## CITY OF DORAL

# LANDMARK AT DORAL TRAFFIC CALMING IMPROVEMENTS

#### **INDEX OF SHEETS**

MIAMI-DADE COUNTY, FLORIDA

SHEET NO.	SHEET DESCRIPTION

C-00	COVER SHEET
G-01	GENERAL NOTES
G-02	KEY SHEET
G-03	SUMMARY OF QUANTITIES
C-01	GEOMETRY PLAN SPEED HUMPS NW 104TH PATH
C-02	PAVEMENT MARKINGS SPEED HUMPS NW 104TH PATH
C-03	SPEED LIMIT SIGNS INSTALLATION NW 104TH AVE
C-04	SHARE LANE MARKINGS (SHARROWS) - I NW 66TH ST
C-05	SHARE LANE MARKINGS (SHARROWS) - II NW 66TH ST
C-06	RRFB AT NW 66TH ST AND NW 104TH PATH DEMOLITION
C-07	RRFB AT NW 66TH ST AND NW 104TH PATH PAVEMENT MARKING
C-07A	RRFB AT NW 66TH ST AND NW 104TH PATH SIGNALIZATION
C-08	RRFB AT NW 66TH ST AND NW 102 PATH DEMOLITION
C-09	RRFB AT NW 66TH ST AND NW 102 PATH PAVEMENT MARKING
C-09A	RRFB AT NW 66TH ST AND NW 102 PATH SIGNALIZATION
C-10	SHARED USED PATH CROSSING ON NW 66TH ST TO NW 107TH AVE
C-11	SHARED USE PATH CROSSING NW 62ND ST

C-11 SHARED USE PATH CROSSING NW 62ND ST
C-12 SHARED USE PATH CROSSING LIMESTONE TRAIL
C-12A RRFB AT NW 104TH PATH AND LIMESTONE TRAIL
C-13 DETAILS

E-01 - E-03 ELECTRICAL DETAILS

SU01-SU-08 SURVEY (EXISTING CONDITIONS)

**INDEX DRAWINGS** 

DET-01	FDOT DETECTABLE WARNING & SIDEWALK CURB RAMP (522-002)
DET-02	FDOT PAVEMENT MARKINGS (711-001)
DFT-03	FDOT BICYCLE MARKINGS (711-002)

DET-04 MIAMI DADE COUNTY SPEED HUMPS GENERAL DETAIL (12A)
DET-05 MIAMI DADE COUNTY RECTANGULAR RAPID FLASHING BEACONS - A/C (654-1)

DET-06 MIAMI DADE COUNTY CONDUIT INSTALLATION DETAIL (1 OF 2)
DET-07 MIAMI DADE COUNTY CONDUIT INSTALLATION DETAIL (2 OF 2)

DET-08 MIAMI DADE COUNTY ELECTRICAL POWER SERVICE ASSEMBLY TYPICAL DETAIL (639-5)

NW 74TH ST

NW 66TH ST

NW 66TH ST

NW 66TH ST

NW 104TH AVE FROM NW 66TH ST TO NW 74TH ST PROJECT LOCATION

NW 66TH ST FROM NW 107TH AVE TO NW 102ND AVE PROJECT LOCATION

NW 104TH PATH FROM NW 66TH ST TO LIMESTONE TRAIL PROJECT LOCATION

NW 62ND ST AT LIMESTONE TRAIL PROJECT LOCATION

NW 62ND ST AT NW 107TH AVE PROJECT LOCATION

DEVELOPED FOR:

#### CITY OF DORAL



Mayor Christi Fraga Vice Mayor Oscar Puig-Corve Councilwoman Digna Cabral Councilwoman Maureen Porras Councilman Rafael Pineyro

#### PROJECT No. 215618043 AUGUST 2024

100% SUBMITTAL

THESE PLANS HAVE BEEN PREPARED IN ACCORDANCE WITH AND ARE GOVERNED BY THE MIAMI—DADE COUNTY PUBLIC WORKS DEPARTMENT STANDARDS AND SPECIFICATIONS PARTS 1, 2 AND 3. THE MANUAL OF UNIFORM MINIMUM STANDARDS FOR DESIGN, CONSTRUCTION AND MAINTENANCE FOR STREETS AND HIGHWAYS. THE FLORIDA DEPARTMENT OF TRANSPORTATION ROADWAY AND TRAFFIC DESIGN STANDARDS, AND THE FLORIDA DEPARTMENT OF TRANSPORTATION STANDARD SPECIFICATIONS (FY 2018—19), AS AMENDED BY CONTRACT DOCUMENTS.

THE SCALE OF THESE DRAWINGS MAY HAVE CHANGED DUE TO REPRODUCTION

The Contractor shall verify and be responsible for all dimensions. DO NOT scale the drawing - any errors or omissions shall be reported to Stantec without delay. The Copyrights to all designs and drawings are the property of Stantec. Reproduction or use for any purpose other than that authorized by Stantec is forbidden.

•••••APPR	••••••APPROVALS•••••						
AGENCY	SUBMITTAL DATE	APPROVAL DATE	PERMIT NUMBER				





www.stantec.com

**LOCATION MAP** 

Ν

ENGINEER'S CERTIFICATION:
THIS PLAN WAS PREPARED UNDER MY DIRECTION AND TO
THE BEST OF MY KNOWLEDGE AND BELIEF COMPLIES WITH
THE INTENT OF THE MANUAL OF UNIFORM STANDARDS FOR
DESIGN, CONSTRUCTION AND MAINTENANCE FOR STREETS
AND HIGHWAYS, AS ADOPTED BY THE STATE OF FLORIDA
LEGISLATURE, CHAPTER 72—328 F.S.



2024/06/15 | 2024/06/15 | 2024/06/15 |

- ANY N.G.V.D. BENCH MARK MONUMENTS WITHIN THE LIMITS OF CONSTRUCTION IS TO BE PROTECTED AND PROPERLY REFERENCED BY A REGISTERED—LAND SURVEYOR IN ACCORDANCE WITH THE MINIMUM TECHNICAL STANDARDS OF THE FLORIDA BOARD OF PROFESSIONAL LAND SURVEYORS PRIOR TO BEGINNING WORK AT THE SITE. IF ANY MONUMENT IS IN
- ALL PUBLIC LAND CORNERS AND MONUMENTS WITHIN THE LIMITS OF CONSTRUCTION ARE TO BE PROTECTED BY THE CONTRACTOR AS FOLLOWS: CORNERS AND MONUMENTS IN CONFLICT WITH THE WORK AND IN DANGER OF BEING DAMAGED, DESTROYED, OR COVERED SHALL BE PROPERLY REFERENCED BY A REGISTERED—LAND SURVEYOR IN ACCORDANCE WITH THE MINIMUM TECHNICAL STANDARDS OF THE FLORIDA BOARD OF PROFESSIONAL LAND SURVEYORS PRIOR TO BEGINNING WORK AT THE SITE. THE CONTRACTOR SHALL RETAIN THE LAND SURVEYOR TO REFERENCE, AND RESTORE UPON COMPLETION OF THE WORK, ALL SUCH CORNERS AND MONUMENTS AND SHALL FURNISH TO MIAMI-DADE COUNTY PUBLIC WORKS DEPARTMENT A SIGNED AND SEALED COPY OF THE LAND SURVEYOR'S REFERENCE DRAWING.
- ALL STATIONS AND OFFSETS REFER TO CENTERLINE OF CONSTRUCTION, UNLESS OTHERWISE STATED.
- ALL GRADES SHOWN IN PLAN ARE FINISHED GRADES.
- THE CONTRACTOR SHALL PAINT ALL STATIONS WITH STENCLED NUMBERS ON THE FACE OF CURB:
  A. FROM THE BEGINNING OF THE PROJECT WHERE THE CURB IS TO REMAIN.
  B. AT NEW CURB NOT LATER THAN 72 HOURS AFTER BEING POURED. C. WHERE CURB DOES NOT EXIST AND SHALL NOT BE CONSTRUCTED, THE CONTRACTOR SHALL MAINTAIN STATIONING WITH SURVEYING STAKES. CONTRACTOR SHALL MAINTAIN THE STATION MARKS VISIBLE UNTIL FINAL INSPECTION.
- ALL CONSTRUCTION SHALL BE IN STRICT ACCORDANCE WITH THE REQUIREMENTS OF THE MIAMI-DADE COUNTY PUBLIC WORKS DEPARTMENT, AND ANY OTHER STATE OR LOCAL AGENCY WITH JURISDICTION. IT IS THE INTENT OF THESE PLANS TO BE IN ACCORDANCE WITH APPLICABLE CODES AND AUTHORITIES HAVING JURISDICTION, ANY DISCREPANCIES BETWEEN THESE PLANS AND APPLICABLE CODES SHALL BE IMMEDIATELY BROUGHT TO THE ATTENTION OF THE ENGINEER.
- THE LOCATION AND SIZE OF THE UTILITIES SHOWN IN THE PLANS ARE BASED ON THE BEST AVAILABLE INFORMATION AND SHOULD BE CONSIDERED APPROXIMATE ONLY. ADDITIONAL UTILITIES MAY EXIST WHICH ARE NOT SHOWN ON THESE DRAWINGS. THE CONTRACTOR SHALL VERIFY ALL UTILITIES BY ELECTRONIC METHODS AND BY PRE-TRENCHING IN COORDINATION WITH ALL UTILITY COMPANIES, PRIOR TO BEGINNING ANY CONSTRUCTION OPERATION, ANY AND ALL CONFLICTS OF EXISTING UTILITIES WITH PROPOSED IMPROVEMENTS MUST BE RESOLVED BY THE ENGINEER AND THE OWNER. THIS WORK By the contractor shall be considered incidental to the contract and no additional compensation shall be
- EXISTING TOPOGRAPHIC INFORMATION WAS OBTAINED FROM SURVEY PREPARED BY LONGITUDE SURVEYORS
- CONTRACTOR SHALL CONTACT SUNSHINE STATE ONE-CALL AT 1-(800)-432-4770 AT LEAST 48 HOURS PRIOR TO PERFORMING ANY DIGGING TO VERIFY THE EXACT LOCATION OF EXISTING UTILITIES. A CONTRACTOR'S REPRESENTATIVE MUST BE PRESENT WHEN UTILITY COMPANIES LOCATE THEIR FACILITIES. CONTRACTOR SHALL CALL ALL UTILITY COMPANIES TO VERIFY EXACT LOCATION OF ALL UTILITIES PRIOR TO ANY EXCAVATION. THE CONTRACTOR SHALL COORDINATE WORK WITH ALL UTILITY COMPANIES, CITY OF DORAL AND OTHER CONTRACTORS TO MINIMIZE DISRUPTION OR INTERFERENCE TO THE CONTRACTOR'S WORK
- THE CONTRACTOR IS TO USE CAUTION WHEN WORKING IN OR AROUND AREAS OF OVERHEAD AND UNDERGROUND UTILITIES.
- MIAMI-DADE WATER AND SEWER DEPARTMENT REQUIRES THAT ACCESS TO ALL WATER AND SEWER VALVES, SANITARY MANHOLES, AND OTHER CONTROL MECHANISMS BE MAINTAINED THROUGHOUT CONSTRUCTION IN THE EVENT OF AN EMERGENCY TO ENSURE THE PUBLIC HEALTH AND SAFETY. COVERING VALVE BOXES AND MANHOLES CAN BE CONSIDERED UNAUTHORIZED OBSTRUCTION OF AND TAMPERING WITH DEPARTMENT UTILITIES. ALL REQUESTS FOR UTILITY ADJUSTMENTS UNAU HONGLED OBSTRUCTION OF AND TAMPERING WITH DEPARTMENT OTILITIES. ALL REQUESTS FOR UTILITY ADJUSTMENTS MUST BE MADE IN WRITING AT LEAST TWO (2) WEEKS IN ADVANCE. FOR MANHOLE AND VALVES, CONTRACT THE CONSTRUCTION MANAGEMENT SECTION, PUMP STATIONS UNIT, 3071 SW 38 AVENUE, FAX NO. 305-668-3626. THE DEPARTMENT WILL MAKE ONE FINAL AND PERMANENT ADJUSTMENT AT NO COST TO THE REQUESTING AGENCY. FOR THE ADJUSTMENT OF WATER METERS, CONTACT THE CHIEF OF METERS OPERATIONS AND MANTENANCE, FAX NO. 305-645-3482. FOR ANY FIRE HYDRANTS THAT ARE DAMAGED OR BUMPED DURING CONSTRUCTION, CONTACT THE MDWASD HYDRANT SHOP AT 305-805-4575 BEFORE POURING CONCRETE FOR THE SIDEWALK. IN THE EVENT OF A WATER OR SEWER EMERGENCY, CONTACT MIAMI DADE WATER AND SEWER DEPARTMENT AT 305-274-9272. THIS LINE IS OPEN 24 HOURS, 7 DAYS A WEEK.
- KNOWN UTILITY COMPANIES IN THE PROJECT LIMITS INCLUDE, BUT ARE NOT LIMITED TO:
  - FP&L (800) 868-9554 & (305) 552-2931 (305) 222-8745 MIAMI-DADE WATER AND SEWER DEPT. (786) 268-5255 COMCAST CABLE (954) 447-8405 FLORIDA CITY GAS (305) 835-3632 MIAMI DADE COUNTY PUBLIC WORKS (305) 592-8925 CROWN CASTLE (786) 610-7073 (954) 298-5606
- THE CONTRACTOR IS ADVISED THAT PROPERTIES ADJACENT TO THE PROJECT HAVE ELECTRIC, TELEPHONE, GAS, WATER, AND/OR SEWER SERVICE LATERALS WHICH MAY NOT BE SHOWN IN PLANS. THE CONTRACTOR MUST REQUEST THE LOCATION OF THESE LATERAL SERVICES FROM THE UTILITY COMPANIES. THE ADDITIONAL COST OF EXCAVATING, INSTALLING, BACKFILLING, AND COMPACTING AROUND THESE LATERAL SERVICES MUST BE INCLUDED IN THE BID RELATED ITEM FOR THE
- ANY DAMAGE TO PUBLIC OR PRIVATE PROPERTY SHALL BE RESTORED BY THE CONTRACTOR AT NO ADDITIONAL COST TO THE OWNER. ASPHALT, CONCRETE OR PAVER DRIVEWAYS ON PRIVATE PROPERTY ABUTTING RIGHT-OF-WAY WHICH ARE DAMAGED or impacted during construction shall be repaired at the contractor's expense as directed by the engineer.
- ANY ENCROACHMENT WITHIN THE LIMITS OF CONSTRUCTION SHALL BE RELOCATED OR PROTECTED BY THE ADJACENT
- CLEARING AND GRUBBING, GRADING AND OTHER INCIDENTAL WORK NECESSARY FOR HARMONIZATION OUTSIDE R/W SHALL BE INCLUDED IN RELATED BID ITEMS.
- ALL GRASS AREAS AFFECTED BY CONSTRUCTION SHALL BE RE—SODDED. SODDING TO BE USED AT LOCATIONS WHERE EXISTING LAWNS OR SWALES ARE DISTURBED, AT CONTRACTORS EXPENSE AS DIRECTED BY THE ENGINEER.
- THE CONTRACTOR SHOULD TAKE SPECIAL NOTE OF SOIL CONDITIONS THROUGHOUT THIS PROJECT. ANY SPECIAL SHORING, SHEETING OR OTHER PROCEDURES NECESSARY TO PROTECT ADJACENT PROPERTY, PUBLIC OR PRIVATE, DURING THE EXCAVATION OF SUBSOIL MATERIAL AND EXFLITATION TRENCH, OR FILLING OF ANY AREA, OR FOR ANY OPERATION DURING CONSTRUCTION CHAIN THE THE CALL PROPERTY. CONSTRUCTION, SHALL BE THE SOLE RESPONSIBILITY OF THE CONTRACTOR.
- IF SHEETING, SHORING, OR DEWATERING, INCLUDING WELL POINTS ARE NECESSARY, THE CONTRACTOR MUST MONITOR AND CONTROL ALL WORK THAT MAY CAUSE CRACKING TO ANY ADJACENT BUILDING, STRUCTURE, OR PROPERTY AREA. THE CONTRACTOR SHALL BE RESPONSIBLE FOR ANY DAMAGES CAUSED BY THESE OPERATIONS. COST OF SHEETING, SHORING, OR DEWATERING SHALL BE INCLUDED IN THE RELATED BID ITEM FOR THE WORK BEING DONE.

- THE CONTRACTOR SHALL BE RESPONSIBLE FOR OBTAINING THE DEWATERING PERMIT. COST OF THE PERMIT AND DEWATERING SHALL BE INCLUDED IN THE THE RELATED BID ITEM FOR THE WORK BEING DONE.
- THE CONTRACTOR WILL RESTRICT PERSONNEL, THE USE OF EQUIPMENT, AND THE STORAGE OF MATERIALS TO AREAS WITHIN THE LIMITS OF CONSTRUCTION AND DESIGNATED STAGING AREA, IF IDENTIFIED.
- EXPLORATORY OR PRE-TRENCHING IN THE ALIGNMENT AND GRADE OF PROPOSED PIPES STRUCTURES, FRENCH DRAINS, CONDUTS, POLE FOUNDATIONS AND/OR SUB-GRADE SHALL BE PERFORMED SEVEN DAYS IN ADVANCE OF ITS CONSTRUCTION AS DIRECTED BY THE ENGINEER. THE CONTRACTOR SHALL PROVIDE UNDERGROUND UTILITY OWNERS AND THE DEPARTMENT WITH IMMEDIATE NOTIFICATION OF ANY CONFLICT WITH PROPOSED CONSTRUCTION. THIS NOTIFICATION SHALL PROVIDE SURVEY INFORMATION ABOUT EXISTING UTILITY ALIGNMENT, GRADE AND POSSIBLE CONFLICTS. PAYMENT FOR EXPLORATORY -trenching, survey and backfilling shall be included in the cost of the related bid item for the work
- ALL DITCH EXCAVATIONS SHALL BE PERFORMED IN FULL COMPLIANCE WITH THE PROVISIONS OF THE TRENCH SAFETY ACT.
- ALL EXCESS MATERIAL, AS DESIGNATED BY THE ENGINEER, IS TO BE DISPOSED BY THE CONTRACTOR IN LEGAL AREAS PROVIDED BY HIM WITHIN 72 HOURS OF BEING DEPOSITED IN THE CONSTRUCTION AREA AND AT THE CONTRACTOR'S
- ALL DISPOSAL OF MATERIALS, RUBBISH, AND DEBRIS SHALL BE MADE AT A LEGAL DISPOSAL SITE OR BY OTHER PRIOR APPROVED MANNER. MATERIAL CLEARED FROM THE SITE AND DEPOSITED ON ADJACENT OR NEARBY PROPERTY WILL NOT BE CONSIDERED AS HAVING BEEN DISPOSED OF SATISFACTORILY.
- ANY KNOWN OR SUSPECTED HAZARDOUS MATERIAL FOUND ON THE PROJECT BY THE CONTRACTOR SHALL BE IMMEDIATELY REPORTED TO THE PROJECT ENGINEER, WHO SHALL DIRECT THE CONTRACTOR TO PROTECT THE AREA OF KNOWN OR SUSPECTED CONTAMINATION FROM FURTHER ACCESS. THE ENGINEER WILL ARRANGE FOR INVESTIGATION, IDENTIFICATION, AND REMEDIATION OF THE HAZARDOUS MATERIAL. THE CONTRACTOR SHALL NOT RETURN TO THE AREA OF CONTAMINATION UNTIL APPROVAL IS PROVIDED BY THE PROJECT ENGINEER.
- EXISTING ABOVE GROUND FEATURES ARE SHOWN ACCORDING TO THE BEST AVAILABLE DATA AND MAY NOT ACCURATELY REFLECT PRESENT CONDITIONS. CONTRACTOR SHALL BE RESPONSIBLE FOR FAMILIARIZING HIMSELF WITH CURRENT SITE CONDITIONS, AND SHALL REPORT DISCREPANCIES TO THE ENGINEER PRIOR TO STARTING WORK.
- CONTRACTOR IS TO VERIFY THE EXACT LOCATION OF ALL EXISTING TREES, STRUCTURES AND UTILITIES, WHICH MAY NOT BE SHOWN ON PLANS. ANY STRUCTURE, PAVEMENT, TREES OR OTHER EXISTING IMPROVEMENT NOT SPECIFIED FOR REMOVAL WHICH IS TEMPORARY DAMAGED, EPOSED OR IN ANY WAY DISTURBED BY CONSTRUCTION PERFORMED UNDER THIS CONTRACT, SHALL BE REPAIRED, PATCHED OR REPLACED AT NO ADDITIONAL COST TO THE OWNER. CONTRACTOR TO INSTALL ROOT BARRIERS AROUND EXISTING TREES TO REMAIN WHICH ARE ADJACENT TO CONCRETE
- CONTRACTOR SHALL AVOID DAMAGE TO ANY EXISTING TREES TO REMAIN. EXISTING TREES SHALL BE REMOVED ONLY IF REQUIRED FOR CONSTRUCTION. THOSE TREES NOT INTERFERING WITH CONSTRUCTION SHALL BE PROTECTED IN PLACE.
- TRAFFIC SHALL BE MAINTAINED ON DUST FREE ASPHALT SURFACE AT ALL TIMES. THE CONTRACTOR SHALL USE A STREET SWEEPER (USING WATER) OR OTHER EQUIPMENT CAPABLE OF CONTROLLING AND REMOVING DUST. APPROVAL OF THE USE OF SUCH EQUIPMENT IS CONTINGENT UPON ITS DEMONSTRATED ABILITY TO DO THE WORK.
- THE CONTRACTOR SHALL PREPARE AND SUBMIT SHOP DRAWINGS FOR ALL ITEMS USED IN THIS PROJECT.
- WHEN DISSIMILAR MATERIAL CONNECTIONS ARE MADE, SUCH AS CONCRETE TO METAL, THE DISSIMILAR MATERIAL SHALL BE 33.
- THE CONTRACTOR IS RESPONSIBLE FOR KEEPING EXISTING AND NEW INLETS CLEAN OF MILLING MATERIAL, LIMEROCK, DEBRIS, ETC. DURING THE CONSTRUCTION AT NO ADDITIONAL COST TO THE OWNER. ALL LINES AND STRUCTURES SHALL BE CLEANED PRIOR TO FINAL INSPECTION AND ACCEPTANCE AND CONFIRMED WITH CCTV.
- CAST IRON PRODUCTS: HEAVY-DUTY CLASSIFICATION SUITABLE FOR HIGHWAY TRAFFIC LOADS OR 16,000 LBS WHEEL
- EXISTING MANHOLES AND INLETS SCHEDULED TO REMAIN SHALL BE THOROUGHLY CLEANED BY REMOVING ALL DEBRIS AND SEDIMENTS, AND THE INTERIOR SHALL BE SEALED WITH AN APPROVED NON-TOXIC BITUMASTIC SEALANT.
- PRIOR TO CONSTRUCTION THE CONTRACTOR WILL INSPECT ALL EXISTING STRUCTURES WHICH ARE TO REMAIN AND NOTIFY THE ENGINEER OF ANY OBVIOUS STRUCTURAL DEFICIENCIES.
- RADII ON CURB RETURNS ARE TO THE EDGE OF PAVEMENT UNLESS OTHERWISE NOTED.
- SPECIAL ATTENTION IS DIRECTED TO THE FACT THAT PORTIONS OF SOME DRAINAGE STRUCTURES EXTEND INTO THE STABILIZED PORTION OF THE ROADBED AND EXTREME CAUTION SHOULD BE USED IN THE STABILIZING OPERATIONS AT THESE
- THE CONTRACTOR SHALL BE RESPONSIBLE FOR THE PROVISION, INSTALLATION, AND MAINTENANCE OF ALL TRAFFIC CONTROL AND SAFETY DEVICES, IN ACCORDANCE WITH SPECIFICATIONS OUTLINED IN THE PUBLIC WORKS STANDARD DETAILS, THE MANUAL OF UNIFORM TRAFFIC CONTROL DEVICES, AND THE FDOT DESIGN STANDARDS.
- WHERE NEW PAVEMENT MEETS EXISTING, CONNECTION SHALL BE MADE IN A NEAT STRAIGHT LINE AND FLUSH WITH THE
- THE LOCATION OF SOME DRIVEWAYS IS APPROXIMATE. VERIFICATION OF EXACT LOCATION AND DIMENSIONS IS
- THE INFORMATION PROVIDED IN THESE DRAWINGS IS SOLELY TO ASSIST THE CONTRACTOR IN ASSESSING THE NATURE AND EXTENT OF CONDITIONS WHICH WILL BE ENCOUNTERED DURING THE COURSE OF WORK. THE CONTRACTORS ARE DIRECTED, PRIOR TO BIDDING, TO CONDUCT WHATEVER INVESTIGATIONS THEY DEEM NECESSARY TO ARRIVE AT THEIR OWN CONCLUSION regarding the actual conditions that will be encountered, and upon which bids will be based.
- LOCAL RESIDENTS, PROPERTY OWNERS AND TENANTS WITHIN THE AREA OF CONSTRUCTION SHALL BE GIVEN ACCESS TO THEIR
- CONTRACTOR SHALL REMOVE ANY EXISTING STRIPING THAT CONFLICTS WITH THE MAINTENANCE OF TRAFFIC DURING CONSTRUCTION AND PROVIDE ADEQUATE TEMPORARY SIGNING AND/OR STRIPING USING REFLECTORIZED PAINT.
- PAVED ASPHALT, TEMPORIARY PAVEMENT AND CONNECTIONS SHALL BE PROVIDED THROUGHOUT PROJECT, AS NEEDED AND DIRECTED BY THE ENGINEER TO MANATAIN TRAFFIC AND ACCESS. (ITEM NUMBER 102-1)

  CONTRACTOR SHALL PRESERVE ALL STREET SIGNS, BENCHES, TRAFFIC CONTROL SIGNS, ETC. AS DIRECTED BY THE ENGINEER. WHEN DIRECTED BY THE ENGINEER. CONTRACTOR SHALL REINSTALL OR DELIVER SAID PUBLIC PROPERTY TO THE CITY OF DORAL AND/OR MIANT-BADE, COUNTRY DIBLIC WORKS DEPARTMENT.

Consultants

- 48. ALL EXISTING FIRE HYDRANTS SHALL REMAIN UNDISTURBED UNLESS OTHERWISE NOTED.
- CONTRACTOR SHALL CAREFULLY SAW-CUT ANY ROOTS IN CONFLICT WITH CONSTRUCTION OF CURB, SIDEWALK, DRAINAGE OR UTILITIES. ROOTS TORN BY BACKHOE WILL NOT BE ALLOWED AT CONTRACTORS EXPENSE.
- CONTRACTOR SHALL MAINTAIN TRENCHING TO THE MINIMUM REQUIRED TO DO WORK TO AVOID DAMAGE TO TREES. ANY TREES EXPECTED TO BE DAMAGED NOTIFY ENGINEER.
- RESIDENTS, PROPERTY OWNERS AND TENANTS ALONG PROJECT ROUTE SHALL RECEIVE MINIMUM SEVEN (7) DAY ADVANCE WRITTEN NOTIFICATION BY CONTRACTOR OF WORK TO BE PERFORMED IN FRONT OF THEIR PROPERTY.
- ALL SIDEWALK CLOSURES SHALL BE PROVIDED BY THE CONTRACTOR WITH PROPER PEDESTRIAN DIRECTIONAL DETOUR
- CONTRACTOR SHALL RELOCATE ALL EXISTING MAILBOXES IN CONFLICT WITH PROPOSED CONSTRUCTION AS PER MIAMI-DADE COUNTY PUBLIC WORKS AND WASTE MANAGEMENT ROADWAY STANDARDS AND CONSTRUCTION STANDARD DETAILS.
- CONTRACTOR SHALL CONFORM TO ALL LATEST STANDARDS OF F.D.O.T. AND MIAMI-DADE COUNTY PUBLIC WORKS AND WASTE MANAGEMENT ROADWAY STANDARDS AND CONSTRUCTION STANDARD DETAILS.
- NOTHING, INCLUDING UTILITIES, FURNISHINGS AND LANDSCAPING CAN PROTRUDE INTO THE PEDESTRIAN CLEAR PATH ZONE,
- AS-BUILT PLANS THE CONTRACTOR WILL BE FURNISHED THE CAD FILES FOR USE IN PREPARING AS-BUILT DRAWINGS TO BE SUBMITTED TO THE ENGINEER WITHIN THE TIME FOR SUBSTANTIAL COMPLETION OF THE PROJECT, IT SHALL BE THE CONTRACTOR'S RESPONSIBILITY TO RETAIN A PROFESSIONAL LAND SURVEYOR TO PREPARE AS-BUILT DRAWINGS IN AUTOCAD FORMAT AND PDF. THE COST OF SAID SERVICES SHALL BE INCLUDED IN THE CONTRACTOR'S PRICE WHETHER SHOWN AS A SEPARATE LINE ITEM OR NOT. CONTRACTOR SHALL SUBMIT COMPLETED AS—BUILT PLANS, ACCEPTABLE TO THE CITY, WITHIN FOURTEEN (14) DAYS AFTER THE SUBSTANTIAL COMPLETION DATE. THE CITY RESERVES THE RIGHT TO REVIEW THE AS—BUILTS AND TO REQUIRE REVISIONS TO BE MADE BY THE CONTRACTOR'S SURVEYOR AT NO ADDITIONAL COST TO THE CITY

#### **ENVIRONMENTAL**

- A. NO STAGING OR OTHER ACTIVITIES FOR THIS PROJECT SHOULD OCCUR WITHIN NO STAGING OR OTHER ACTIVITIES FOR THIS PROJECT SHOULD OCCUR WITHIN THE DRIPLINE OF EXISTING TREES.
- B. PREVENT DAMAGING TREES AND PLANTERS WITHIN OR IMMEDIATELY ADJACENT PREVENT DAMAGING TREES AND PLANTERS WITHIN OR IMMEDIATELY ADJACENT TO THE PROJECT'S RIGHT-OF-WAY.
- C. THERE WILL BE 2 TREES TO BE REMOVED IN THIS PROJECT. WHEN NECESSARY, INSTALL A PHYSICAL AND HIGHLY VISIBLE BARRIER AROUND EXISTING TREE TO BE PROTECTED. USE DURABLE FENCING MATERIAL, SUCH AS PLASTIC CONSTRUCTION FENCING OR EQUIVALENT MATERIAL. PLACE THE BARRIER AS DETERMINED IN THE PRE-CONSTRUCTION SURVEY, IDENTIFYING CRITICAL AREAS TO BE PROTECTED.
- D. TREE PROTECTION SHALL BE INSTALLED AROUND TREES TO REMAIN LOCATED TREE PROTECTION SHALL BE INSTALLED AROUND TREES TO REMAIN LOCATED ADJACENT TO CONSTRUCTION ACTIVITIES.
- F. THE CONTRACTOR SHALL REVIEW ENVIRONMENTAL REQUIREMENTS OF ANY PROPOSED STAGING AREAS WITH THE CITY OF DORAL PROJECT MANAGER AT LEAST 72 HR PRIOR USE.
- G. CONTRACTOR MUST HAVE AN ARBORIST PRESENT AT ALL TIMES DURING ANY ROOT PRUNING AND PROTECTION OF EXISTING TREES
- H. CONTRACTOR WILL BRACE ALL EXISTING LANDSCAPING TO REMAIN PRIOR TO CONTRACTOR WILL BRACE ALL EXISTING LANDSCAPING TO REMAIN PRIOR TO BEGINNING ANY WORK AND WILL ENSURE THEIR STABILIZATION THROUGHOUT THE ENTIRE CONSTRUCTION PROCESS. EXISTING SOD DISTURBED BY CONSTRUCTION 15 IN ORIGINAL IS NOT AFFECTED BY PROPOSED GRADING WILL BE RESTORED TO ITS ORIGINAL STATE UPON COMPLETION OF CONSTRUCTION. SODDED SLOPES STEEPER THAN 4 HORIZONTAL TO 1 VERTICAL WILL BE PEGGED.
- I. ALL WASTE GENERATED FROM THE CONSTRUCTION SHALL BE DISCARDED IN ALL WASTE GENERATED FROM THE CONSTRUCTION SHALL BE DISCARDED IN ACCORDANCE WITH ALL APPLICABLE STATE, LOCAL, AND FEDERAL REGULATIONS. CONTRACTOR IS TO OBTAIN ALL APPLICABLE CODES AND BECOME FAMILIAR WITH STATE, LOCAL AND FEDERAL REGULATIONS PRIOR TO BEGINNING CONTRUCTION. REQULATIONS CAN BE FOUND, BUT NOT LIMITED TO, DEPARTMENT OF ENVIRONMENTAL RESOURCE MANAGEMENT AND DEPARTMENT OF ENVIRONMENTAL PROTECTION.
- J. TO ENSURE THAT OFF-SITE VEHICLE TRACKING OF SEDIMENTS AND THE TO ENSURE THAT OFF-SITE VEHICLE TRACKING OF SEDIMENTS AND THE GENERATION OF DUST IS MINIMIZED, CONTRACTOR IS TO PUT INTO PRACTICE THE METHODS DETAILED IN FDOT INDEX 108 (LATEST VERSION).
- K. DUST GENERATED FROM CONSTRUCTION WILL BE MINIMIZED, A WATER TRUCK AND DUST GENERATED FROM CONSTRUCTION WILL BE MINIMIZED, A WATER TRUCK AND SITE CLEANING AT THE END OF EACH WORK DAY IS REQUIRED. DISPOSAL OF EXCESS MATERIAL IS SEVENTY TWO (72) HOURS MAXIMUM

By Appd. YY.MM.DD By Appd. YY.MM.DD Revision

STATE OF

CARLOS ARROWS FAR ARROWS STATE OF STAT


901 Ponce de Leon Blvd, Suite 900 www.stantec.com

The Contractor shall verify and be responsible for all dimensions, DO NOT scale the drawing - any errors or amissions shall be reported to Stantec without delay, The Copyrights to a I designs and drawings are the property of Stantee. Reproduction or use for any purpose other than that authorized by Stantec is forbidden.

CITY OF DORAL LANDMARK AT DORAL TRAFFIC CALMING

NW 66TH ST FROM NW 102ND AVE TO NW 107TH AVE RM CMH CMH 23.06.01

**GENERAL NOTES** Project No. Scale Drawing No. Sheet Revision G-01 of

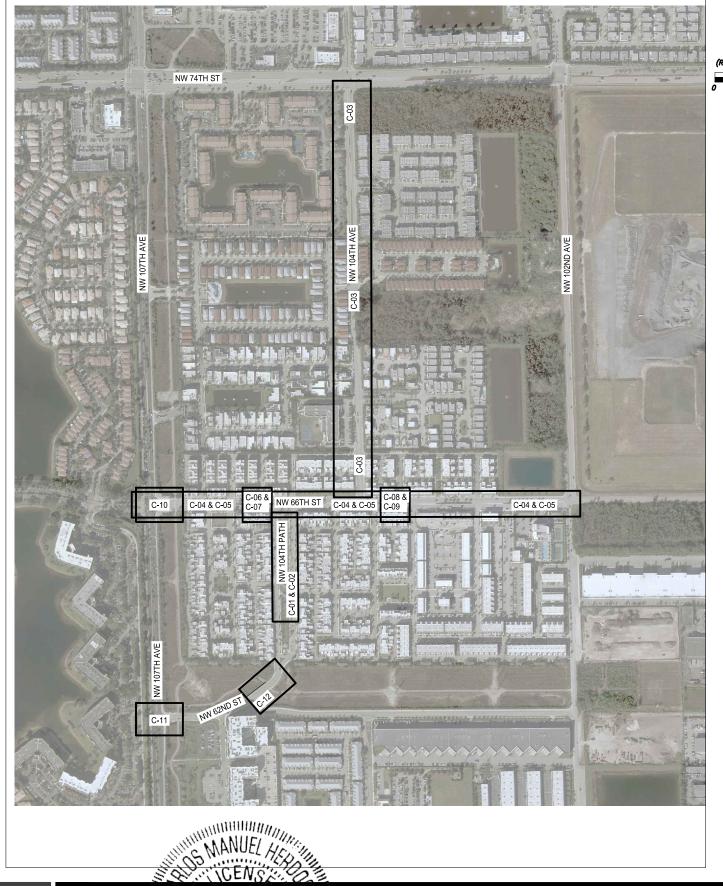

Scale: 1" = 300'
(Reduced Scale: 1" = 600

:\2156\pactive\215618043\drawings\civil\215618043\_GEN 024/08/15 1:18 PM By: Morales, Rod

No. 47660

STATE OF

CARGO M. GRADO PAR.

REGISTERED FIGURATE OF STATE OF JOHN MICE OF STATE OF STAT

By Appd. YY.MM.DD

Stantec
901 Ponce de Leon Blvd. Suite 900
Coral Gables, Florida 33134
www.stantec.com

The Contractor shall verify and be responsible for all dimensions, DO NOT scale the drawing- any errors or amissions shall be reported to Strantoc without delay. The Copyrights to all designs and drawings are the property of Stantec. Reproduction or use for any purpose other than that authorized by Stantee is forbidden.

CITY OF DORAL

LANDMARK AT DORAL TRAFFIC CALMING

NW 66TH ST FROM NW 102ND AVE TO NW 107TH AVE

NW 66TH ST FROM NW 1	02ND A	VE TO	NW 10	7TH AVE
File Name:	RM	СМН	СМН	23.06.01
	Dwn.	Chkd.	Dsgn.	YY.MM.DD

KEY SHEET

Project No. Scale


Drawing No. Sheet Revision

G-02 of

By Appd. YY.MM.DD

ITEM NO.	ITEM	UNIT	PLAN	FINAL
1.00	DEMOLITION	L.S.	_ 1	1
2.00	MAINTENANCE OF TRAFFIC*	L.S.	1	
3.00	THERMOPLASTIC (WHITE) (SOLID) (6")	L.F.	864	
4.00	THERMOPLASTIC (WHITE) (SOLID) (12")	L.F.	820	
5.00	THERMOPLASTIC (WHITE) (SOLID) (24")	L.F.	970	
6.00	THERMOPLASTIC (YELLOW) (SOLID) (6")	L.F.	88	
7.00	#654-2-12, RAPID FLASHING BEACON, AC POWERED, INCLUDES THE RECTANGULAR BEACONS, SIGNS, SIGN SUPPORT STRUCTURE, CABINET, ELECTRONICS, CONDUIT, PULL BOX, WIRING, GROUNDING, PEDESTRIAN PUSHBUTTON (665-2-12) AND ALL NECESSARY APPURTENANCES NEEDED TO MEET THE REQUIREMENTS OF THE MIAMI DADE COUNTY SPECIFICATIONS SECTION 654 (USE SIGNS W11-2, SEE SHEETS C-07A & C-09A) (USE SIGNS W11-15, SEE SHEET C-12)	A.S.	10	
8.00	PULL BOXES (635-2-11)	E.A.	29	
9.00	ELECTRICAL SERVICE WIRE (639-2-1)	L.F.	910	
10.00	CONDUIT, DIRECTIONAL BORE (630–2–12)	L.F.	910	
11.00	ELECTRICAL POWER SERVICE (639-1-122)	A.S.	3	
12.00	CONCRETE POLE FOR SERVICE POINT (641-2-12)	E.A.	3	
13.00	EXISTING SIDEWALK RECONSTRUCTION	S.F.	48	
14.00	DEPRESSED SIDEWALK	E.A.	2	
15.00	CONCRETE CURB AND GUTTER	L.F.	136	
16.00	CONCRETE VALLEY GUTTER	L.F.	160	
17.00	ASPHALT TRAFFIC HUMPS	E.A.	4	
18.00	CURB RAMP DETECTABLE WARNINGS (4)	S.F.	60	
19.00	SOD	S.Y.	66	
20.00	MILLING & RESURFACING EXIST. ASPHALT PAVEMENT (1" AVG. DEPTH)	S.Y.	161	
21.00	PALM TREE REMOVAL	E.A.	2	
22.00	GREEN BUTTONWOOD TREE TO BE RELOCATED (LOCATION TO BE APPROVED BY THE CITY OF DORAL)	E.A.	2	
23.00	RELOCATE EXISTING SIGN	E.A.	1	
24.00	REMOVE EXISTING PAVEMENT MARKING	S.F.	1486	
25.00	SHARROWS	E.A.	14	
26.00	BICYCLE SIGN R4-11	E.A.	10	
27.00	SPEED LIMIT 30 MPH SIGN R2-1	E.A.	9	
28.00	SPEED HUMP SIGN W17-1	E.A.	8	
29.00	ARROW SIGN W16-7P	E.A.	8	
30.00	AHEAD SIGN W16-9P	E.A.	14	
31.00	PEDESTRIAN SIGN W11-2	E.A.	6	
32.00	STOP HERE SIGN R1-5B	E.A.	6	
33.00	TURNING VEHICLES STOP FOR PEDESTRIAN SIGN R10-15A	E.A.	2	
34.00	CYCLIST DISMOUNT SIGN	E.A.	8	
35.00	AHEAD SIGN M6-2A	E.A.	4	
36.00	ADVANCED INTERSECTION LANE CONTROL SIGN R3-8B	E.A.	2	
37.00	USE CROSSWALK SIGN R9-3B	E.A.	4	

Consultants

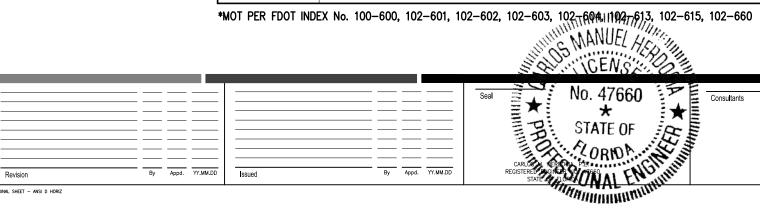

Stantec
901 Ponce de Leon Blvd. Suite 900 www.stantec.com


The Contractor shall verify and be responsible for all dimensions. DO NOT scale the drawing - any errors or amissions shall be reported to Stantac without delay, the Copyrights to all designs and drawings are the property of Stantace. Reproduction or use for any purpose other than that authorized by Stantac is forbidden.


CITY OF DORAL LANDMARK AT DORAL TRAFFIC CALMING NW 66TH ST FROM NW 102ND AVE TO NW 107TH AVE


 RM
 CMH
 CMH
 23.06.01


 Dwn.
 Chkd.
 Dsgn.
 YY.MM.DD

SUMMARY OF QUANTITIES Drawing No. Sheet Revision G-03 of

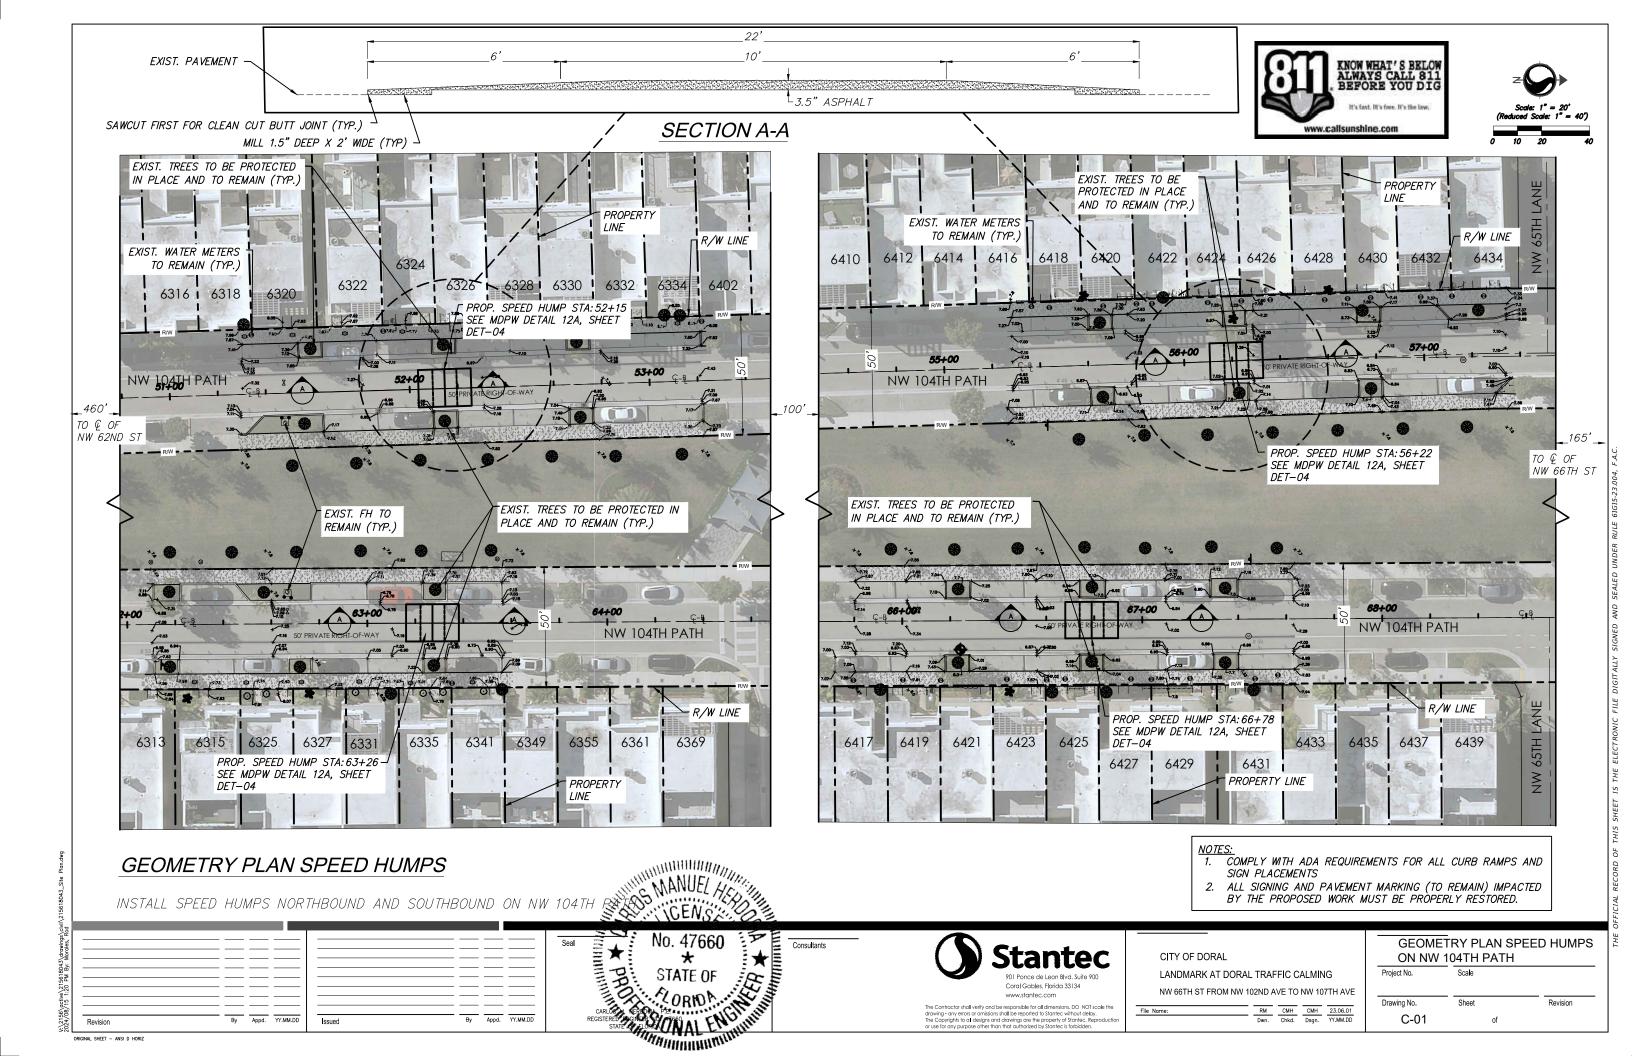

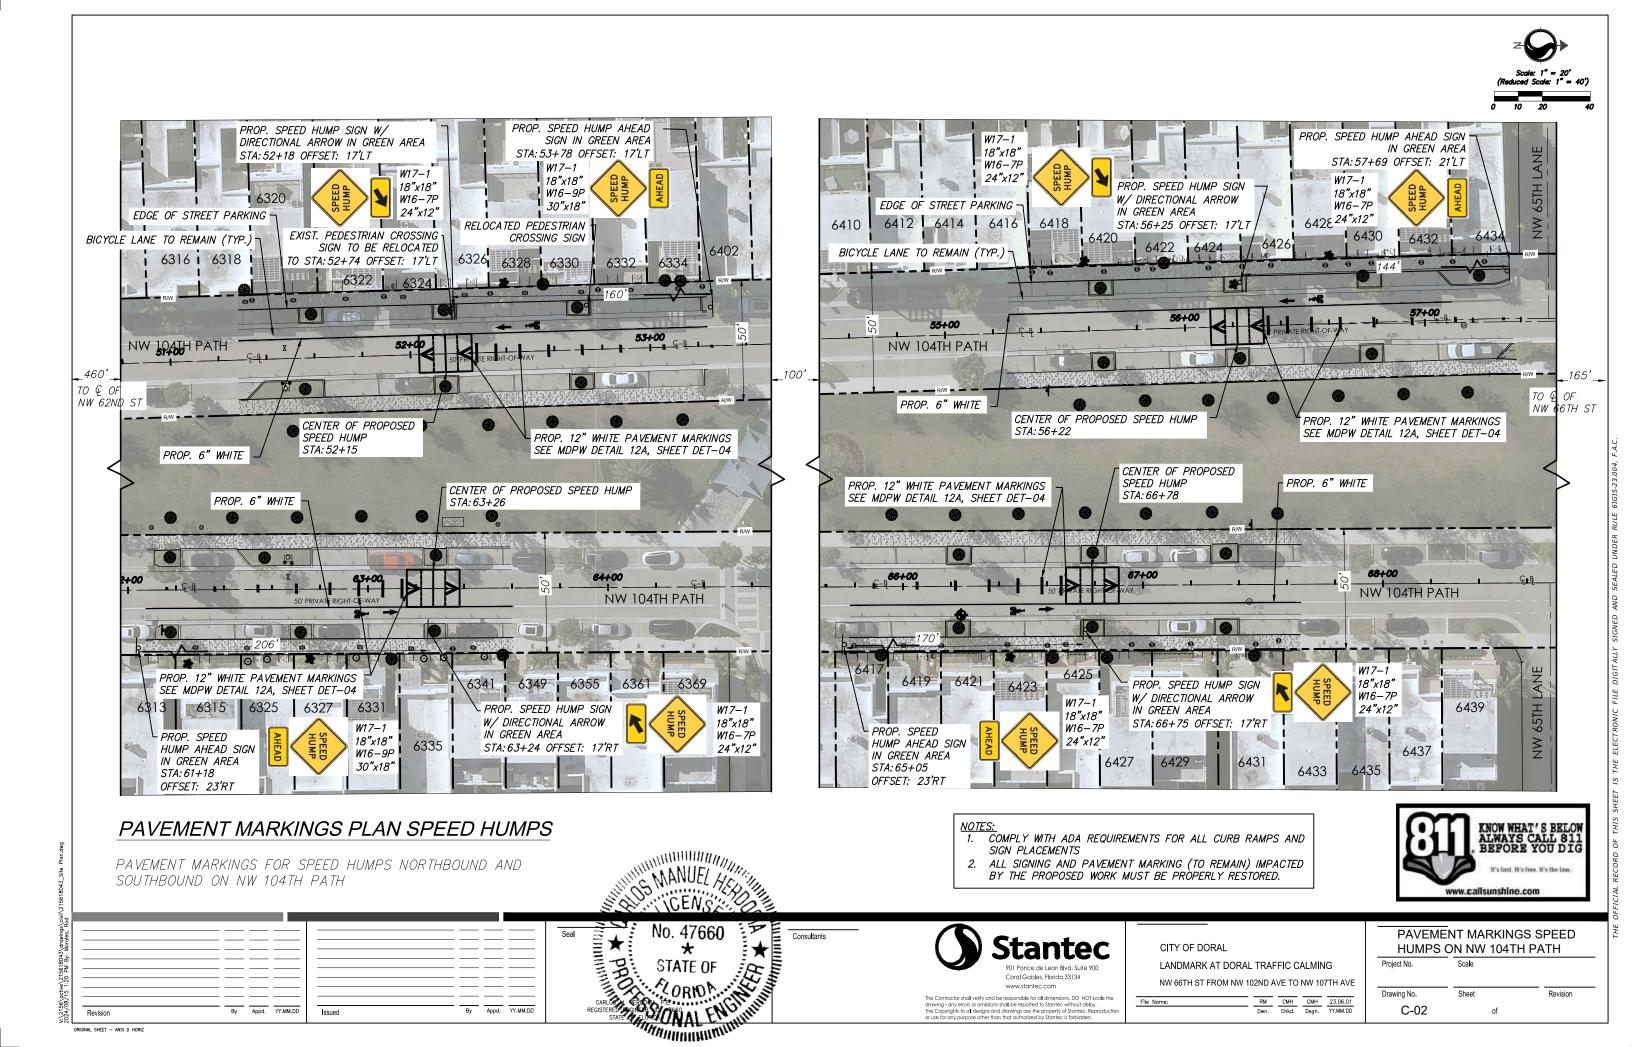

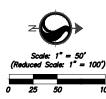

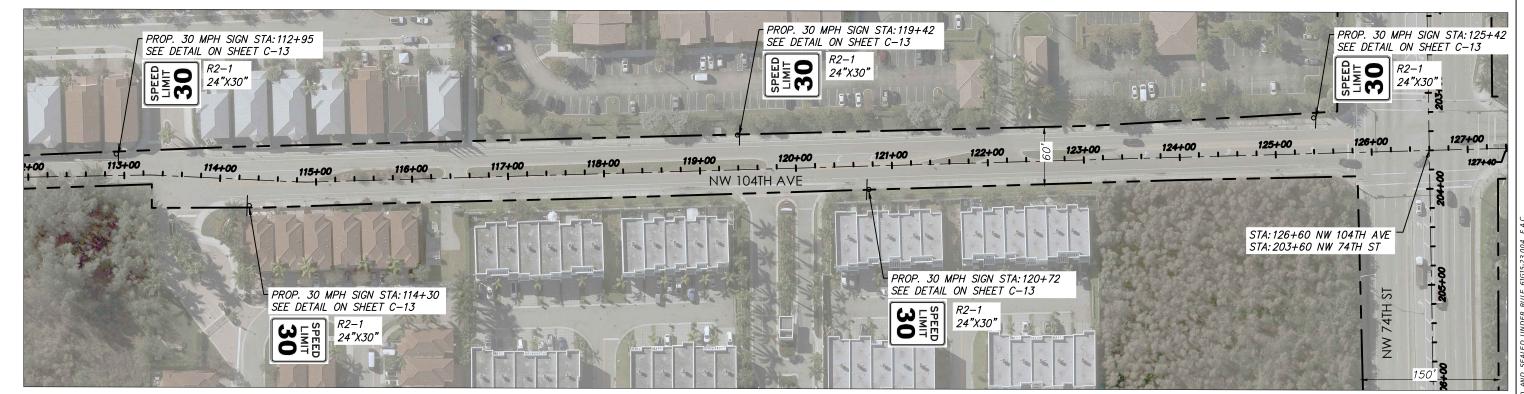

#### SPEED LIMIT SIGNS INSTALLATION

INSTALL SPEED LIMIT SIGNS (30MPH) FOR NORTHBOUND AND SOUTHBOUND ON NW 104TH AVE FROM 112+95 TO 126+00

- NOTES:

  1. COMPLY WITH ADA REQUIREMENTS FOR ALL CURB RAMPS AND
- 2. ALL SIGNING AND PAVEMENT MARKING (TO REMAIN) IMPACTED BY THE PROPOSED WORK MUST BE PROPERLY RESTORED.

				MANUEL HEROM
Revision	By Appd. YY.MM.DD	Issued	By Appd. YY,MM.DD	Seal No. 47660  STATE OF  CARLOS A GERBON PAR REGISTER DE PROPER STATE OF PAGE PAGE STATE OF PAGE PAGE STATE OF PAGE PAGE PAGE STATE OF PAGE PAGE PAGE PAGE PAGE PAGE PAGE PAGE
RIGINAL SHEET - ANSI D HORIZ			·	Mannan Ma


901 Ponce de Leon Blvd. Suite 900 www.stantec.com


The Contractor shall verify and be responsible for all dimensions, DO NOT scale the drawing- any errors or amissions shall be reported to Stantec without delay. The Copyrights to all designs and drawings are the property of Stantec, Reproductio or use for any purpose other than that authorized by Stantec is forbidden.

CITY OF DORAL LANDMARK AT DORAL TRAFFIC CALMING

NW 66TH ST FROM NW 102ND AVE TO NW 107TH AVE

SPEED LIMIT SIGNS INSTALLATION ON NW 104TH AVE Drawing No. C-03 of

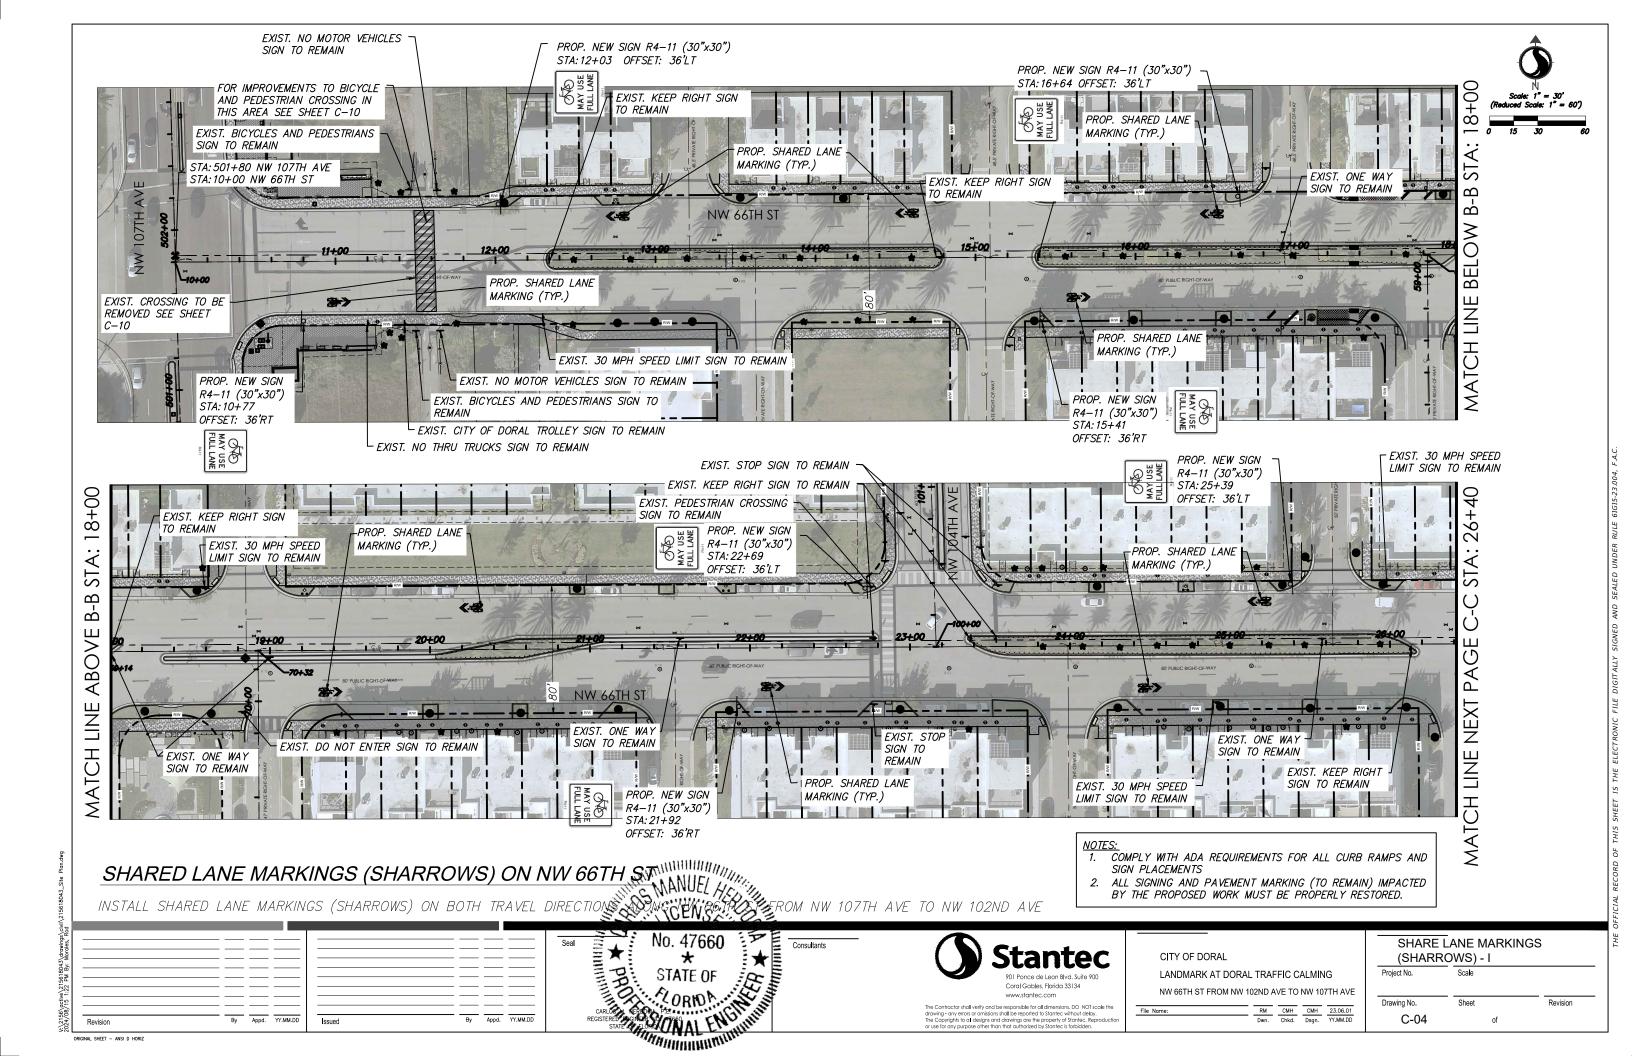

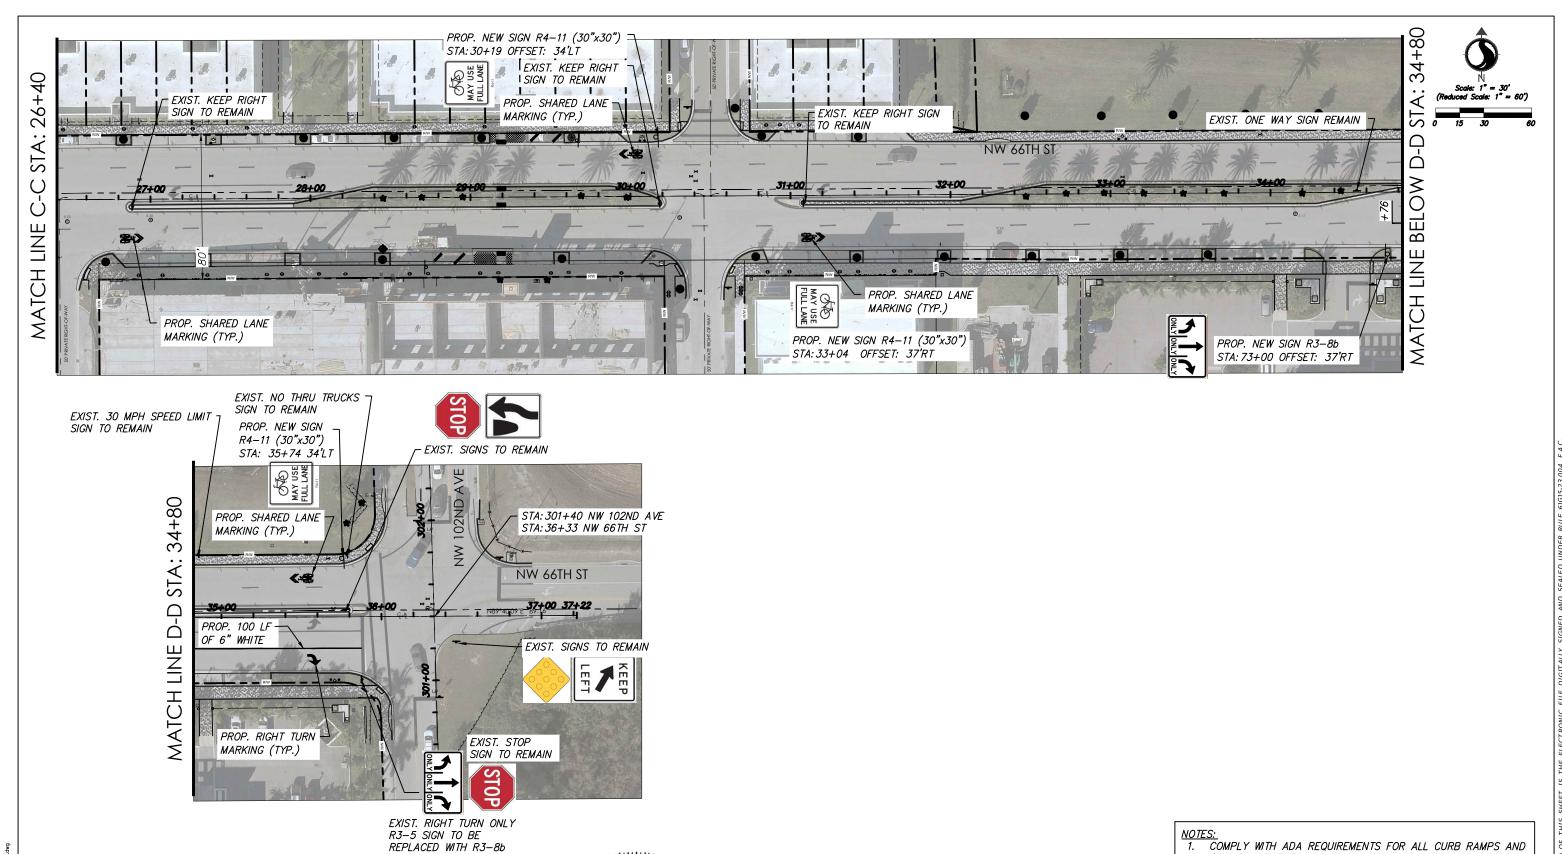

SHARED LANE MARKINGS (SHARROWS) ON NW 66TH STANDEL HELDER OF THE SHARED LANE MARKINGS (SHARROWS) ON BOTH TRAVEL DIRECTIONS AS INC. THE SECOND NW 107TH AVE TO NW 102ND AVE

- COMPLY WITH ADA REQUIREMENTS FOR ALL CURB RAMPS AND SIGN PLACEMENTS
- 2. ALL SIGNING AND PAVEMENT MARKING (TO REMAIN) IMPACTED BY THE PROPOSED WORK MUST BE PRÒPERLY RESTORED.


INSTALL SHARLD LANE WARR	NGS (SHARROWS) ON BOTT TRAVEL	- DIVECTIONS ASSOCIACION CON TON	III AVE TO NW TOZNO AVE
		Seal No. 47660  STATE OF	Stantec  901 Ponce de Leon Blvd. Suite 900 Coral Gables, Florida 33134 www.stontec.com
Revision By Appd. YY.MM.DI	Issued By Appd. YY.MM.DD	CARLOS A RERODA PLE REGISTERED PORTO 1960 STATE OF FLORID 1960	The Contractor shall verify and be responsible for all dimensions. DO NOT scale the drawing- any errors or amissions shall be reported to Stantec without deby. The Copyrights to all designs and drawings are the property of Stantec. Reproduction or use for any purpose other than that authorized by Stantec is forbidden.

TY OF DORAL NDMARK AT DORAL TRAFFIC CALMING


66TH ST FROM NW 102ND AVE TO NW 107TH AVE 
 RM
 CMH
 CMH
 23.06.01


 Dwn.
 Chkd.
 Dsgn.
 YY.MM.DD


SHARE LANE MARKINGS (SHARROWS) - II Drawing No. C-05 of

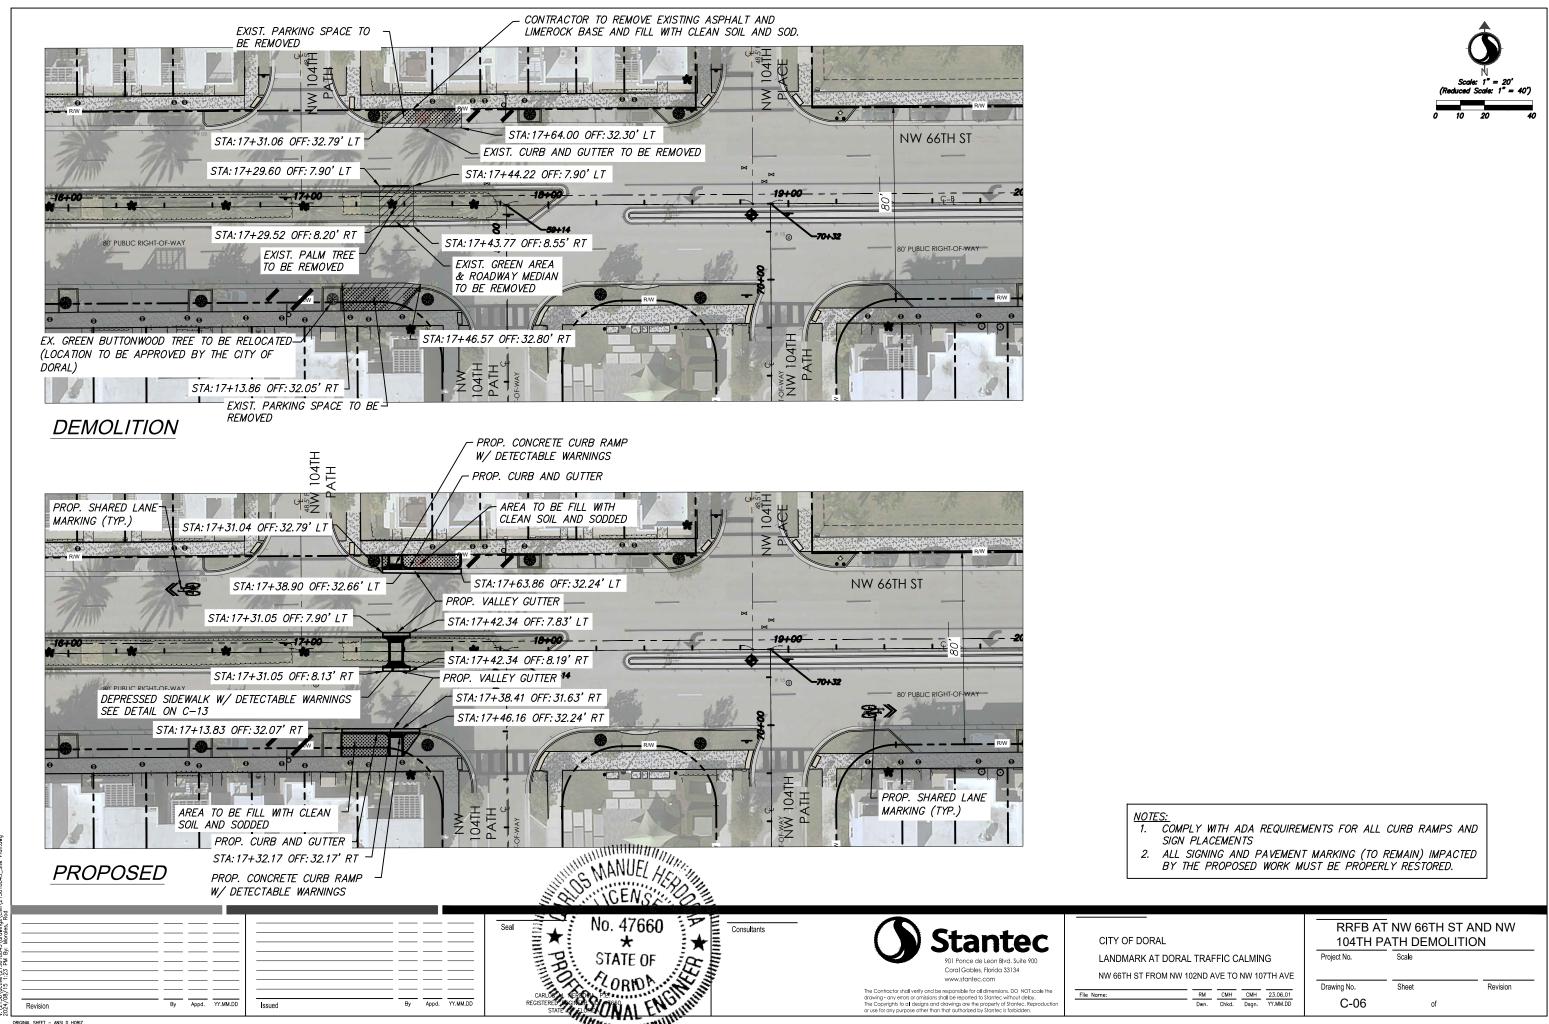


THE OFFICIAL RECORD OF THIS SHEET IS THE ELECTRONIC FILE DIGITALLY SIGNED AND SA

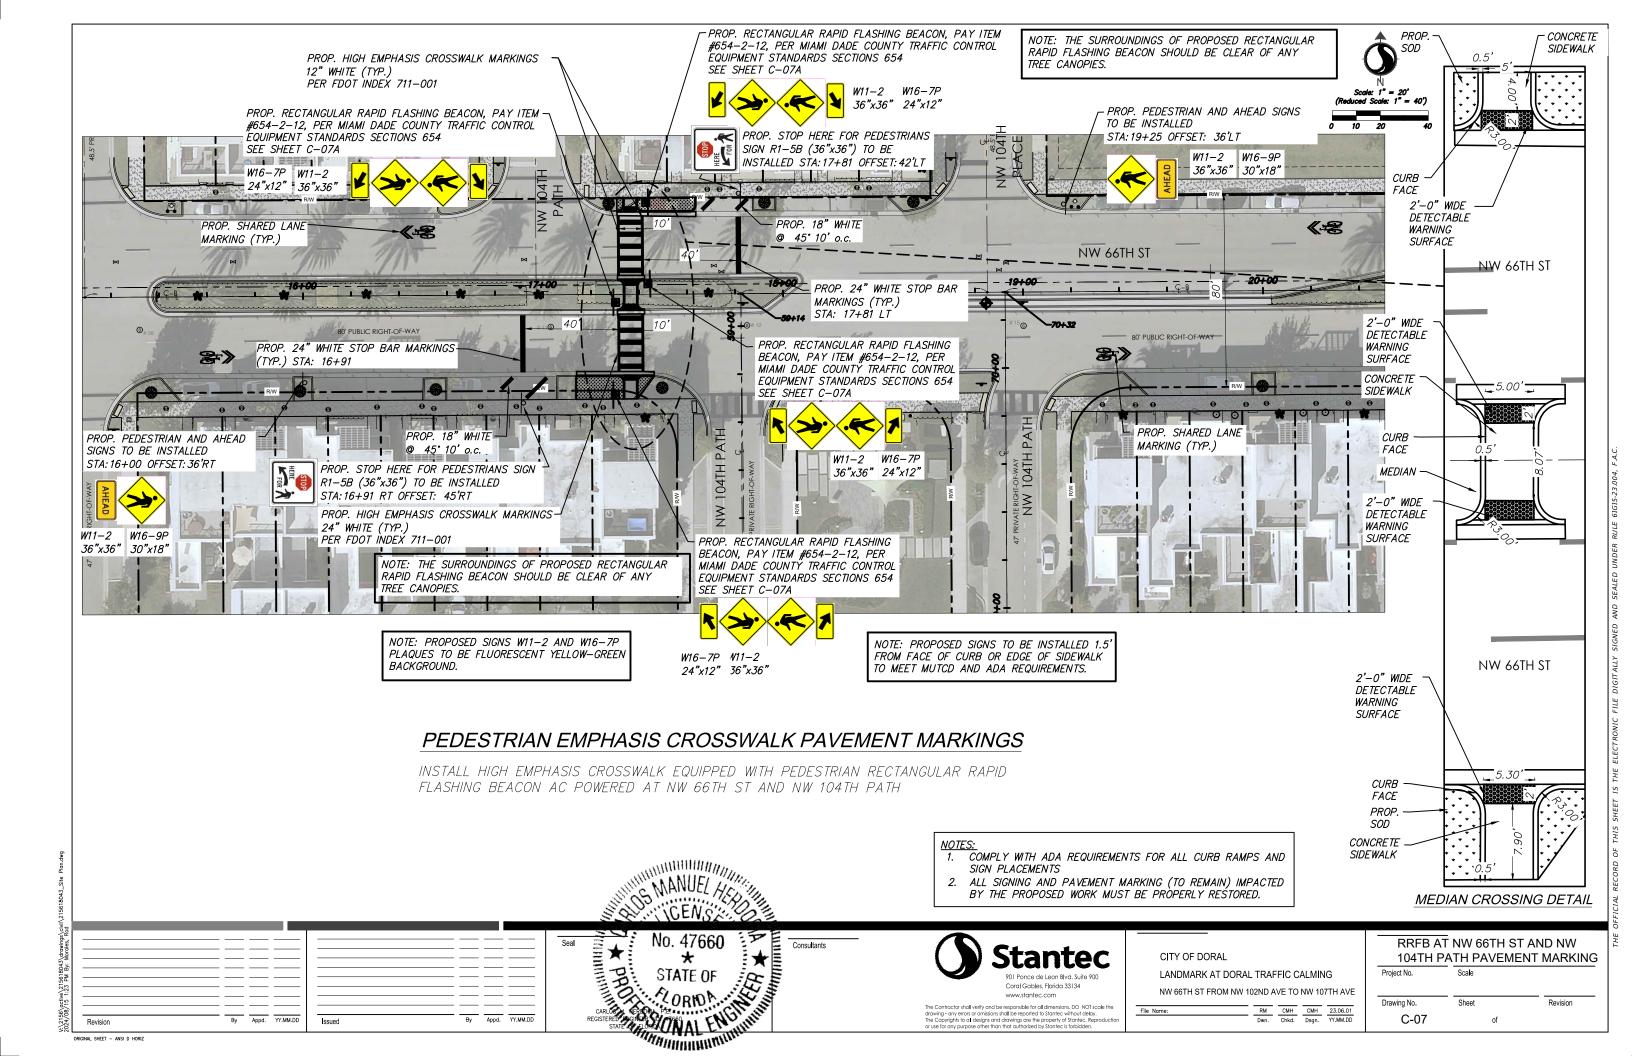


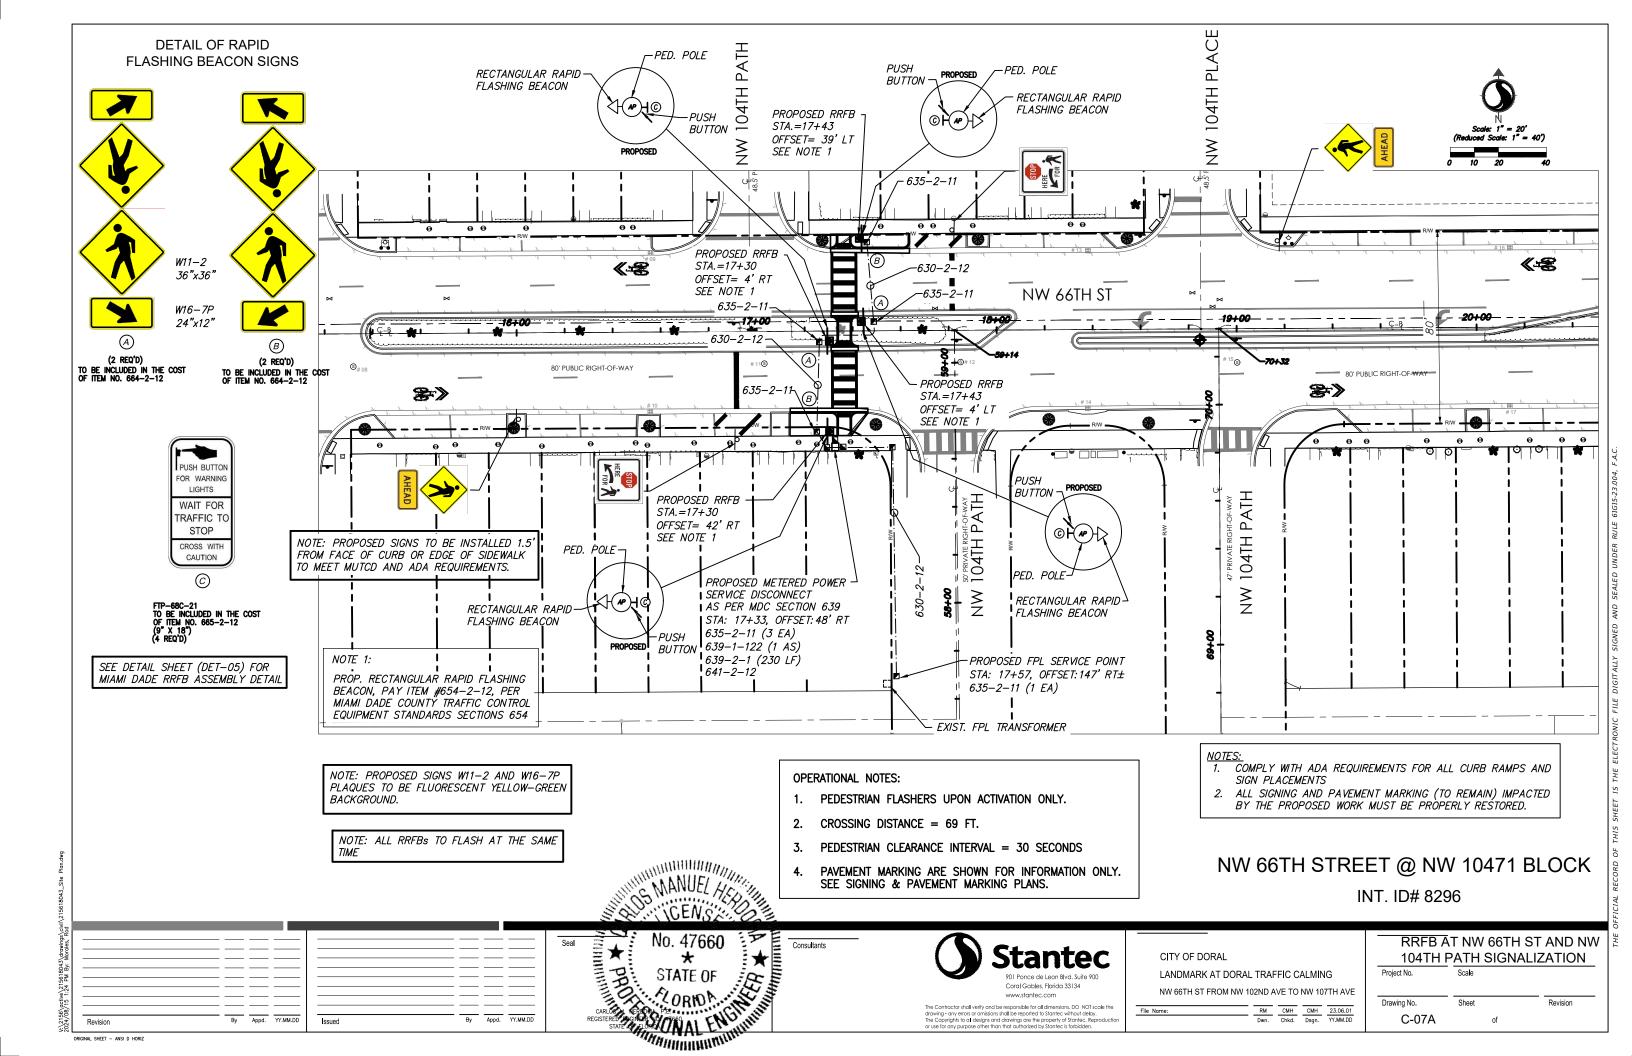


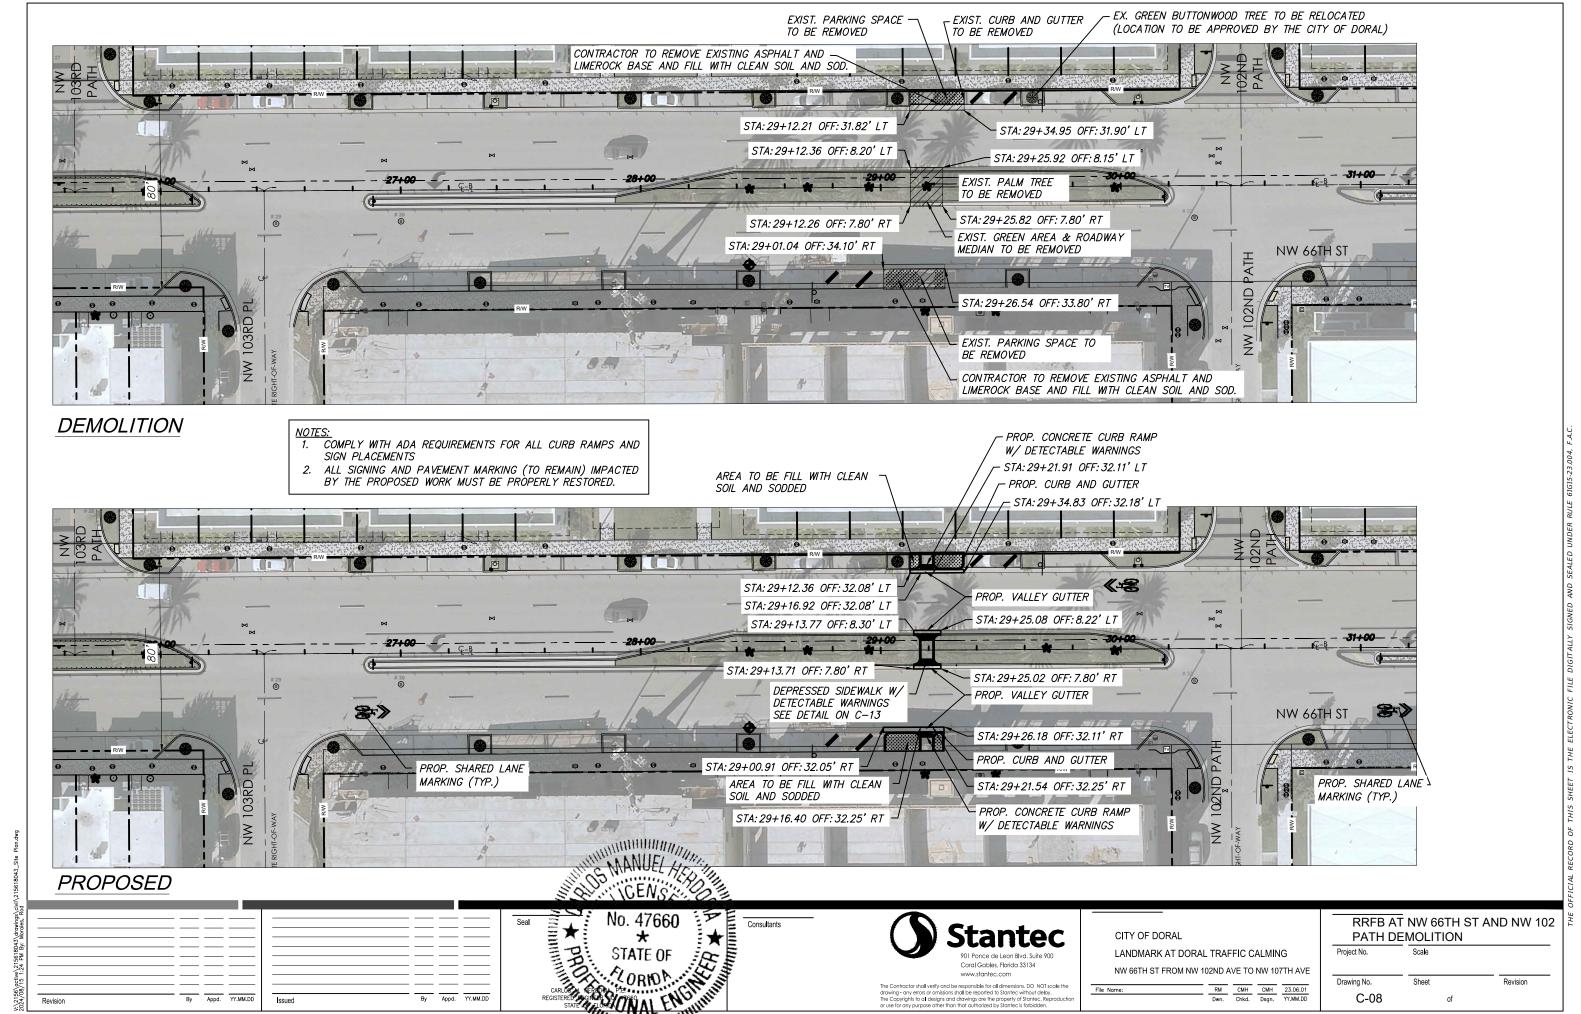


ORIGINAL SHEET - ANSI D HOI

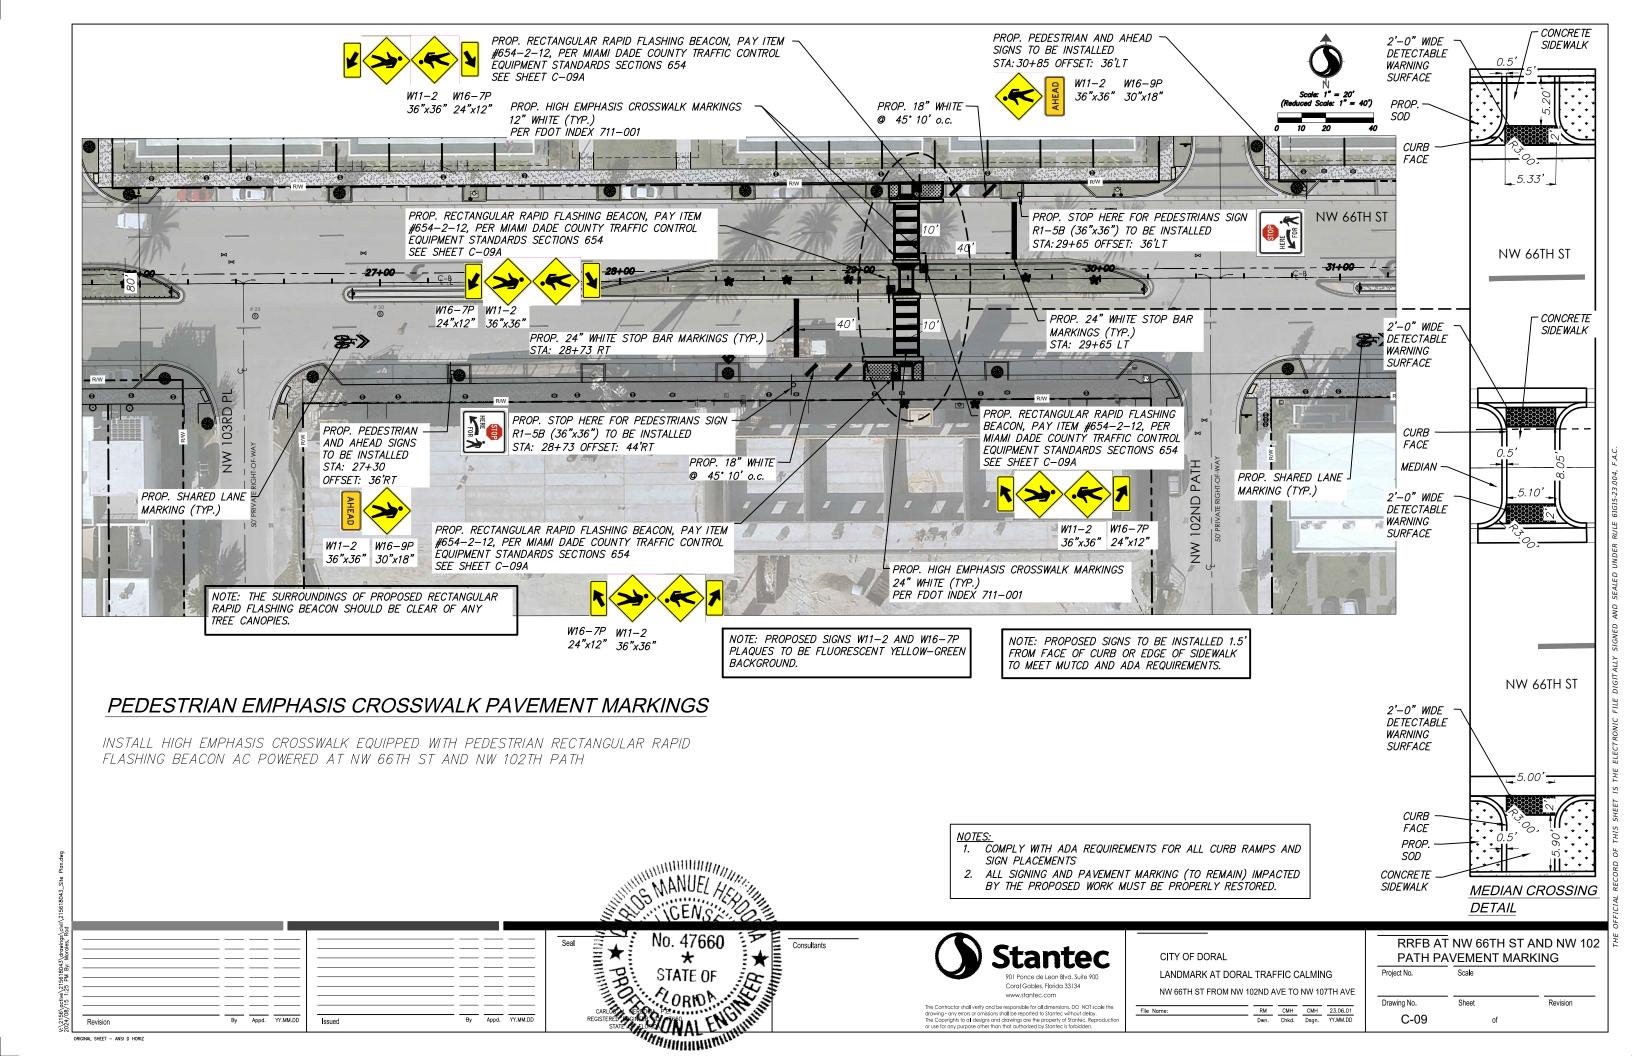


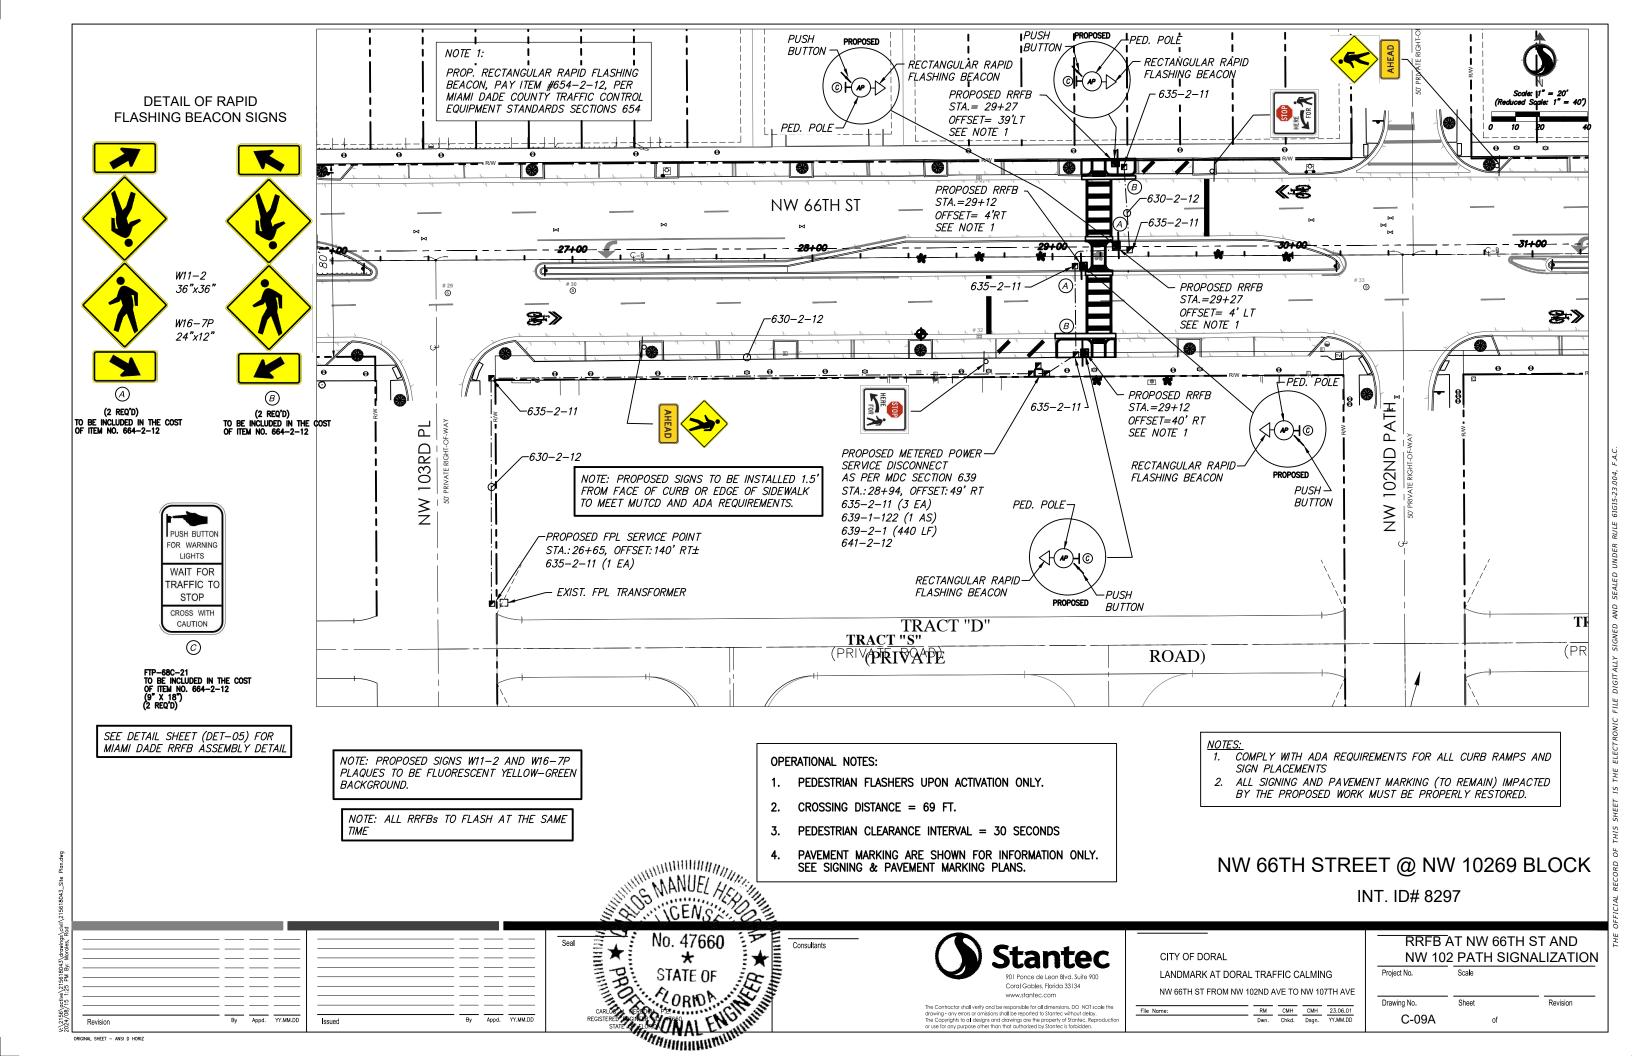


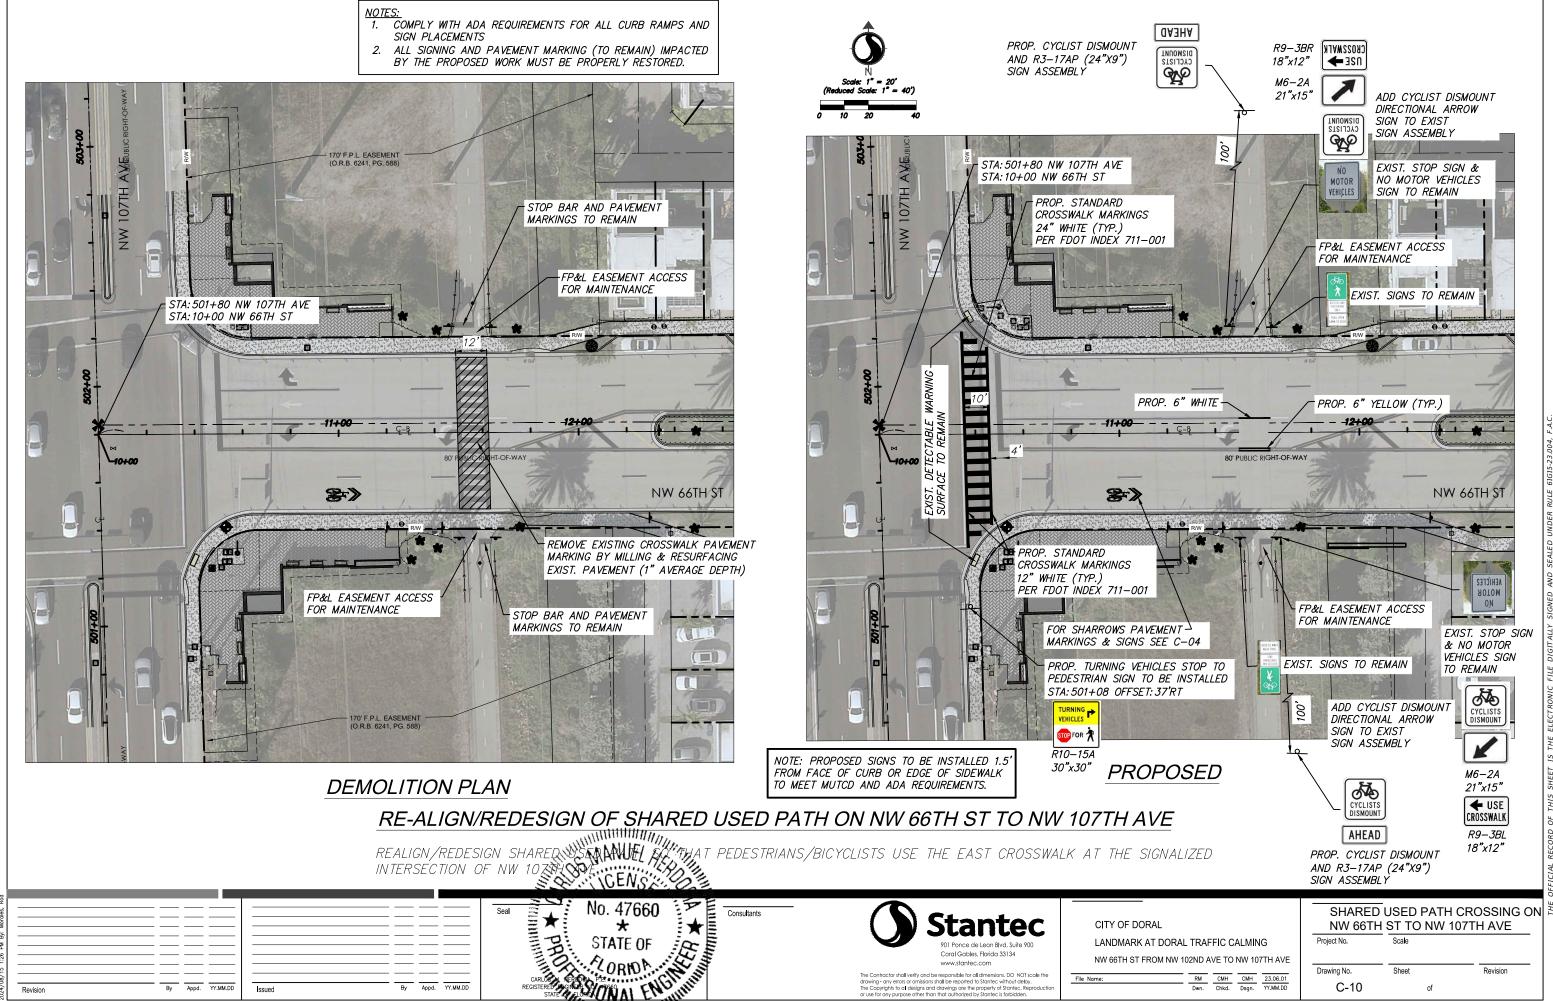


2156/active\215618043\drawings\civil\215618043\_

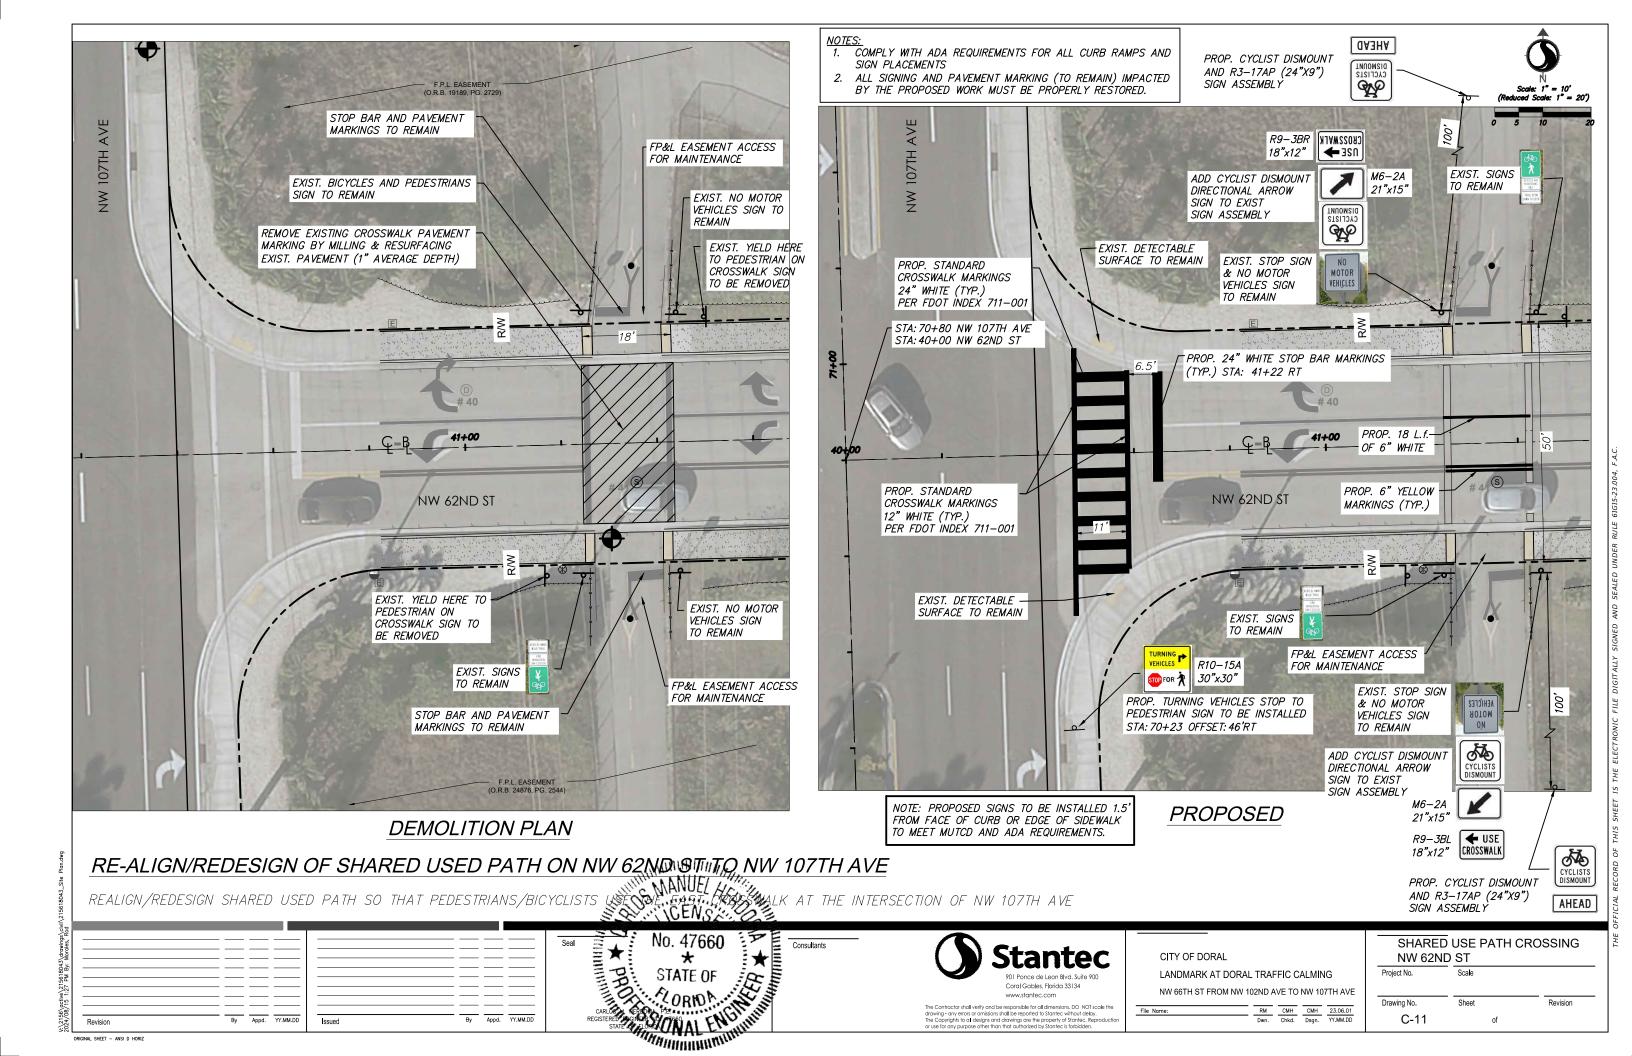

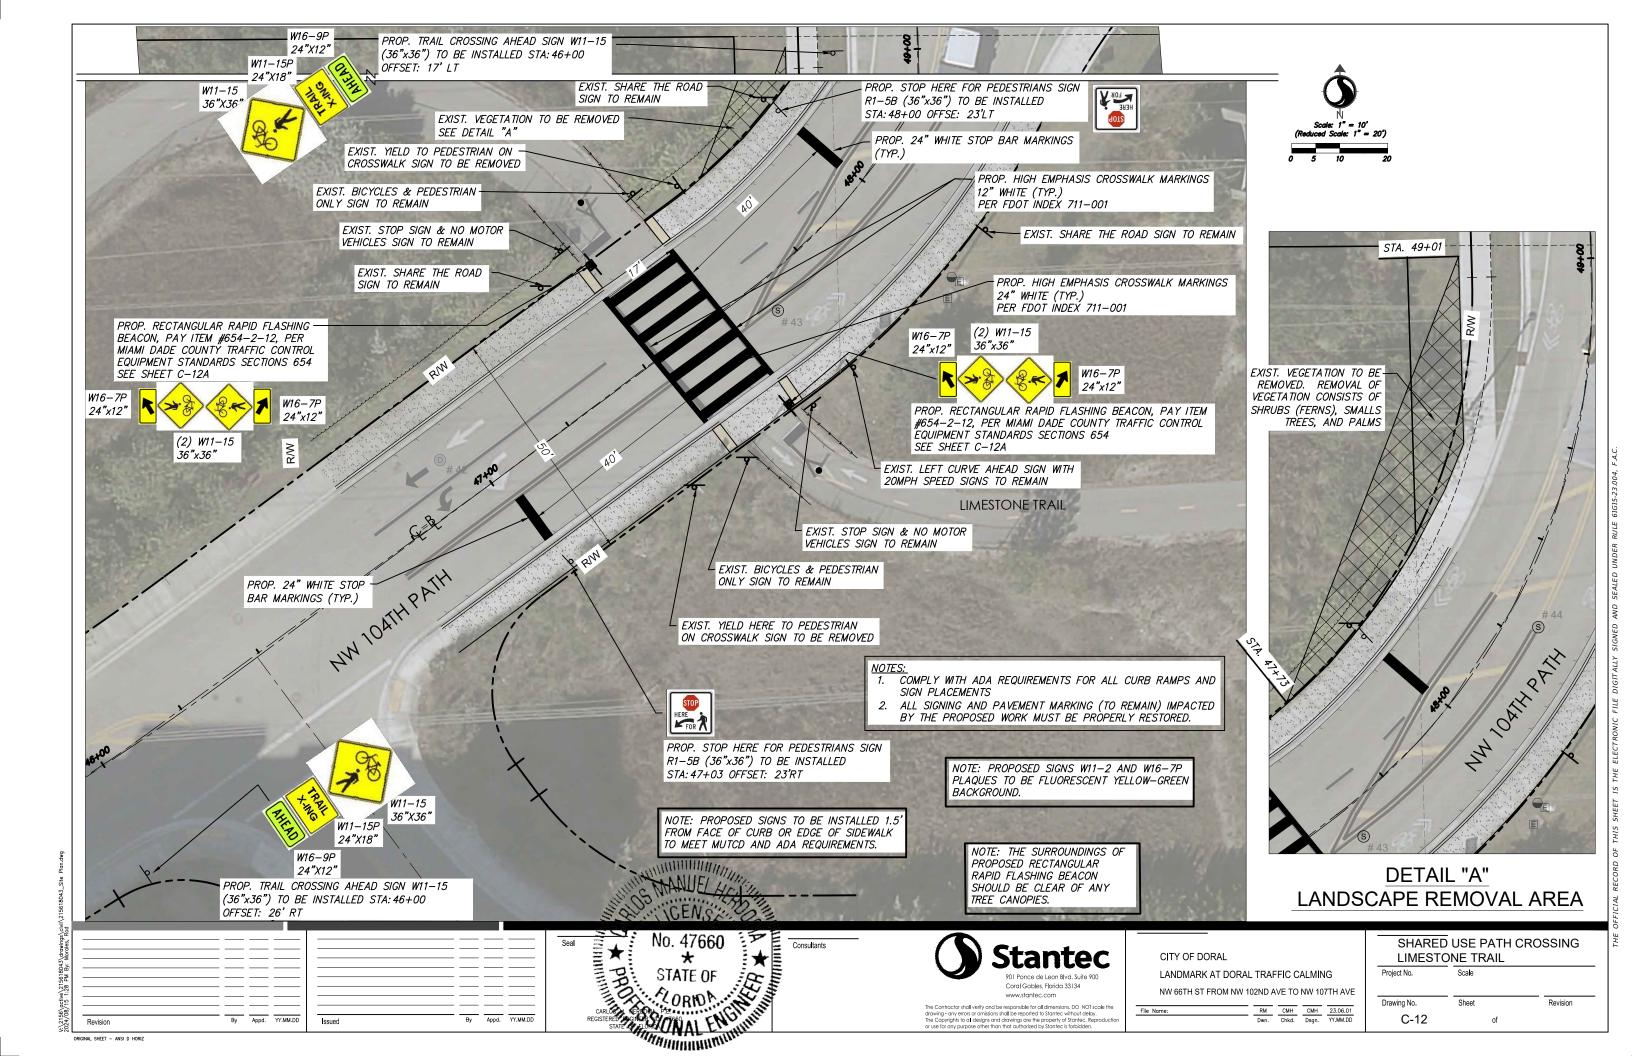

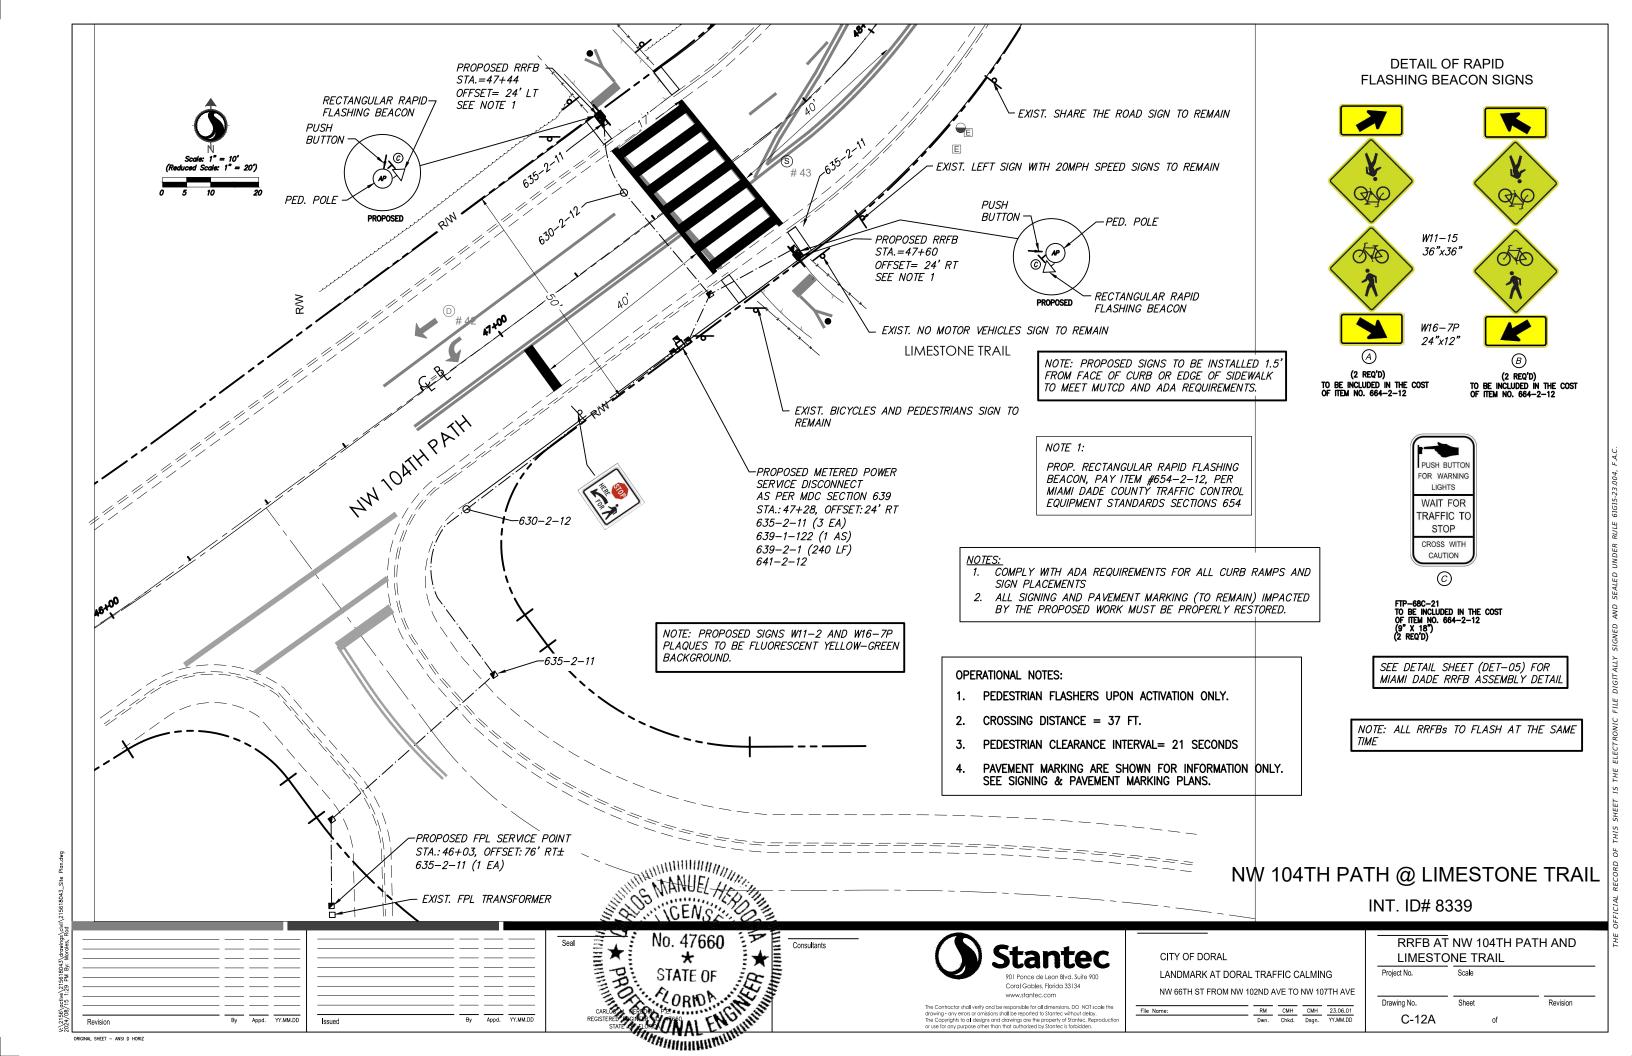

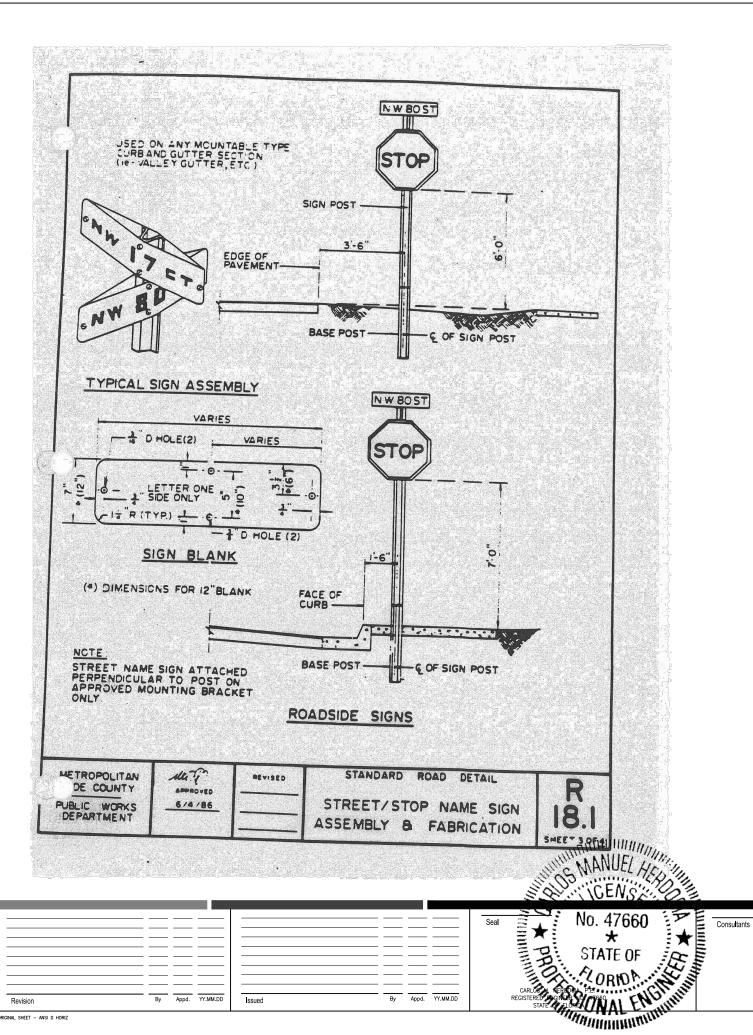

By Appd. YY.MM.DD

901 Ponce de Leon Blvd. Suite 900 www.stantec.com

The Contractor shall verify and be responsible for all dimensions, DO NOT scale the drawing - any errors or amissions shall be reported to Stantec without delay, the Copyrights to all designs and drawings are the property of Stantec, Reproduction or use for any purpose other than that authorized by Stantec is forbidden.

LANDMARK AT DORAL TRAFFIC CALMING NW 66TH ST FROM NW 102ND AVE TO NW 107TH AVE

CITY OF DORAL

 RM
 CMH
 CMH
 23.06.01

 Dwn.
 Chkd.
 Dsgn.
 YY.MM.DD

**DETAILS** Scale Project No. SEE PLANS C-13 of

Revision

By Appd. YY.MM.DD

#### NOTES:


- METER INSTALLATION CONNECTION AND ALL WORK RELATED TO ELECTRICAL POWER
   SERVICE SHALL BE COORDINATED WITH FPL UTILITY REPRESENTATIVE. COORDINATE EXACT
   LOCATION. FOUIPMENT DIMENSIONS. AND SERVICE INSTALLATION.
- 2. THE ELECTRICAL CONTRACTOR SHALL BE RESPONSIBLE FOR COORDINATING ELECTRICAL INSTALLATIONS WITH ALL OTHER TRADES TO AVOID ANY CONFLICTS.
- 3. ALL NEW WIRING SHALL BE INSTALLED IN CONDUIT WITHOUT EXCEPTION. MINIMUM SIZE CONDUIT SHALL BE 3/4".
- ALL NEW CONDUCTORS SHALL BE TYPE THHN/THWN-2 90C COPPER FOR #10 AND SMALLER AND XHHW-2 FOR #8 AND LARGER.
- 5. THE USE OF NO. 14 AWG COPPER CONDUCTORS SHALL BE RESTRICTED TO CONTROL AND INSTRUMENT WIRING.
- 6. ALL ELECTRICAL EQUIPMENT SHALL BE GROUNDED IN ACCORDANCE WITH ARTICLE 250 OF THE
- ALL CUTTING AND PATCHING REQUIRED FOR THE INSTALLATION OF NEW RACEWAYS OR EQUIPMENT SHALL BE PERFORMED BY A TRADESMAN EXPERIENCED IN THE WORK REQUIRED. ALL FINISHES SHALL MATCH EXISTING ADJACENT SURFACES.
- 8. THE ELECTRICAL CONTRACTOR SHALL BE RESPONSIBLE FOR ANY LOSS OR DAMAGE CAUSED BY HIM OR HIS WORKMAN TO THE LOCATION DURING THE COURSE OF CONSTRUCTION. THE ELECTRICAL CONTRACTOR SHALL BE RESPONSIBLE FOR REPAIRING OR REPLACING SUCH LOSS OR DAMAGE AT NO ADDITIONAL COST TO THE OWNER.
- THE ELECTRICAL WORK SHALL COMPLY WITH ALL APPLICABLE CITY, COUNTY, STATE AND SERVING ELECTRICAL UTILITY CODES, ORDINANCES, RULES AND REGULATIONS. THE ENTIRE ELECTRICAL INSTALLATION SHALL COMPLY WITH OR SURPASS THE LATEST EDITION OF THE NATIONAL ELECTRICAL CODE
- THE ELECTRICAL CONTRACTOR SHALL FURNISH ALL MATERIALS, TOOLS, LABOR, PLAN CHECK FEES, ETC., FOR A COMPLETE ELECTRICAL INSTALLATION UNLESS OTHERWISE NOTED ON PLANS
- 11. ALL MATERIALS FURNISHED BY THE ELECTRICAL CONTRACTOR SHALL BE NEW AND OF FIRST CLASS QUALITY, SHALL BE U.L. LISTED AND FREE OF ANY DEFECTS UNLESS OTHERWISE NOTED ON PLANS.
- 12. ALL EQUIPMENT SHALL BE RATED FOR USE INTENDED VOLTAGE, H.P., ETC. ALL DISCONNECT SWITCHES FURNISHED SHALL BE LOAD BREAK RATED.
- 13. ALL NECESSARY PERMITS REQUIRED FOR ELECTRICAL INSTALLATIONS ARE THE RESPONSIBILITY OF THE ELECTRICAL CONTRACTOR AND SHALL BE CONSIDERED TO BE PART OF HIS CONTRACT FEE.
- 14. THE ELECTRICAL CONTRACTOR SHALL FULLY GUARANTEE THE INSTALLATION FOR A PERIOD OF ONE YEAR FROM THE DATE OF FINAL ACCEPTANCE BY THE OWNER AGAINST IMPERFECT WORKMANSHIP AND MALFUNCTION OF EQUIPMENT. ANY WORK FOUND TO BE DEFECTIVE WITHIN THIS PERIOD SHALL BE REPAIRED OR REPLACED PROMPTLY AT NO ADDITIONAL COST TO THE OWNER.
- 15. DRAWINGS ARE DIAGRAMMATIC IN NATURE AND CANNOT SHOW EVERY CONNECTION, JUNCTION BOX, WIRE, CONDUIT, ETC. THE EXACT LOCATION AND ARRANGEMENT OF ALL PARTS SHALL BE DETERMINED AS THE WORK PROGRESSES. THE CONTRACTOR SHALL BE RESPONSIBLE FOR PROVIDING A COMPLETE AND FUNCTIONAL ELECTRICAL SYSTEM.
- 16. ALL SERVICE EQUIPMENT SHALL BE U.L. LISTED..
- 17. ELECTRICAL CONTRACTOR TO VERIFY AND PROVIDE EQUIPMENT GROUNDING CONDUCTOR AS PER NEC 250. ALL EXPOSED METAL PARTS ARE TO BE BONDED TO THE GROUND SYSTEM.

#### KEYED NOTES

- THE ENCLOSURE SHALL BE NEMA 4X POLE MOUNTED, RIGIDLY ATTACHED TO THE POLE FACE. THE ENCLOSURE DOOR SHALL BE LOCKABLE BY PADLOCK AND FOUR KEYS PROVIDED. NO SCREWS TO BE USED TO ATTACH DOOR.
- $\ \, \bigcirc$  SPD SHALL BE WIRED INSIDE THE ENCLOSURE. PROVIDE SQUARE D SDSA1175 OR APPROVED EQUIVALENT. CONNECT PER MANUFACTURER INSTRUCTIONS.
- $\langle 3 \rangle$  MODIFY EMBEDMENT DEPTH AS REQUIRED BY FIELD CONDITIONS.
- 4 BOND RGS CONDUIT TO GROUNDING ELECTRODE CONDUCTOR AT BOTH ENDS.

By Appd. YY.MM.DD

- $_{\overline{5}}$  NEW SIGN WITH TWO MESSAGE BOARDS (ONE ON EACH SIDE). ALPHA ECLIPSE STREET SMART 48X64 AMBER, 17MM, WITH CELLULAR RADIO.
- THE CONTRACTOR SHALL FURNISH ARC FLASH PROTECTION LABEL ON THE MESSAGE BOARD SERVICE DISCONNECTING MEANS. THE LABEL SHALL BE BASED OFF THE AVAILABLE FAULT CURRENT PROVIDED BY THE ELECTRIC UTILITY AND FURNISHED EQUIPMENT. THE LABEL SHALL INCLUDED INCIDENT ENERGY, ARCH FLASH PROTECTION BOUNDARIES AND PERSONAL PROTECTIVE EQUIPMENT (PPE).

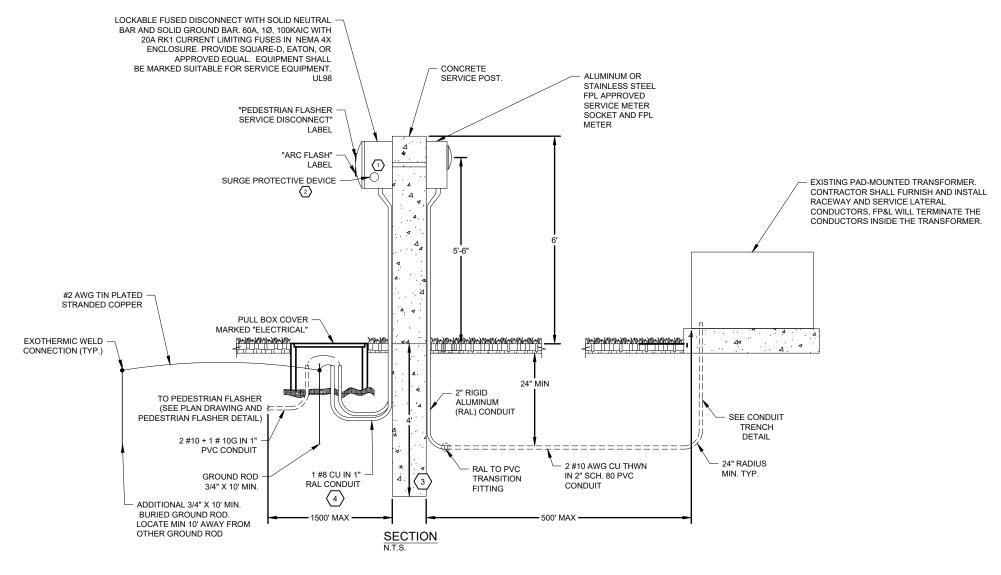

#### PIPING LEGEND:

PVC SCHEDULE 40 CONDUIT (UNLESS OTHERWISE NOTED). REFER TO PLANS FOR SIZING.

RGS CONDUIT. REFER TO PLANS FOR SIZING AND QUANTITY.

TYPICAL SERVICE POINT DETAIL

DESCRIPTION VA FLASHING BEACONS (4x@30VA EA 120 TOTAL LOAD 120 AMPS@120V=1A

TYPICAL SERVICE LOAD CALCULATION



By Appd. YY.MM.DD

Stanted
901 Ponce de Leon Blvd. Suite 900
Cord Gobbes, Florido 33134
www.stontec.com

The Contractor shall verify and be responsible for all dimensions, DO NOT scale the drawing - any errors or omissions shall be reported to Stantec without delay. The Copyrights to all designs and clawings are the property of Stantes. Reproduction or use for any purpose other than that authorized by Stantes to footbase.

CITY OF DORAL

LANDMARK AT DORAL TRAFFIC CALMING

NW 66TH ST FROM NW 102ND AVE TO NW 102TH


V:\2156\active\215618043\drawings\electrica\18043\_E-01

Revision

ORIGINAL SHEET - ANSI D HORIZ

OPTION

#### CONDUIT BURIED WHEN **CROSSING ROAD**

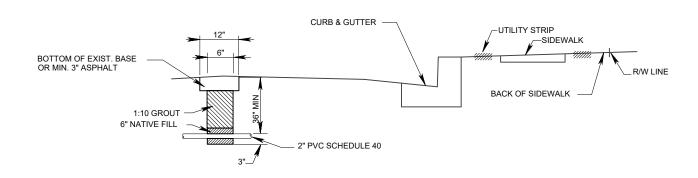


TRENCH NOT TO BE OPENED MORE THAN 250' AT A TIME

\* MAY BE ADJUSTED IN FIELD DUE TO FIELD CONDITIONS AS DIRECTED BY THE ENGINEER.

By Appd. YY.MM.DD

**OPTION** 

#### **CONDUIT BURIAL IN ROADWAY**

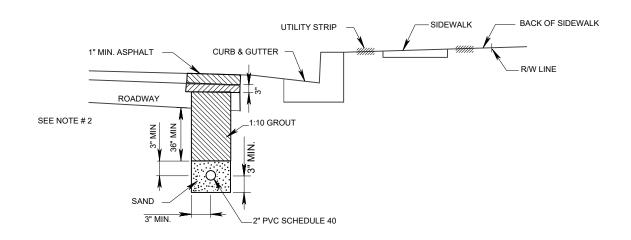

NOTE:


- 1. TRENCH NOT TO BE OPENED MORE THAN 250' AT A TIME.
- 2. THIS AREA SHALL BE BACKFILLED WITH TYPE S-1 ASPHALTIC CONCRETE TO WITHIN 1 INCH OF FINISHED GRADE.

\* MAY BE ADJUSTED IN FIELD DUE TO FIELD CONDITIONS AS DIRECTED BY THE ENGINEER.

RECORD OF THIS SHEET IS THE ELECTRONIC FILE


OPTION (3)

> CONDUIT IN UTILITY AND **BACK OF SIDEWALK**

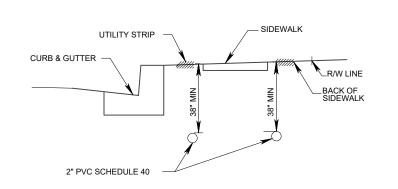

By Appd. YY.MM.DD


**CONDUIT UNDER OPTION SIDEWALK** 

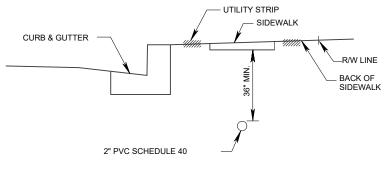

NOTE:
IN PLACING CONDUIT UNDER SIDEWALK
REPLACEMENT OF ENTIRE, SIDEWALK
SECTION SHALL BE NECESSARY AND EL

CONDUIT **DIRECTIONAL BORE** 

**OPTION** 

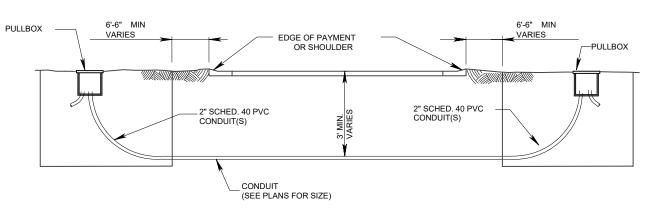

1. DIRECTIONAL BORING OPERATIONS SHALL BE DONE IN ACCORDANCE WITH THE F.D.O.T. UTILITY ACCOMODATION MANUAL.

No. 47660 \* STATE OF Coral Gables, Florida 33134 www.stantec.com

901 Ponce de Leon Blvd. Suite 900

The Contractor shall verify and be responsible for all dimensions, DO NOT scale the drawing - any errors or amissions shall be reported to Stantec without delay, the Copyrights to all designs and drawings are the property of Stantec, Reproductio or use for any purpose other than that authorized by Stantec is forbidden.


CITY OF DORAL LANDMARK AT DORAL TRAFFIC CALMING


Scale NO SCALE NW 66TH ST FROM NW 102ND AVE TO NW 107TH AVE Drawing No. Sheet E-02

**ELECTRICAL DETAILS** 

of

Revision

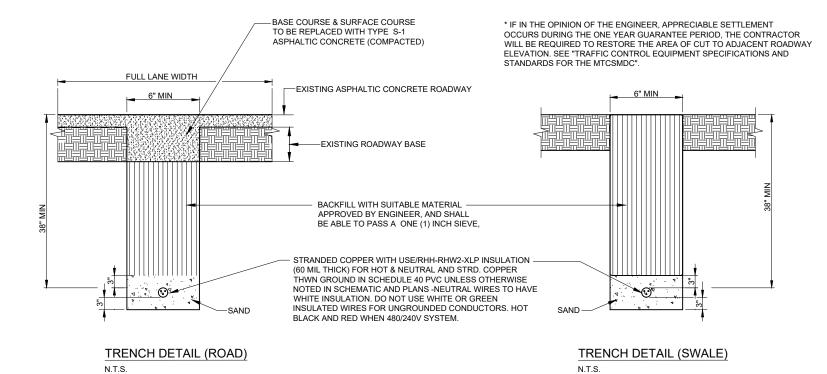

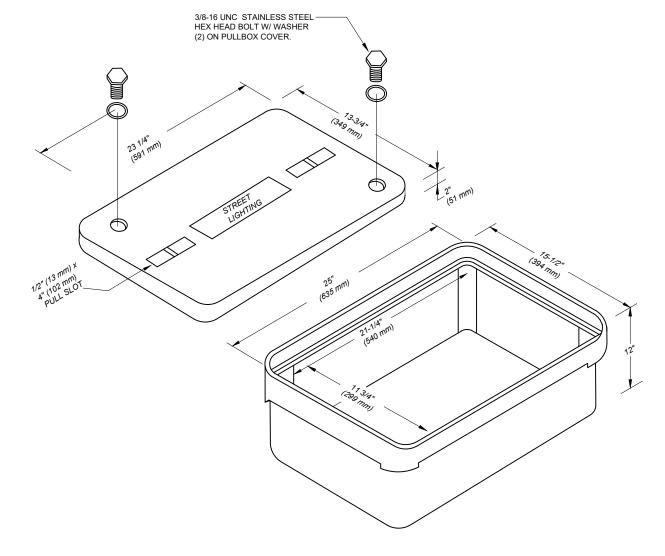


#### PULL BOX SPECIFICATION

- 1. PULL BOXES SHALL HAVE AN OPEN-BOTTOM, QUAZITE POLYMER CONCRETE DESIGN OR PRECAST CONCRETE DESIGN CONSTRUCTED OF CLASS I CONCRETE HAVING A MINIMUM COMPRESSIVE STRENGTH OF 2,500 PSI AT TWENTY- EIGHT (28) DAYS. POLYMER CONCRETE PULL BOX SHALL BE QUAZITE PRODUCT NO. PG1324BA12 OR APPROVED EQUIVALENT. CONCRETE PULL BOX SHALL BE BROOKS 38 SERIES OR APPROVED EQUIVALENT. IN EITHER CASE, BOTH PULL BOXES SHALL BE CONSTRUCTED PER ABOVE SPECIFIED MANUFACTURERS SIZE, MATERIALS AND PERFORMANCE SPECIFICATIONS. THEREFORE, BELOW SPECIFIED PULL BOX COVER SHALL BE FULLY INTER- CHANGEABLE WITH EITHER PULL BOX. ALL PULL BOX COVERS FURNISHED AND INSTALLED SHALL BE POLYMER CONCRETE QUAZITE PRODUCT NO. PG1324HA00 OR APPROVED EQUIVALENT. PULL BOX COVERS SHALL BE MARKED "ELECTRIC".
- 2. IN SITUATIONS WHERE PULL BOX IS LOCATED OUTSIDE OF SIDEWALK, i.e. SWALE AREA. THE PULL BOX IS TO HAVE A 6'x5' MIN CONCRETE APRON (6" THICK) PLACED AROUND IT. COST OF CONCRETE APRON IS TO BE INCLUDED IN THE PULL BOX INSTALLATION COST.

**PULL BOX DETAIL** 

N.T.S.

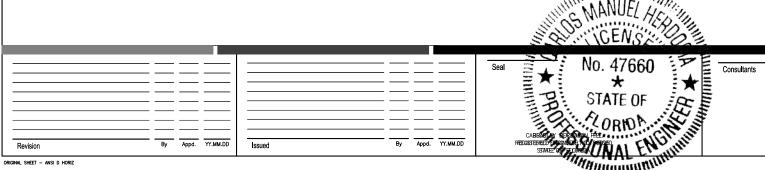

901 Ponce de Leon Blvd. Suite 900 Coral Gables, Florida 33134 www.stantec.com


The Contractor shall verify and be responsible for all dimensions. DO NOT scale the drawing - any errors or amissions shall be reported to Stantec without delay, the Copyrights to all designs and drawings are the property of Stantec, Reproduction or use for any purpose other than that authorized by Stantec is forbidden.

CITY OF DORAL LANDMARK AT DORAL TRAFFIC CALMING NW 66TH ST FROM NW 102ND AVE TO NW 107TH AVE


**ELECTRICAL DETAILS** NO SCALE Drawing No. Sheet E-03 of

# NOTES:


- 1. Where crosswalk markings are used, ramps must fall within the crosswalk limits. A clear space of 48" minimum is required at the bottom of the ramp within a marked crosswalk. If crosswalk markings are not present, a clear space of 48" minimum is required at the bottom of the ramp outside of active travel lanes.
- 2. Crosswalk widths and configurations vary; must conform to Index 711-001.
- 3. Flangeway Gap may be up to 3" for Freight-only Railways.

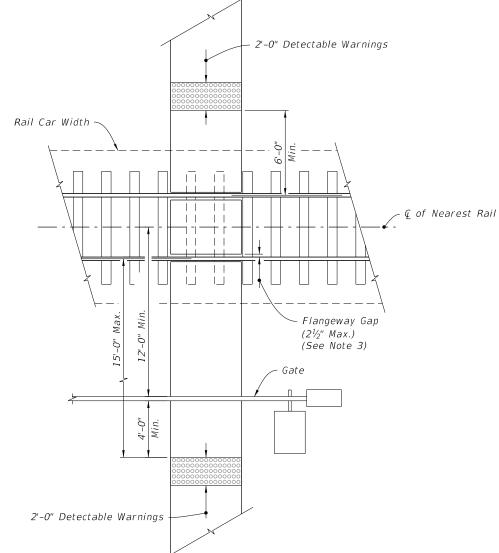

= RAILROAD CROSSING =====

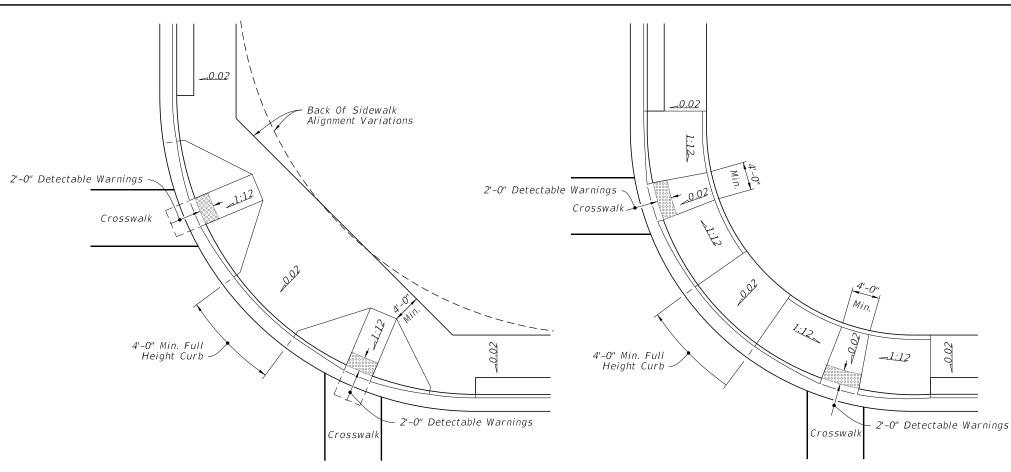

#### CURB RAMPS WITHIN RADIAL RETURN

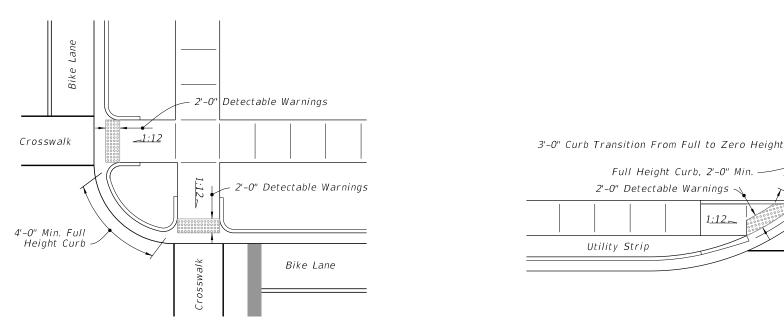

CURB RAMPS OUTSIDE RADIAL RETURN

LINEAR SIDEWALK RAMPS

=PLACEMENT OF SIDEWALK CURB RAMPS AT CURBED RETURNS (TYP.)=

RAILROAD CROSSING AND CURB RAMPS AT CURBED RETURNS

REVISION 11/01/20

DESCRIPTION:


FY 2024-25 STANDARD PLANS

DETECTABLE WARNINGS AND SIDEWALK CURB RAMPS

INDEX 522-002

SHEET 7 of 7

Crosswalk

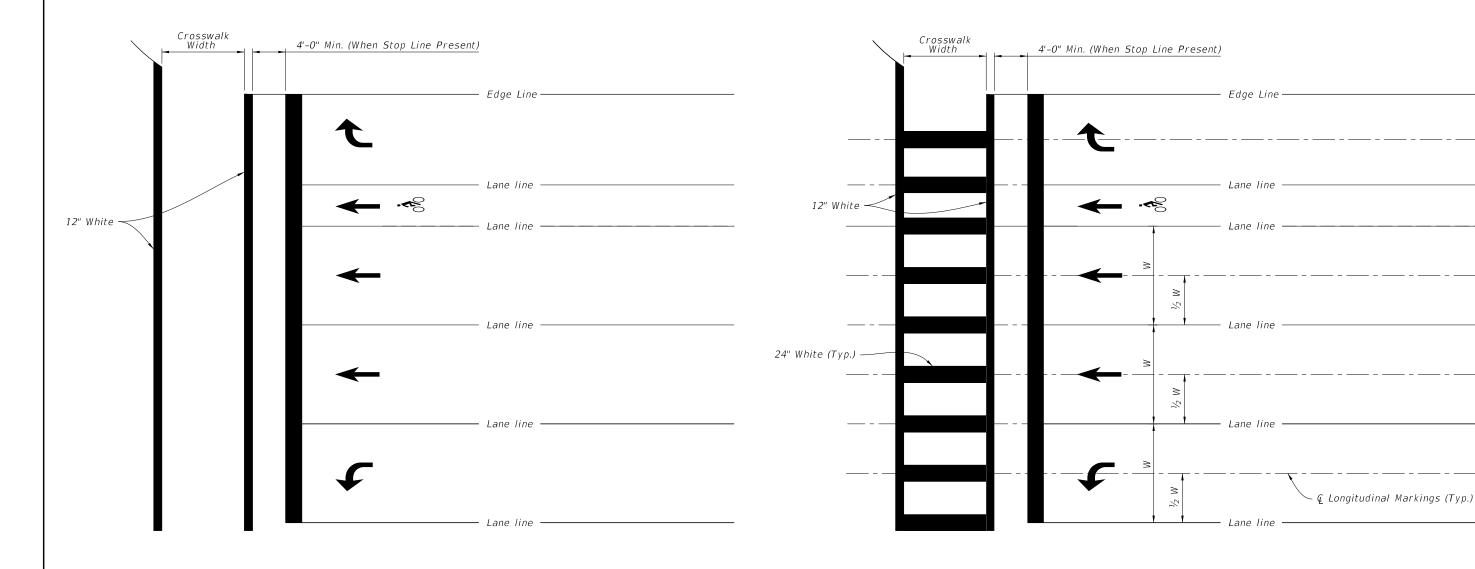

STANDARD CROSSWALK DETAILS =

SPECIAL EMPHASIS CROSSWALK DETAILS


#### NOTES:

- 1. For crosswalk width, exceed width of the adjacent sidewalk, but do not make width less than 6' for intersection crosswalks and 10' for midblock crosswalks. Measure width from the inside of the transverse crosswalk markings.
- 2. When the Special Emphasis Crosswalk is not perpendicular to the lane lines, make the longitudinal markings parallel to the lane lines.
- 3. Refer to Index 522-002 when Curb Ramps are present.


FDOT

DESCRIPTION:


8.1 S.F.

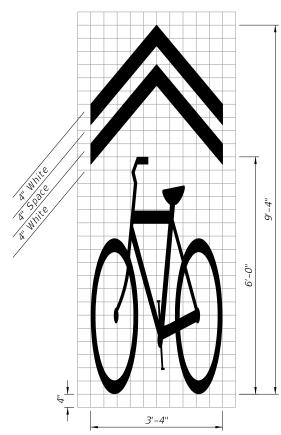


SHARED LANE MARKING (SLM)

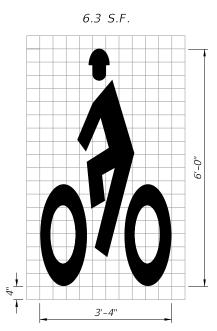

HELMETED BICYCLIST SYMBOL

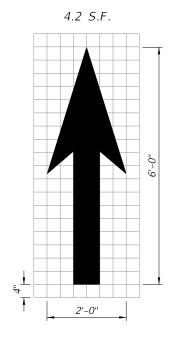

BIKE LANE ARROW

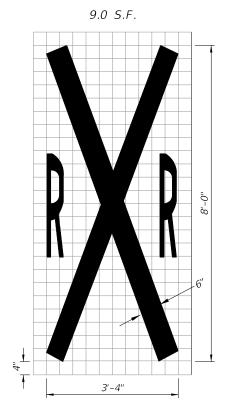

RAILROAD CROSSING


#### NOTES:


- 1. All bicycle markings and pavement messages shall be White.
- 2. All bicycle markings shall be preformed thermoplastic.
- 3. All grids are 4" x 4".


= STANDARD PAVEMENT MARKING MESSAGE LAYOUTS =

≥ DESCRIPTION:

### SPEED HUMP GENERAL DETAILS

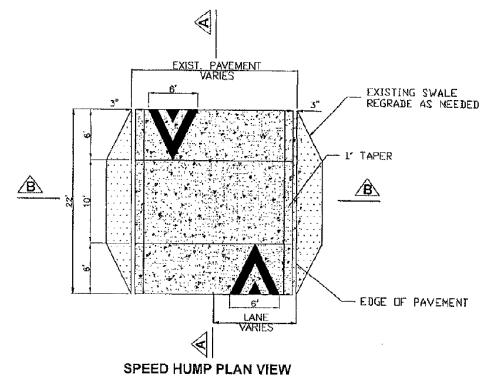

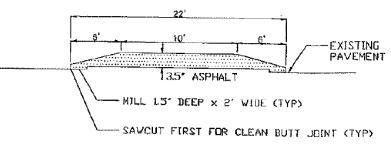

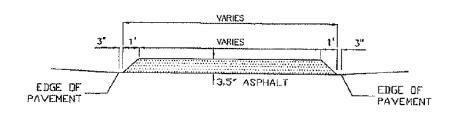

SECTION A - A

SECTION B - B N.T.S.

REFERENCE: MUTCD SECTION-3B.25 & 3B.26

-24 RPM total for Center Line & Speed Hump as shown.

-Paint:

250' of 2-6" Yellow Each Hump 100' of 12" White Each Hump


#### DRAINAGE NOTE:


HUMP TO BE AT LEAST 3" AWAY FROM THE EDGE OF PAVEMENT ON BOTH SIDES IN ORDER TO ALLOW PROPER FLOW OF RUNOFF INTO THE EXISTING CATCH BASINS.
REGRADE EXISTING SWALE IF NEEDED.

#### NOTE:

-LOCATE SPEED HUMP AND SIGNS TO MINIMIZE IMPACT ON DRIVEWAYS -REMOVE ALL SIGNING AND MARKING IN CONFLICT WITH THE DESIGN.


#### SIGNS DETAILS

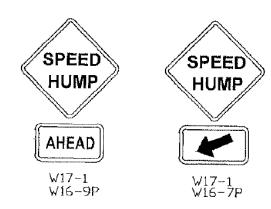


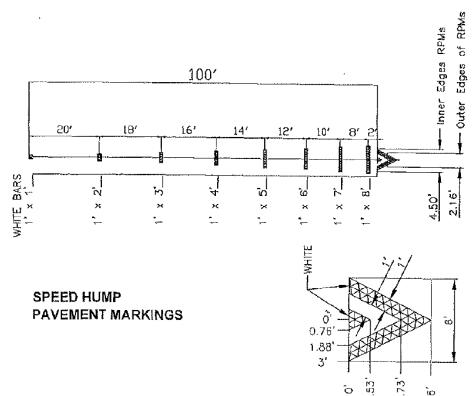



			_			
MIAMI-DADE	COUNTY	<u> </u>				A CONTRACTOR OF THE CONTRACTOR
PUBLIC WORKS AND WASTE MAN	AGEMENT DEPARTMENT	·		,,,,,		SPEED HUMPS GENERAL DETAILS
TRAFFIC ENGINEER	ING DIVISION				/	
PROJECT No	SHEET 1 OF 5	REV.	DATE	DESCRIPTION	BY:	A. SUAREZ 01/03/13 SHEET NO. 12A

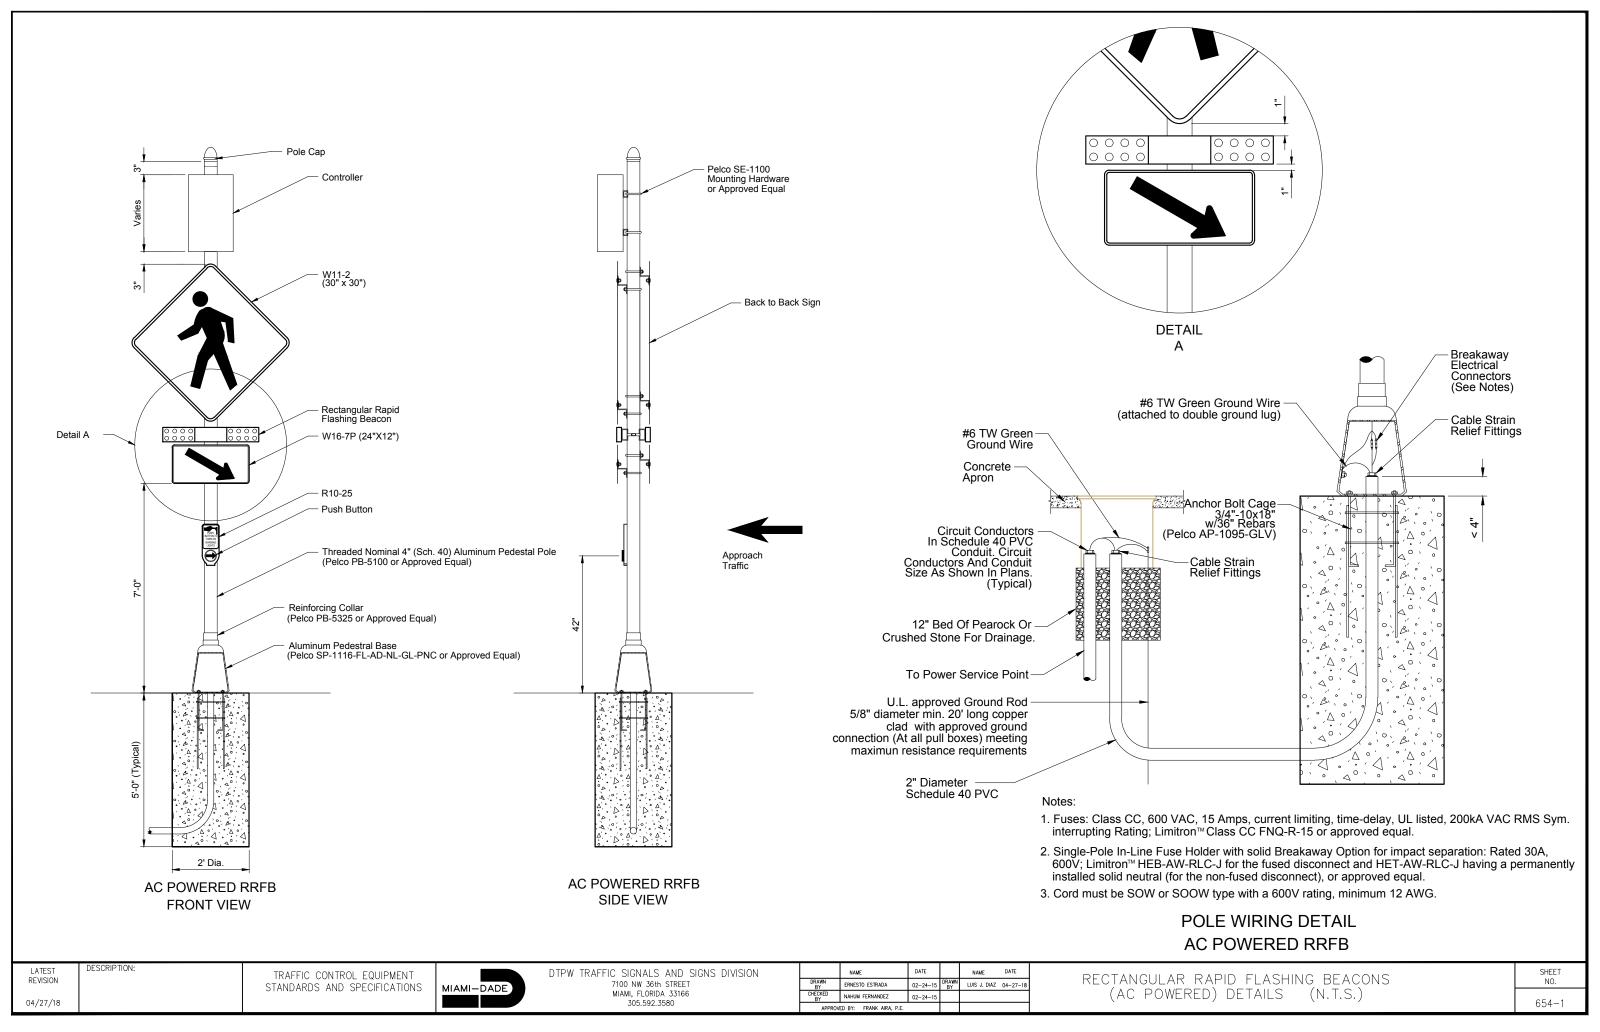

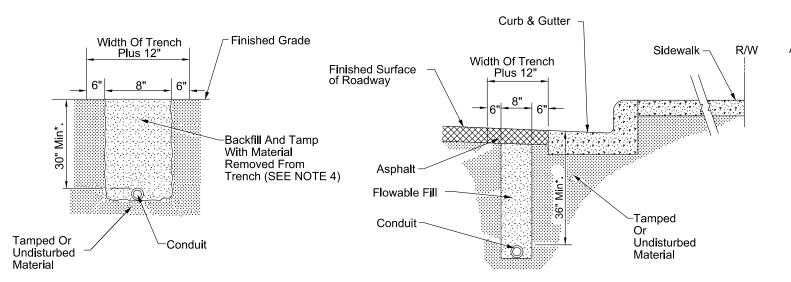

FOR USE IN AREAS NOT EXPOSED TO VEHICULAR TRAFFIC

FIGURE A

#### Notes:


- 1. Sidewalk patches to match existing joints.
- 2. Entire sidewalk slab must be replaced when specified in the plans.
- Backfill and tamp with material from trench except at driveways. At driveways, backfill a length of trench within the driveway entirely with Flowable Fill.
- 4. Remove and replace additional pavement within 6" of tench.

FOR USE IN ASPHALT ROADWAY ADJACENT TO GUTTER WHEN PLACEMENT OUTSIDE OF THE PAVEMENT IS NOT FEASIBLE.

#### FIGURE B

#### Notes:

- Trench not to be open more than 250' at a time when contruction area is subject to vehicular or pedestrian traffic.
- 2. Asphalt to be sawcut to leave neat lines at the pavement cut.

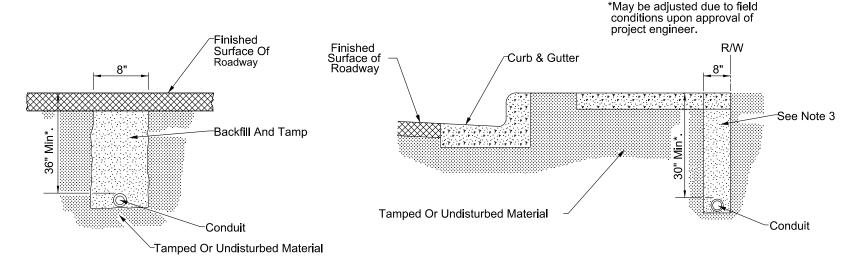


FOR USE INSTALLING CONDUIT UNDER A NEW ROADWAY PRIOR TO INSTALLATION OF BASE AND PAVEMENT

FIGURE D

FIGURE E

FOR USE IN INSTALLING CONDUIT UNDER SIDEWALK

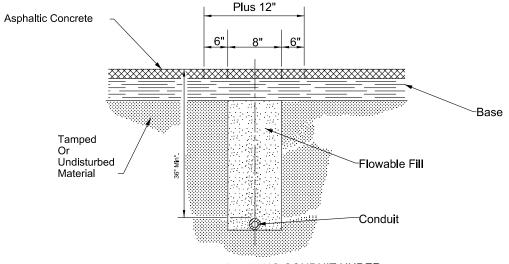


Width Of Trench

FOR USE IN INSTALLING CONDUIT UNDER EXISTING ASPHALT PAVEMENT NOT ADJACENT TO GUTTER WHEN JACKING OR DIRECT BORING IS NOT FEASIBLE

#### FIGURE C

#### Notes:

- 1. Rigid conduit must be used when jacking under existing pavement at 36" minimum depth.
- 2. Asphalt to be sawcut at the edges of the trench.

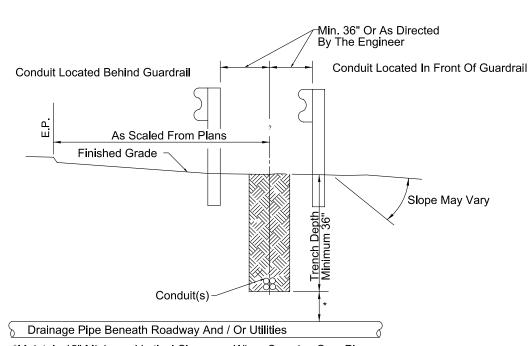

\*Maintain 12" Minimum Vertical Clearance When Crossing Over Pipe And / Or Utilities. If Minimum Vertical Clearance Cannot Be Maintained, Then Conduit Is To Be Routed Under Pipe Maintaining 12" Minimum Vertical Clearance.

FIGURE F

LATEST DESCRIPTION
REVISION

03/31/17

TRAFFIC CONTROL EQUIPMENT STANDARDS AND SPECIFICATIONS

MIAMI-DADE

DTPW TRAFFIC SIGNALS AND SIGNS DIVISION
TIOO NW 36+h STREET
MIAMI, FLORIDA 33166

305.592.3580


NAME DATE

DRAWN TRAVIS BREWER 12-09-16


CHECKED NAHUM FERNANDEZ 03-22-1


APPROVED BY: FRANK AIRA, P.E.

INICITAL LATION DETAIL COMPT C

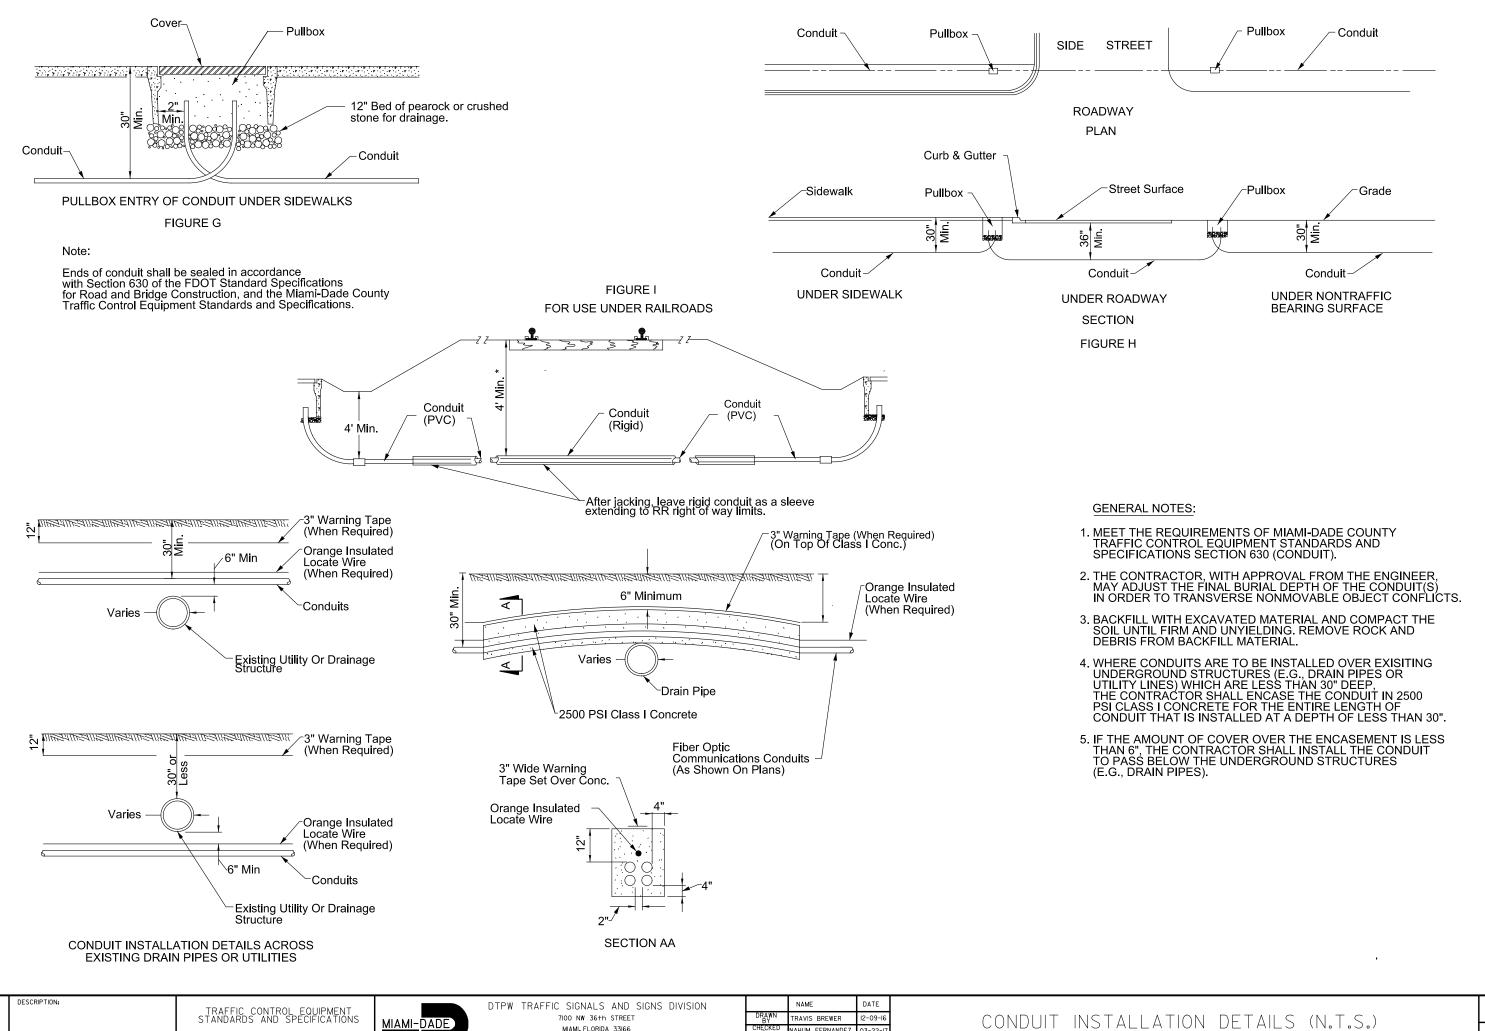

03/31/17

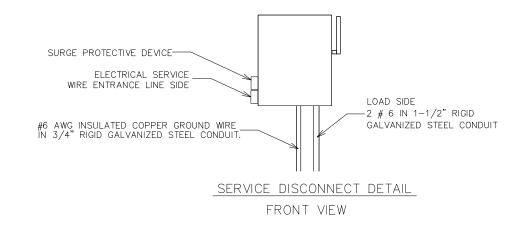

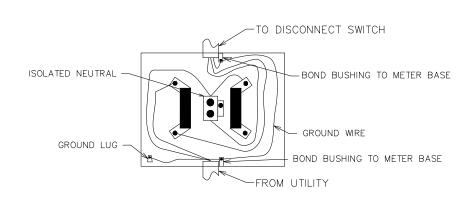

#### METER SOCKET DETAIL

#### <u>NOTES</u>

- 1. CONTRACTOR MUST COORDINATE WITH ELECTRICAL POWER COMPANY (UTILITY) ENGINEERS FOR THE INSTALLATION OF THE UTILITY RISER.
- 2. STRUCTURAL CALCULATIONS OF THE POLE INSTALLATION, SIGNED AND SEALED BY A FLORIDA LICENSED PROFESSIONAL ENGINEER, MAY BE REQUIRED.
- 3. INTERCONNECT ALL GROUNDING ELECTRODES USING #6 GROUNDING CONDUCTOR.
- 4. PROVIDE SUPPLEMENTARY GROUNDING ELECTRODE SPACED AT A MINIMUM OF 6FT APART.
- 5. SERVICE DISCONNECT MUST BE RATED FOR SERVICE ENTRANCE. LABEL MUST BE FACTORY INSTALLED.
- 6. SERVICE DISCONNECT TO BE ORIENTED ON CONCRETE POLE SO ITS FACING THE SIDEWALK.
- 7. METER TO BE ORIENTED ON SIDE OF CONCRETE POLE SO WHEN READING IT YOU ARE FACING ON-COMING TRAFFIC.
- 8. PROVIDE 2 FEET OF COILED TERMINATION OF CONDUCTOR IN THE PULLBOX MARKED "ELECTRIC".
- 9. TERMINATE CONDUITS IN METER SOCKET AND SERVICE DISCONNECT WITH INSULATED GROUNDING BUSHING WITH SOLDERLESS LUG.

02/25/21

TRAFFIC CONTROL EQUIPMENT STANDARDS AND SPECIFICATIONS MIAMI-DADE COUNTY

TRAFFIC SIGNALS AND SIGNS DIVISION 7100 NW 36th STREET MIAMI, FLORIDA 33166 305.592.3580

HECTOR SANCHEZ CHECKED NAHUM FERNANDEZ APPROVED BY: FRANK AIRA, P.F. ELECTRICAL POWER SERVICE ASSEMBLY TYPICAL DETAILS (N.T.S.)

SHEET NO.

639 - 5