1	RESOLUTION #Z07 – 01
2 3 4 5 6 7 8 9	A RESOLUTION OF THE CITY COUNCIL OF THE CITY OF DORAL, FLORIDA AUTHORIZING AND APPROVING A SITE PLAN FOR CV MIAMI, LLC, FOR A PARKING FACILITY AND APPROXIMATELY 140,000 SQ. FT. OF NEW OFFICE SPACE LOCATED AT 2305 NORTHWEST 107 TH AVENUE, DORAL, FLORIDA; PROVIDING AN EFFECTIVE DATE.
10 11	WHEREAS, CV Miami, LLC, ("Applicant") has requested approval of a
12	site plan for Miami Free Trade Zone Expansion which is located at 2305 NW
13	107 th Avenue, Doral, Florida, for a parking facility and approximately 140,000
14	sq. ft. of new office space; as depicted on; Exhibit "A" attached hereto; and
15	WHEREAS, on February 28 th , 2007 the City Council held a public
16	hearing and after careful review and deliberation, including a review of staff's
17	recommendation, determined that it is in the best interests of the citizens of the
18	City of Doral to approve the Site Plan, subject to conditions;
19	NOW, THEREFORE, BE IT RESOLVED BY THE CITY COUNCIL OF
20	THE CITY OF DORAL, FLORIDA THAT:
21	Section 1. The City Council of the City of Doral hereby approves
22	Applicant's application for approval of a Site Plan for a for a parking facility and
23	approximately 140,000 sq. ft. of new office space; as depicted on "Exhibit "A"
24	attached hereto; on the property generally located 2305 NW 107th Avenue,
25	Doral, Florida; is hereby approved subject to the following conditions:

1 1. The applicant shall provide adequate security (on site) during the entire time of construction between the hours of 7:00 pm and 7:00 am; Monday 2 3 through Friday, and 24 hours during weekends and holidays; and 4 2. The applicant must receive approval for this application from the Department of Environmental Resource Management; and 5 6 3. The applicant must receive approval for this application from Miami-Dade 7 Fire Rescue prior to submitting for building permits. 8 4. Section 2. This Resolution shall be recorded in the Public Records of 9 Miami-Dade County, Florida and the Applicant shall pay the costs of recording said document. 10

11 <u>Section 3.</u> This resolution shall become effective upon its passage
 12 and adoption by the City Council.

- WHEREAS, a motion to approve the Resolution was offered by Vice 1
- Mayor Cabrera who moved its adoption. The motion was seconded by 2
- 3 Councilman Van Name and upon being put to a vote, the vote was as follows:
- Mayor Juan Carlos Bermudez 4 Yes Vice Mayor Peter Cabrera Yes 5 Councilmember Michael DiPietro 6 Yes Councilwoman Sandra Ruiz Abstain 7 Councilmember Robert Van Name Yes 8 9
- 10 PASSED AND ADOPTED this 28th day of February, 2007.
- 11
- 12

13 14

15

OS BERMUDEZ, MAYOR JUAN

BARBARA HERRERA, CITY CLERK

APPROVED AS TO FORMAND
LEGAL SUFFICIENCY FOR THE
SOLE USE OF THE CITY OF DORAL:

J. HEARN CITY ATTORNEY JOHN

EXHIBIT "A"

ROND 2/6/07

MIAMI FREE ZONE EXPANSION CV MIAMI, LLC SITE WORK CONSTRUCTION DRAWINGS SECTION 32, TOWNSHIP 53S., RANGE 40E. CITY OF DORAL, FLORIDA

INDEX OF DRAWINGS BY LANGAN ENGINEERING							
DRAWING NO	SHEET NO.	DESCRIPTION	SCALE	DATE	LAST REVISED		
00.01	1 OF 7	COVER SHEET	AS SHOWN	11/9/2006	01/08/07		
16.01	2 OF 7	DEMOLITION PLAN	1" = 60'	11/9/2006	01/08/07		
20.01	3 OF 7	SITE PLAN	1" = 60'	11/9/2006	01/08/07		
21.01	4 OF 7	GRADING AND DRAINAGE PLAN	1" = 60'	11/9/2006	01/08/07		
22.01	5 OF 7	UTILITY PLAN	1" = 60'	11/9/2006	01/08/07		
28.01	6 OF 7	DETAILS	NTS	11/9/2006	01/08/07		
28.02	7 OF 7	DETAILS	NTS		01/08/07		

INDEX OF DRAWINGS BY FORD ARMENTEROS & MANUCI, INC. DRAWING NO SHEET NO. DESCRIPTION SCALE DATE LAST REVISED


DRAWING NO	SHEET NO.	DESCRIPTION	SCALE	DATE	LAST REVISEI
A-1	1 0F 13	GROUND FLOOR PLAN	AS SHOWN	11/9/2006	
A-2	2 OF 113	2ND FLOOR PLAN	AS SHOWN	11/9/2006	-
A-3	3 OF 13	3RD FLOOR PLAN	AS SHOWN	11/9/2006	
A-4	4 OF 113	4TH FLOOR PLAN	AS SHOWN	11/9/2006	-
A-5	5 OF 113	5TH FLOOR PLAN	AS SHOWN	11/9/2006	-
A-6	61 OF 113	6TH FLOOR PLAN	AS SHOWN	11/9/2006	
A-7	7 OF 113	7TH FLOOR PLAN	AS SHOWN	11/9/2006	
A-8	810F 113	NORTH AND SOUTH BUILDING ELEVATIONS	AS SHOWN	11/9/2006	
A-9	9 OF 13	EAST AND WEST BUILDING ELEVATIONS	AS SHOWN	11/9/2006	
A-10	10 OF 13	ENLARGED NORTH BUILDING ELEVATION	AS SHOWN	11/9/2006	-
A-11	11 OF 113	ENLARGED SOUTH BUILDING ELEVATION	AS SHOWN	11/9/2006	
A-12	12 OF 113	SECTIONS	AS SHOWN	11/9/2006	
A-13	13 OF 113	ISECTIONS	AS SHOWN	11/9/2006	

INDEX OF DRAWINGS BY WITKIN DESIGN GROUP							
DRAWING NO	SHEET NO.	DESCRIPTION	SCALE	DATE	LAST REVISED		
L-1	1 OF 3	PLANTING PLAN FOR EASTERN HALF OF MIAMI FREE ZONE	AS SHOWN	11/9/2006			
L-2	2 OF 3	PLANTING PLAN FOR WESTERN HALF OF MIAMI FREE ZONE	AS SHOWN	11/9/2006			
L-3	3 OF 3	PLANTING DETAILS FOR MIAMI FREE ZONE	AS SHOWN	11/9/2006			

Carol City Djus **Biscayne Gardens** North Mian mi Shore Hialeah Miami Sp Buena Vista (959) (836) Mian vestchester Coral Gables Biscayne Bay Kendall Coral Bay Howard MAP REFERENCED FROM MAPOLIEST CO. VICINITY MAP

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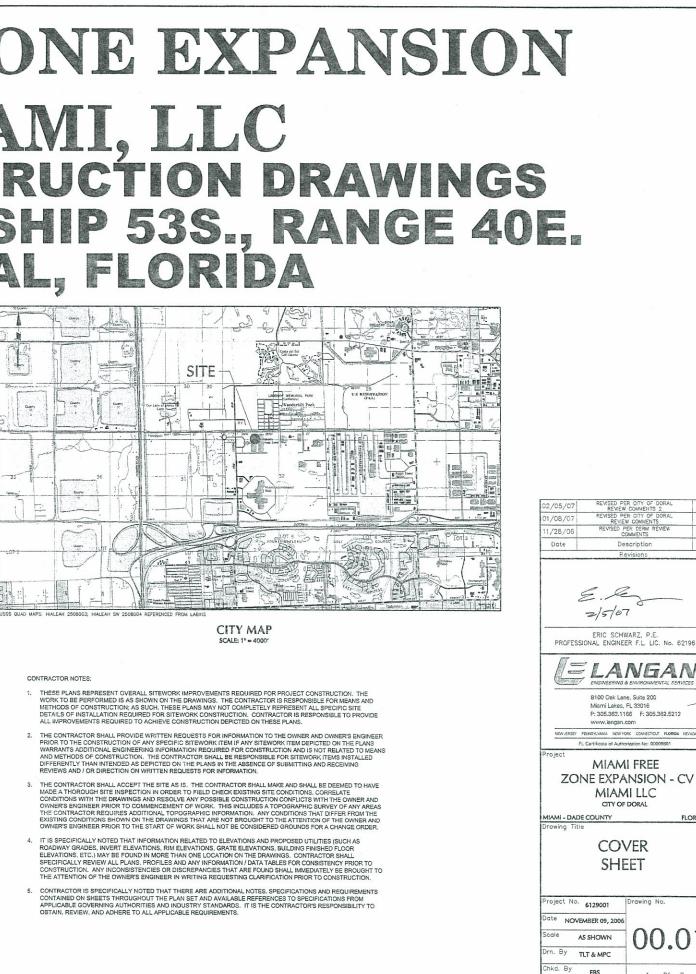
N.T.S

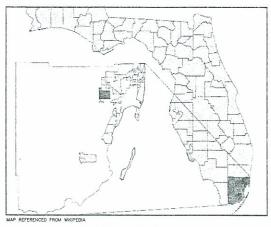

FLORIDA MAP

N.T.S

CV MIAMI, LLC 17 STATE STREET, 9TH FLOOR NEW YORK, NY 10004 (212) 248-3111 APPLICANT: PLAN ENGINEER: LANGAN ENGINEERING VIRONMENTAL SERVICE I, INC. ANDREW JACKSON BULLDING AT GOVER 8100 OAK LANE, SUITE 200 MAIMI LAKES, FL 33016 AUTHORIZED AGENT: R.S. MURALI PROJECT MANAGER: ERIC SCHWARZ, P.E. TEL PEHONE: (200) 302, 1166



CIVIL ENGINEER: ERIC SCHWARZ, P.

ARCHITECT: ROBERTO BEAUCHAMP

BORGES AND ASSOCITES WACHOVIA FINANCIAL (200 S BISCAYNE BOULEV SUITE 800 MIAMI, FLORIDA 33131 (305) 374-9216

LANGAN ENGINEERING AND EI 8100 OAK LANE SUITE 200 MIAMI LAKES, FLORIDA 33016 (305) 362-1166

ATTORNEY: PATRICIA BALOYRA BROAD AND CASSEL, ATTORNEYS AT LAW ONE BISCAYNE TOWER 21ST FLOOR MIAMI, FLORIDA 33131 (305) 373-4470

UITE 201 (IAMI, FLORIDA 33178 305) 592-7123 TRAFFIC ENGINEER: RICHARD GARCIA, P.E RICHARD GARCIA AND ASSOCIATES, INC 13117 NW 107TH AVENUE

SUITE 4 HALEAH GARDENS, FLORIDA 33018 3051 595,7505 CLIENT: STEVE BARTHEL, VP CV MIAMI, LLC 17 STATE STREET

LIST OF CONTACTS

STRUCTURAL ENGINEER:

TIMOTHY HAAHS ENGINEERS 0305 NW 41ST STREET

9TH FLOOR NEW YORK, NEW YORK 10004 (212) 248-3111

GEOTECHNICAL ENGINEER: ROGER ARCHABAL RING AND EN LAKES, FLORIDA 3001

1950 NORTHWES MIAML FL 33172 LANDSCAPE ARHITECT

WITKIN DESIGN GROUP 16853 NE 2ND AVENUE SUITE 305 NORTH MIAMI BEACH, FLORIDA 33162

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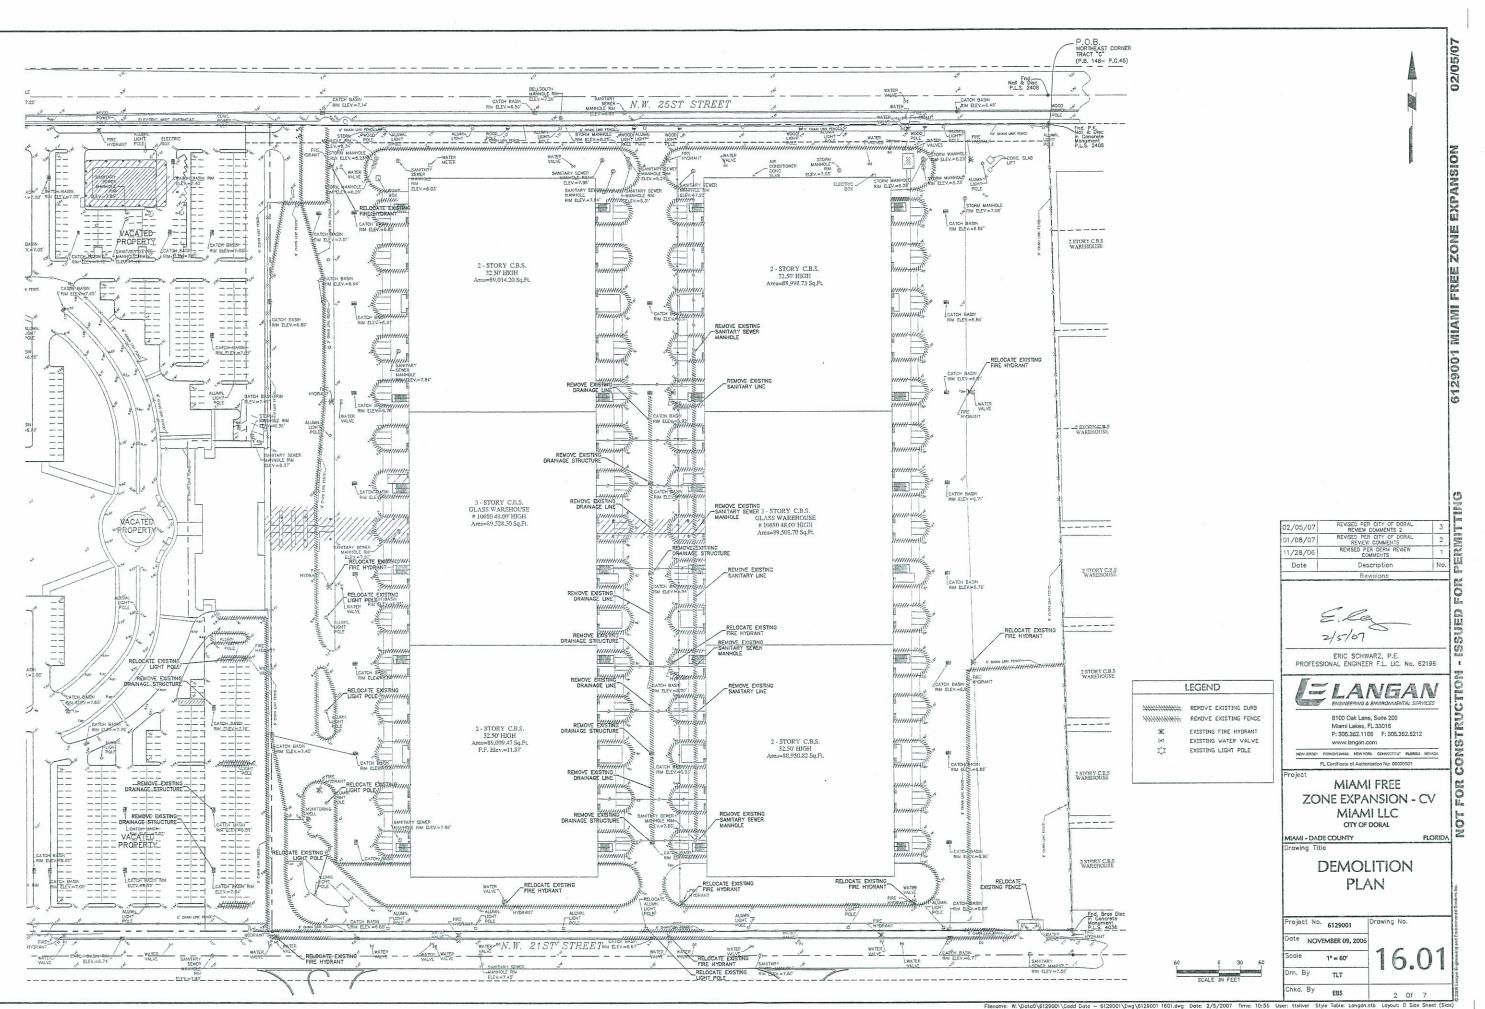
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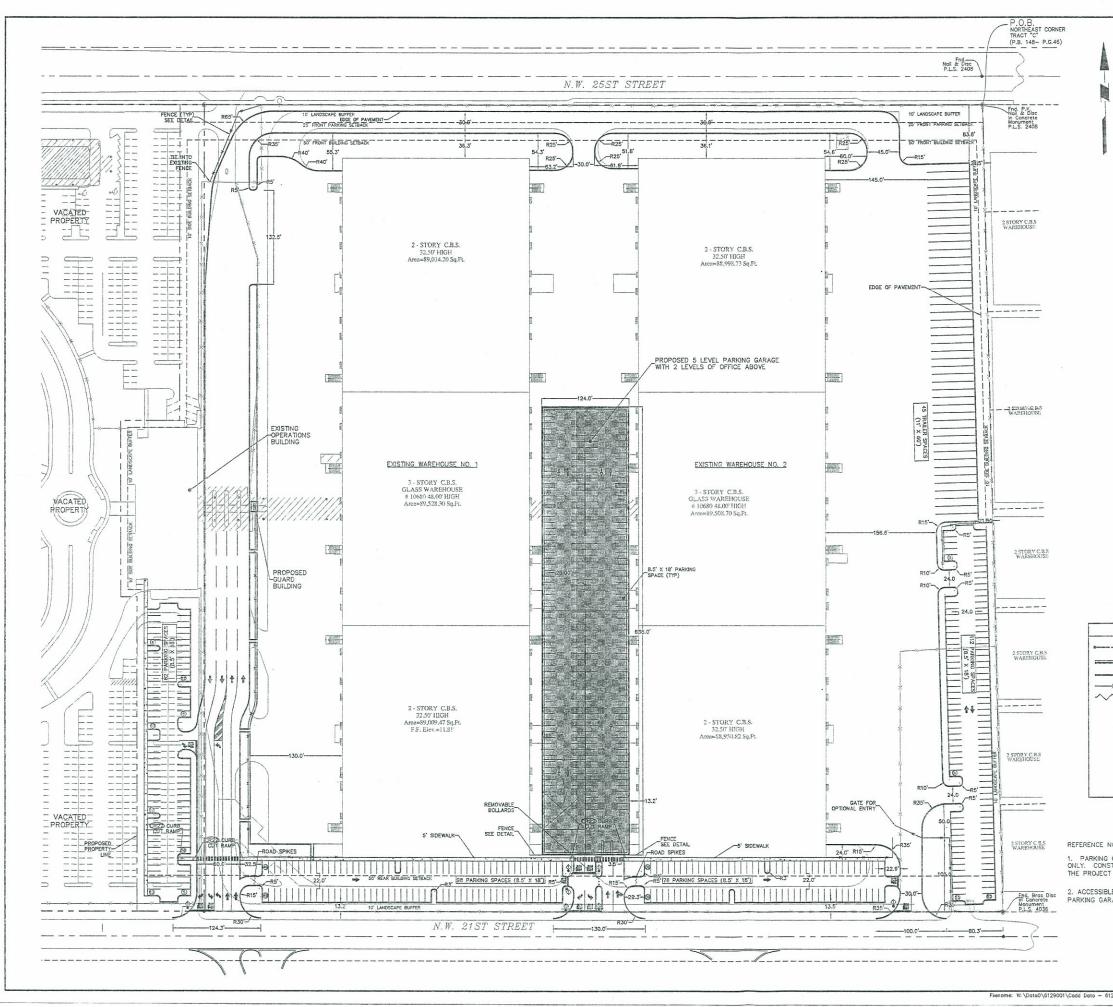
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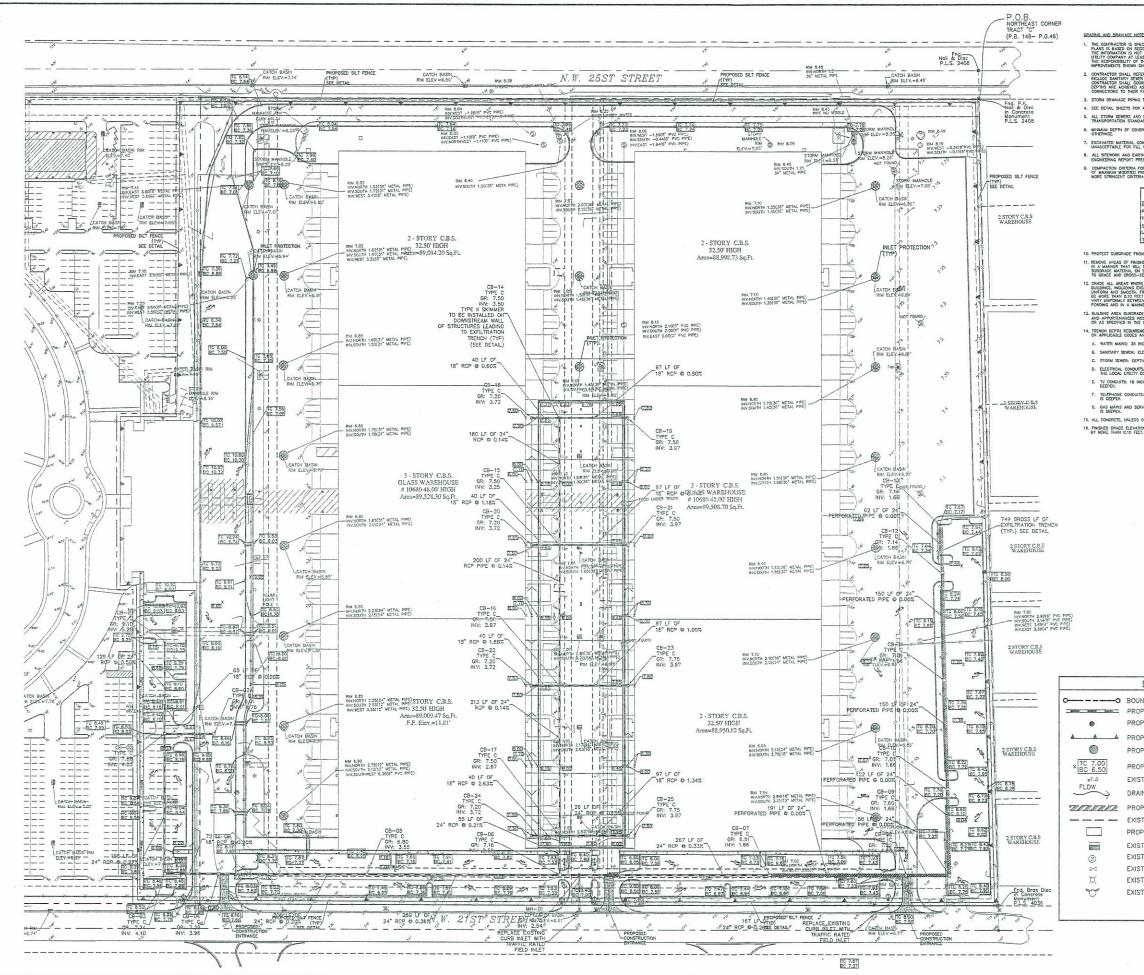
FLORIDA





DATA		MIAM	FRE	EE ZON	IE E	XPAI	NSION Z	ONIN	G TAB	E (1)	
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	Land Use:						Office / Wa	arehouse		ffice /	Warehouse	
SITE	Lot Area: Minimum	Parcel Area					10 AC	RF		.89 A		
	Min. Lot Wi	dth					330 1	FT		146 FT	Г	
Buffer Area Setback Building Setbacks:				10 F			10 F					
0N	Min. From Min. Side						50 F 10 F		22	76 F		
BUILDING	Min Side	Through Lot					25 F	FT		76 F	r i	
BUI	Min. Rear	Yard*					50 F	T	7	6.5 F		
	Car Parking	Space Size:										_
		Space Size					8.5 FT x	18 FT		8.5 F	T x 18 FT	
SS							1SP/1,000 SF	Wareho	150	1 000	SF Wareho	
CCE	Min. Num	ber of Spaces	per Gr	oss Floor A	rea		1SP/300S				DOSF Office	
PARKING & ACCESS	Number o	of Spaces					1,07	78			1,638	
DN		le Width, 90 d					24 F			24 F		
RKI		arking Setbac arking Setbac				Street)	25 F 5 F			84 F		
PA	Minimum P	arking Setbac	k from :	side street			10 F	-T		11 F	r	1
		ess Point Sep	aration				100	FT	1	300 F	г	
	(1)All data r	referenced from	n Miam	i-Dade Cou	nty Co	de of Or	dinances					-
ES												
NOTES												
-	* Pertains to	o a Through Lo	ol, see	Miami-Dade	Code	of Ordin	ances 33-1 D	efinitions				
			-			ACE	SUMMAR	Y	MIN	EP C	F SPACES	
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AND EA				300,200		SPAC	E PER 2000 SF	SF >	212			
MEZZA EAST)	NINE A & B	(WEST AND		137,764		1 SPA	CE PER 2000	0 SF	69			
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GRADING AND DRAINAGE NOTES

THE CONTRACTOR IS SPECIFICALLY CAUTIONED 1 PLANS IS BASED ON RECORDS OF THE VARIOUS THE INFORMATION IS NOT TO BE RELIED ON AS UTILITY COMPANY AT LEAST 48 HOURS BEFORE THE RESPONSEULTY OF THE CONTRACTOR TO R IMPROVEMENTS SHOWN ON THE PLANS.

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CONTRACTOR SHALL REFER TO ARCHIECTURAL PLANS AND SPECIFICATIONS FOR ACTUA INCLUDE SANITARY SENEL LATERALS, DOMESTIC AND FRE PROTICTION WATER SERVICE, CONTRACTOR SHALL COORDANIE INSTALLATION OF UTILITES IN SUCH A MANNER AST DEPTHS ARE AGREEDE AS WELL AS COORDANIES WITH THE UTILITY COMPANES AS TO CONNECTIONS TO THER FACILITES.

3. STORM DRAMAGE PIPING TO UTILIZE WATER TIGHT JOINTS WHERE INDICATED 4. SEE DETAIL SHEETS FOR ALL PROPOSED STRUCTURE DETAILS.

ALL STORM SEWERS AND STRUCTURES SHALL BE CONSTRUCTED IN ACCORDANCE WITH STATE OF FLORIDA, DEPARTMENT O TRANSPORTATION STANDARDS OF ROADWAY CONSTRUCTION DETAILS.

6. MINIMUM DEPTH OF COVER FOR ALL STORM SEWER PIPE IS SEVEN (7*) INCHES MEASURED FROM BOTTOM OF BASE, UNLESS SHOWN OTHERMISE. EXCAVATED MATERIAL CONTAINING CONCRETE ROCK OR STONE GREATER THAN SIX (6*) INCHES IN LARGEST DIMENSION IS UNACCEPTABLE FOR FILL WITHIN THE PROPOSED BUILDING AND PAVING AREA.

8. ALL SITEWORK AND EARTHWORK OPERATIONS CONDUCTED ON THE SITE TO BE PERFORMED IN ACCOR ENGINEERING REPORT PREPARED BY THE OWNER'S GEOTECHNICAL ENGINEER.

. COMPACTION CRITERIA FOR FILL PLACED IN THE FOLLOWING AREAS SHALL MEET OR EXCEED THE FOLLOWING MINIMUM PERCENTAGE OF MAXAMUM MODIFIED PROCTOR DRY DENSITY AS DETERMINED BY ASTM D-1557 USED ON REPRESENTATIVE SOIL SAMPLES, UNLESS MORE STRUCTOR TORTING, ROYA LESSMERTE

Fill Area	Percent of Maximum Modified Proctor Dry Density
Building Footprint	96%
Pavement and Roadways	98%
Paved Parking Areas	95%
Sidewalk	95%
Landscape Areas	93%
Trench Backfill	Same as Surrounding Areas

10. PROTECT SUBGRADE FROM EXCESSIVE WHEEL LOADING DURING CONSTRUCTION, INCLUDING CONCRETE TRUCKS AND DUMP TRUCKS 1. REJORE AREAS OF BINSHED SUBGRAF FORME TO HARE INSUFFICIENT COMPACTION BRISTY TO A DETTH RECESSION AND REPLACE IN A MAINER THAT NEL COMPACTIVENT COMPACTION REQUESIONET BY USE OF MATERIAL EDUA TO GR ENTER THAN REST SUBGRAFE MATERIAL ON STL. SUBFACE OF SUBGRAFE AFTER COMPACTION SHALL BE MARD, MARGON, MOOTH, STARLE AND TRUE TO GRAFE MAR CORSS-SECTION.

12. GRADE ALL AREAS WHERE FIREN GRADE ELEVATIONS OR CO BUILDINGS, INCLUDING DISAVATID AREAS, FILED AND TRAVI-BUILDINGS, INCLUDING DISAVATID AREAS, FILED AND TRAVI-ENDORED HAIN SOTOR-TREEDING REAL DISERSING DISAUD VARY UNFORMLY BETWEEN REGISTANT BUILDINGS, FINISH OF PONDING AND IN A AMANDER THAT TILL INFINISE ERGISION PI PONDING AND IN A AMANDER THAT TILL INFINISE. INFORMLY BETWEEN INDICATED ELEVATIONS. FINISH G AND IN A MANNER THAT WILL MINIMIZE EROSION

BUILDING AREA SUBGRADE PAD SHALL BE THAT PORTION OF SITE DIRECTLY BONEATH AND TEN FEET (10 AND APPURTENANCES INCLUDING THE UNITS OF ANY FUTURE BUILDING EXPANSION AREAS AS SHOWN ON OR AS SPECIFIC IN THE OSCIDENNICAL REPORT.

14. TRENCH DEPTH REQUIREMENTS MEASURED FROM FINISHED GRADE OR PAVED SURFACE SHALL OR APPLICABLE CODES AND ORDINANCES: A. WATER MAINS: 36 INCHES TO TOP OF PIPE BARREL

B. SANTARY SEWER: ELEVATIONS AND GRADES AS INDICATED ON DRAWINGS.
 C. STORM SEWER: DEPTHS, ELEVATIONS, AND GRADES AS SHOWN ON DRAWINGS


 ELECTRICAL CONDUITS: 24 INCHES MINIMUM TO TOP OF CONDUIT OR AS REQUIRED BY NEC 300-5, NEC 710-36 CODES, OR THE LOCAL UTILITY COMPANY REQUIREMENTS. WHICHEVER IS DEEPER. TV CONDUITS: 18 INCHES MINIMUM TO TOP OF CONDUIT OR AS REQUIRED BY THE LOCAL UTILITY O

CONDUITS: 18 INCHES MINIMUM TO TOP OF CONDUIT OR AS REQUIRED BY THE LOC

C. GAS MAINS AND SERVICE: 30 INCHES MINIMUM TO TOP OF PIPE, OR AS REQUIRED BY THE LOCAL UTILITY COMPANY, WHICHEVED IS DEEPER. 5. ALL CONCRETE, UNLESS OTHERWISE NOTED OR SPECIFIED BY REGULATORY AUTHORITIES, SHALL BE 3000 PSI.

16. FINISHED GRADE ELEVATIONS SHALL NOT DEVIATE FROM THE PROPOSED ELEVATIONS SHOWN ON THE GRADING AND DRAINAGE PLANS BY MORE THAN 0.10 FEET.

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	EXFILTRATION TRENCH				11/28/06	REVIEW COMMENTS REVISED PER DERM REVIEW COMMENTS	1
	1				Date	Description	No.
	2 STORY C.E.S WAREHOUSE					Revisions	
11	*						
¥	110 8.50 XIBC 8.06						
	A180 8.06						
	[8 9	
	1						
ŝ.	RIM 7.09 INV.NORTH 2.99(8" PW	C PIPE)				2/5/07	
-	HW.NORTH 2,99(8' PW HV.NORTH 2,99(8' PW HV.SOUTH 3,14(8' PVC HW.WEST 3,69(4' PVC HV.EAST 3,59(4' PVC	PIPE) FIPE)					
1	78				PROFESS	ERIC SCHWARZ, P.E. IONAL ENGINEER F.L. LIC. No. 62	106
	2 STORY C.B.S WAREHOUSE				11101200		
21							ES F
-						LANDAI	V
1			LEGEND		Contest	ENGINEERING & ENVIRONMENTAL SERV	CES
7	ì[8100 Oak Lane, Suite 200	
		00	BOUNDARY LINE			Miami Lakes, FL 33016	
1			PROPOSED STORM LINE	1		P: 305.362.1166 F: 305.362.5212 www.langan.com	
15		e	PROPOSED MANHOLE		NEW JERSEY	PENNSYLVANIA NEWYORK CONNECTICUT PLORIDA I	NEVADA
	A second	AA	PROPOSED SILT FENCE			L Certificate of Authorization No: 00006601	
4	2 STORY C.B.S WAREHOUSE		PROPOSED INLET PROTECTION		Project		
45		× TC 7.00 BC 6.50	PROPOSED SPOT ELEVATION			MIAMI FREE	
10 20	TC 8.78	x7.5 FLOW	EXISTING SPOT ELEVATION		ZOI	NE EXPANSION - C	V
73	BC 8.28	FLOW >	DRAINAGE GENERAL FLOW PATH			MIAMI LLC	
	*	THERE	PROPOSED EXFILTRATION TRENCH			CITY OF DORAL	
			EXISTING EASEMENT		Drawing Title	CONTRACTOR CONTRA	LORIDA
52 07	2 STORY CHS		PROPOSED DRAINAGE INLET	1			
3.4.	2 STORY C.B.S WAREHOUSE		EXISTING DRAINAGE INLET		G	RADING AND	
		3	EXISTING MANHOLE		סח	AINAGE PLAN	
,	1	×	EXISTING VALVE			MINAUE FLAIN	1
-		X	EXISTING LIGHT POLE				
40	End. Bras Disc	0	EXISTING FIRE HYDRANT				
	Monument P.L.S. 4036				Project No.	6129001 Drawing No.	
-	N. C. S. C.				Date NOVEM	FBFR 09, 2005	
_					Scale		111
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			SCALE IN FEET		Drn. By 7	LT & MPC	-
			SUALE IN FEET		Chkd. By		
						EBS 4 Of 7	
ile	name: W: \Data0\6129001\	Cadd Data - 6129001\D	wg\6129001 2101.dwg Date: 2/5/2007 Time:	11:32 Us	er: ttoliver Styl	e Table: Langan.stb Layout: D Size Si	heet (Side)

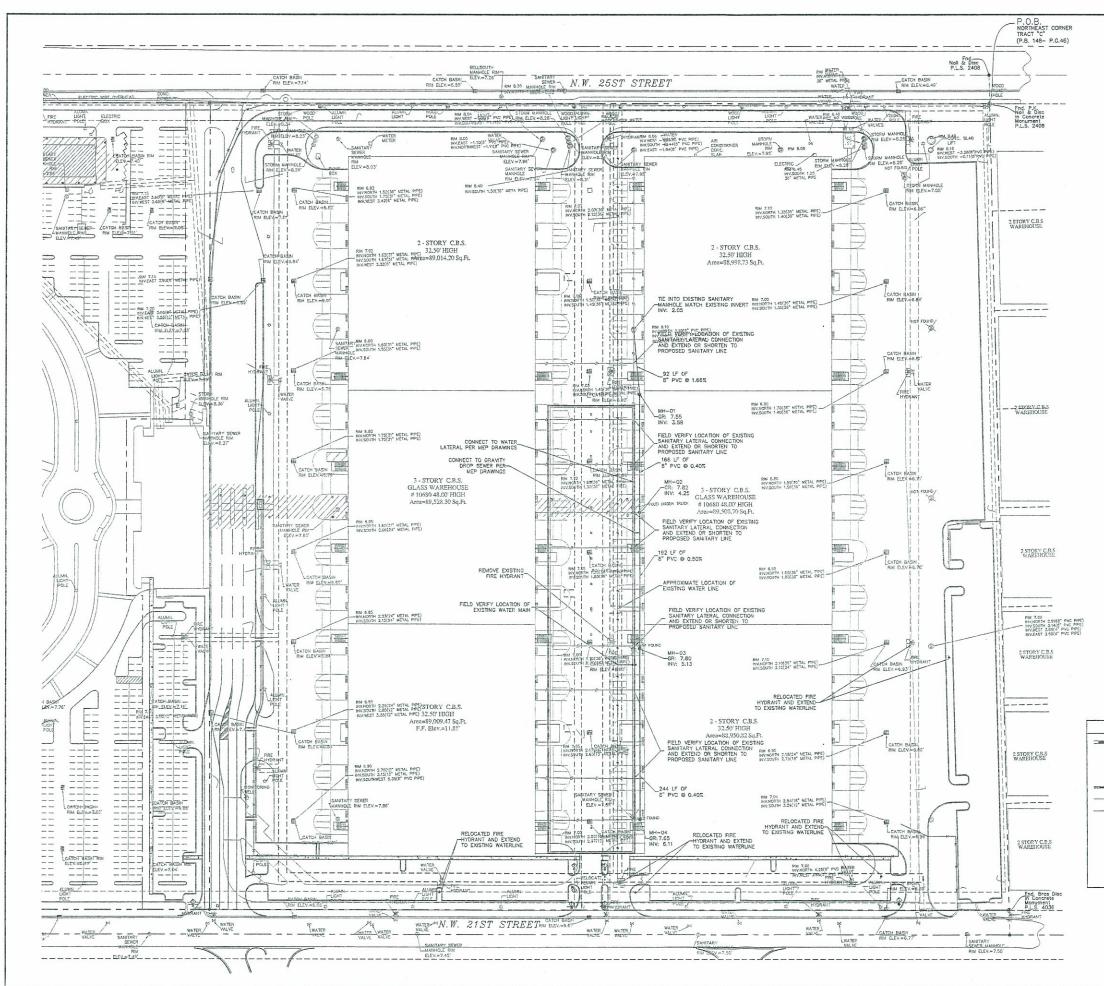

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SANITARY SEWER NOTES:

02/05/07

ZONE EXPANSION

5129001 MIAMI FREE

- ANITARY SEWER NOTES: ALL SANITARY GRAVITY SEWER PIPE ON THE SITE SHALL BE PVC SDR35. SEE DETAIL SHEET FOR BEDDING REQUIREMENTS. APPROVED BACKFILL FOR PIPE TRENCHES SHALL BE FLACED IN 8 INCH LAYERS AND COMPACTED WITH A MINIMUM OF 4 COVERAGES OF A VIERO PLUIS CM 20 OF EQUIVALENT. IN ADDITION, THE BACKFILL SHALL BE COMPACTED TO A MINIMUM SE FERCENT MODIFIED PROCTOR DEDISTIF. CARE SHOULD A SOL FREE FROM LUMPS, LARCE STORE, BOULDERS OR OFHER DEDISTIF. CARE SHOULD SOL FREE FORM LUMPS, LARCE STORE, BOULDERS OR OFHER INSUFFLEE MATERIALS. AT THE POINT WHERE THE PROPOSED SEWER CONSTRUCTION MEETS A LIVE OR EVISITING SEWER, THE NEW SEWER SHALL BE SECURELY PLUGGED UNTIL THE FINITE NEW SEWER CONSTRUCTION IS COMPLETED AND READY FOR FINAL INSPECTION. ALL OFHER APPOPRIATE AGENCIES WHEN WORK IS TO COMMENCE. AUL AFEAS DISTURBED BY CONSTRUCTION BY FILLING THEO TO RGINAL CONDITION UPON CH CONTRACTOR SHALL APPORPHIATE TO BY FILLING THE DIRE TO DUDY OVER A V-NOTCH OF THE MANHOLE. THE LIMITING RATE OF INFLITATION SHALL NOT EVCEDED TO GALLONS FELL THE INCH DIANE BY FELLING THE ZA HUNCER TO 10 FEET ABOVE THE INVERT OF THE MANHOLE. THE LUMITING RATE OF INFLITATION SHALL NOT EVCEDED TO GALLONS FELL THE INCH DIANE BY FELLING THE ZA HUNCER TO 10 FEET ABOVE THE INVERT OF THE MANHOLE. THE LUMITING RATE OF INFLITATION SHALL NOT EVCEDED TO GALLONS FELL THE INCH DIANE BY FELLING THE ZA HUNCER TO 10 FEET ABOVE THE INVERT OF THE MANHOLE. THE LUMITING RATE OF INFLITATION SHALL NOT EVCEDED TO GALLONS FELL THE HAIL BE ESTERD FOR MENUTING AN ALL TERNATE TESTING METHOD SHALL BE AIR PRESSURE TESTING AT 5 SEVEN THE INCH DIANE BY FELLING THE ZA HUNCES TO 10 FEET ABOVE THE INVERT OF THE MANHOLE. THE LUMITING RATE OF INFLITATION SHALL NOT EVCED EDUG OLONS PERLID TO THE MANHOLE. THE SUMMER STARE TO 10 FEET ABOVE THE INVERT OF THE MANHOLE. THE LUMITING RATE OF INFLITATION SHALL BOT TO MINUTES THELED BY OR AND SHERE DUCKT IN IS TWO FEET OR MORE ABOVE INVERT TO MANHOLE TO BE UTILIZED MHERE INVERT IN IS TWO FEET OR MORE ABOVE INVERT
- UT. ONTRACTOR SHALL OBTAIN ALL PERMITS REQUIRED FOR CONSTRUCTION AND SUPPLY SUPPLENT FOR ALL TESTS ON SANITARY SEWER LINES. NITARY CLEANOUTS SHALL BE ROWORDS WITHIN 5 FEET OF ALL BUILDING CONNECTIONS. UT SWEETS AND SHOP DRAWINGS OF ALL TEMS PERTAINING TO THE CONSTRUCTION OF THE SANITARY SEWER SHALL BE SUBMITED TO WORKE AND ENGINEER OF RECORD FOR EVEN. THIS INCLUES, BUT IS NOT LIMITED TO: MANHOLES, GREASE TRAPS, PUMP TATIONS, FRAMES, COVERS, PIPE, ITTINGS, BACKFILL MATERIAL, BLACKTOP, ETC. MISTING SEWER SYSTEM ESTIMATED FOW ORGINAL DRAWINGS AND SURVEY.

WATER NOTES:

60-


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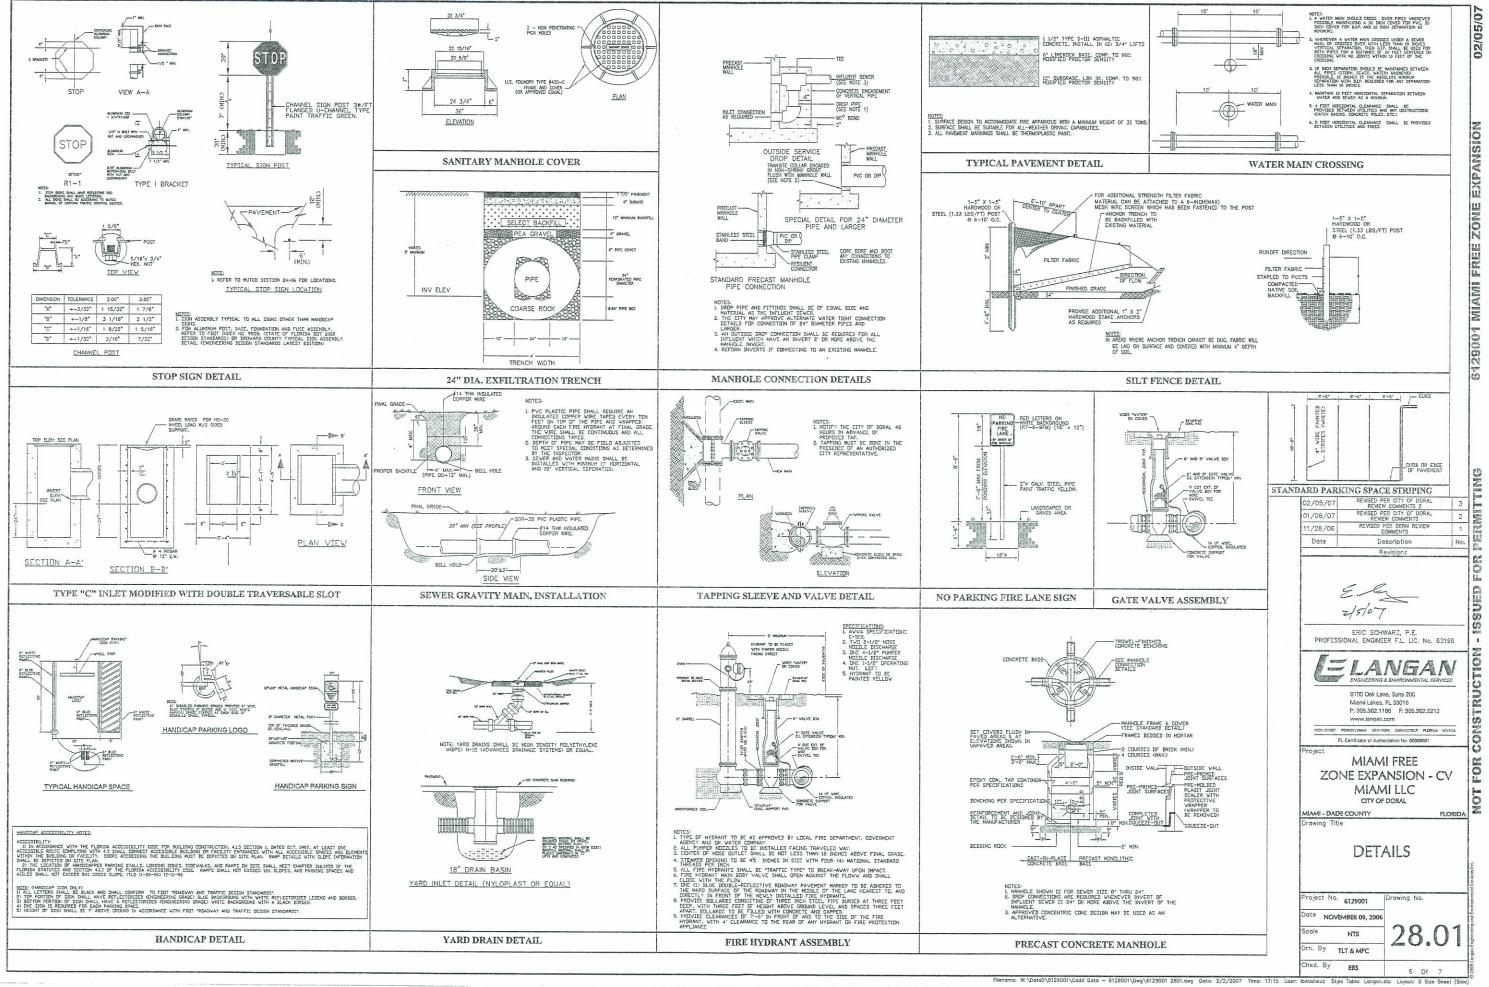
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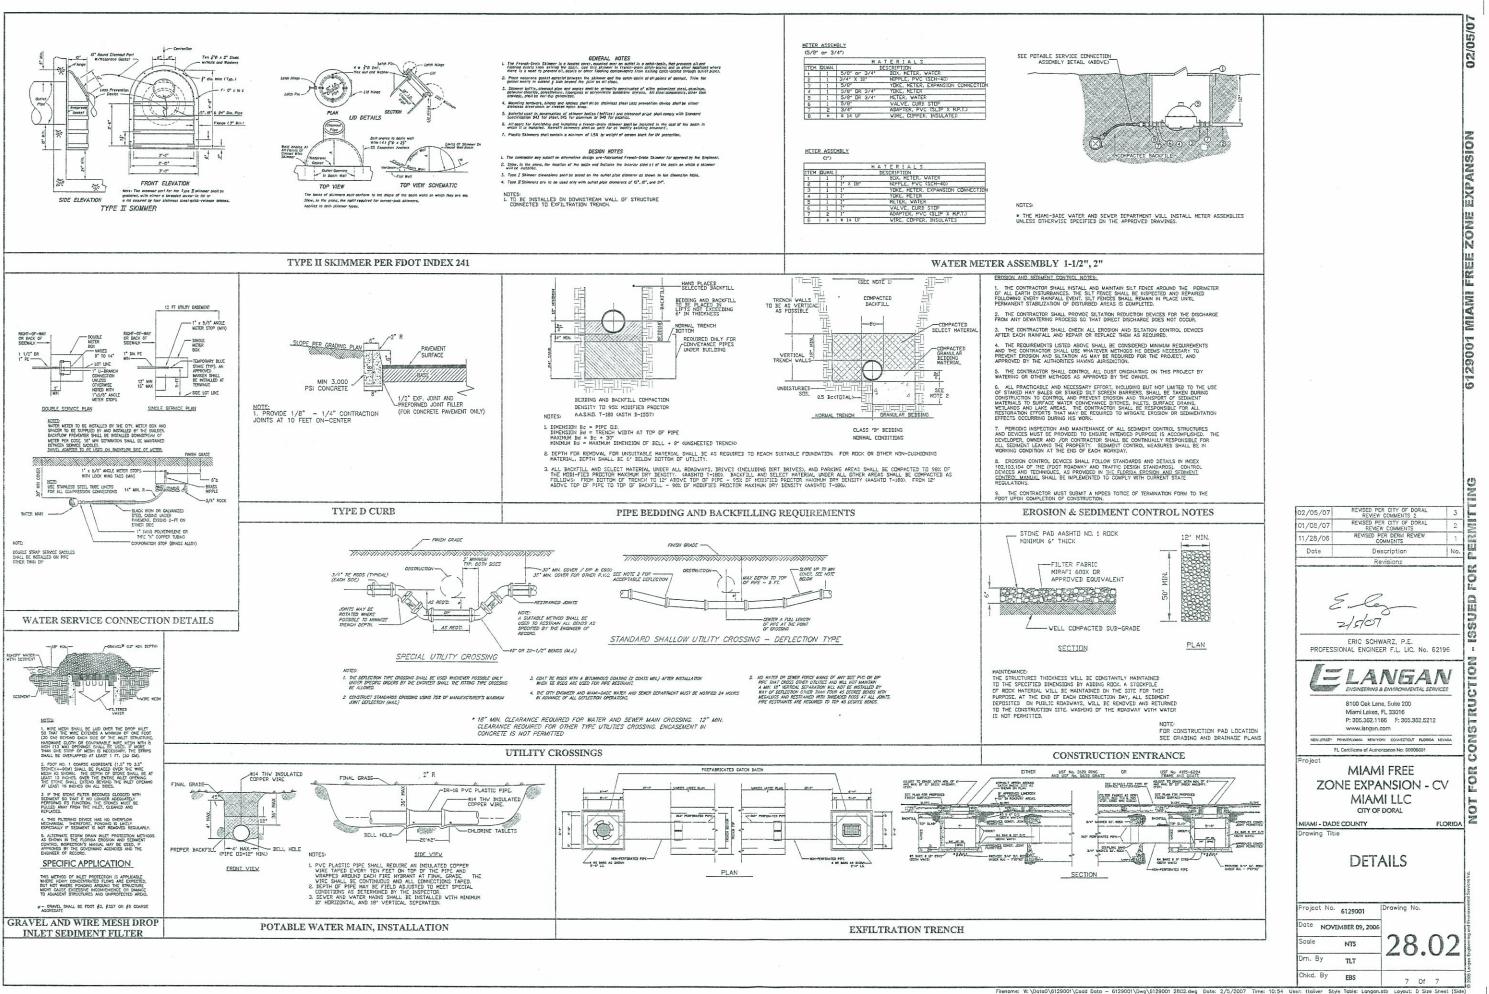
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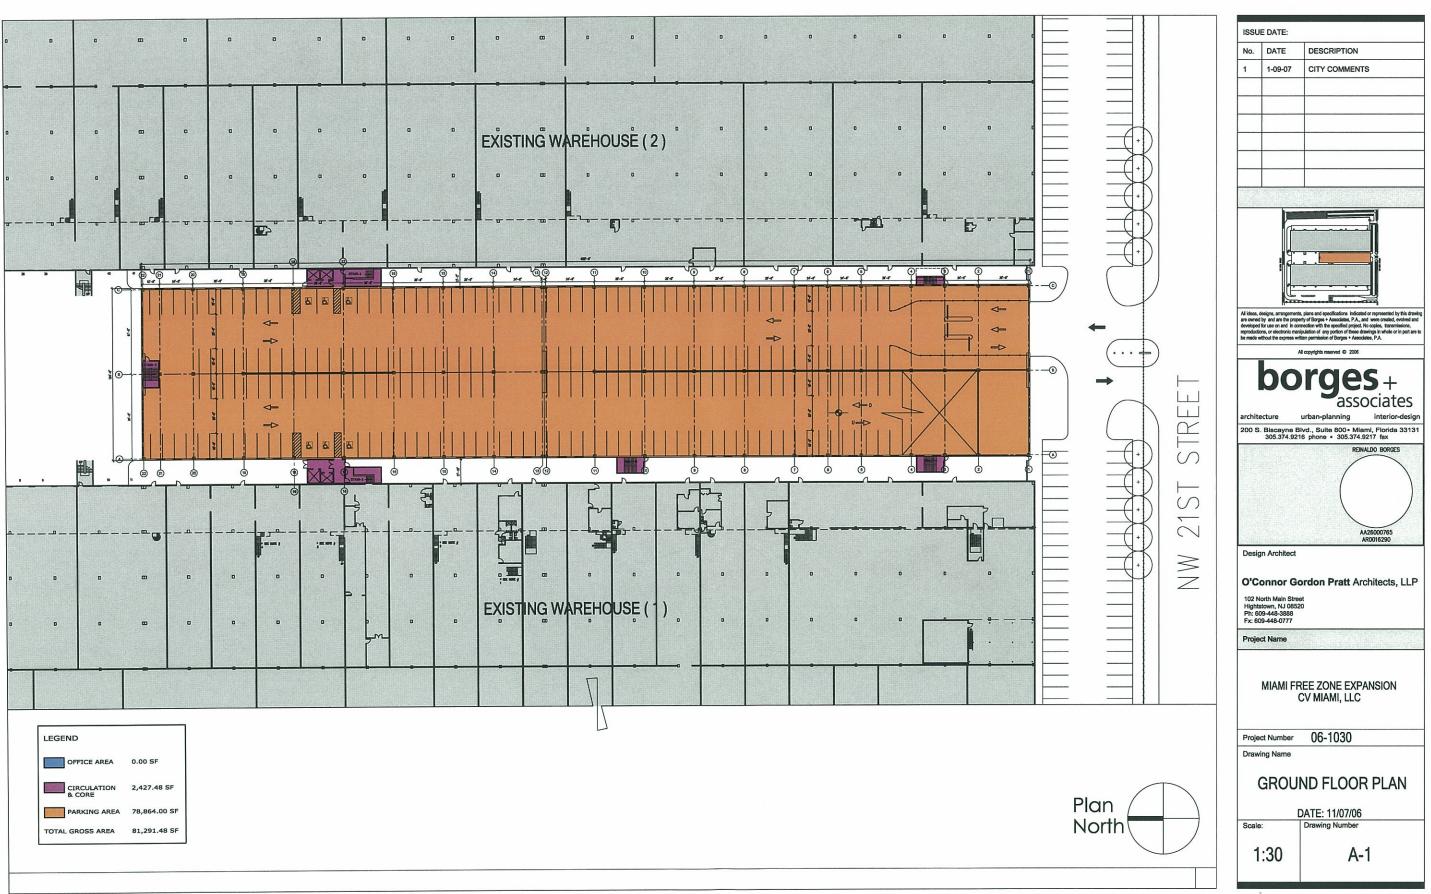
- NATER NOTES: ALL WATER LINE SYSTEM COMPONENTS (PIPES, VALVES, HYDRANTS, ETC.) SHALL CONFORM TO THE SPECIFICATIONS OF THE LOCAL GOVERNMENTAL AGENCY, THE LOCAL WATER COMPANY, AND THE LOCAL FIRE DEPARTMENT. ANNUME ARTH COVER OVER TOP OF PIPE SHALL BE 3 FEET. THRUST BLOCKS SHALL BE PROVIDED AT ALL TEES, LIBOWS, AND PLUGS. SEE DETAIL SHEET FOR SIZING REQUREMENTS. SEED BIAL SHEET FOR LACERS AND COMPACIED WITH A MUMICIAL OF PIPE TRENCHES SHALL PLUS CM. 20 OR FEDUINABLE MATCHENIS. APPRAVED BACKFLL (DRD PIPE TRENCHES SHALL PLUS CM. 20 OR FEDUINABLE. IN ADDITION THE BACKFLL SHALL BE COMPACIED TO A MINIMUM SO PERCENT MODIFIED PROCTOR DENSITY. CARE SHOULD BE TAKEN TO FILL ALL VOIDS AROUND THE PIPE BLACKTLL SHALL CONSIST OF GRANULARS SOL FREE FROM LUMPS, LARGE STONES, BOULDERS OR OTHER UNSUITABLE MATERIALS. ALL NEW PIPING SHALL BE PRESSURE TESTED IN ACCORDANCE WITH AWWA C600-99, SECTION 4 SALL NEW WATER SECTIONS DE TESTER AT THESE NATION OF HEADING. IN MO CASE ALL NEW WATER SECTIONS DE TESTER AT THESE NATION FOR HEATING. IN MO CASE ALL NEW WATER SECTIONS DE TESTER AT THESE NATIONE OF HEADING. IN MO CASE ALL NEW WATER SECTIONS DE TESTER AT THESE NATIONE OF HEADING. IN MO CASE ALL NEW WATER SECTIONS DE TESTER AT THESE NATIONE OF HEADING. IN MO CASE ALL NEW WATER SECTIONS DE TESTER AT THESE NATIONE OF HEADING. IN MO CASE ALL NEW WATER SECTIONS DE TESTER AT THESE NATIONE OF HEADING. IN MO CASE ALL NEW WATER MENDALE BESTREITED SECTIONE OF THE MANAL CONDITION UPON COMPLETION OF MALL BESTREIT. THESE NATIONE OF HEADING AND CONNECTION MADE TO ENSTINGED DEFINITS REQUIRED FOR CONSTRUCTION AND SUPPLY EQUIPMENT CONTRACTOR SHALL BESTREIT. HEADING TO CONFORM TO PLUMBING SUBCODE OF THE APPROPRIATE JURISDICTION BODY. 10. AFTER DISINFECTION, AND BEFORE THE WATER SYSTEM IS PLACED IN SERVEE, BACTERIOLOGICAL SAMPLES SHALL BE TAKEN MAND TESTED IN ACCORDANCE WITH AWAR OGO AND NST-61 CERTIFICATIONS. 11. CONTRACTOR SHALL BE TAKEN MAND TESTED AND ACCORDANCE WITH AWAR OGO AND NST-61 CERTIFICATIONS. 12. WATER PIPE '' MO


- COPPER TYPE K. EXISTING WATERLINE LOCATION ESTIMATED FROM SURVEY LOCATION OF EXISTING WATER VAVLES AND EASEMENTS. CONTRACTOR SHALL TEST PIT AND FIELD LOCATED ACTUAL WATER LINE IN ENOUGH LOCATIONS FOR HIM TO BE SATISFIED PRIOR TO ANY OTHER SUBSURFACE DISTURBANCE INCLUDING ORILING OR PILE DRIVING.









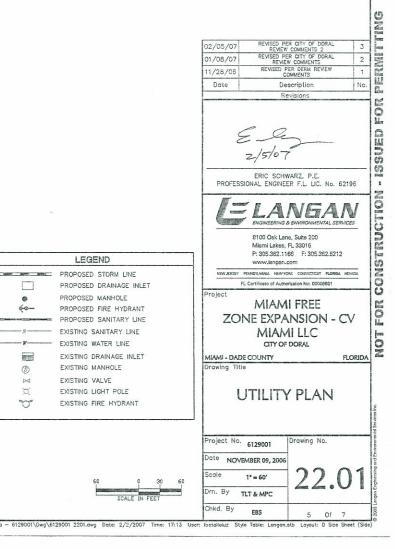


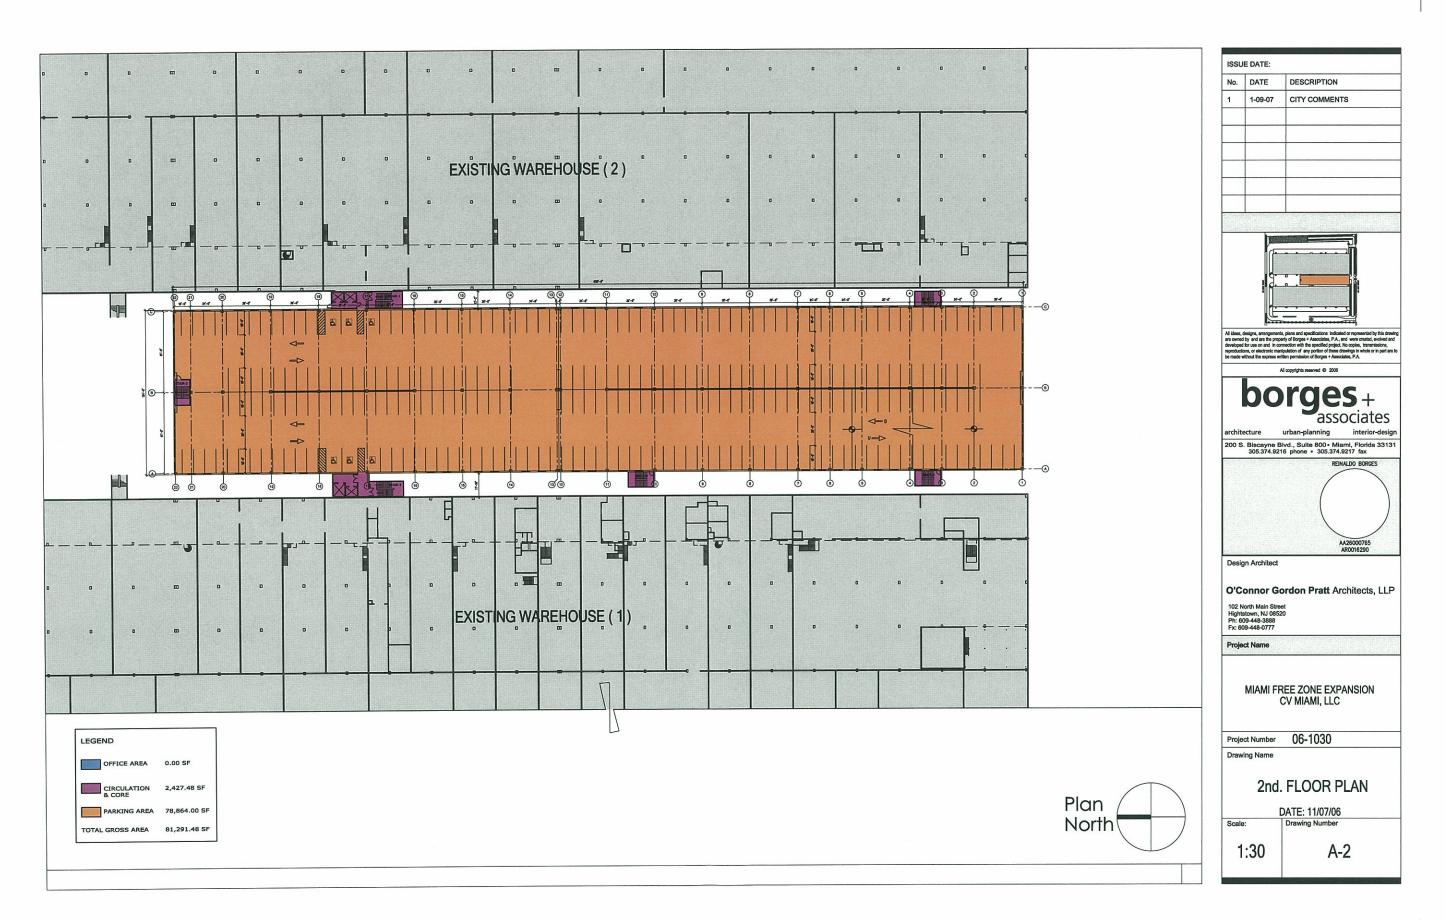



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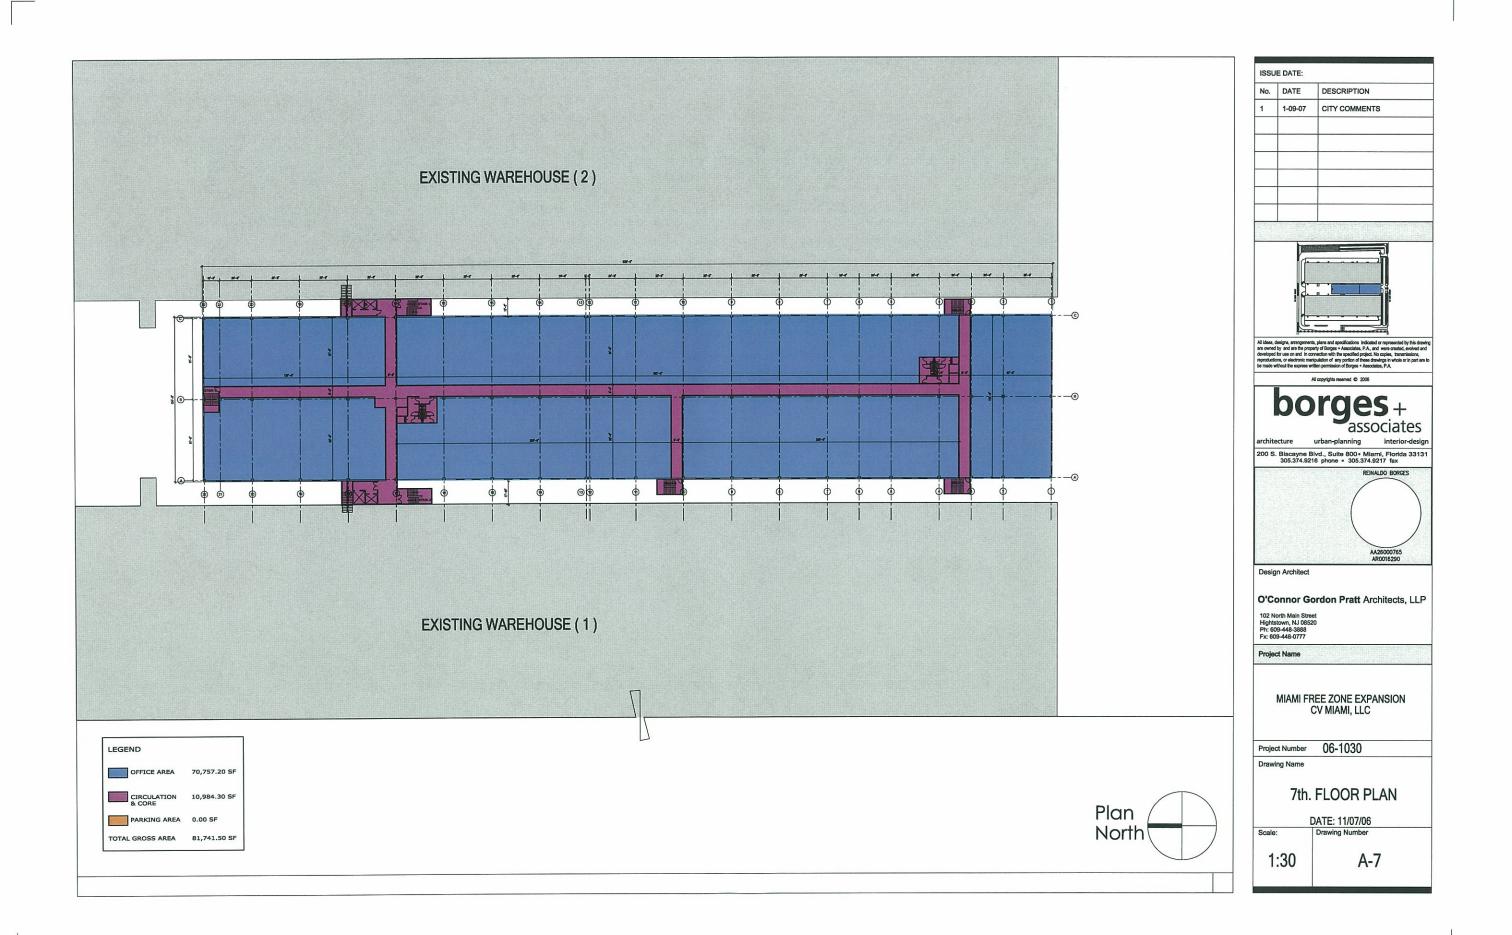


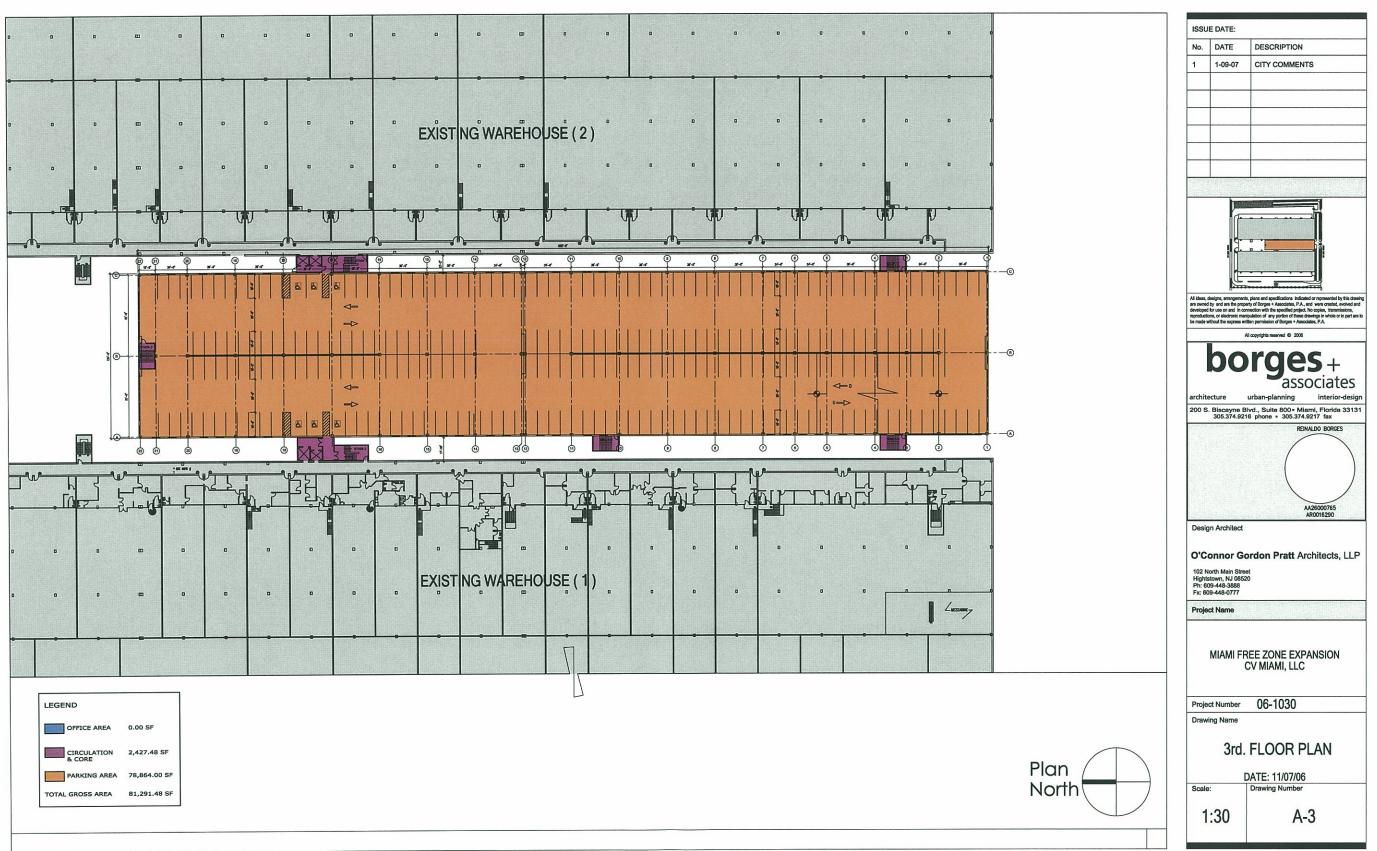


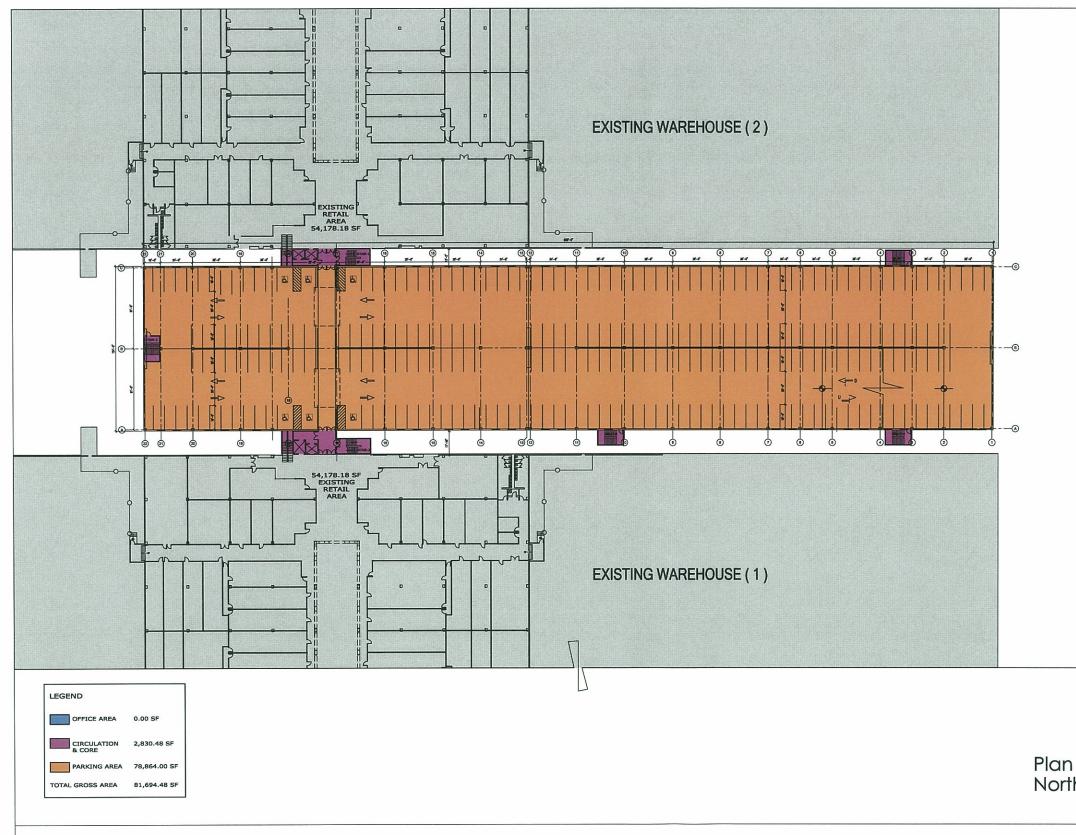


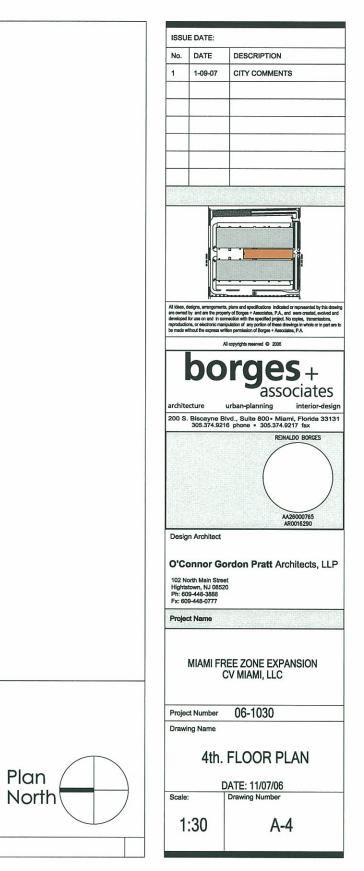


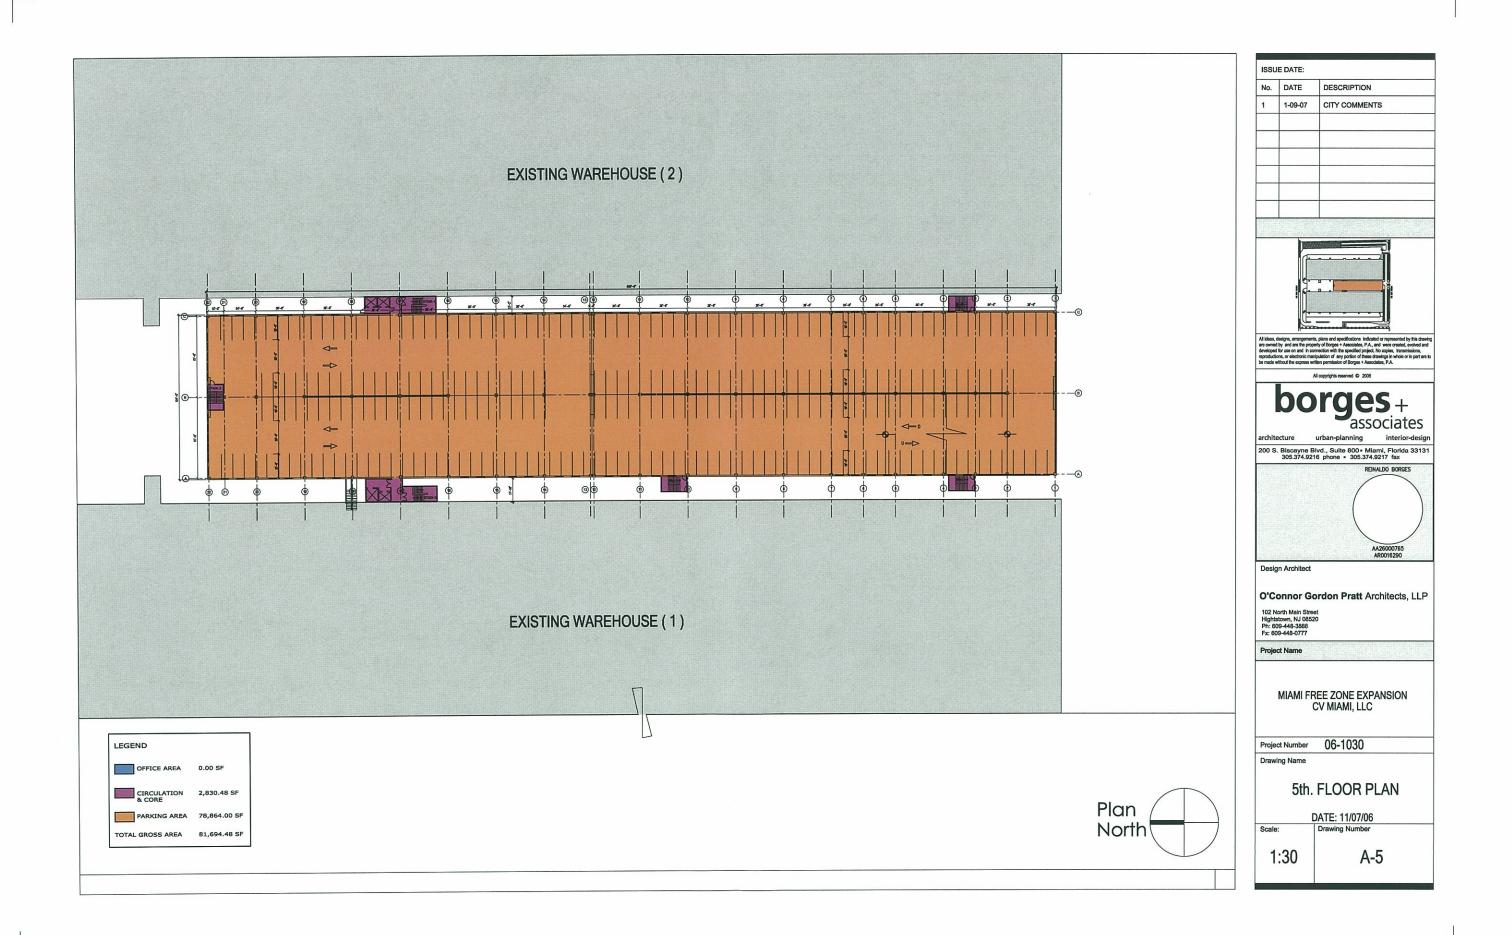


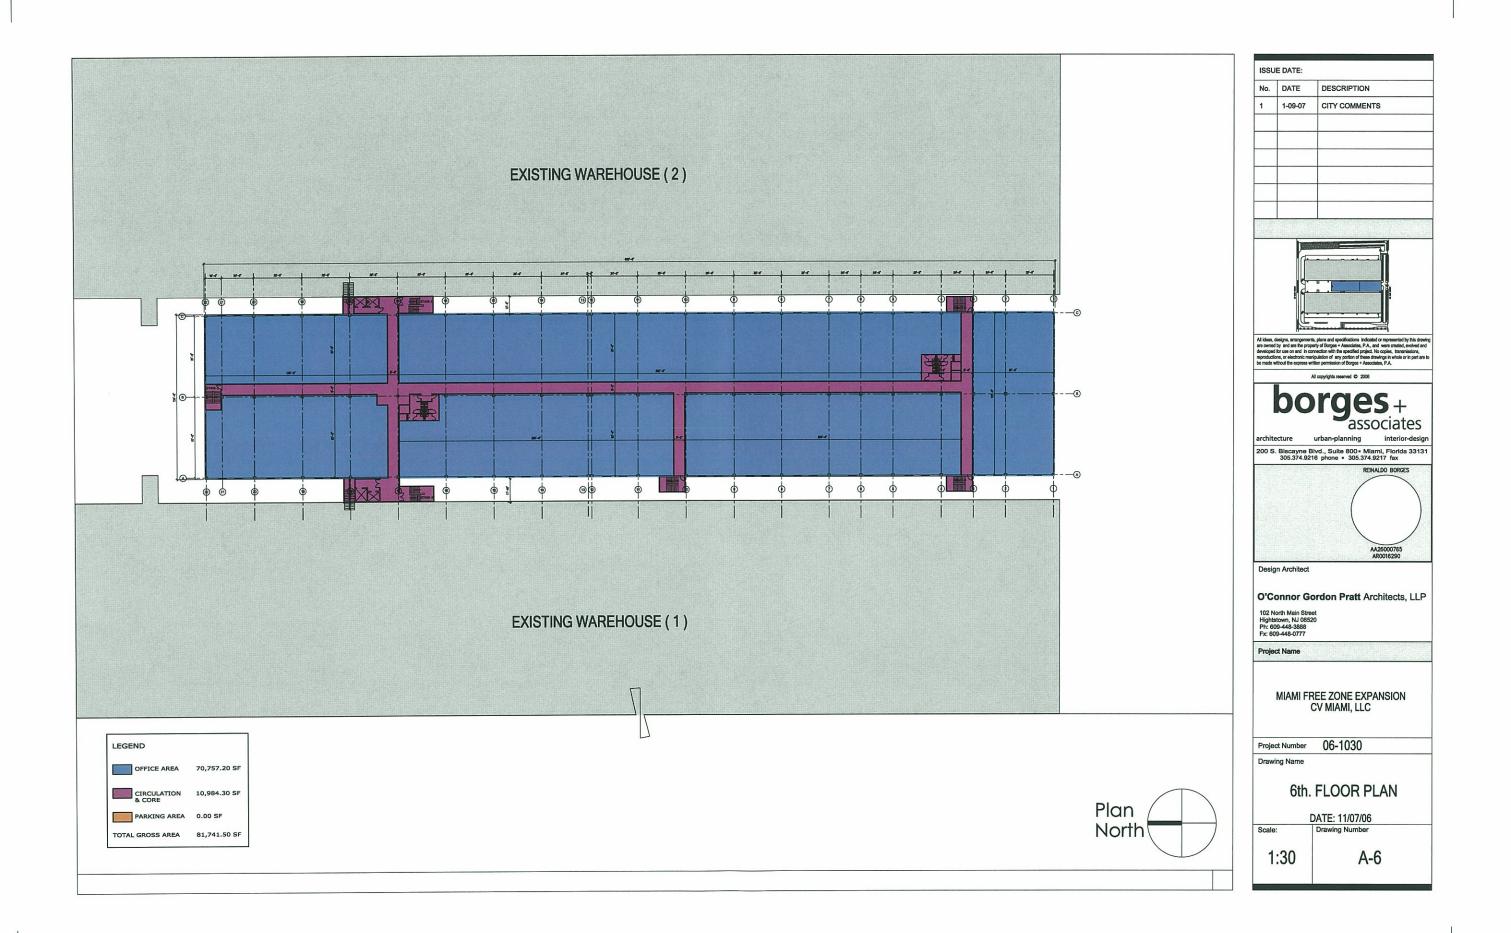


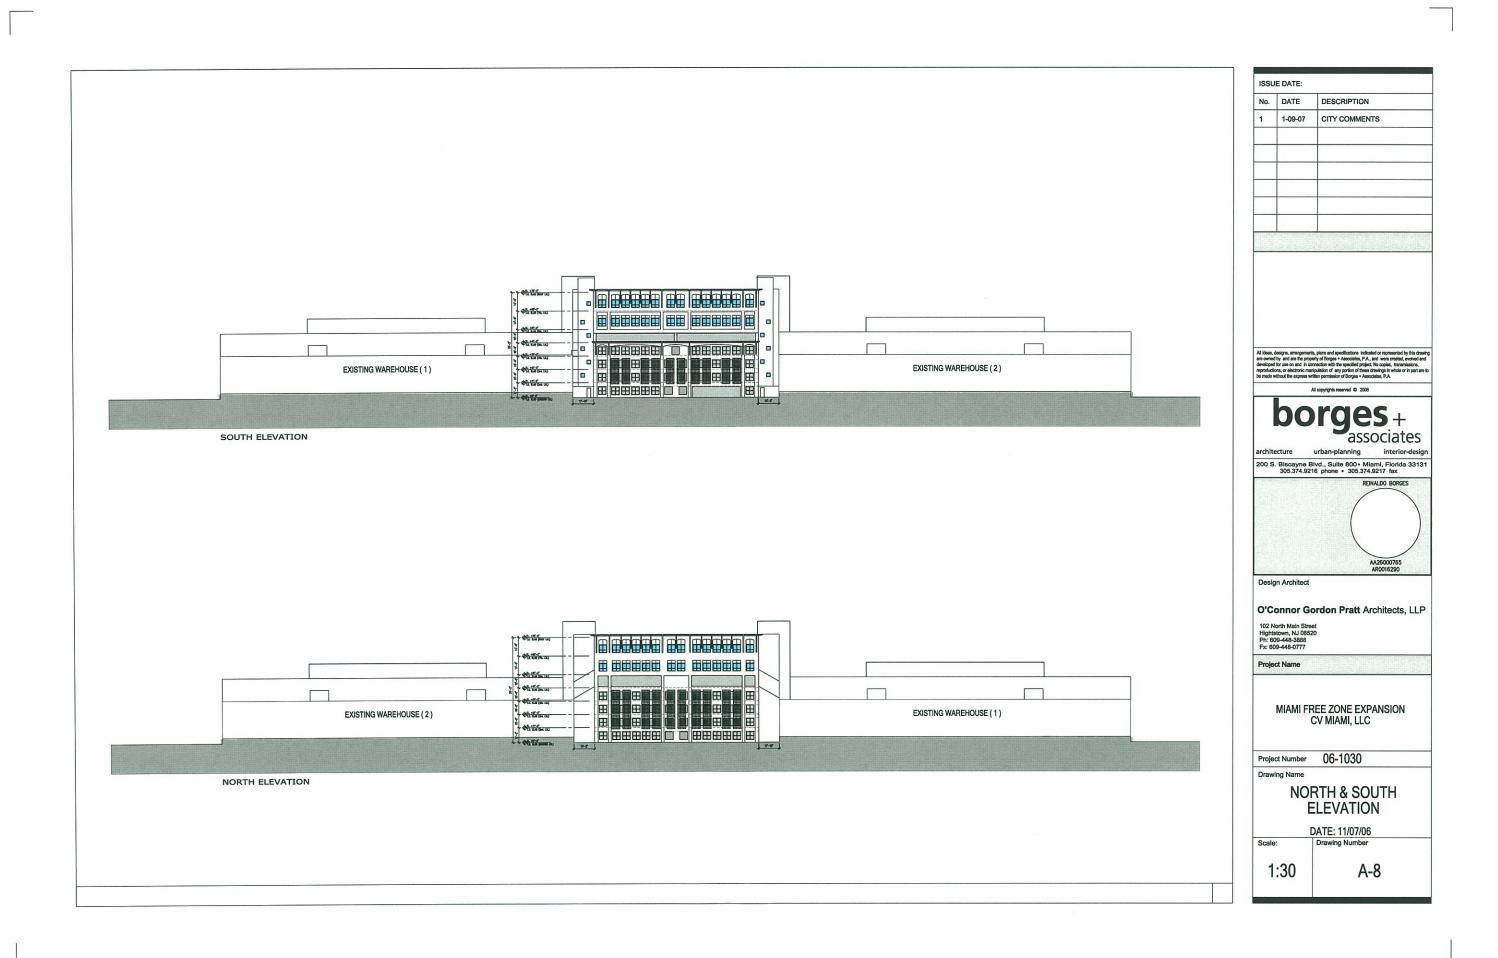


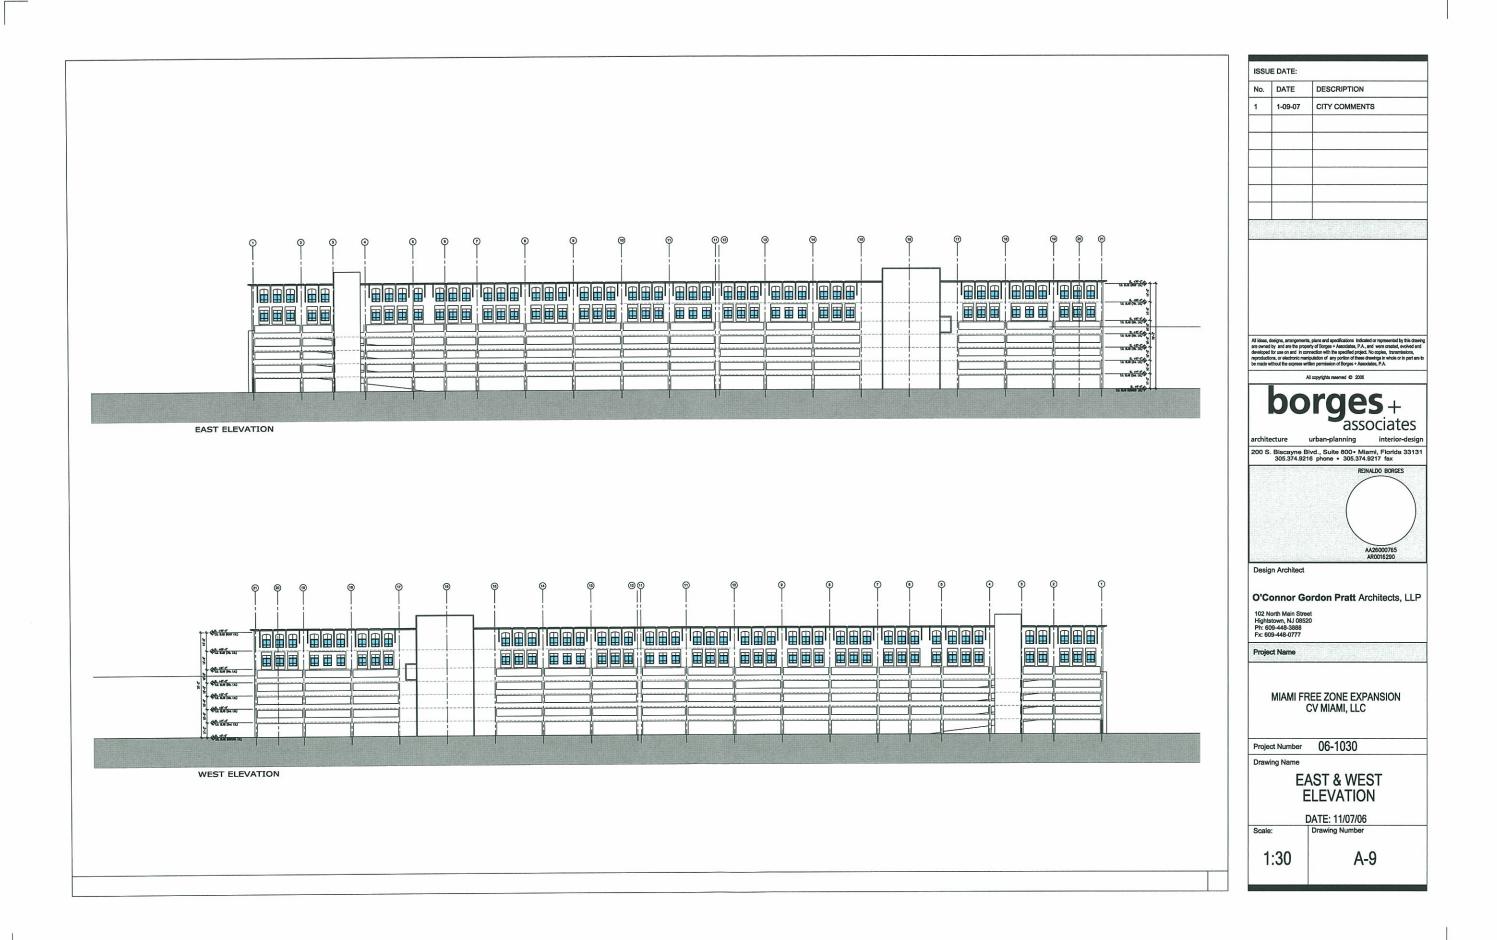

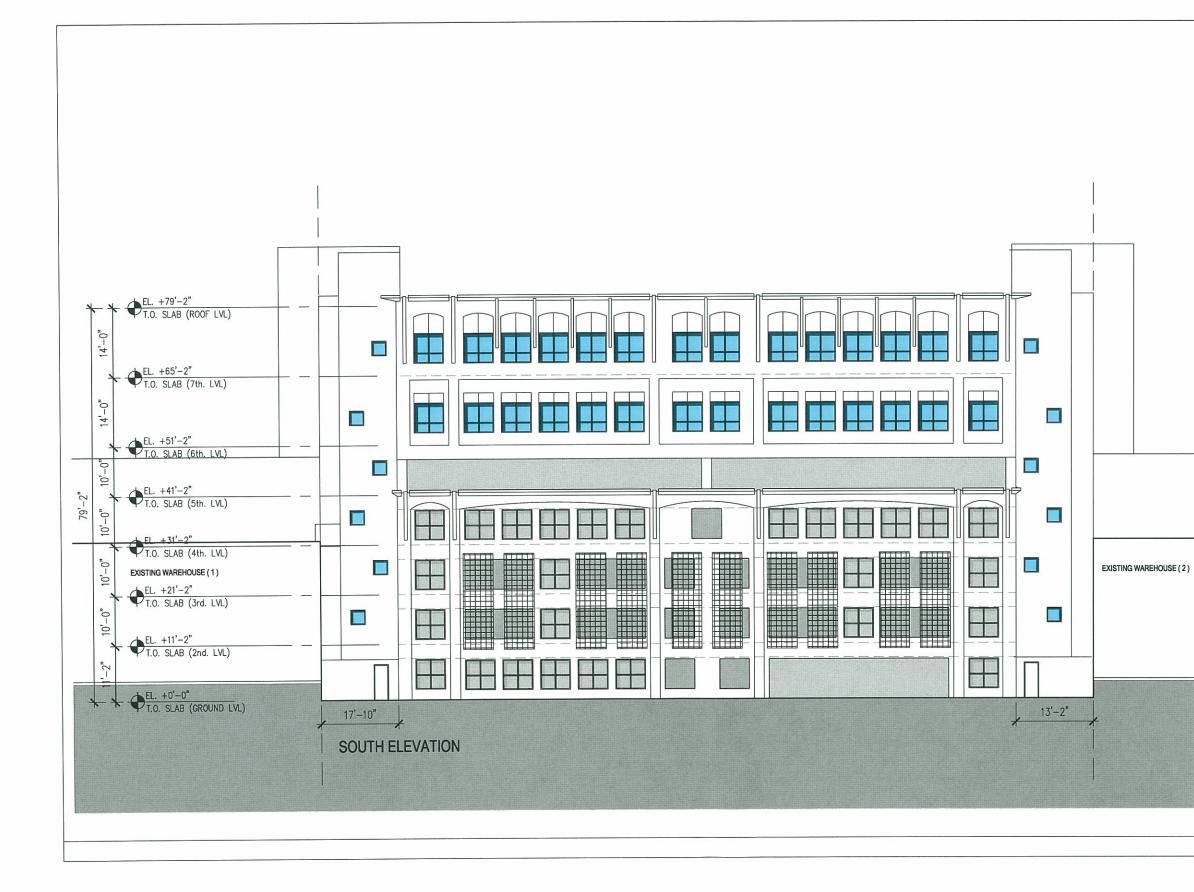


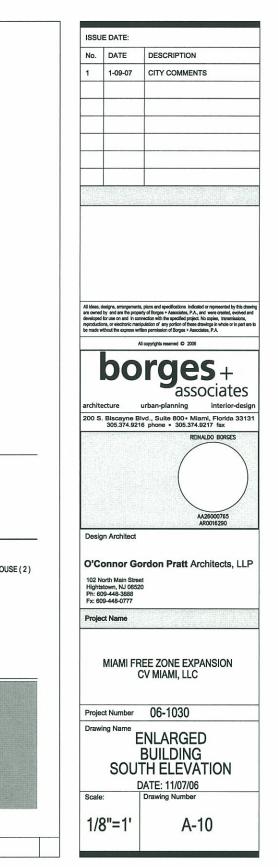


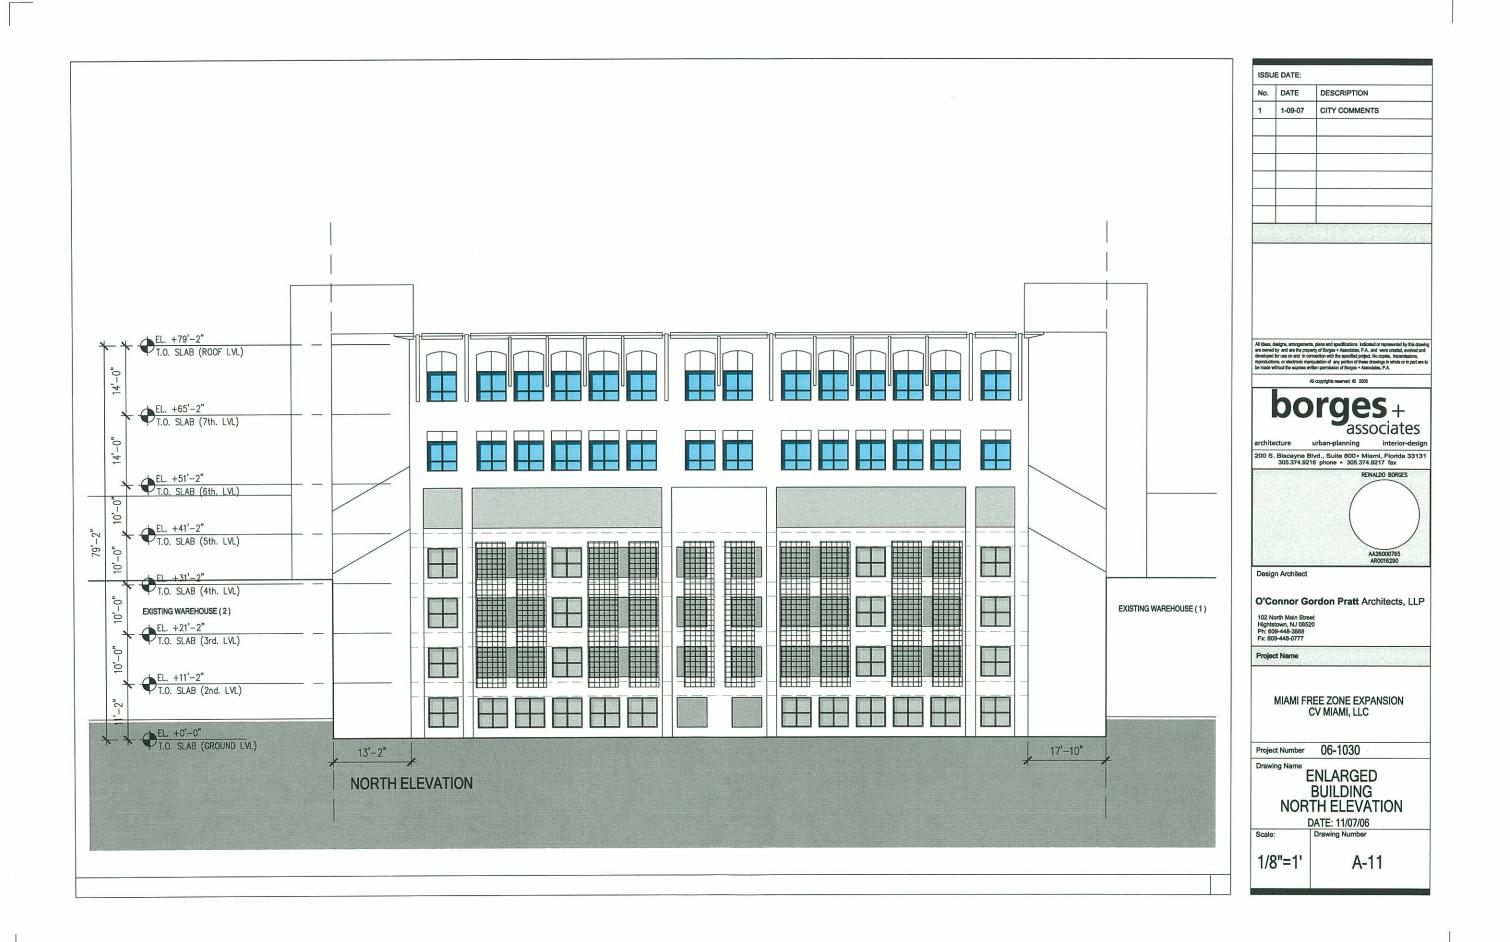

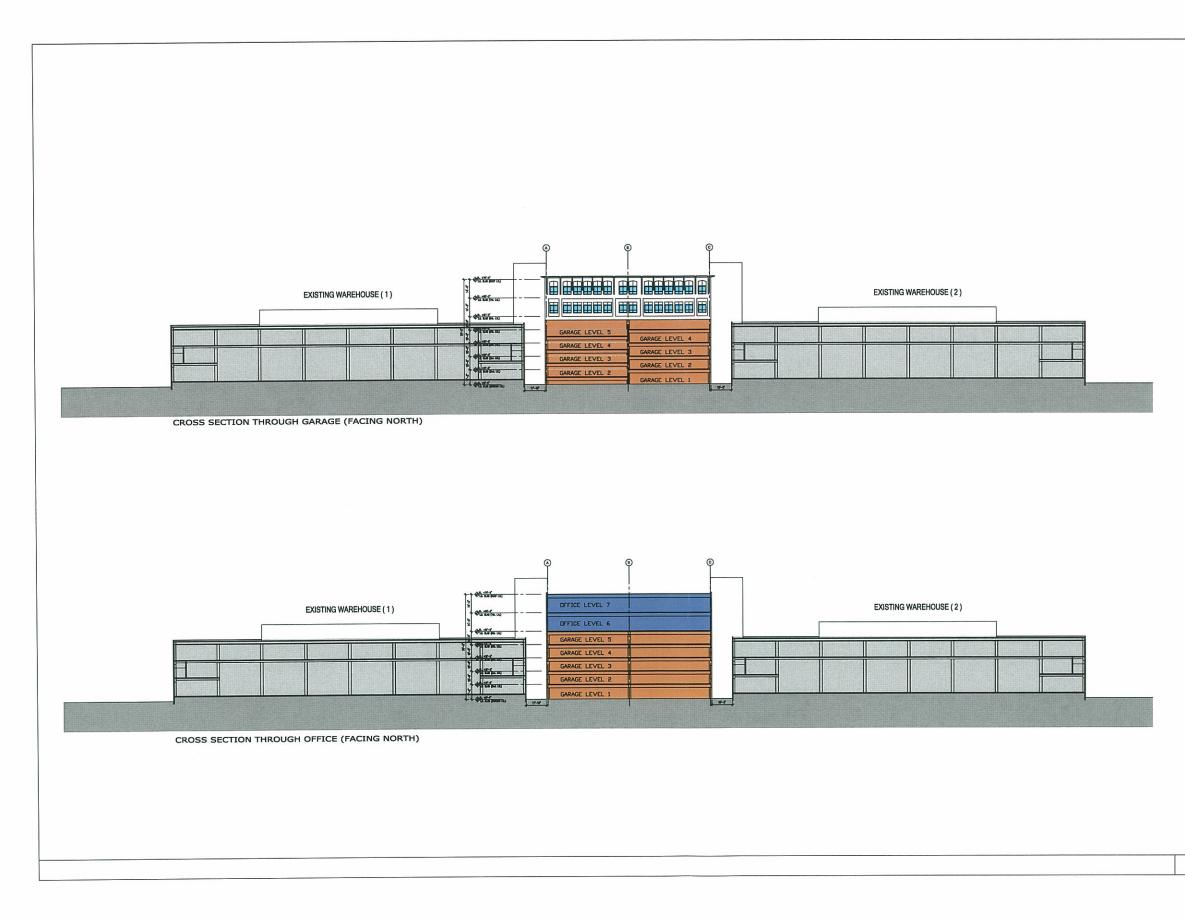



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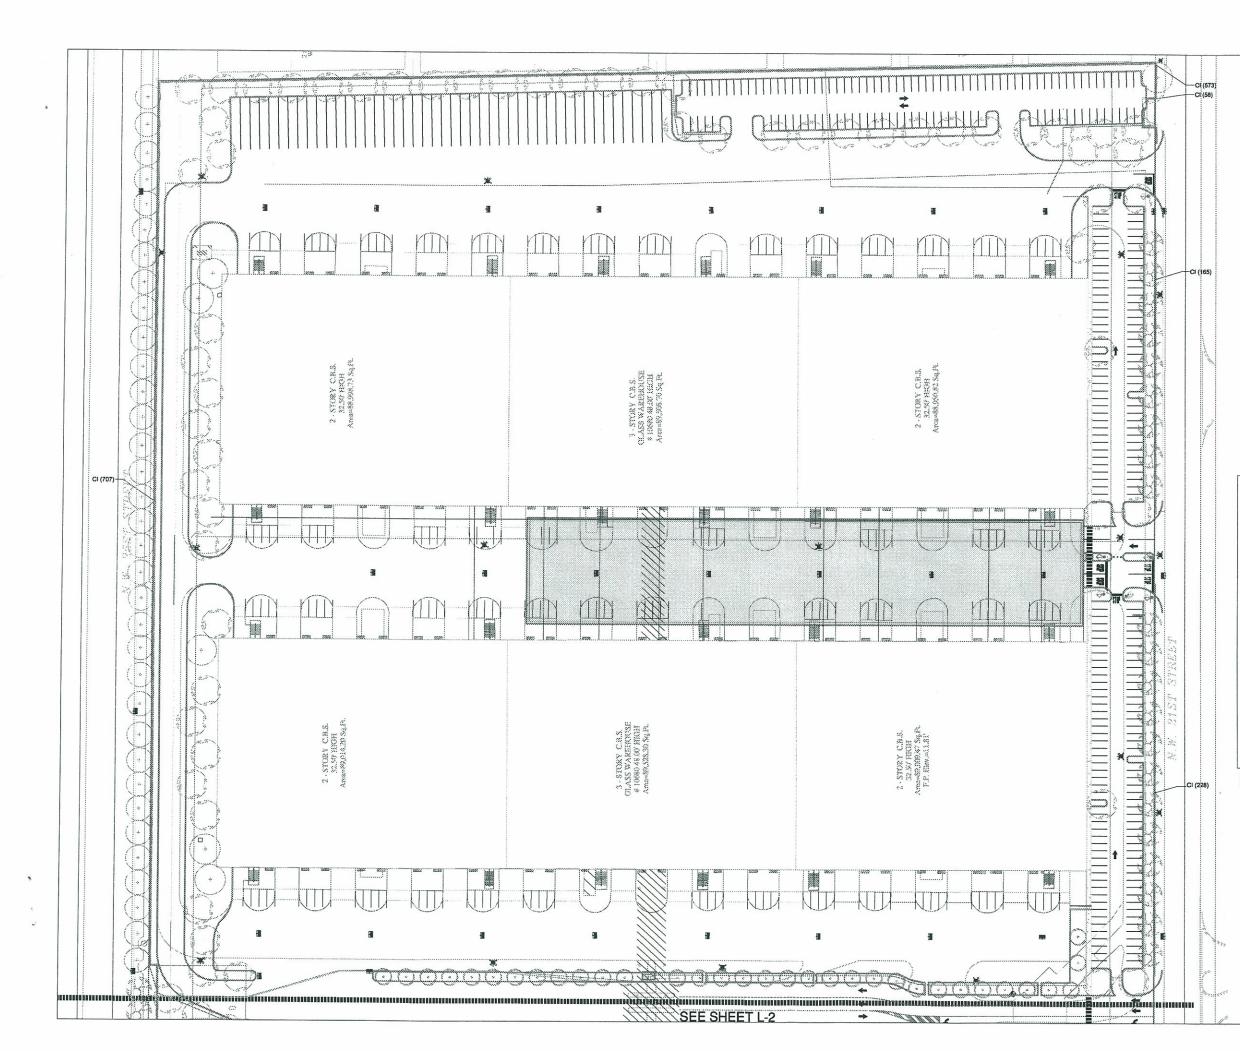


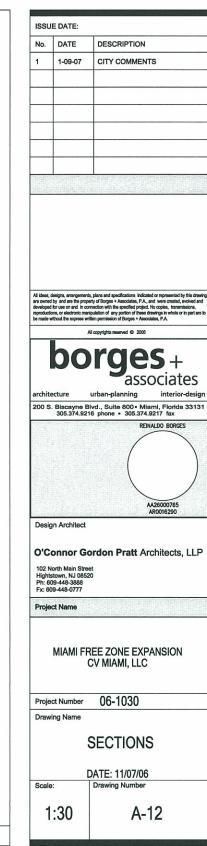

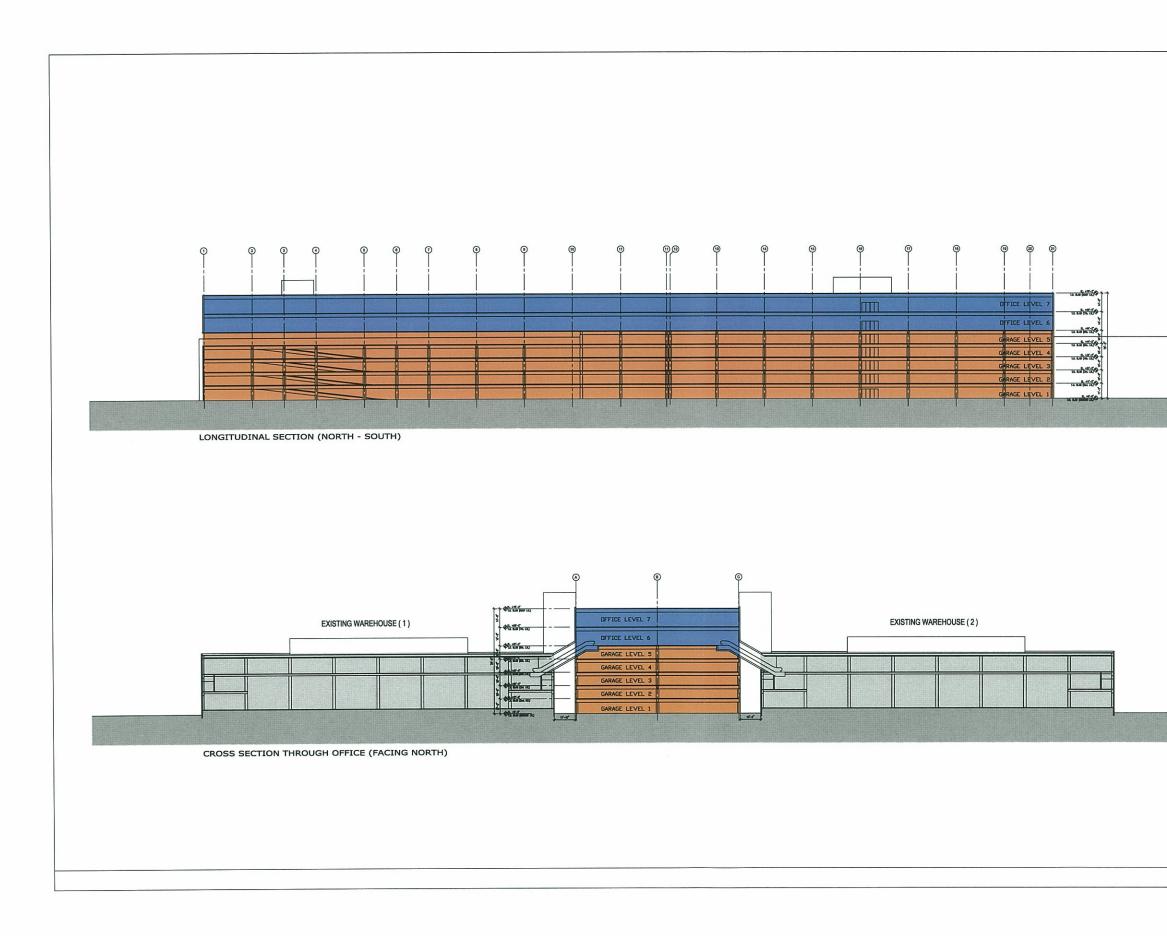C



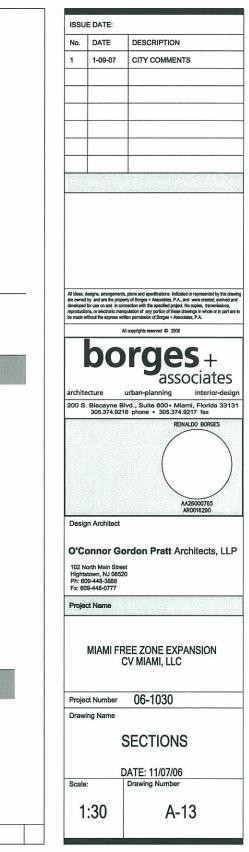

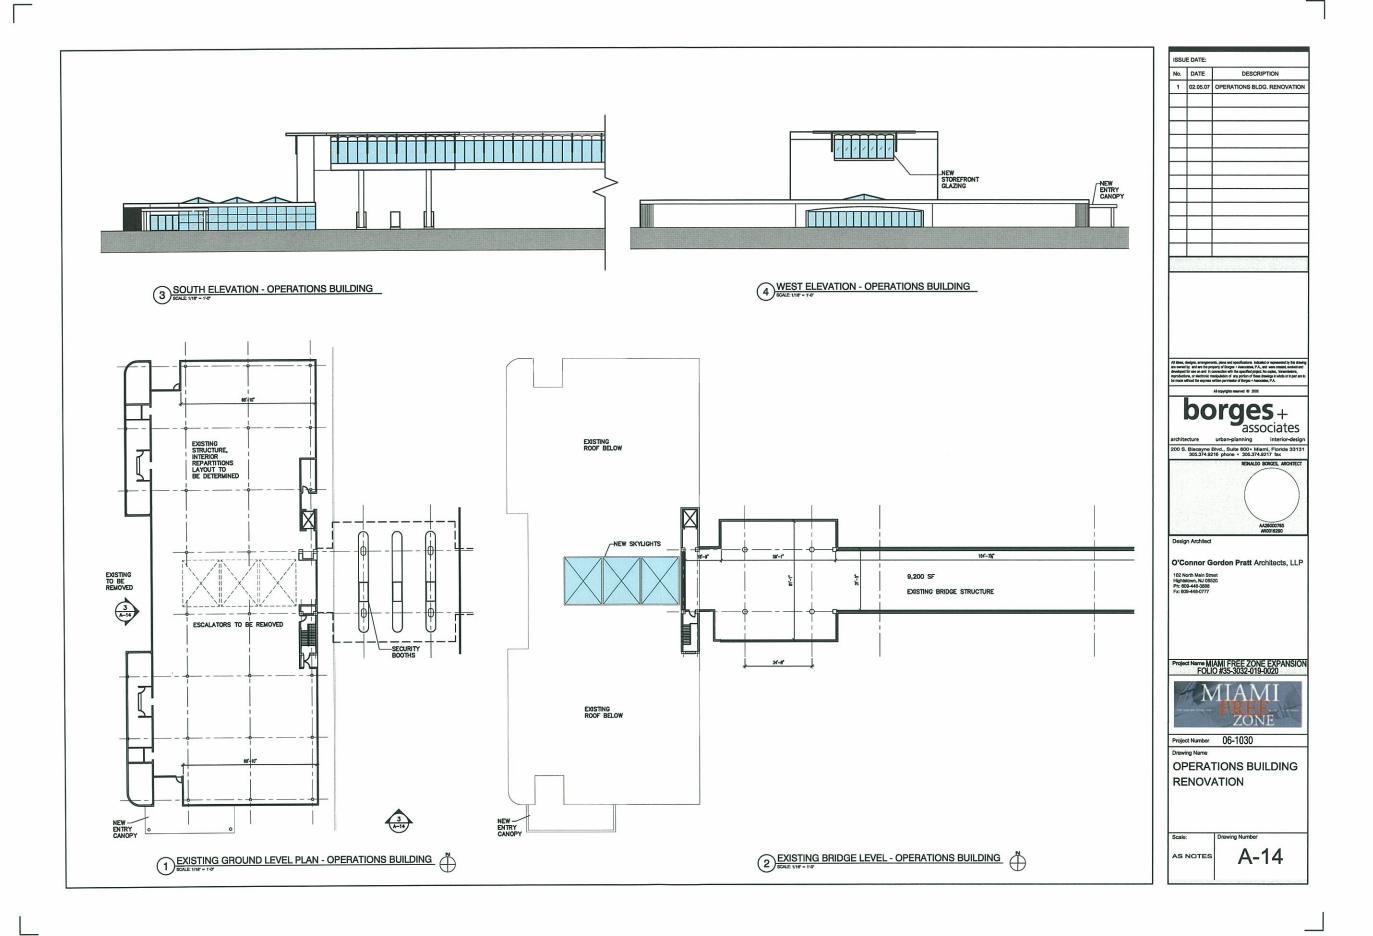

(71) EXISTING TREE TO REMAIN

VITHAUD	NEY	BOTANICAL / DOMMON NAME	DI-BOHIPTION
31		* Ilex cassine DAHOON HOLLY	12' ht. x 6' spr. f.g.
99	\bigcirc	* Quercus virginiana * LIVE OAK	12' ht. x 6' spr. f.g.
33	\odot	* Cordia sebestana * ORANGE GEIGER TREE	10' ht. x 5' spr. f.g.
25	$\langle \rangle$	* Swietania mahagoni * MAHOGANY	12' ht. x 6' spr. f.g.
2703	CI	* Chrysophyllum Icaco 'Red Tip' RED TIP COCOPLUM	36" ht. X 24" spr 3 gal.
AS REQ'D	LAWN	Paspalum notatum BAH/A GRASS	Solid Even Sod

Native Plant Material

LANDSCAPE LEGEND		
Zoning District: IU-C		
Net Lot Area 30.89 acres 1,345,568 s.f.		
OPEN SPACE	REQUIRED	PROVIDED
A. Square Feel of open space required by Chapter 33, as indicated on site pien Net lot area = _1,345,568 _ s.f. x_20_ % = _209,113_ s.f.	289,113	108,165.3
B. Square Feel of parking lot open space required by Chapter 18A,		
es indicated on ste plen: No. parking spaces 1,078 × 10 s.f. per parking spaces =	10,780	10,780
C. Total s.f. of landscaped open space required by Chapter 33: A + B =	279,893	198,935.3
LAWN AREA CALCULATION		
A_279.893_ total s.f. of landscaped open space required by Chapter 33	279,603	198,935.3
B. Maximum lawn area (eod) permitted = _20% x _279,803s.t =	66,979	55,979
TREES		
A. No. trees required per nel lot som		
Less existing number of trees meeting minimum requirements = <u>22</u> trees x not for every =	580	131 Proposed trees 5 Existing trees
B. % Palma Allowed: No. trees required x 30% = % Palma permitted to count as street trees 1:1 basis x 30%	204	NA
C. % Nelives Required: No. trees provided x 30% =	204	185
D. Street trees (maximum everage specing of 35" o.c.): 		57 Proposed trees 66 Existing trees
E. Street trees located directly beneath power lines (maximum everage specing of 25" o.c.): linear fest plong street / 25 =	NA	N/A
F. Total Trees Required A + D + E =T97Total Trees	797	259
SHRUBS		
A. No. trees required x 10 = No. of shrubs showed	7,970	2,703
B. No. shrubs allowed x 30% = No. of native shrubs required	2,391	2,703
IRRIGATION PLAN: If required by Chepter 38		

The safe sight distance triangle area shall not contain obstructions to cross-visibility at a height of two and one-hall (2.5) feet or more above the pervenant. Ground covers and shrubs may not exceed 30° in height if within sight tringles.

