#### **RESOLUTION No. 22-45**

A RESOLUTION OF THE MAYOR AND THE CITY COUNCIL OF THE CITY OF DORAL, FLORIDA, APPROVING THE SITE PLAN FOR RAISING CANE'S RESTAURANT FOR THE PROPERTY LOCATED AT 8080 NW 36 STREET, PURSUANT TO SECTION 53-184(F) OF THE CITY'S LAND DEVELOPMENT CODE; AND PROVIDING FOR AN EFFECTIVE DATE

WHEREAS, on November 2, 2016, the City of Doral (the "City") adopted Ordinance
No. 2016-29 amending the City's Land Development Code to establish procedures for
Mayor and City Council site plan review and approval process; and

WHEREAS Raising Cane's Restaurants, LLC (the "Applicant") has submitted an application for Mayor and Council site plan review and approval for Raising Cane's Restaurant for the property located at 8080 NW 36 Street, further identified by folio number 35-3027-001-0091, as legally described in "Exhibit A"; and

WHEREAS, a zoning workshop was held on January 20, 2022, at which meeting the public was afforded an opportunity to examine the project and provide feedback; and

WHEREAS, the City of Doral staff finds that the proposed site plan complies with the requirements and standards of the City's Land Development Code; and

WHEREAS, after notice of public hearing duly published and notifications of all property owners of record within 500-foot radius, a public hearing was held before the Mayor and City Council of the City of Doral on March 23, 2022, at which hearing all interested persons were afforded the opportunity to be heard; and

**WHEREAS**, the Mayor and City Council of the City of Doral find the adoption of this Resolution is in the best interest of the health, safety and welfare of the residents of the City of Doral.

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NOW, THEREFORE, BE IT RESOLVED BY THE MAYOR AND THE CITY COUNCIL OF THE CITY OF DORAL, FLORIDA, AS FOLLOWS:

<u>Section 1.</u> Recitals. The foregoing recitals are confirmed, adopted, and incorporated herein and made as part hereof by this reference.

Section 2. Approval. The Mayor and City Council hereby approve the site plan for Raising Cane's Restaurant for the property located at 8080 NW 36 Street, further identified by folio number 35-3027-001-0091, as legally described in "Exhibit A." The site plan consists of a 3,584 square-foot Raising Cane's Restaurant with a drive-through. A copy of the site plan is provided in "Exhibit B." The approval of the site plan is subject to the following conditions. Violation of these conditions may result in a code compliance citation or the revocation of this Resolution.

- 1. The proposed project shall be built in substantial compliance with the plans entitled "Raising Cane's Restaurant #0855," prepared by Kimley–Horn and Associates, Inc., dated stamped received February 17, 2022.
- 2. The project shall be landscaped in accordance with the landscape plan, prepared by Benjamin Van Johnson, dated stamped received February 17, 2022 as amended, and included with the site plan submittal.
- 3. Compliance with Ordinance No. 2015-09 "Public Arts Program" will be required at the time of building permit. No final approval, such as a final inspection or a certificate of occupancy, for development projects subject to the City's public arts program requirements shall be issued unless one or more of the following has been achieved:
  - I. The approved art has been installed in a manner that is [in] compliance with the requirements set forth in this ordinance and the public arts program guidelines; or
  - II. All in-lieu art fees have been paid; or
  - III. Financial security (including but not limited to a performance bond, letter of credit, or similar instrument) in an amount equal to the acquisition and installation costs of an approved art selection, has been provided to the City in a form approved by the City Attorney and the City Manager, or his/her designee and placed into escrow account; or
  - IV. Donation of art which have been approved by the board are delivered by the applicant to the City and are accepted by the City in accordance with this ordinance.

For purposes of the art program, "artwork" does not include the following:

- a. Directional elements, such as signage or graphics.
- b. Objects that are mass produced in standard designs.
- c. Landscape gardening, unless substantially comprising durable.
- 4. That the Applicant comply with the City's Floodplain Management regulations (Chapter 23, Article II, Floodplain Management) of the Land Development Code.
- 5. That the Applicant provide the City a certified drainage inspection report prior to the issuance of a certificate of occupancy.
- 6. That the property owner maintains the public rights-of-way adjacent to the property. Maintenance includes trees, plants, sod, and sidewalks within the rights-of-way.
- 7. A Stormwater Pollution Prevention Plan (SWPPP) must be submitted by the Applicant at time of building permit. The Plan should provide guidelines for implementing an erosion and sedimentation control program before the site is cleared or graded, including areas where topsoil will be removed, and contours of slopes will be cleared. The Plan shall also include location and type of erosion control measures, storm water and sediment management systems, and a vegetative plan for temporary and permanent stabilization. The Plan shall remain on-site for the duration of the construction activity.
- 8. If more than one (1) acre of land is disturbed during construction the Contractor/Developer is responsible to obtain NPDES Stormwater permit coverage through the Florida Department of Environmental Protection (FDEP), Construction Generic Permit (CGP). If the project is less than one (1) acre, but part of a larger common plan of development or sale that will ultimately disturb one or more acres, permit coverage is also required. Instruction to request and obtain a CGP can be found at: http://www.dep.state.fl.us/water/stormwater/npdes/docs/cgp.pdf.

  Contractor/Developer should submit the Notice of Intent (NOI) with the appropriate processing fees to the NPDES Stormwater Notices Center. Contractor/Developer must apply for permit coverage at least two (2) days before construction begins.
- 9. Construction shall be permitted only during the hours set forth in Ordinance No. 2011-01 "Noise Ordinance."
- 10. That the Applicant comply with all applicable conditions and requirements of the Miami-Dade County Department of Regulatory and Economic Resources.
- 11. That the Applicant comply with all applicable conditions and requirements of the Miami-Dade County Fire Rescue Department.
- 12. All applicable local, state and federal permits must be obtained before commencement of the development.

13. Issuance of this development permit by the City of Doral does not in any way create any right on the part of an Applicant to obtain a permit from a state or federal agency and does not create any liability on the part of the City of Doral for issuance of the permit if the applicant fails to obtain requisite approvals or fulfill the obligations imposed by a state or federal agency or undertakes actions that result in a violation of state or federal law.

<u>Section 3.</u> <u>Effective Date.</u> This Resolution shall become effective immediately upon its adoption.

The foregoing Resolution was offered by Councilmember Cabrera who moved its adoption. The motion was seconded by Councilmember Puig-Corve and upon being put to a vote, the vote was as follows:

| Mayor Juan Carlos Bermudez   | Yes |
|------------------------------|-----|
| Vice Mayor Digna Cabral      | Yes |
| Councilman Pete Cabrera      | Yes |
| Councilwoman Claudia Mariaca | Yes |
| Councilman Oscar Puig-Corve  | Yes |

PASSED AND ADOPTED this 23 day of March, 2022.

JUAN CARLOS BERMUDEZ, MAYOR

ATTEST:

CONNIÉ DIAZ, MMC

CITY CLERK

APPROVED AS TO FORM AND LEGAL SUFFICIENCY FOR THE USE AND RELIANCE OF THE CITY OF DORAL ONLY:

LUIS FIGUEREDO, ESQ.

CITY ATTORNEY

# **EXHIBIT "A"**

#### EXHIBIT A

#### LEGAL DESCRIPTION OF SUBJECT PROPERTY

#### SECTION 2) LEGAL DESCRIPTION:

That portions of the West 1/2 of the Tract 14, "FLORIDA FRUIT LAND COMPANY'S SUBDIVISION NO. 1", in Section 27, Township 53 South, Range 40 East, Miami Dade County, Florida, according to the Plat thereof, as recorded in Plat Book 2, at Page 17, of the Public Records of Miami-Dade County, Florida, lying South of Northwest 36 Street Extension Right-of-Way, and lying East of a line 353.16 feet East of and parallel with the West line of the Northeast 1/4 of Section 27.

#### Property Address and Tax Folio Number:

8050-8080 NW 36 Street Doral, Florida 33166 Folio No. 35-3027-001-0091

# EXHIBIT "B"



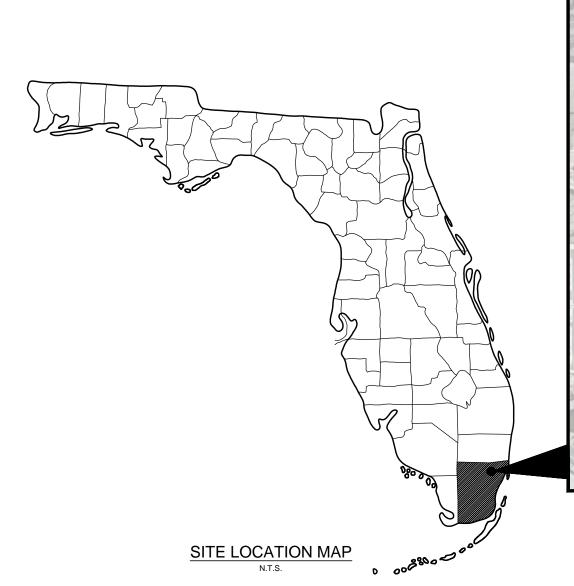
# SITE PLAN SET FOR

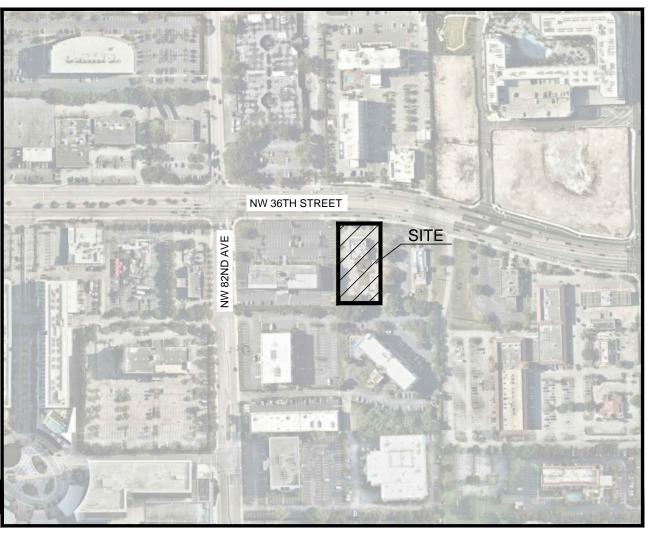


RESTAURANT C0855 8070 NW 36TH STREET DORAL, FLORIDA 33166 SECTION 27, TOWNSHIP 53S, RANGE 40E

# **GOVERNMENT / UTILITY CONTACTS**

| UTILITIES DEPARTMENT  CONTACT:  | MIAMI-DADE COUNTY WATER AND SEWER DEPARTMENT 3575 S. LE JEUNE ROAD MIAMI, FL 33146 PHONE: (786) 268-5273                             |
|---------------------------------|--|
| STORMWATER DEPARTMENT  CONTACT: | MIAMI-DADE REGULATORY AND ECONOMIC RESOURCES DEPARTMENT WATER CONTROL SECTION 701 NW 1ST COURT MIAMI, FL 33136 PHONE: (305) 372-6789 |
| ELECTRIC COMPANY CONTACT:       | FLORIDA POWER AND LIGHT<br>10705 QUAIL ROOST DR<br>MIAMI, FL 33157<br>PHONE: (386) 586-6403  |
| GAS COMPANY CONTACT:            | FLORIDA CITY GAS<br>4045 NW 97TH AVE<br>DORAL, FL 33178<br>PHONE: (305-835-3624)   |
| COMMUNICATIONS COMPANY CONTACT: | COMCAST CABLE<br>6565 NOVA DR<br>DAVIE, FL 33317<br>PHONE: (305) 433-0880  |





GRAPHIC SCALE IN FEET 150 300

VICINITY MAP

#### C2.0 GENERAL NOTES EROSION CONTROL PLAN C3.0 C3.1 **EROSION CONTROL DETAILS** C3.2 EROSION CONTROL NOTES C4.0 DEMOLITION PLAN C5.0 SITE KEYNOTE PLAN C5.1 DIMENSION CONTROL PLAN STRIPING AND SIGNAGE PLAN PAVING AND JOINTING PLAN **GRADING PLAN** C6.0 C7.0 STORM DRAINAGE PLAN WATER & SEWER NOTES WATER PLAN C9.2 SANITARY SEWER PLAN C9.3 WATER PROFILE C9.4 SEWER PROFILES WATER, SEWER AND DRAINAGE UTILITY C10.0 PLAN (PRIVATE) C11.0 CONSTRUCTION DETAILS C11.1 CONSTRUCTION DETAILS C12.0 OFFSITE IMPROVEMENT PLAN L-100 TREE SURVEY L-200 TREE DISPOSITION PLAN TREE DISPOSITION NOTES AND DETAILS L-250 L-300 LANDSCAPE PLAN L-301 LANDSCAPE SCHEDULE AND CODE LEGEND L-350 LANDSCAPE NOTES L-351 LANDSCAPE DETAILS L-400 IRRIGATION PLAN L-450 IRRIGATION NOTES IRRIGATION NOTES AND DETAILS

**DESCRIPTION** 

80% PROGRESS SET

SITE PLAN SUBMITTAL

SITE PLAN RESUBMITTAL

PLANS SUBMITTAL/REVIEW LOG

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INDEX OF SHEETS

COVER SHEET

Sheet No. | Sheet Title

# **CIVIL ENGINEER:**

KIMLEY-HORN AND ASSOCIATES, INC. 355 ALHAMBRA CIR CORAL GABLES, FLORIDA 33134 PHONE: (305) 535-1460 JUAN PABLO GONZALEZ PENA

# LANDSCAPE ARCHITECT: OWNER / DEVELOPER:

KIMLEY-HORN AND ASSOCIATES, INC. 355 ALHAMBRA CIR CORAL GABLES, FLORIDA 33134 PHONE: (305) 878-8155 BEN JOHNSON

RAISING CANES RESTAURANTS, L.L.C. 6800 BISHOP ROAD PLANO, TX 75024 PHONE: (469) 644-3198 REBECCA MUNOZ

# ARCHITECT:

935 GRAVIER ST., SUITE 1650

NEW ORLEANS, LA 70112

PHONE: (469) 498-2100

CSRS, INC.

LISA BACELIS

HADONNE 1985 NW 88TH COURT, SUITE 101 DORAL, FL 33172 PHONE: (305) 207-6845

**SURVEY:** 

ABRAHAM HADAD



Raising Cane's Restaurant #0855 8070 NW 36th Street Doral, FL 33166 CUSTOM [A]

Designer's Information:

Coral Gables, Florida 33134 Telephone: 469-498-2100 www.csrsinc.com

95 Merrick Way, 3rd floor

2021-1.0 (05-07-2021) 10-30-2021 Project Issue Date:

CSRS Project Manager:

**ENTITLEMENTS** 11-19-2021

355 ALHAMBRA CIRCLE, SUITE 1400, CORAL GABLES, FL 33134 PHONE: 305-673-2025 WWW.KIMLEY-HORN.COM REGISTRY NO. 696 STATE OF

DATE: 2/16/2022 THIS ITEM HAS BEEN DIGITALLY SIGNED AND SEALED BY JUAN PABLO GONZALEZ PENA, P.E. ON THE DATE ADJACENT TO THE SEAL.
PRINTED COPIES OF THIS DOCUMENT ARE NOT CONSIDERED SIGNED AND SEALED AND THE SIGNATURE MUST BE VERIFIED ON ANY ELECTRONIC COPIES.

**Sheet Versions:** 

# Date Description /1\ 02/16/2022 ENTITLEMENTS RESUBMITTAL

Sheet Title:

**COVER SHEET** 

Sheet Number:

CAUTION!! CONTRACTOR IS TO VERIFY PRESENCE AND EXACT LOCATION OF ALL UTILITIES PRIOR TO CONSTRUCTION. Call 811 or www.sunshine811.com two siness days before digging to have utiliti located and marked.

11/17/2021 | SITE PLAN

02/16/2022 | SITE PLAN

11/19/2021

SITE PLAN

MILESTONE

FOR REVIEW

## GENERAL NOTES AND SPECIFICATIONS

#### I. APPLICABLE CODES

- 1. ALL WORK AND MATERIALS SHALL CONFORM TO CURRENT MIAMI-DADE COUNTY PUBLIC WORKS DEPARTMENT (MDCPWD), MIAMI-DADE COUNTY DEPARTMENT OF REGULATORY AND ECONOMIC RESOURCES WATER CONTROL SECTION (DRER), MIAMI-DADE WATER AND SEWER DEPARTMENT (M-DWASD), AND THE FLORIDA DEPARTMENT OF TRANSPORTATION (FDOT) STANDARDS AND SPECIFICATIONS AS WELL AS ALL LOCAL, STATE, AND NATIONAL CODES AND REGULATORY REQUIREMENTS, AS APPLICABLE.
- 2. THE CONTRACTOR SHALL BE RESPONSIBLE FOR ENSURING THAT ALL CONSTRUCTION SHALL BE DONE IN A SAFE MANNER AND IN STRICT COMPLIANCE WITH ALL THE REQUIREMENTS OF FEDERAL OCCUPATIONAL SAFETY AND HEALTH ACT OF 1970, AND ALL STATE AND LOCAL SAFETY AND HEALTH REGULATIONS.
- 3. LOCATIONS, ELEVATIONS AND DIMENSIONS OF EXISTING UTILITIES, STRUCTURES AND OTHER SITE FEATURES SHOWN ON THE DRAWINGS WERE OBTAINED FROM THE BOUNDARY SURVEY BY:

1985 NW 88TH COURT, SUITE 101

DORAL, FLORIDA 33172

- 4. ELEVATIONS SHOWN HEREON RELATE TO NATIONAL GEODETIC VERTICAL DATUM, N.G.V.D., 1929.
- 5. PROPOSED ELEVATIONS SHOWN ARE FINISHED GRADES.
- 6. EXISTING UTILITIES TO BE ADJUSTED IN ACCORDANCE WITH PROPOSED GRADES AND REQUIREMENTS OF UTILITY OWNERS, AS REQUIRED.
- 7. EXISTING STRUCTURES, TREES, UTILITIES AND OTHER IMPROVEMENTS WHICH ARE TO REMAIN IN PLACE SUCH AS BUILDING SEWERS, DRAINS, WATER OR GAS PIPES, CONDUITS, POLES, WALLS, COLUMNS, ETC., WHETHER OR NOT SHOWN ON THE PLANS, ARE TO BE CAREFULLY PROTECTED FROM DAMAGE. IF DAMAGE OCCURS FROM WORK PERFORMED UNDER THIS CONTRACT, THE CONTRACTOR SHALL PROMPTLY REPAIR THE DAMAGED ITEM(S) TO THE CONDITION OF THE ITEM(S) PRIOR TO THE DAMAGE. THIS WORK SHALL BE AT NO ADDITIONAL COST TO THE
- 8. THE CONTRACTOR IS TO USE CAUTION WHEN WORKING IN OR AROUND AREAS OF OVERHEAD TRANSMISSION LINES AND UNDERGROUND UTILITIES.
- 9. CONTRACTOR SHALL PRESERVE ALL STREET SIGNS, PARKING METERS, BENCHES, TRAFFIC CONTROL SIGNS, ETC. WHEN DIRECTED BY THE ENGINEER, THE CONTRACTOR SHALL REINSTALL OR DELIVER SAID PUBLIC PROPERTY TO
- 10. THE CONTRACTOR SHALL COORDINATE HIS/HER WORK WITH ANY OTHER UTILITY AND BUILDING TRADES WORKING ON THIS OR ADJACENT PROJECT.
- 11. ALL DITCH EXCAVATION SHALL BE PERFORMED IN FULL COMPLIANCE WITH THE PROVISIONS OF THE FLORIDA TRENCH SAFETY ACT.
- 12. THE CONTRACTOR SHALL TAKE SPECIAL NOTE OF SOIL CONDITIONS THROUGHOUT THIS PROJECT. ANY SPECIAL SHORING, SHEETING OR OTHER PROCEDURES NECESSARY TO PROTECT ADJACENT PROPERTY, EITHER PUBLIC OR PRIVATE, DURING EXCAVATION OF SUBSOIL MATERIAL OR DURING THE FILLING OF ANY AREA, OR FOR ANY OPERATION DURING CONSTRUCTION SHALL BE THE SOLE RESPONSIBILITY OF THE CONTRACTOR.
- 13. THE CONTRACTOR AND SUBCONTRACTORS SHALL OBTAIN A COPY OF THE FDOT "STANDARD SPECIFICATIONS FOR ROAD AND BRIDGE CONSTRUCTION" (LATEST EDITION), M-DCPWD STANDARDS AND SPECIFICATIONS, MDWASD STANDARD DETAILS AND SPECIFICATIONS, AND ALL OTHER APPLICABLE STANDARD AND/OR SPECIFICATIONS PERTAINING TO THE PROPOSED WORK AND BECOME FAMILIAR WITH THE CONTENTS PRIOR TO COMMENCING WORK. UNLESS OTHERWISE NOTED, ALL WORK SHALL CONFORM AS APPLICABLE TO THESE STANDARDS AND SPECIFICATIONS.
- 14. THE CONTRACTOR SHALL BE RESPONSIBLE FOR FURNISHING ALL MATERIAL AND LABOR TO CONSTRUCT THE FACILITY AS SHOWN AND DESCRIBED IN THE CONSTRUCTION DOCUMENTS IN ACCORDANCE WITH THE APPROPRIATE APPROVING AUTHORITIES, SPECIFICATIONS AND REQUIREMENTS. CONTRACTOR SHALL CLEAR AND GRUB ALL AREAS UNLESS OTHERWISE INDICATED, REMOVING TREES, STUMPS, ROOTS, MUCK, EXISTING PAVEMENT AND ALL OTHER DELETERIOUS MATERIAL
- 15. EXISTING UTILITIES SHOWN ARE LOCATED ACCORDING TO THE INFORMATION AVAILABLE TO THE ENGINEER AT THE TIME OF THE TOPOGRAPHIC SURVEY AND HAVE NOT BEEN INDEPENDENTLY VERIFIED BY THE OWNER OR THE ENGINEER. GUARANTEE IS NOT MADE THAT ALL EXISTING UNDERGROUND UTILITIES ARE SHOWN OR THAT THE LOCATION OF THOSE SHOWN ARE ENTIRELY ACCURATE. FINDING THE ACTUAL LOCATION OF ANY EXISTING UTILITIES IS THE CONTRACTOR'S RESPONSIBILITY AND SHALL BE DONE BEFORE COMMENCING ANY WORK IN THE VICINITY. FURTHERMORE, THE CONTRACTOR SHALL BE FULLY RESPONSIBLE FOR ANY AND ALL DAMAGES DUE TO THE CONTRACTOR'S FAILURE TO EXACTLY LOCATE AND PRESERVE ANY AND ALL UNDERGROUND UTILITIES. THE OWNER OR ENGINEER WILL ASSUME NO LIABILITY FOR ANY DAMAGES SUSTAINED OR COST INCURRED BECAUSE OF THE OPERATIONS IN THE VICINITY OF EXISTING UTILITIES OR STRUCTURES, NOR FOR TEMPORARY BRACING AND SHORING OF SAME. IF IT IS NECESSARY TO SHORE, BRACE, SWING OR RELOCATE A UTILITY, THE UTILITY COMPANY OR DEPARTMENT AFFECTED SHALL BE CONTACTED AND THEIR PERMISSION OBTAINED REGARDING THE METHOD TO USE FOR SUCH WORK.
- 16. IT IS THE CONTRACTOR'S RESPONSIBILITY TO CONTACT THE VARIOUS UTILITY COMPANIES WHICH MAY HAVE BURIED OR AERIAL UTILITIES WITHIN OR NEAR THE CONSTRUCTION AREA BEFORE COMMENCING WORK. THE CONTRACTOR SHALL PROVIDE 48 HOURS MINIMUM NOTICE TO ALL UTILITY COMPANIES PRIOR TO BEGINNING CONSTRUCTION. AN APPROXIMATE LIST OF THE UTILITY COMPANIES WHICH THE CONTRACTOR MUST CALL BEFORE COMMENCING WORK IS PROVIDED ON THE COVER SHEET OF THESE CONSTRUCTION PLANS. THIS LIST SERVES AS A GUIDE ONLY AND IS NOT INTENDED TO LIMIT THE UTILITY COMPANIES WHICH THE CONTRACTOR MAY WISH TO NOTIFY.
- 17. THE CONTRACTOR SHALL BE RESPONSIBLE FOR OBTAINING ALL REQUIRED CONSTRUCTION PERMITS AND BONDS IF REQUIRED PRIOR TO CONSTRUCTION.
- 18. THE CONTRACTOR SHALL HAVE AVAILABLE AT THE JOB SITE AT ALL TIMES ONE COPY OF THE CONSTRUCTION DOCUMENTS INCLUDING PLANS, SPECIFICATIONS, GEOTECHNICAL REPORT AND SPECIAL CONDITIONS AND COPIES OF ANY REQUIRED CONSTRUCTION PERMITS.
- 19. ANY DISCREPANCIES ON THE DRAWINGS SHALL BE IMMEDIATELY BROUGHT TO THE ATTENTION OF THE OWNER AND ENGINEER BEFORE COMMENCING WORK. NO FIELD CHANGES OR DEVIATIONS FROM DESIGN ARE TO BE MADE WITHOUT PRIOR APPROVAL OF THE OWNER AND NOTIFICATION TO THE ENGINEER.
- 20. ALL COPIES OF COMPACTION, CONCRETE AND OTHER REQUIRED TEST RESULTS ARE TO BE SENT TO THE OWNER AND DESIGN ENGINEER OF RECORD DIRECTLY FROM THE TESTING AGENCY.
- 21. THE CONTRACTOR SHALL BE RESPONSIBLE FOR SUBMITTING TO THE ENGINEER A CERTIFIED RECORD SURVEY SIGNED AND SEALED BY A PROFESSIONAL LAND SURVEYOR REGISTERED IN THE STATE OF FLORIDA DEPICTING THE ACTUAL FIELD LOCATION OF ALL CONSTRUCTED IMPROVEMENTS THAT ARE REQUIRED BY THE JURISDICTIONAL AGENCIES FOR THE CERTIFICATION PROCESS. ALL SURVEY COSTS WILL BE THE CONTRACTORS RESPONSIBILITY.
- 22. THE CONTRACTOR SHALL BE RESPONSIBLE FOR DOCUMENTING AND MAINTAINING AS-BUILT INFORMATION WHICH SHALL BE RECORDED AS CONSTRUCTION PROGRESSES OR AT THE COMPLETION OF APPROPRIATE CONSTRUCTION INTERVALS AND SHALL BE RESPONSIBLE FOR PROVIDING AS-BUILT DRAWINGS TO THE OWNER FOR THE PURPOSE OF CERTIFICATION TO JURISDICTIONAL AGENCIES AS REQUIRED. ALL AS-BUILT DATA SHALL BE COLLECTED BY A STATE OF FLORIDA PROFESSIONAL LAND SURVEYOR WHOSE SERVICES ARE ENGAGED BY THE CONTRACTOR.
- 23. ANY WELLS DISCOVERED ON SITE THAT WILL HAVE NO USE MUST BE PLUGGED BY A LICENSED WELL DRILLING CONTRACTOR IN A MANNER APPROVED BY ALL JURISDICTIONAL AGENCIES. CONTRACTOR SHALL BE RESPONSIBLE FOR OBTAINING ANY WELL ABANDONMENT PERMITS REQUIRED.
- 24. ANY WELL DISCOVERED DURING EARTH MOVING OR EXCAVATION SHALL BE REPORTED TO THE APPROPRIATE JURISDICTIONAL AGENCIES WITHIN 24 HOURS AFTER DISCOVERY IS MADE.
- 25. ANY WELL TO REMAIN SHALL BE ADJUSTED TO GRADE BY THE CONTRACTOR.
- 26. THE CONTRACTOR SHALL BE RESPONSIBLE FOR VERIFYING THAT THE PROPOSED IMPROVEMENTS SHOWN ON THE PLANS DO NOT CONFLICT WITH ANY KNOWN EXISTING OR OTHER PROPOSED IMPROVEMENTS. IF ANY CONFLICTS ARE DISCOVERED, THE CONTRACTOR SHALL NOTIFY THE OWNER PRIOR TO INSTALLATION OF ANY PORTION OF THE SITE WORK THAT WOULD BE AFFECTED. FAILURE TO NOTIFY OWNER OF AN IDENTIFIABLE CONFLICT PRIOR TO PROCEEDING WITH INSTALLATION RELIEVES OWNER OF ANY OBLIGATION TO PAY FOR A RELATED CHANGE ORDER.
- 27. IT IS THE CONTRACTOR'S RESPONSIBILITY TO COORDINATE MAINTENANCE OF TRAFFIC CIRCULATION FOR THE ADJACENT PROPERTY DURING CONSTRUCTION.
- 28. IF IT SHOULD BECOME NECESSARY TO STOP WORK FOR INDEFINITE PERIODS, THE CONTRACTOR SHALL TAKE EVERY PRECAUTION TO PREVENT DAMAGE OR DETERIORATION OF THE WORK ALREADY PERFORMED.
- II. PRECONSTRUCTION RESPONSIBILITIES
- 1. THE INFORMATION PROVIDED IN THESE PLANS IS TO ASSIST THE CONTRACTOR IN ASSESSING THE NATURE AND EXTENT OF THE CONDITIONS WHICH MAY BE ENCOUNTERED DURING THE COURSE OF THE WORK. ALL CONTRACTORS ARE DIRECTED, PRIOR TO BIDDING, TO CONDUCT ANY INVESTIGATIONS THEY DEEM NECESSARY TO ARRIVE AT THEIR OWN CONCLUSIONS REGARDING THE ACTUAL CONDITIONS THAT WILL BE ENCOUNTERED AND UPON WHICH THEIR
- 2. TWO (2) BUSINESS DAYS BEFORE BEGINNING CONSTRUCTION IN THE AREA, THE CONTRACTOR SHALL NOTIFY SUNSHINE STATE CALL ONE OF FLORIDA, INC. AT 811 AND ANY OTHER UTILITY COMPANIES WHICH MIGHT BE
- 3. UPON THE RECEIPT OF THE "NOTICE TO PROCEED", THE CONTRACTOR SHALL CONTACT THE ENGINEER OF RECORD AND ARRANGE A PRECONSTRUCTION CONFERENCE TO INCLUDE ALL INVOLVED GOVERNMENTAL AGENCIES, UTILITY OWNERS, THE OWNER, AND THE ENGINEER OF RECORD.

- 4. THE CONTRACTOR SHALL APPLY FOR AND PROCURE ALL PERMITS AND LICENSES, PAY ALL CHARGES, TAXES, ROYALTIES & FEES, AND GIVE ALL NOTICES NECESSARY TO COMPLETE THIS PROJECT.
- 5. THE CONTRACTORS SHALL COORDINATE WITH UTILITY COMPANIES TO ARRANGE FOR ANY REMOVAL, RELOCATION AND TEMPORARY SUPPORT OF UTILITY FEATURES, ETC. AS NECESSARY TO COMPLETE THE WORK, IF APPLICABLE.
- 6. THE LOCATIONS OF THE UTILITIES SHOWN IN THE PLANS ARE APPROXIMATE ONLY. THE CONTRACTOR SHALL LOCATE AND EXPOSE ALL EXISTING UTILITIES TO BE CONNECTED SUFFICIENTLY AHEAD OF CONSTRUCTION TO ALLOW REDESIGN BY THE ENGINEER IF SUCH UTILITIES ARE FOUND TO BE DIFFERENT THAN THOSE SHOWN ON PLANS.

#### III. OBSERVATIONS AND TESTING

- . THE CONTRACTOR SHALL NOTIFY THE ENGINEER OF RECORD AT LEAST 2 BUSINESS DAYS IN ADVANCE OF PERFORMING ALL CIVIL RELATED TESTS. UNLESS AUTHORIZED BY THE ENGINEER OF RECORD. THE CONTRACTOR SHALL NOT PROCEED WITH TESTING UNLESS THE ENGINEER OR A DESIGNATED REPRESENTATIVE IS PRESENT TO
- 2. THE ENGINEER OF RECORD WILL REQUIRE THAT THE FOLLOWING TESTS BE PERFORMED WITH ACCEPTABLE RESULTS: I. SANITARY SEWAGE COLLECTION SYSTEM:

  - INFILTRATION/EXFILTRATION TEST UP TO THE CONNECTING MANHOLE • LAMPING TEST FROM MANHOLE TO MANHOLE, INCLUDING CONNECTING MANHOLE
  - PRESSURE TEST AS REQUIRED BY DRER
- B. STORM DRAINAGE—(EXFILTRATION TRENCH DEPTH) EXFILTRATION TRENCH DEPTH
  - LAMPING TEST FROM MANHOLE TO MANHOLE, INCLUDING CONNECTING MANHOLE (IF APPLICABLE)
- C. DRAINAGE WELL SPECIFIC CAPACITY TEST.
- D. WATER SYSTEM-(PRESSURE TEST AND BACTERIOLOGICAL TEST) E. SUBGRADE - SUBMIT AND HAVE APPROVED DENSITIES PRIOR TO PLACEMENT OF ROCK.
- F. LIME ROCK BASE SUBMIT AND HAVE APPROVED DENSITIES AND AS-BUILTS PRIOR TO THE PLACEMENT OF ANY ASPHALT. (FLAT BOARDING ALSO REQUIRED.) G. ASPHALT PAVEMENT
- H. FINAL WALK-THROUGH INSPECTION IT IS THE RESPONSIBILITY OF THE CONTRACTOR TO CONTACT ALL APPLICABLE REGULATORY AGENCIES FOR INSPECTION REQUIREMENTS. I. CONCRETE FORMWORK AND ADA SLOPE VERIFICATIONS.
- 3. THE CONTRACTOR SHALL NOTIFY THE ENGINEER OF RECORD AT LEAST 2 BUSINESS DAYS IN ADVANCE OF THE FOLLOWING EVENTS:
  - A. PRIOR TO PLACING BALLAST ROCK WITHIN EXFILTRATION TRENCH AND PIPE RUNS TO MEASURE DEPTH AND WIDTH, AS WELL AS DIRECTIONS RESPECTIVELY.
- B. PRIOR TO BACKFILLING WATER MAINS AND SERVICES
- C. PRIOR TO BACKFILLING SANITARY SEWER MAINS AND SERVICES
- D. AFTER COMPACTION OF LIMEROCK BASE AND PRIOR TO PLACEMENT OF FIRST LIFT OF ASPHALT
- E. AFTER 2ND LIFT AND CONCRETE PLACEMENT OF PEDESTRIAN PATHWAYS
- F. INSTALLING CONNECTIONS TO EXISTING WATER AND SEWER MAINS/SERVICES AFTER SECOND LIFT AND CONCRETE PLACEMENT OF PEDESTRIAN PATHWAYS.
- G. AT SUBSTANTIAL COMPLETION
- H. FINAL INSPECTION
- UNLESS AUTHORIZED BY THE ENGINEER OF RECORD, THE CONTRACTOR SHALL NOT PROCEED WITH THESE ACTIVITIES, UNLESS THE ENGINEER OR A DESIGNATED REPRESENTATIVE IS PRESENT TO PERFORM AN INSPECTION.
- 4. SHOULD THE CONTRACTOR FAIL TO GIVE THE ENGINEER OF RECORD ADVANCE NOTICE OF TESTING AND INSPECTIONS AS SPECIFIED ABOVE, THE ENGINEER SHALL RESERVE THE RIGHT TO REFUSE ISSUANCE OF ANY CERTIFICATIONS OF COMPLETION AND FINAL INSPECTIONS, AND RESERVES THE RIGHT TO RECOMMEND THAT ANY CONTRACT AMOUNTS STILL HELD IN RETAINAGE NOT BE RELEASED. CITY INSPECTOR REPORTS SHALL NOT BE ACCEPTED AS A SUBSTITUTE FOR THE ENGINEER'S PRESENCE AT THE TESTING AND INSPECTION INTERVALS SPECIFIED ABOVE.

### IV. SHOP DRAWINGS

- PRIOR TO CONSTRUCTION OR INSTALLATION, SHOP DRAWINGS SHALL BE SUBMITTED TO AND APPROVED BY THE ENGINEER OF RECORD FOR THE FOLLOWING ITEMS:
- A. DRAINAGE STRUCTURES, INCLUDING CATCH BASINS, WELL BOXES, PUMPS, MANHOLES/INLET FRAMES/GRATES.
- BAFFLES, ETC. B. ALL DRAINAGE PIPES.
- . TRENCH DRAINS. ). EXFILTRATION FILTER FABRIC
- ALL WATER AND SEWER SYSTEM COMPONENTS
- ASPHALT PAVEMENT MIX DESIG G LIMEROCK MATERIAL
- H. CONCRETE MIX FOR PAVEMENT MATERIAL SUBSTITUTION REQUESTS
- J. EROSION CONTROL MATERIALS K. FILL MATERIAL
- 2. ALL PRECAST STRUCTURAL DRAWINGS MUST BE SIGNED AND SEALED BY A STATE OF FLORIDA LICENSED ENGINEER OF RECORD STATING THAT THE STRUCTURE(S) MEETS THE H20 LOAD RATING REQUIREMENTS. STRUCTURAL SHOP DRAWINGS WILL BE REJECTED AND NOT REVIÈWED IF NOT SEALED BY A FLORIDA LICENSED ENGINEER.
- IN ADDITION, SOME CITIES, COUNTIES, STATE AND/OR NATIONAL REGULATORY AGENCIES REQUIRE THEIR OWN INDIVIDUAL REVIEW AND APPROVAL. IT IS THE RESPONSIBILITY OF THE CONTRACTOR TO OBTAIN ALL OTHER AGENCY SHOP DRAWING APPROVALS AS REQUIRED.

## V. TEMPORARY FACILITIES

- 1. TEMPORARY FACILITIES
- A. IT SHALL BE THE CONTRACTOR'S RESPONSIBILITY TO ARRANGE FOR OR SUPPLY TEMPORARY WATER SERVICE, SANITARY FACILITIES, AND ELECTRICITY, DURING CONSTRUCTION. B. THE CONTRACTOR SHALL MAINTAIN AT LEAST ONE ACCESS ENTRANCE TO COMMERCIAL PROPERTIES AT ALL
- C. THE CONTRACTOR SHALL MAINTAIN A CLEAR PATH FOR ALL SURFACE WATER DRAINAGE STRUCTURES AND DITCHES DURING ALL PHASES OF CONSTRUCTION, IF APPLICABLE.
- 2. TRAFFIC REGULATION
- A. THE CONTRACTOR SHALL PROVIDE ALL WARNING SIGNALS, SIGNS, LIGHTS AND FLAG PERSONS AS NECESSARY FOR THE MAINTENANCE OF TRAFFIC WITHIN PUBLIC RIGHT-OF-WAYS IN ACCORDANCE WITH THE U.S. DEPARTMENT OF TRANSPORTATION MANUAL OF UNIFORM TRAFFIC CONTROL DEVICES (M.U.T.C.D.), FDOT AND M-DCPWD

DEPARTMENT, AND/OR THE FLORIDA DEPARTMENT OF TRANSPORTATION.

B. ALL OPEN TRENCHES AND HOLES ADJACENT TO ROADWAYS OR WALKWAYS SHALL BE PROPERLY MARKED AND BARRICADED TO ASSURE THE SAFETY OF BOTH VEHICULAR AND PEDESTRIAN TRAFFIC. C. NO TRENCHES OR HOLES NEAR WALKWAYS, IN ROADWAYS OR THEIR SHOULDERS ARE TO BE LEFT OPEN DURING NIGHTTIME HOURS WITHOUT THE EXPRESS PERMISSION OF THE MIAMI-DADE COUNTY PUBLIC WORKS

# VI. PROJECT CLOSE OUT:

- CLEANING UP
- A. DURING CONSTRUCTION, THE PROJECT SITE AND ALL ADJACENT AREAS SHALL BE MAINTAINED IN A NEAT AND CLEAN MANNER AND THE PAVED AREAS SHALL BE SWEPT BROOM CLEAN. UPON FINAL CLEANUP. THE PROJECT SITE SHALL BE LEFT CLEAR OF ALL SURPLUS MATERIAL OR TRASH, AND THE PAVED AREAS SHALL BE BROOMED AND PRESSURE CLEANED.
- B. THE CONTRACTOR SHALL RESTORE OR REPLACE, WHEN AND AS DIRECTED, ANY PUBLIC OR PRIVATE PROPERTY DAMAGED BY HIS/HER WORK, EQUIPMENT AND/OR EMPLOYEES TO A CONDITION AT LEAST EQUAL TO THAT EXISTING IMMEDIATELY PRIOR TO THE BEGINNING OF OPERATIONS.
- C. THE CONTRACTOR SHALL REPLACE ALL PAVING, STABILIZED EARTH, CURBS, DRIVEWAYS, SIDEWALKS, FENCES, MAILBOXES, SIGNS AND ANY OTHER IMPROVEMENTS REMOVED DURING CONSTRUCTION WITH THE SAME TYPE OF MATERIAL AND TO THE CONDITION WHICH EXISTED PRIOR TO THE BEGINNING OF OPERATIONS.
- D. WHERE MATERIAL OR DEBRIS HAVE WASHED OR FLOWED INTO, OR HAVE BEEN PLACED IN WATER COURSES, DITCHES, DRAINS, CATCH BASINS, OR ELSEWHERE AS A RESULT OF THE CONTRACTOR'S OPERATIONS, SUCH MATERIAL OR DEBRIS SHALL BE REMOVED AND SATISFACTORILY DISPOSED OF DURING THE PROGRESS OF THE WORK, AND THE AREA KEPT IN A CLEAN AND NEAT CONDITION.
- E. ALL DISPOSAL OF EXCESS AND UNSUITABLE EXCAVATED MATERIAL, DEMOLITION, VEGETATION, RUBBISH AND DEBRIS SHALL BE MADE OUTSIDE THE LIMITS OF CONSTRUCTION AT A LEGAL DISPOSAL SITE PROVIDED BY THE CONTRACTOR AT HIS/HER OWN EXPENSE, WITH THE PRIOR APPROVAL OF THE ENVIRONMENTAL ENGINEER. MATERIAL CLEARED FROM THE SITE SHALL NOT BE DEPOSITED ON ADJACENT AND/OR NEARBY PROPERTY.

- 2. ALL PROPERTY MONUMENTS OR PERMANENT REFERENCES, REMOVED OR DESTROYED BY THE CONTRACTOR DURING CONSTRUCTION SHALL BE RESTORED BY A STATE OF FLORIDA REGISTERED LAND SURVEYOR AT THE CONTRACTOR'S FXPFNSF.
- 3. PROJECT RECORD DOCUMENTS
  - A. DURING THE DAILY PROGRESS OF THE JOB, THE CONTRACTOR SHALL RECORD ON HIS SET OF CONSTRUCTION DRAWINGS THE EXACT LOCATION, LENGTH AND ELEVATION OF ANY FACILITY NOT BUILT EXACTLY ACCORDING TO
  - B. THE CONTRACTOR SHALL PROVIDE THE ENGINEER WITH AS-BUILT GRADES AND LOCATIONS OF FINISHED PAVEMENT, SIDEWALKS, CURBS, AND ALL PHYSICAL IMPROVEMENTS. SUCH GRADES SHALL BE OBTAINED BY A LICENSED SURVEYOR REGISTERED TO PRACTICE IN THE STATE OF FLORIDA, AND SHALL DOCUMENT THE INTENT OF THE PROPOSED GRADES SHOWN ON THE PLANS. THIS SHALL BE DONE AT NO COST TO THE OWNER.
- 4. CONTRACTOR TO REPLACE ALL FOUND PIPES WITH NAIL AND DISKS.

#### VII. STORM DRAINAGE

350

- GENERAL
- A. CATCH BASIN GRATES AND MANHOLE RIM ELEVATIONS AS SHOWN ON PLANS SHALL BE ADJUSTED TO CONFORM TO NEW OR EXISTING GRADES, AS REQUIRED.
- B. ALL ONSITE STORM DRAINAGE MATERIALS AND INSTALLATION SHALL CONFORM TO THE APPLICABLE M-DCPWD AND FDOT SPECIFICATIONS INCLUDING, BUT NOT LIMITED TO, THE FOLLOWING:
  - EXCAVATION, TRENCHING AND BACKFILLING FOR PIPE STRUCTURES
  - DRAINAGE PIPE 340 STORM SEWER MANHOLES
  - CATCH BASINS
  - 355 INLETS SEEPAGE DRAIN (EXFILTRATION DRAIN) 360
- 2. ALL EXFILTRATION TRENCH SHALL BE AS PER STANDARD DETAIL SD 1.1 OF THE MDCPWD MANUAL , AND INSTALLED AT THE WIDTH. DEPTH AND ELEVATION SHOWN ON THE APPROVED CROSS SECTION DEPICTED IN THE DETAILS SHEET. ANY CONFLICT WITH EXISTING OR PROPOSED UTILITIES SHALL IMMEDIATELY BE BROUGHT TO THE ATTENTION OF THE ENGINEER. ANY IMPERMEABLE MATERIAL ENCOUNTERED IN THE EXCAVATION FOR THE EXFILTRATION TRENCH SHALL BE REMOVED AS DIRECTED BY THE ENGINEER.
- 3. ALL DRAINAGE CATCH BASINS AND STRUCTURES SHALL BE PRECAST CONCRETE AS MANUFACTURED BY U.S. PRECAST CORPORATION OR APPROVED EQUAL.
- 4. ALL DRAINAGE CATCH BASIN FRAMES AND GRATES, AND STORM DRAINAGE MANHOLE RIMS SHALL BE AS MANUFACTURED BY U.S. FOUNDRY OR APPROVED EQUAL.
- 5. THE TRENCH FILTER FABRIC SHALL BE SELECTED FROM THE MANUFACTURERS AND FABRIC TYPES APPROVED BY M-DCPWD . IT SHALL BE USED TO WRAP ALL SIDES, BOTTOM AND TOP OF THE EXFILTRATION TRENCH. THE TOP SECTION OF THE MATERIAL SHALL BE LAPPED A MINIMUM OF 12 INCHES AND THE CONTRACTOR SHALL TAKE EXTREME CARE IN BACKFILLING TO AVOID BUNCHING OF THE FABRIC.
- 6. SOLID AND PERFORATED STORM DRAINAGE PIPE SHALL BE CORRUGATED METAL PIPE (C.M.P.) OR HIGH DENSITY POLYETHYLENE PIPE (H.D.P.E.) SELECTED FROM THE MANUFACTURES AND TYPES APPROVED BY M-DCPWD PERFORATED PIPE SHALL TERMINATE 4'-0" FROM THE DRAINAGE STRUCTURE. THE REMAINING 4'-0" SHALL BE NON-PERFORATED PIPE.
- 7. PROVIDE A MINIMUM PROTECTIVE COVER OF 24 INCHES OVER STORM SEWER AND AVOID UNNECESSARY CROSSING BY HEAVY CONSTRUCTION VEHICLES DURING CONSTRUCTION.
- 8. THE CONTRACTOR SHALL PROTECT COMPLETED DRAINAGE STRUCTURES AND EXFILTRATION TRENCH SYSTEMS FROM CONTAMINATION OF SILT AND CONSTRUCTION DEBRIS. PLACE PLYWOOD ON, OR FILTER FABRIC BETWEEN, THE FRAME AND INLET GRATE UNTIL CONSTRUCTION OPERATIONS ARE FINISHED.

### VIII. PAVING

- - A. ALL UNDERGROUND UTILITIES SHALL BE COMPLETED PRIOR TO CONSTRUCTION OF LIMEROCK BASE.
  - C. ALL EXISTING PAVEMENT, CUT OR DAMAGED BY CONSTRUCTION SHALL BE PROPERLY RESTORED AT THE CONTRACTOR'S EXPENSE.
  - D. WHERE ANY PROPOSED PAVEMENT IS TO BE CONNECTED TO EXISTING PAVEMENT, THE EXISTING EDGE OF PAVEMENT SHALL BE SAW CUT.
  - E. PROPOSED ASPHALT PAVEMENT SHALL BE CONNECTED TO EXISTING AS PER FDOT AND MIAMI-DADE COUNTY STANDARD DETAILS. CONTRACTOR SHALL MATCH EXISTING ELEVATIONS ON NEW SIDEWALK OR NEW
  - PAVEMENT. F. CONTRACTOR SHALL REMOVE AND DISPOSE OF THE EXISTING CONC. CURB, CURB & GUTTER, SIDEWALK AND ASPHALT WHERE NEW SIDEWALK. CURB & GUTTER AND MEDIAN IS PROPOSED TO BE CONSTRUCTED
- G. NONE OF THE EXISTING LIMEROCK BASE THAT IS REMOVED IS TO BE INCORPORATED INTO THE PROPOSED
- 2. MATERIALS AND INSTALLATION A. ALL ON SITE WORK AND MATERIALS SHALL BE IN ACCORDANCE WITH PART 2 OF THE M-DCPWD MANUAL
  - INCLUDING, BUT NOT LIMITED TO THE FOLLOWING: EXCAVATION AND EMBANKMENT
    - STABILIZATION LIMEROCK BASE
    - PRIME AND TACK COATS 145 CONCRETE SIDEWALK SPECIFICATIONS

ROAD AND BRIDGE CONSTRUCTION INDEX #711-001, WHERE SHOWN ON THE PLANS.

- B. SUBGRADE FOR DRIVEWAYS AND PARKING AREAS SHALL BE COMPACTED TO A MINIMUM OF 95% OF THE MAXIMUM DENSITY PER AASHTO SPECIFICATION T-180-74. THE MINIMUM COMPACTED THICKNESS OF THE STABILIZED SUBGRADE SHALL BE 12".
- C. THE MINIMUM COMPACTED THICKNESS OF THE LIMEROCK BASE SHALL BE 6" AND PLACED IN TWO EQUAL LIFTS. LIMEROCK BASE SHALL BE PRIMED AND COMPACTED TO 98% PER A.A.S.H.T.O. T-180-74.
- VII. DENSITY TESTS SHALL BE TAKEN BY AN INDEPENDENT TESTING LABORATORY, CERTIFIED BY THE STATE OF FLORIDA. WHERE DIRECTED BY THE MDCPWD INSPECTOR OR THE GEOTECHNICAL ENGINEER

# IX. PAVEMENT MARKINGS AND TRAFFIC SIGNS

- 1. PAVEMENT MARKINGS A. INSTALLATION: ALL PAVEMENT MARKINGS SHALL BE MADE IN ACCORDANCE WITH FDOT STANDARD PLANS FOR
- (1) WHERE THE PLANS CALL FOR PAINTED PAVEMENT MARKINGS (P), INSTALLATION AND MATERIALS SHALL MEET ÀLL REQUIREMENTS OF SECTION 710 OF FDOT STANDARD SPECIFICATIONS FOR ROAD AND BRIDGE CONSTRUCTION
- AND THE FOLLOWING, CONTRACTOR TO APPLY TWO COATS OF VOC COMPLIANT, LOCAL DOT APPROVED, UNDILUTED, SOLVENT BASED OR LATEX TRAFFIC PAINT. CONTRACTOR TO FOLLOW MANUFACTURER'S RECOMMENDED APPLICATION RATE, WITHOUT ADDITION OF A THINNER, WITH A MAXIMUM OF 100 SQUARE FEET PER GALLON OR AS REQUIRED PROVIDING MINIMUM 15 MILS WET FILM THICKNESS AND 71/2 MILS DRY FILM THICKNESS PER COAT WITH MINIMUM OF 30 DAYS BETWEEN APPLICATIONS. SECOND COAT OF PAINT SHALL NOT BE APPLIED EARLIER THAN 7 DAYS PRIOR TO GRAND OPENING. PAINT SHALL BE CRISP, STRAIGHT AND APPLIED UNIFORMLY ACROSS THE WIDTH OF THE LINE FOR A TOTAL DRY FILM THICKNESS OF 15 MILS
- (2) ALL PAVEMENT SYMBOLS AND MARKINGS TO BE THERMOPLASTIC WITH THE EXCEPTION OF PARKING STRIPING. WHERE THE PLANS CALL FOR THERMOPLASTIC PAVEMENT MARKINGS. INSTALLATION AND MATERIALS SHALL MEET ALL REQUIREMENTS OF SECTION 711 OF FDOT STANDARD SPECIFICATIONS FOR ROAD AND BRIDGE CONSTRUCTION.
- C. PROTECTION: THE CONTRACTOR SHALL NOT ALLOW TRAFFIC ONTO NEWLY APPLIED PAVEMENT STRIPING/MARKINGS UNTIL THEY ARE SUFFICIENTLY DRY TO PERMIT VEHICLES TO CROSS THEM WITHOUT DAMAGE. THE CONTRACTOR SHALL, AT HIS OWN EXPENSE, REMOVE AND REPLACE ANY PORTION OF THE PAVEMENT STRIPING/MARKINGS DAMAGED BY PASSING TRAFFIC OR FROM ANY OTHER CAUSE.
- A. INSTALLATION: TRAFFIC SIGNS SHALL BE INSTALLED IN ACCORDANCE WITH THE M.U.T.C.D. (LATEST EDITION) IN LOCATIONS SHOWN ON PLANS.
- B. MATERIALS: FOLLOW SECTION NO. 700, HIGHWAY SIGNING, OF THE FDOT STANDARD SPECIFICATIONS FOR ROAD AND BRIDGE CONSTRUCTION, AND M.U.T.C.D.



Store:

Raising Cane's 8070 NW 36th Stree

Designer's Information:



95 Merrick Way, 3rd floor

Coral Gables, Florida 33134

Telephone: 469-498-2100 www.csrsinc.com

Prototype Phase: 2021-1.0 (05-07-2021) 10-30-2021 Project Issue Date:

CSRS Project Manager

**ENTITLEMENTS** 

11-19-2021

355 ALHAMBRA CIRCLE, SUITE 1400, CORAL GABLES, FL 33134 PHONE: 305-673-2025 WWW.KIMLEY-HORN.COM REGISTRY NO. 696 STATE OF

DATE: 2/16/2022 JUAN PABLO GONZALEZ PENA, P.E. ON THE DATE
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GENERAL NOTES

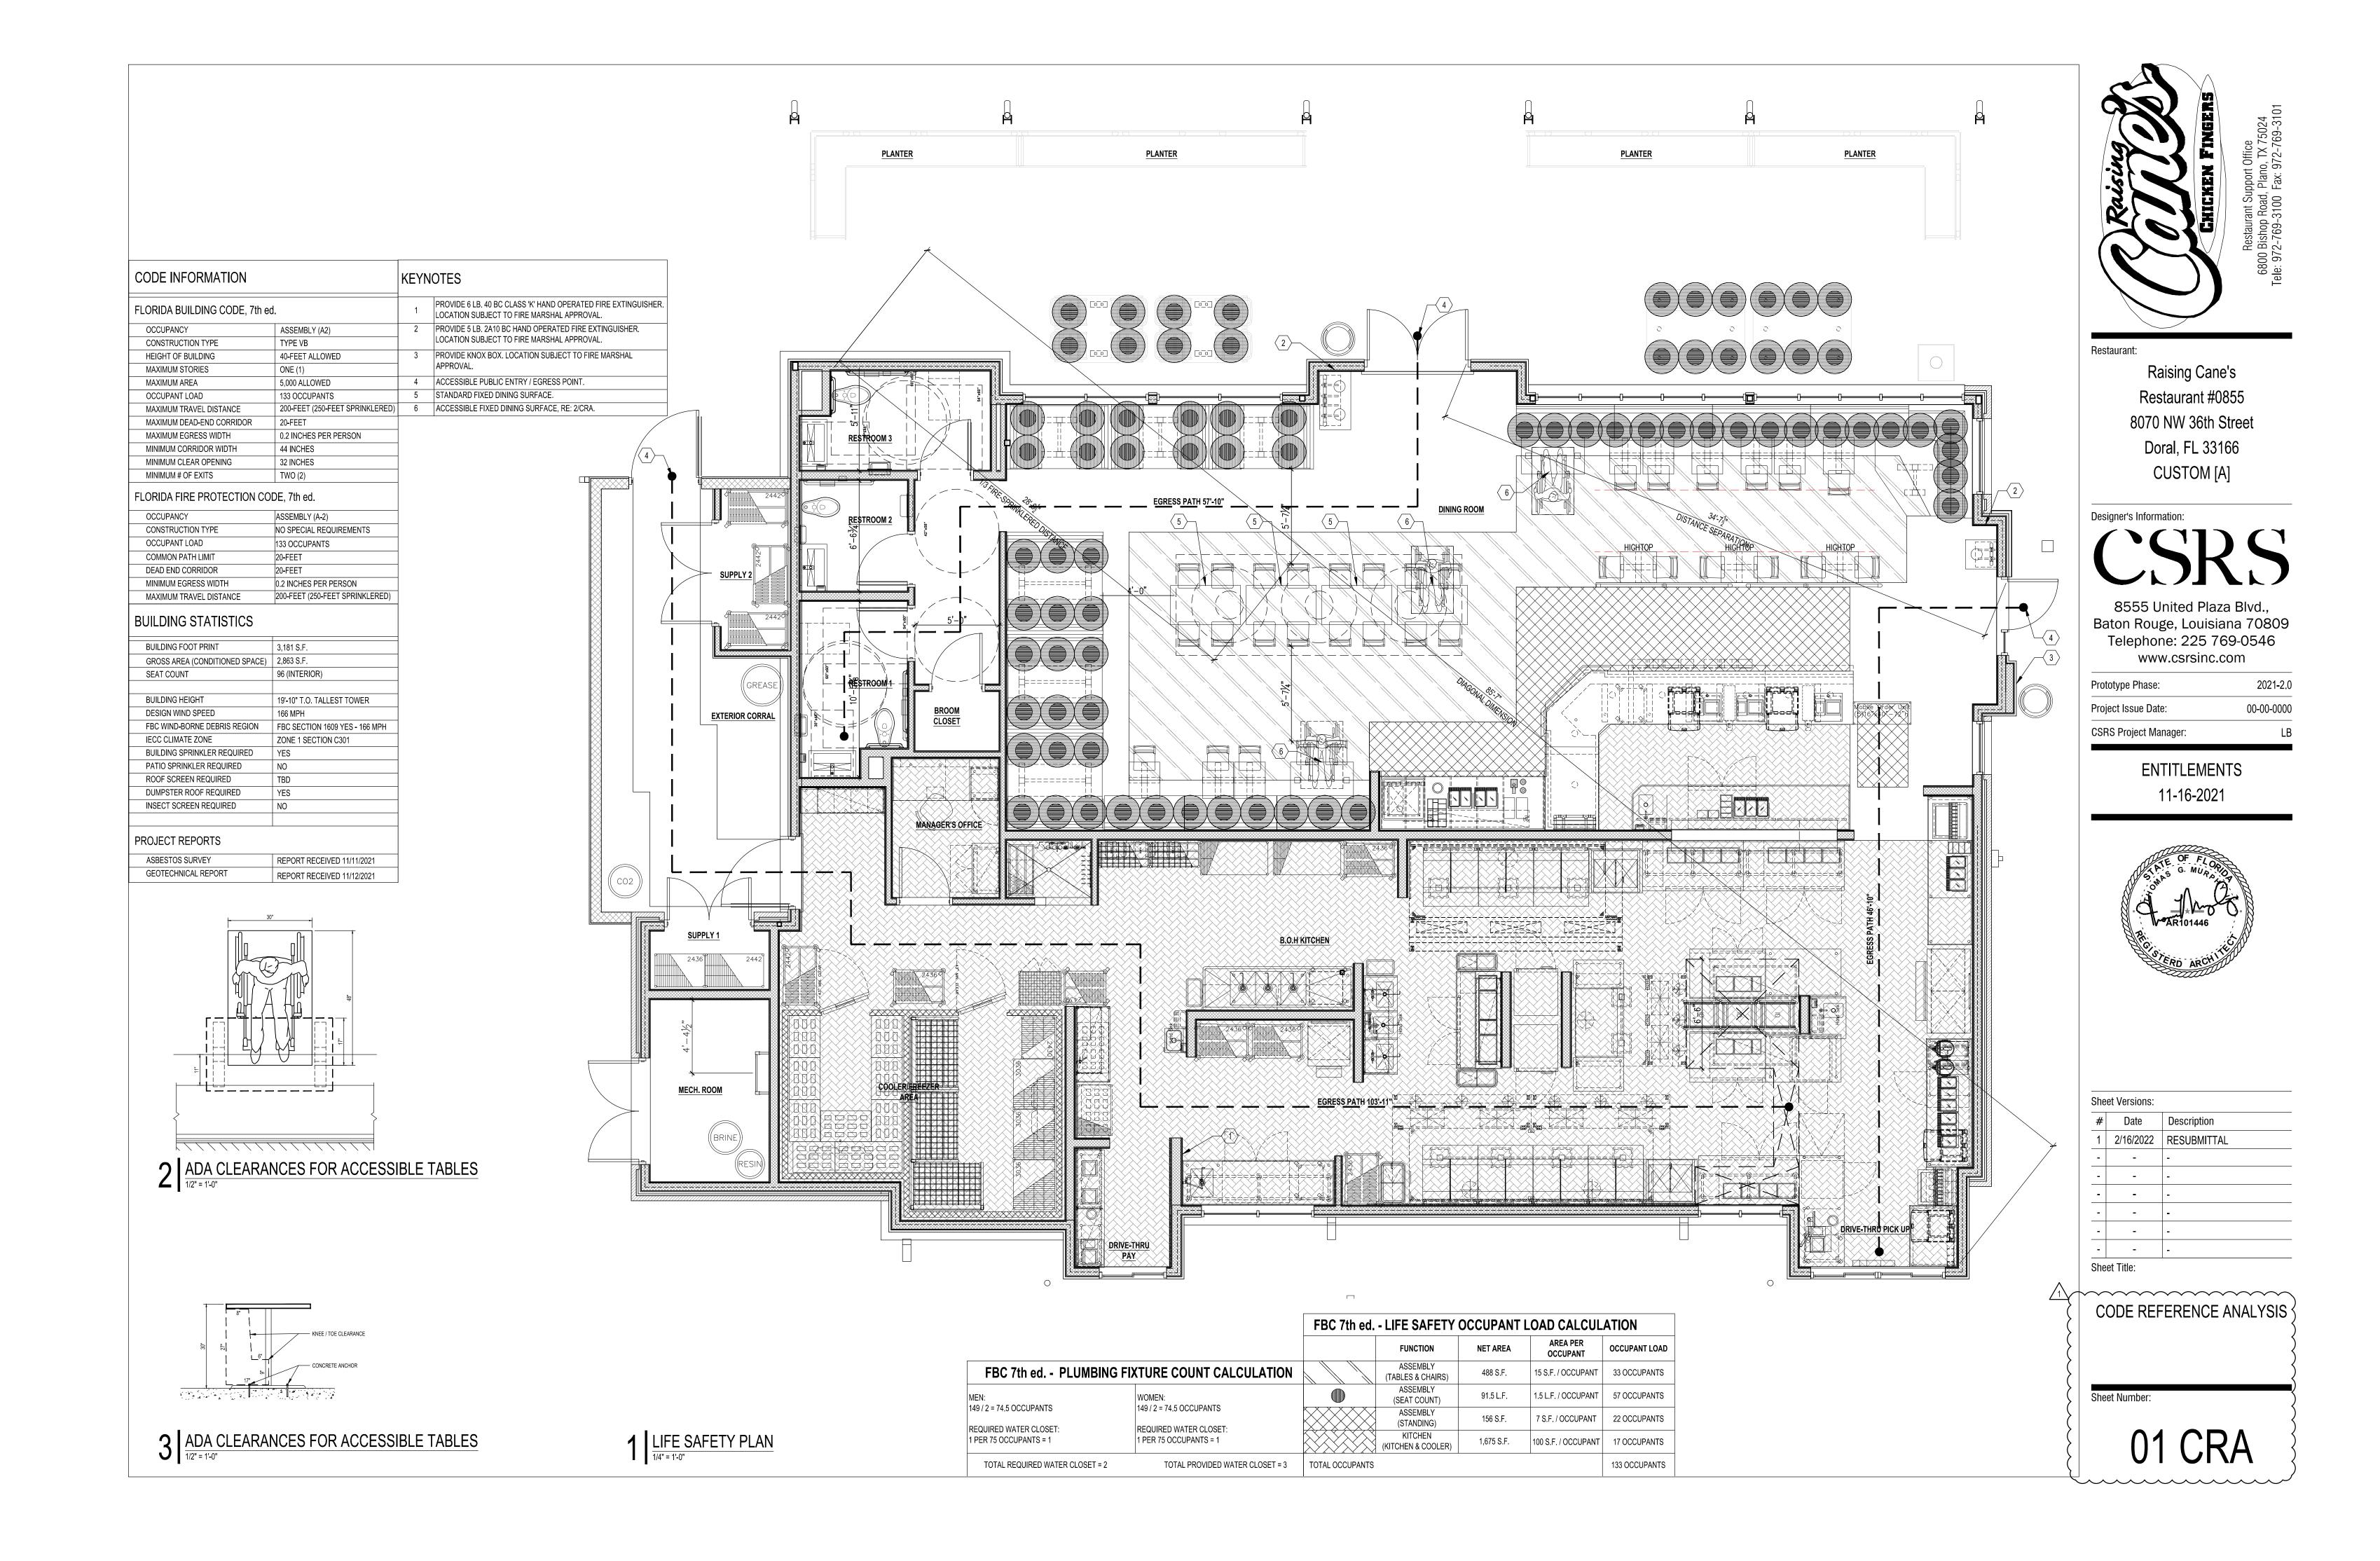
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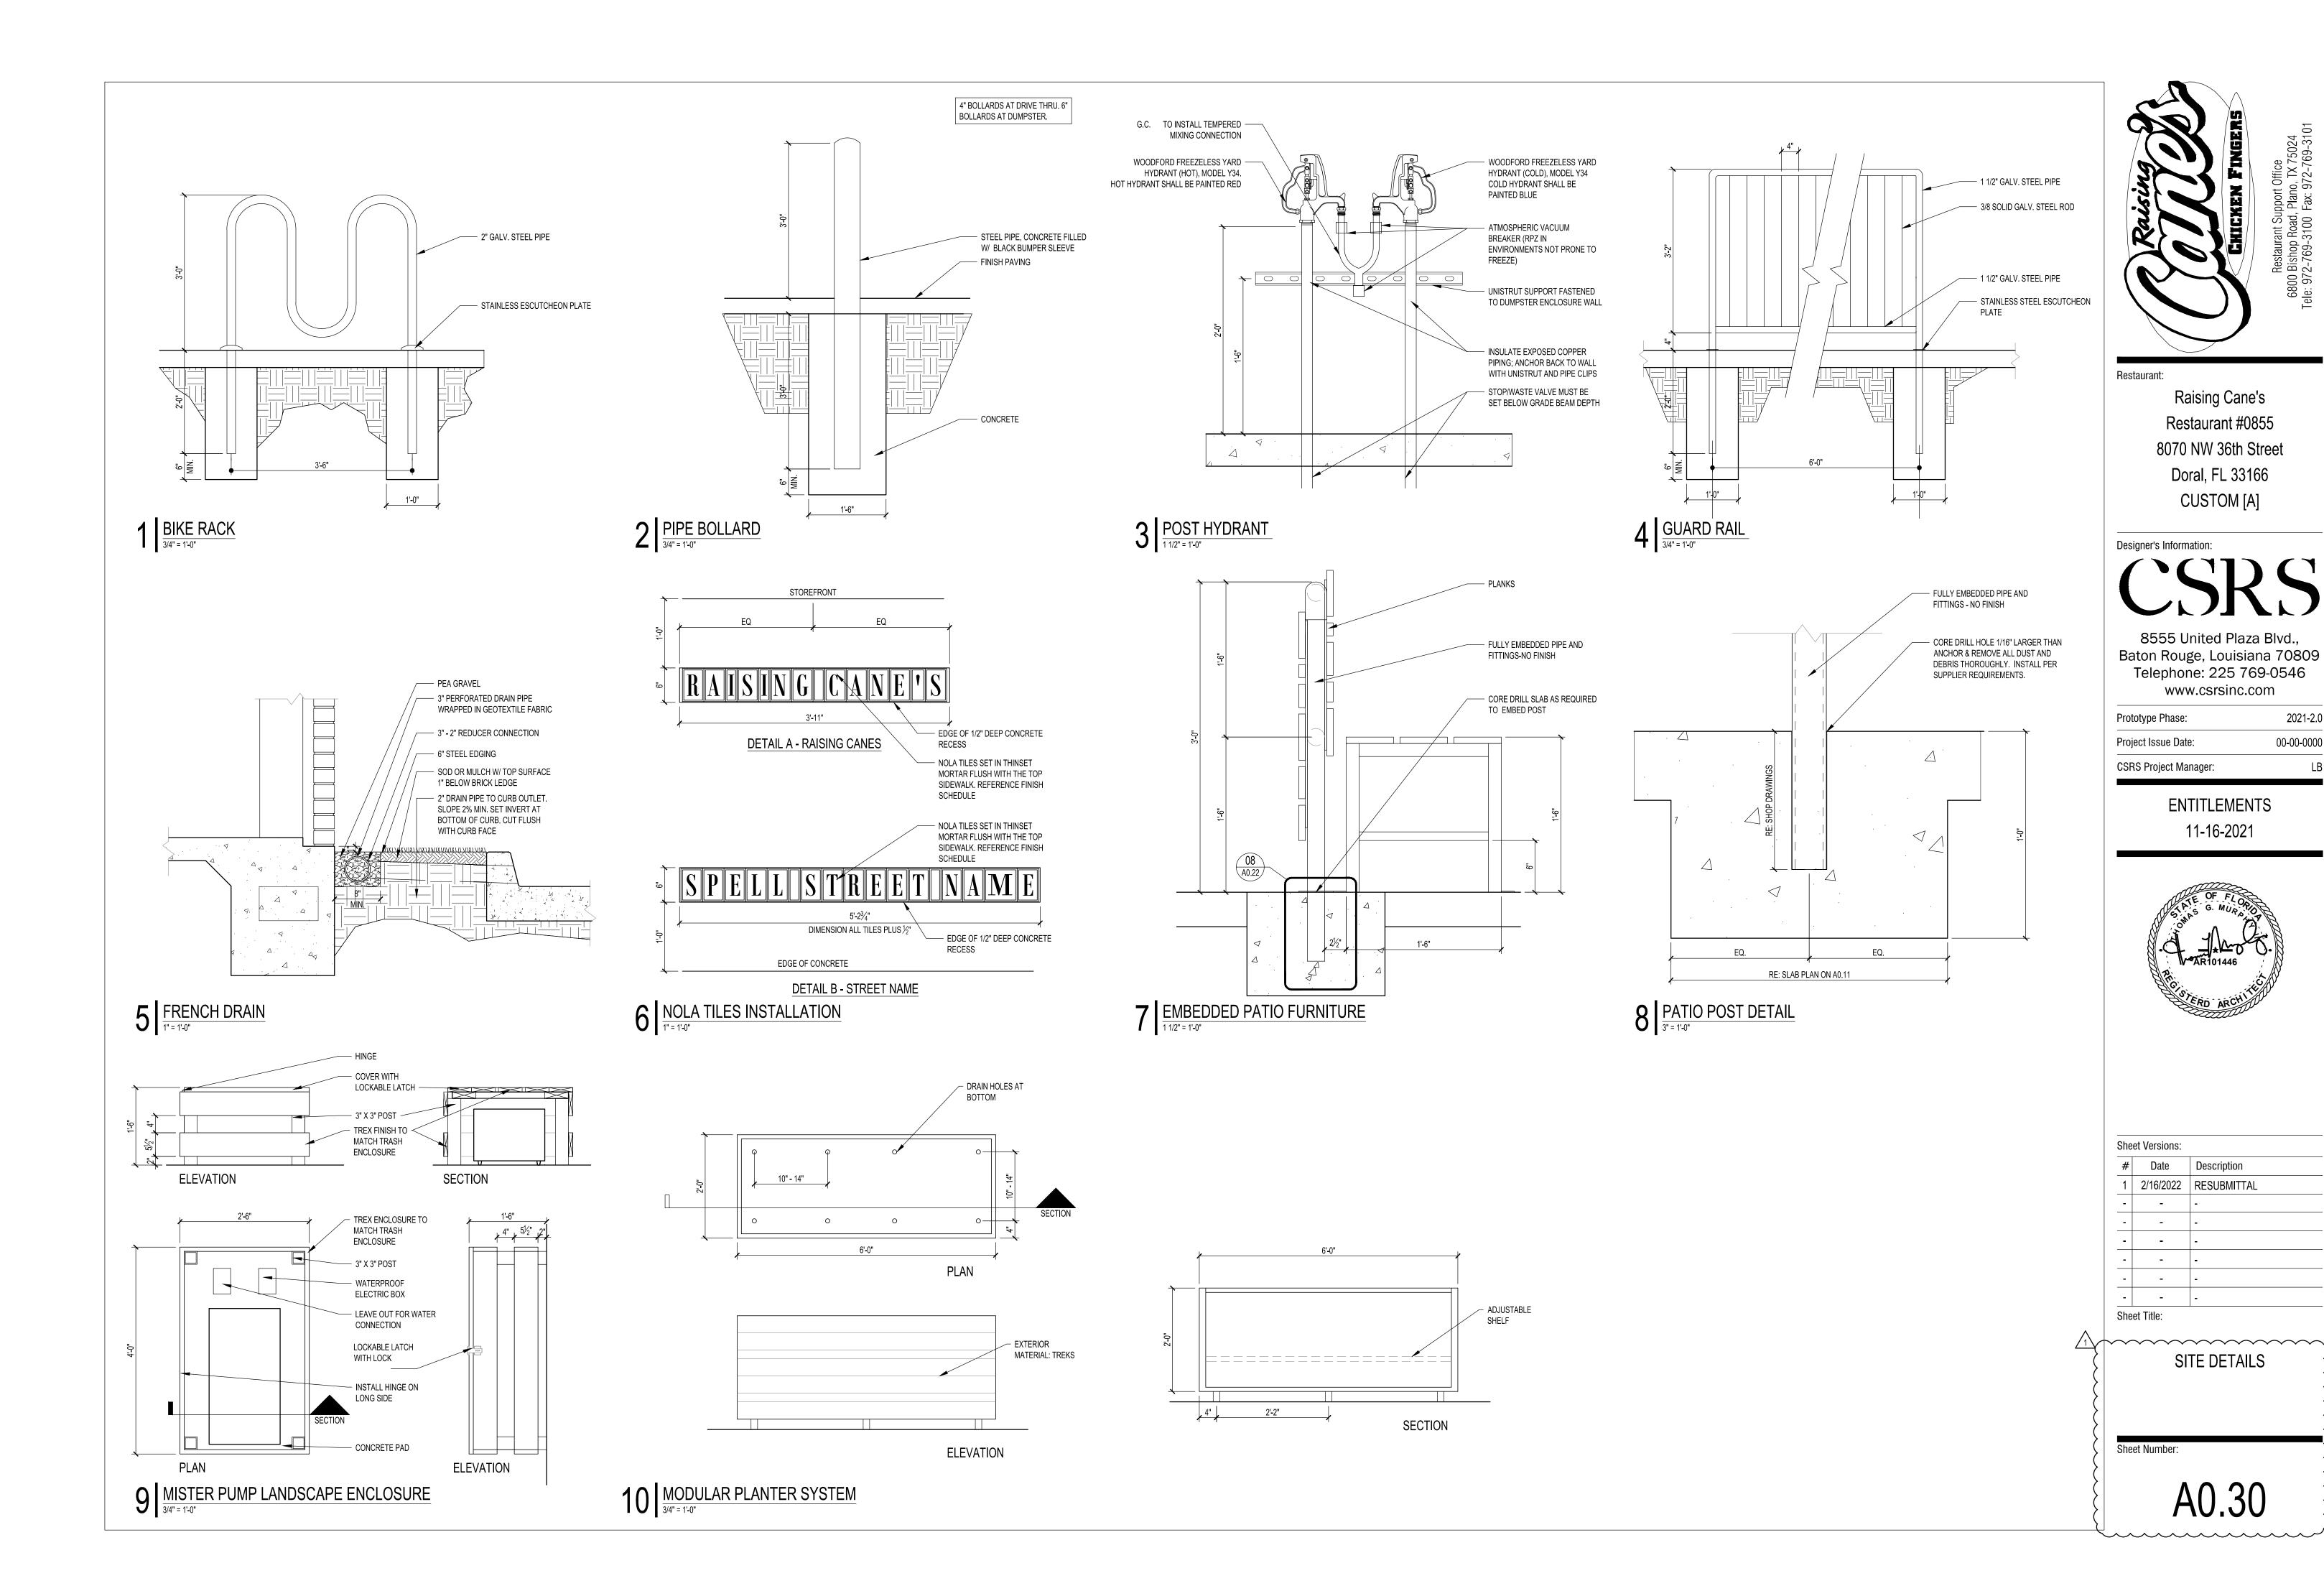
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CAUTION!! CONTRACTOR IS TO VERIFY PRESENCE AND EXACT LOCATION OF ALL UTILITIES PRIOR TO CONSTRUCTION.

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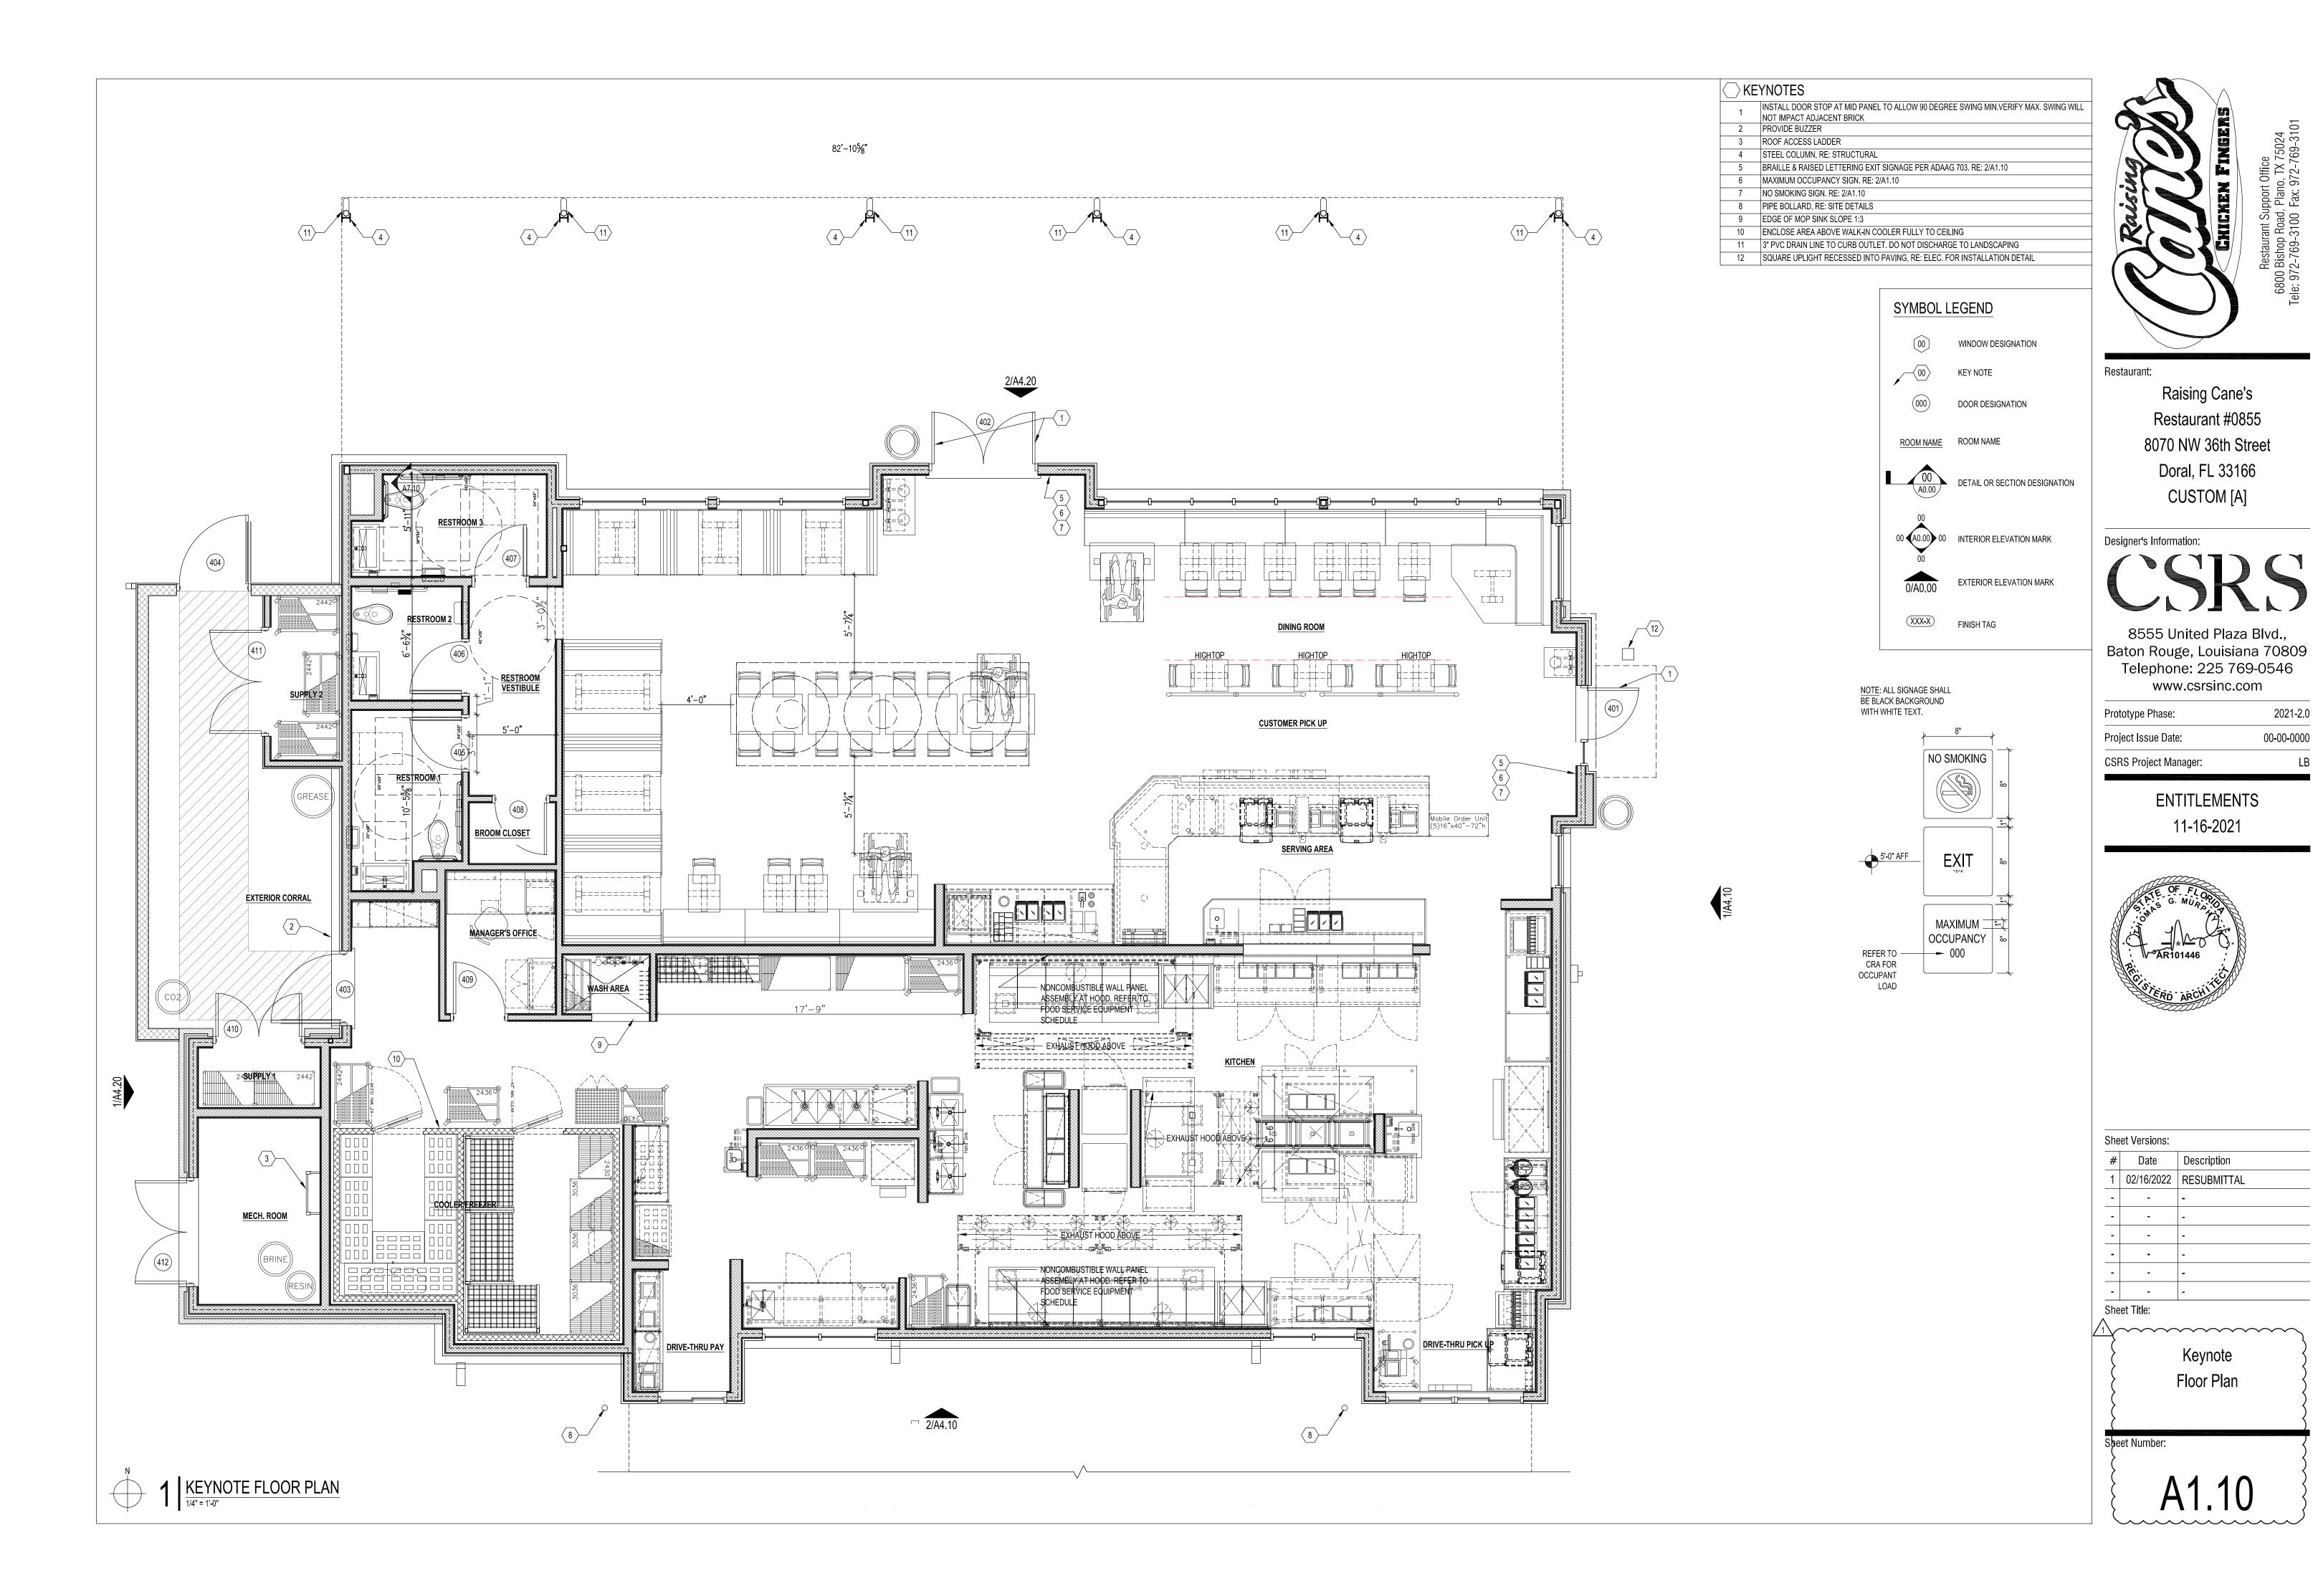
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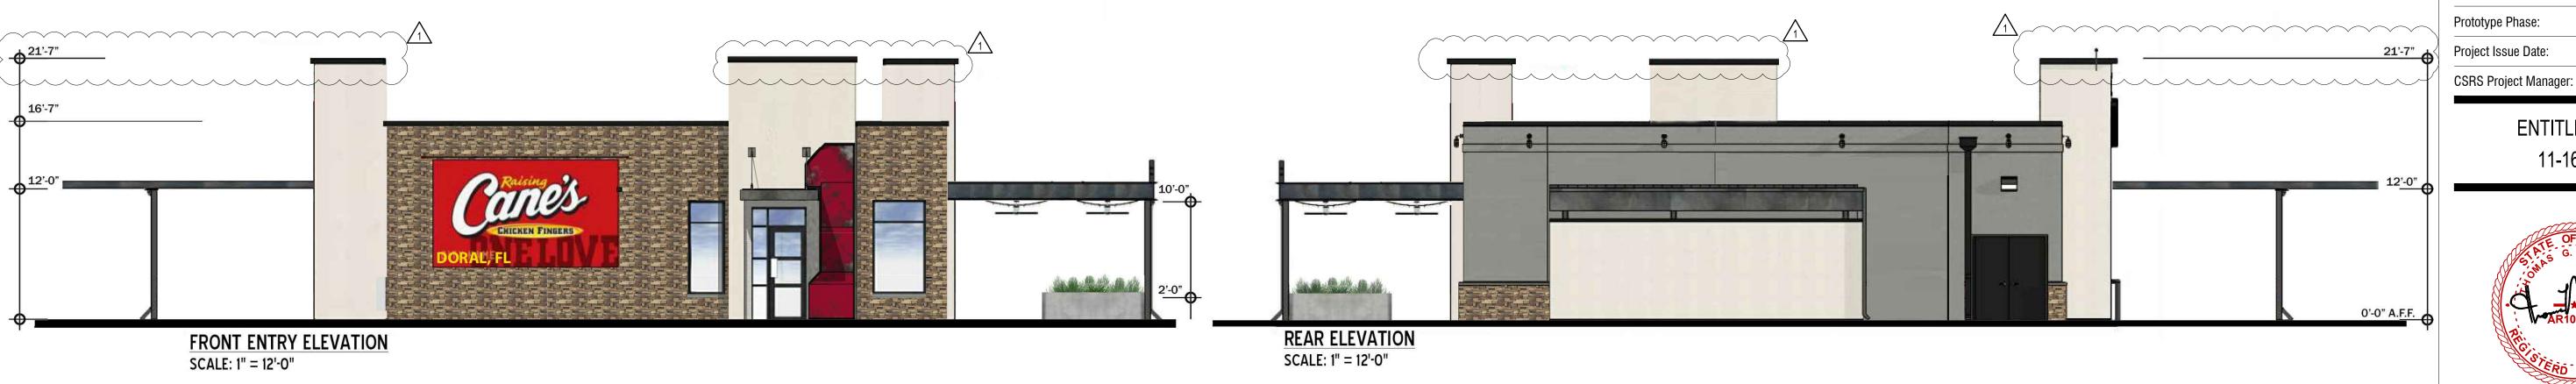


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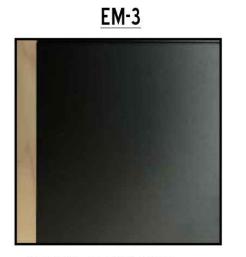
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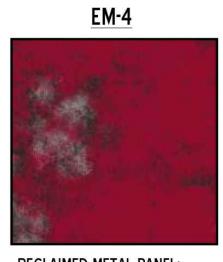
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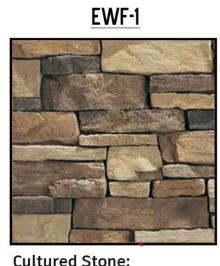
# **MATERIAL FINISHES**




POWDER COATED STEEL, MATTE BLACK FINISH




RECLAIMED METAL PANEL: VINTAGE CAR HOOD OCCURS AT FACE OF THE "1" ELEMENT ONLY



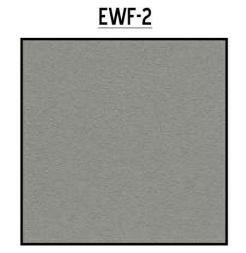
Cultured Stone: El Dorado Stone-Mountain Ledge, Durango



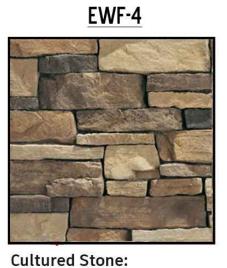
"SW 7669 SUMMIT GRAY" PORTLAND CEMENT STUCCO



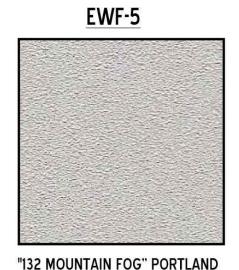**Cultured Stone:** El Dorado Stone-Mountain Ledge, Durango



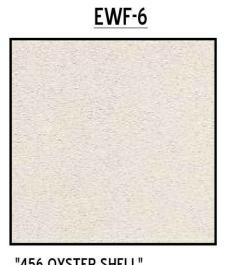"132 MOUNTAIN FOG" PORTLAND CEMENT STUCCO




"456 OYSTER SHELL" CEMENT STUCCO



ALUMINUM STOREFRONT SYSTEM FINISH: ANODIZED BLACK

COLOR RENDERINGS

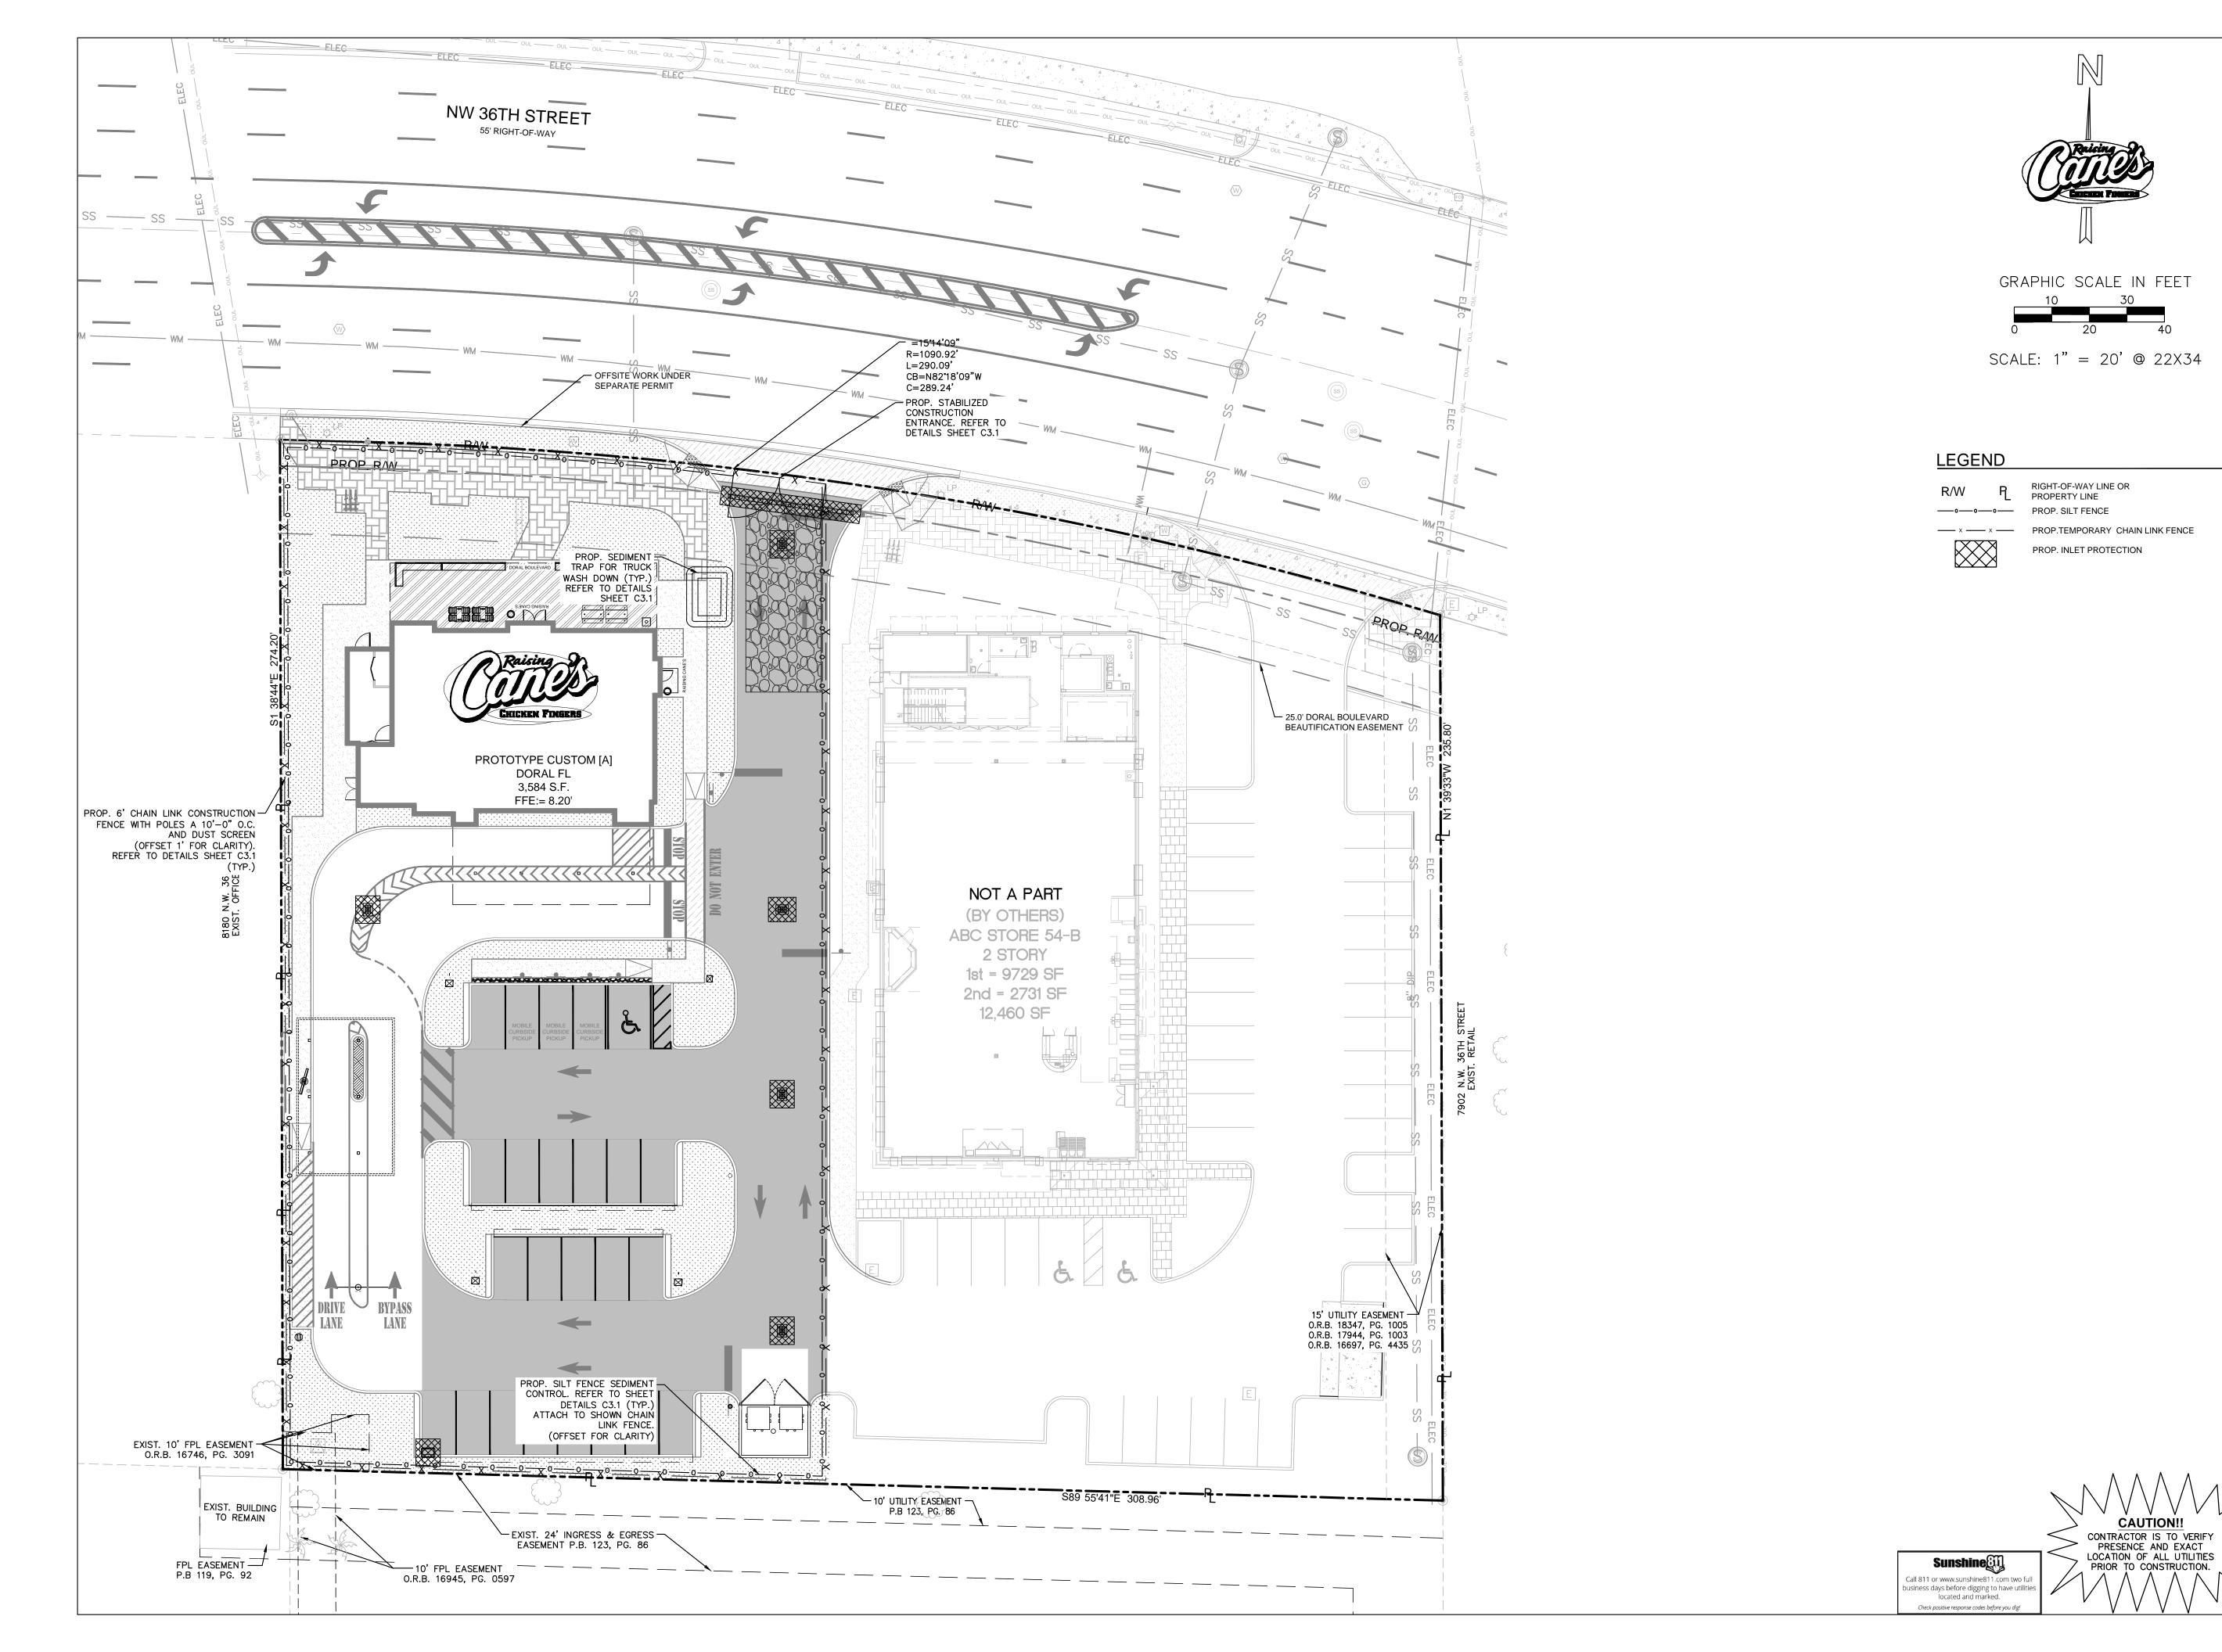Sheet Number:





Store:

Raising Cane's
Restaurant #0855
8070 NW 36th Street
Doral, FL 33166
CUSTOM [A]

Designer's Information:

# CSRS

95 Merrick Way, 3rd floor

Coral Gables, Florida 33134 Telephone: 469-498-2100 www.csrsinc.com

| ototype Phase:    | 2021-1.0 (05-07-2021) |
|-------------------|-----------------------|
| oject Issue Date: | 10-30-2021            |

CSRS Project Manager:

ENTITLEMENTS 11-19-2021

# **Kimley** » Horn

355 ALHAMBRA CIRCLE, SUITE 1400, CORAL GABLES, FL 33134
PHONE: 305–673–2025
WWW.KIMLEY-HORN.COM REGISTRY NO. 696

NO. 92190

STATE OF

ORIDA

DATE: 2/16/2022

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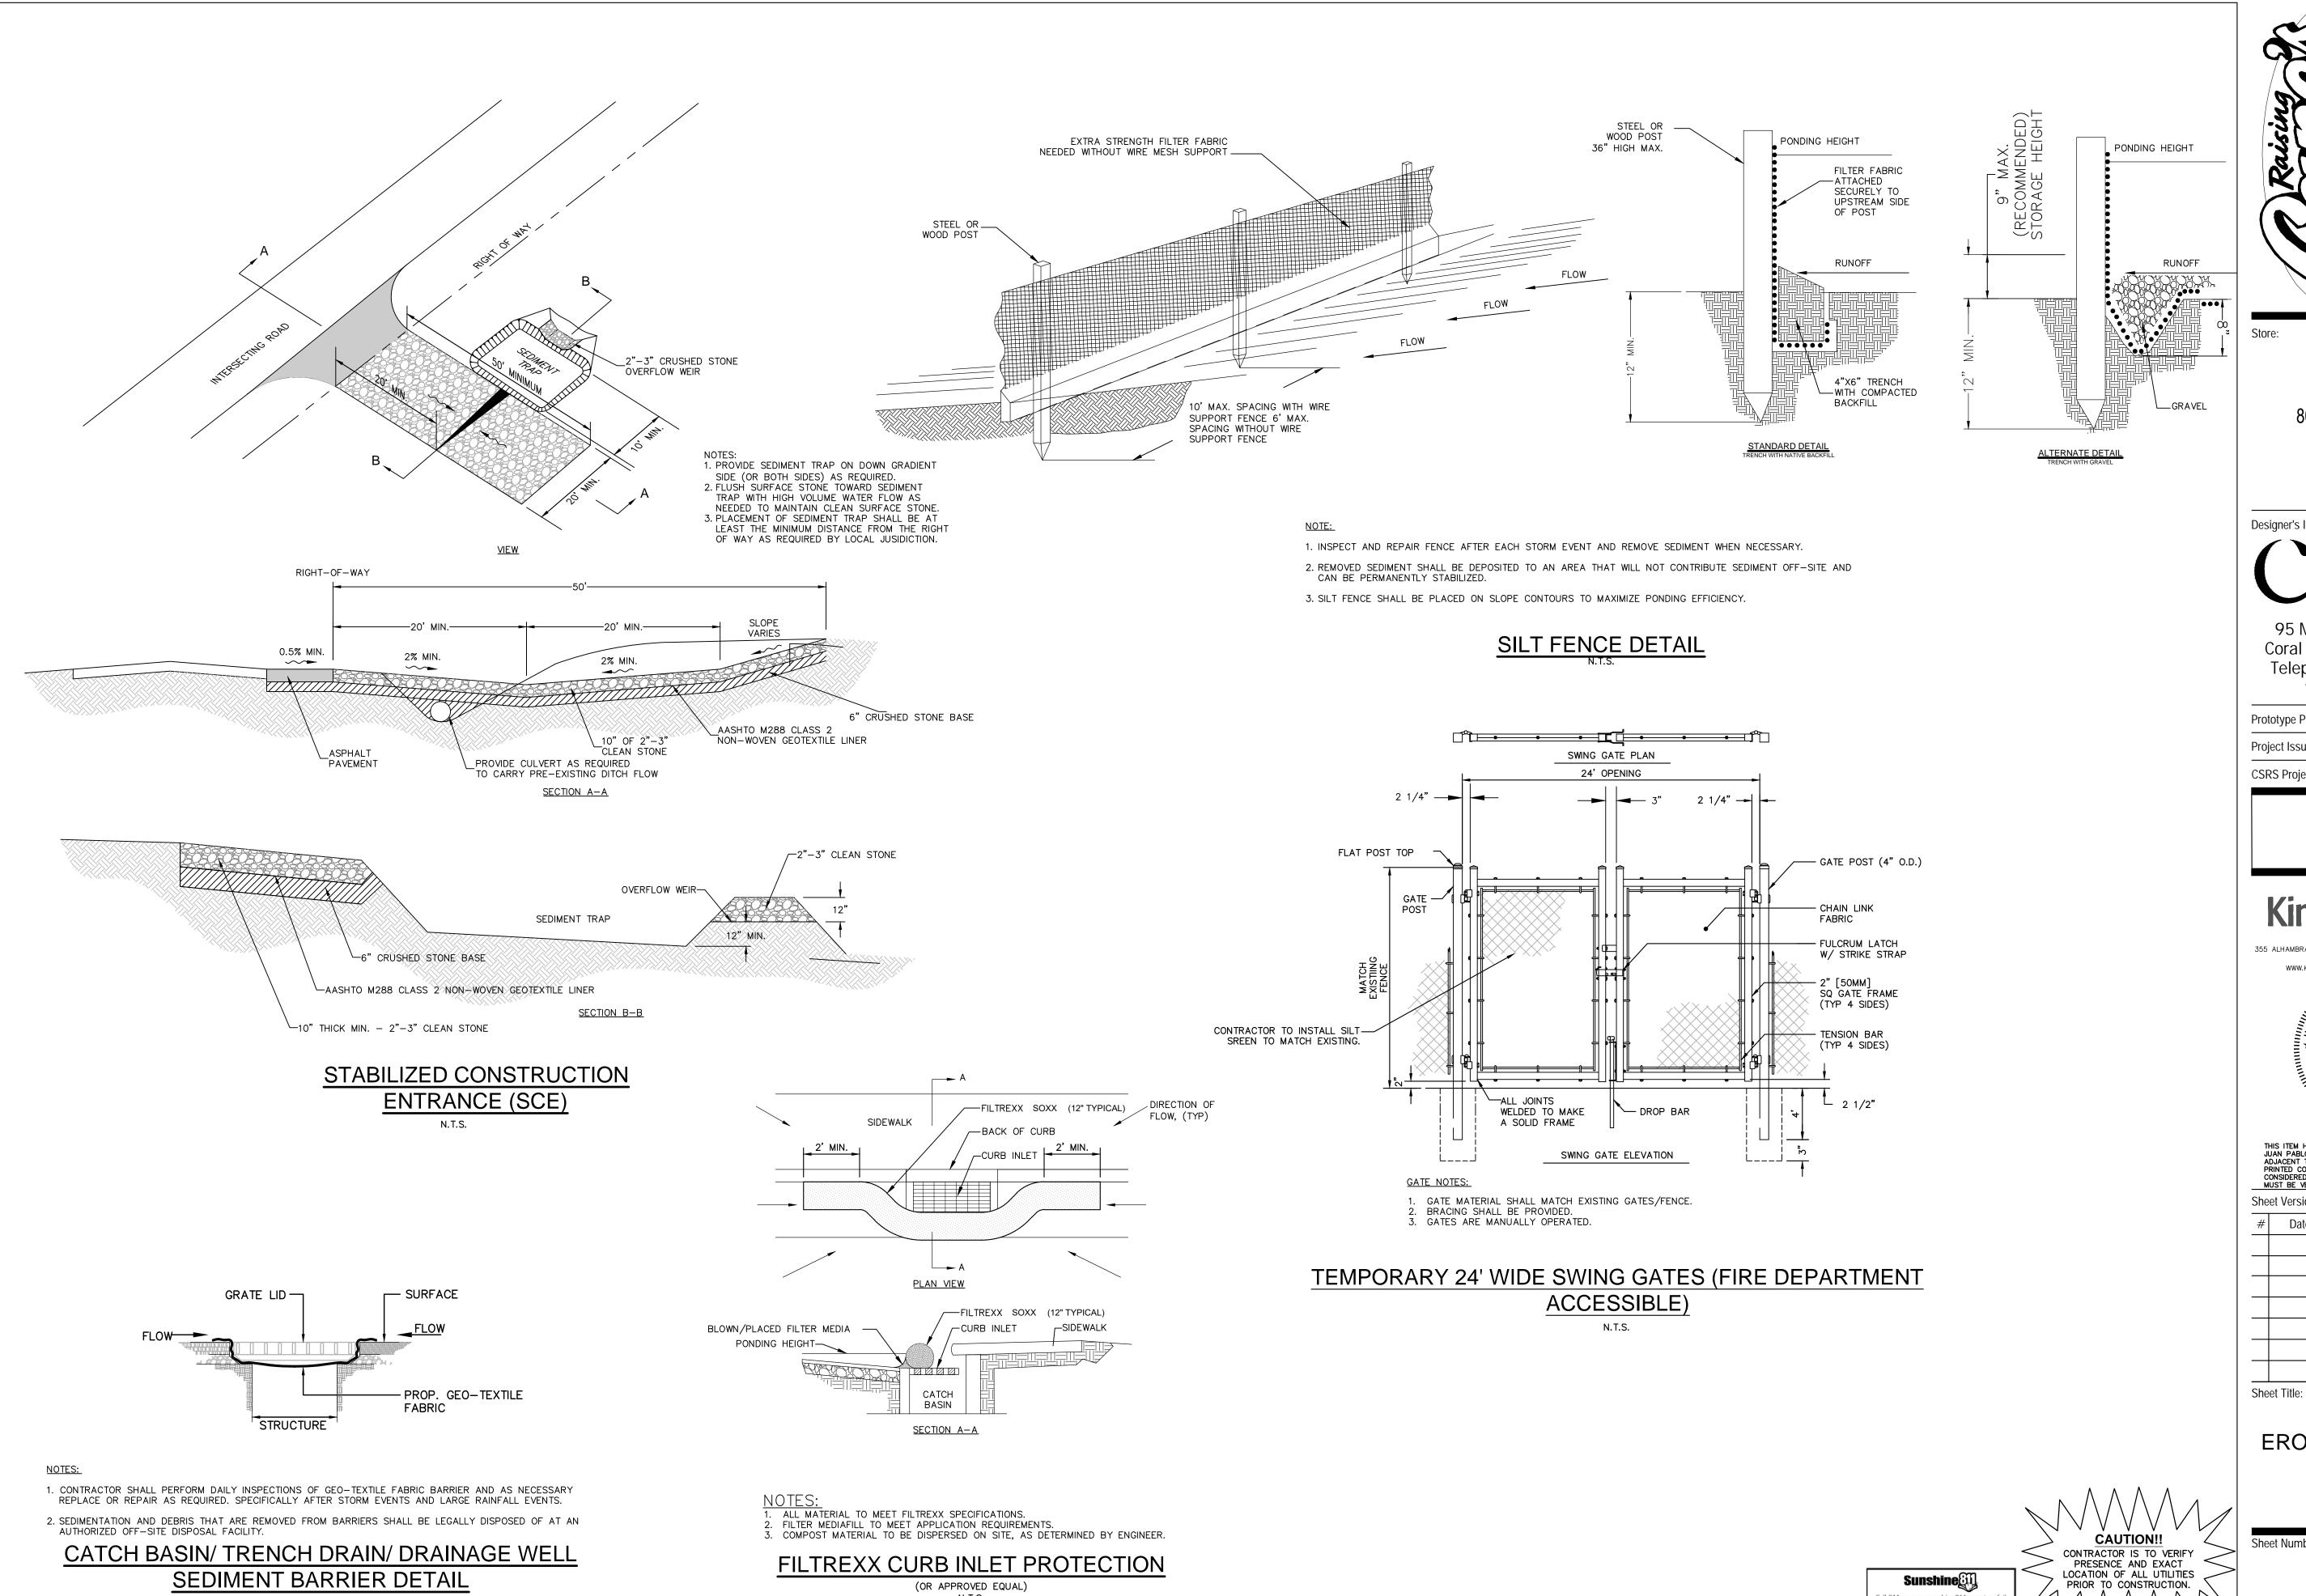
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EROSION CONTROL PLAN

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Raising Cane's Restaurant #0855 8070 NW 36th Street Doral, FL 33166

Designer's Information:

95 Merrick Way, 3rd floor

CUSTOM [A]

Coral Gables, Florida 33134 Telephone: 469-498-2100 www.csrsinc.com

2021-1.0 (05-07-2021) Prototype Phase: 10-30-2021 Project Issue Date: CSRS Project Manager:

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**EROSION CONTROL DETAILS** 

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C3.1

# **EROSION CONTROL NOTES AND SPECIFICATIONS:**

#### I. BEST MANAGEMENT PRACTICES (BMPS):

THIS PLAN HAS BEEN PREPARED TO ENSURE COMPLIANCE WITH APPROPRIATE CONDITIONS OF THE MIAMI-DADE COUNTY LAND DEVELOPMENT REGULATIONS, THE RULES OF THE FLORIDA DEPARTMENT OF ENVIRONMENTAL PROTECTION (FDEP), CHAPTER 17-25, F.A.C., THE SOUTH FLORIDA WATER MANAGEMENT DISTRICT (SFWMD), CHAPTER 40D-4, F.A.C. AND THE UNITED STATES ENVIRONMENTAL PROTECTION AGENCY (EPA) DOCUMENT NO. EPA 832/R-92-005 (SEPTEMBER 1992). THE PLAN ADDRESSES THE FOLLOWING:

- 1. PREVENT LOSS OF SOIL DURING CONSTRUCTION BY STORMWATER RUNOFF AND/OR WIND EROSION, INCLUDING PROTECTING TOPSOIL BY STOCKPILING FOR REUSE.
- 2. SEDIMENTATION PROTECTION OF STORM SEWER OR RECEIVING STREAM.
- 3. PREVENT POLLUTING THE AIR WITH DUST AND PARTICULATE MATTER. THE VARIOUS TECHNIQUES OR ACTIONS IDENTIFIED UNDER EACH SECTION INDICATE THE APPROPRIATE SITUATION WHEN THE TECHNIQUES SHOULD BE EMPLOYED. ALSO IDENTIFIED IS A CROSS-REFERENCE TO A DIAGRAM OR FIGURE REPRESENTING THE TECHNIQUE. IT SHOULD BE NOTED THAT THE MEASURES IDENTIFIED ON THIS PLAN ARE ONLY SUGGESTED BMP(S). THE CONTRACTOR SHALL PROVIDE POLLUTION PREVENTION AND EROSION CONTROL MEASURES AS SPECIFIED IN ACCORDANCE WITH THE CURRENT FLORIDA DEPARTMENT OF ENVIRONMENTAL PROTECTION NATIONAL POLLUTION DISCHARGE ELIMINATION SYSTEM (NPDES) REQUIREMENTS. CONTRACTOR SHALL PREPARE REQUIRED NPDES DOCUMENTATION AND OBTAIN PERMIT PRIOR TO COMMENCEMENT OF CONSTRUCTION. IT IS THE SOLE RESPONSIBILITY OF THE CONTRACTOR TO PREPARE THE REQUIRED NPDES DOCUMENT AND OBTAIN THE NPDES PERMIT. ALL COST ASSOCIATED WITH VII. MAINTENANCE NOTES: SUCH WORK SHALL BE DEEMED INCIDENTAL TO THE PROJECT LUMP SUM COST.

#### II. GENERAL EROSION CONTROL NOTES

- 1. THE STORM WATER POLLUTION PREVENTION PLAN (SWPPP) IS COMPRISED OF THESE EROSION CONTROL DRAWINGS, THE STANDARD DETAILS, THE NPDES PERMIT (TO BE OBTAINED BY CONTRACTOR) AND ALL SUBSEQUENT REPORTS AND RELATED DOCUMENTS.
- 2. ALL CONTRACTORS AND SUBCONTRACTORS INVOLVED WITH STORM WATER POLLUTION PREVENTION SHALL OBTAIN A COPY OF THIS DRAWING AND THE STATE OF FLORIDA NATIONAL POLLUTANT DISCHARGE ELIMINATION SYSTEM GENERAL PERMIT (NPDES PERMIT) AND BECOME FAMILIAR WITH THEIR CONTENTS.
- 3. CONTRACTOR SHALL IMPLEMENT BEST MANAGEMENT PRACTICES (BMP) IN ALL CONSTRUCTION ACTIVITIES INCLUDING BUT NOT LIMITED TO THE FOLLOWING:
  - A. FUEL SPILLS AND LEAKS PREVENTION
  - PREVENT/REDUCE VEHICLE AND EQUIPMENT WASHING AND STEAM CLEANING
  - VEHICLE AND EQUIPMENT MAINTENANCE AND REPAIR PROPER OUTDOOR LOADING/UNLOADING OF MATERIALS
  - PREVENT/REDUCE OUTDOOR STORAGE OF RAW MATERIALS, PRODUCTS, AND BY-PRODUCTS
- SOLID WASTE MANAGEMENT
- HAZARDOUS WASTE MANAGEMENT
- CONCRETE WASTE MANAGEMENT SANDBLASTING WASTE MANAGEMEN
- STRUCTURE CONSTRUCTION AND PAINTING
- SPILL PREVENTION AND CONTROL
- CONTAMINATED SOIL MANAGEMENT
- SANITARY/SEPTIC WASTE MANAGEMENT SOIL EROSION CONTROL
- STORM WATER TURBIDITY MANAGEMENT
- 4. ADDITIONAL BEST MANAGEMENT PRACTICES SHALL BE IMPLEMENTED AS DICTATED BY CONDITIONS AT NO ADDITIONAL COST TO THE OWNER THROUGHOUT ALL PHASES OF CONSTRUCTION.
  - A. BEST MANAGEMENT PRACTICES (BMPS) AND CONTROLS SHALL CONFORM TO FEDERAL, STATE, OR LOCAL REQUIREMENTS OR MANUAL OF PRACTICE, AS APPLICABLE. CONTRACTOR SHALL IMPLEMENT ADDITIONAL CONTROLS AS DIRECTED BY PERMITTING AGENCY OR OWNER.
  - B. SITE MAP MUST CLEARLY DELINEATE ALL STATE WATERS. CONTRACTOR MUST MAINTAIN ALL PERMITS FOR ANY CONSTRUCTION ACTIVITY IMPACTING STATE WATERS OR REGULATED WETLANDS ON SITE AT ALL TIMES
  - C. CONTRACTOR SHALL MINIMIZE CLEARING TO THE MAXIMUM EXTENT PRACTICAL OR AS REQUIRED BY
  - D. CONTRACTOR SHALL BEGIN CLEARING AND GRUBBING THOSE PORTIONS OF THE SITE NECESSARY TO IMPLEMENT PERIMETER CONTROL MEASURES. CLEARING AND GRUBBING FOR THE REMAINING PORTIONS OF THE PROPOSED SITE SHALL COMMENCE ONCE PERIMETER CONTROLS ARE IN PLACE. PERIMETER CONTROLS SHALL BE ACTIVELY MAINTAINED UNTIL SAID AREAS HAVE BEEN STABILIZED AND SHALL BE REMOVED ONCE FINAL STABILIZATION IS COMPLETE.
  - GENERAL EROSION CONTROL BMPS SHALL BE EMPLOYED TO MINIMIZE SOIL EROSION AND POTENTIAL LAKE SLOPE CAVE-INS. WHILE THE VARIOUS TECHNIQUES REQUIRED WILL BE SITE AND PLAN SPECIFIC, THEY SHOULD BE EMPLOYED AS SOON AS POSSIBLE DURING CONSTRUCTION
  - F. ON-SITE & OFF-SITE SOIL STOCKPILE AND BORROW AREAS SHALL BE PROTECTED FROM EROSION AND SEDIMENTATION THROUGH IMPLEMENTATION OF BEST MANAGEMENT PRACTICES. STOCKPILE AND BORROW AREA LOCATIONS SHALL BE NOTED ON THE SITE MAP AND PERMITTED IN ACCORDANCE WITH GENERAL PERMIT REQUIREMENTS.
  - G. SURFACE WATER QUALITY SHALL BE MAINTAINED BY EMPLOYING THE FOLLOWING BMP'S IN THE CONSTRUCTION PLANNING AND CONSTRUCTION OF ALL IMPROVEMENTS.

# III. STORMWATER EROSION CONTROL NOTES:

- CONTRACTORS OR SUBCONTRACTORS WILL BE RESPONSIBLE FOR REMOVING SEDIMENT FROM DETENTION PONDS AND ANY SEDIMENT THAT MAY HAVE COLLECTED IN THE STORM SEWER DRAINAGE SYSTEMS IN CONJUNCTION WITH THE STABILIZATION OF THE SITE.
- 2. SLOPES SHALL BE LEFT IN A ROUGHENED CONDITION DURING THE GRADING PHASE TO REDUCE RUNOFF
- 3. DUE TO THE GRADE CHANGES DURING THE DEVELOPMENT OF THE PROJECT, THE CONTRACTOR SHALL BE 5. ALL MATERIALS SPILLED, DROPPED, WASHED, OR TRACKED FROM VEHICLES ONTO ROADWAYS OR INTO RESPONSIBLE FOR ADJUSTING THE EROSION CONTROL MEASURES (COMPOST SOCK DEVICES, ETC.) TO
- 4. WHERE PRACTICAL, STORMWATER SHALL BE CONVEYED BY SWALES.
- 5. EROSION CONTROL MEASURES SHALL BE EMPLOYED TO MINIMIZE TURBIDITY OF SURFACE WATERS LOCATED THE FOLLOWING ARE THE MATERIAL MANAGEMENT PRACTICES THAT WILL BE USED TO REDUCE THE RISK OF DOWNSTREAM OF ANY CONSTRUCTION ACTIVITY. WHILE THE VARIOUS MEASURES REQUIRED WILL BE SITE SPILLS OR OTHER ACCIDENTAL EXPOSURE OF MATERIALS AND SUBSTANCES TO STORM WATER RUNOFF. SPECIFIC, THEY SHALL BE EMPLOYED AS NEEDED IN ACCORDANCE WITH THE FOLLOWING:
- A. IN GENERAL, EROSION SHALL BE CONTROLLED AT THE FURTHEST PRACTICAL UPSTREAM LOCATION.
- B. STORMWATER INLETS SHALL BE PROTECTED DURING CONSTRUCTION. PROTECTION MEASURES SHALL BE EMPLOYED AS SOON AS PRACTICAL DURING THE VARIOUS STAGES OF INLET CONSTRUCTION. SILT BARRIERS SHALL REMAIN IN PLACE UNTIL SODDING AROUND INLETS IS COMPLETE.
- C. WHEN NEEDED A TEMPORARY SEDIMENT TRAP SHOULD BE CONSTRUCTION TO DETAIN SEDIMENT-LADEN RUNOFF FROM DISTURBED AREAS.
- 6. SILT BARRIERS, ANY SILT WHICH ACCUMULATES BEHIND THE BARRIERS, AND ANY FILL USED TO ANCHOR THE BARRIERS SHALL BE REMOVED PROMPTLY AFTER THE END OF THE MAINTENANCE PERIOD SPECIFIED FOR THE BARRIERS.
- 7. SOD SHALL BE PLACED FOR A 2-FOOT WIDE STRIP ADJOINING ALL CURBING AND AROUND ALL INLETS. SOD SHALL BE PLACED BEFORE SILT BARRIERS ARE REMOVED.
- 8. WHERE REQUIRED TO PREVENT EROSION FROM SHEET FLOW ACROSS BARE GROUND FROM ENTERING A 2. HAZARDOUS PRODUCTS LAKE OR SWALE, A TEMPORARY SEDIMENT SUMP SHALL BE CONSTRUCTED.
- 9. FILTER FABRIC SHOULD BE USED FOR STORM DRAIN INLET PROTECTION BEFORE FINAL STABILIZATION.

## IV. STABILIZATION NOTES:

SHALL BE IN ACCORDANCE WITH DEP DOCUMENT NO. 62-621.300(4)(a)

V. STRUCTURAL NOTES:

SHALL BE IN ACCORDANCE WITH DEP DOCUMENT NO. 62-621.300(4)(a)

### VI. WASTE DISPOSAL NOTES

- 1. WASTE MATERIALS ALL WASTE MATERIALS SHALL BE COLLECTED AND STORED IN A METAL DUMPSTER WITH A SECURE LID IN ACCORDANCE WITH ALL LOCAL AND STATE LAWS. ALL TRASH AND CONSTRUCTION DEBRIS FROM THE SITE SHALL BE DEPOSITED IN THE DUMPSTER. THE SUPERINTENDENT SHALL COORDINATE WITH THE LOCAL UTILITIES TO HAVE THE DUMPSTER EMPTIED AT LEAST TWICE A WEEK AND THE WASTE TAKEN TO AN APPROPRIATE LANDFILL. NO CONSTRUCTION WASTE MATERIALS SHALL BE BURIED ON SITE. THE SUPERINTENDENT SHALL ORGANIZE TRAINING FOR THE EMPLOYEES IN THE PROPER PRACTICES WHEN DEALING WITH WASTE MATERIALS. THE SUPERINTENDENT SHALL BE RESPONSIBLE FOR POSTING AND ENFORCING WASTE MATERIAL PROCEDURES.
- 2. HAZARDOUS WASTE HAZARDOUS WASTE MATERIALS SHALL BE DISPOSED OF IN ACCORDANCE WITH ALL LOCAL AND STATE LAWS OR AS DIRECTED BY THE MANUFACTURER. THE SUPERINTENDENT SHALL HAZARDOUS WASTE MATERIALS. THESE PROCEDURES SHALL BE POSTED ON THE SITE. THE PERSON WHO FOLLOWING PRACTICES SHALL BE FOLLOWED FOR SPILL PREVENTION AND CLEANUP: MANAGES THE SITE SHALL BE RESPONSIBLE FOR ENFORCING THE PROCEDURES.
- 3. SANITARY WASTE SANITARY WASTE SHALL BE COLLECTED AND DISPOSED OF IN ACCORDANCE WITH ALL LOCAL AND STATE LAWS. THE SUPERINTENDENT SHALL COORDINATE WITH THE LOCAL UTILITY FOR COLLECTION OF THE SANITARY WASTE AT LEAST THREE TIMES A WEEK TO PREVENT SPILLAGE ONTO THE
- 4. RUBBISH, TRASH, GARBAGE, LITTER, OR OTHER SUCH MATERIALS SHALL BE DEPOSITED INTO SEALED CONTAINERS. MATERIALS SHALL BE PREVENTED FROM LEAVING THE PREMISES THROUGH THE ACTION OF WIND OR STORM WATER DISCHARGE INTO DRAINAGE DITCHES OR WATERS OF THE STATE.

ALL MEASURES STATED ON THIS EROSION AND SEDIMENT CONTROL PLAN, AND IN THE STORM WATER POLLUTION PREVENTION PLAN, SHALL BE MAINTAINED IN FULLY FUNCTIONAL CONDITION UNTIL NO LONGER REQUIRED FOR A COMPLETED PHASE OF WORK OR FINAL STABILIZATION OF THE SITE. ALL EROSION AND SEDIMENTATION CONTROL MEASURES SHALL BE CHECKED BY A QUALIFIED PERSON AT LEAST ONCE EVERY SEVEN CALENDAR DAYS AND WITHIN 24 HOURS OF THE END OF A 0.5" RAINFALL EVENT, AND CLEANED AND REPAIRED IN ACCORDANCE WITH THE FOLLOWING:

- 1. INLET PROTECTION DEVICES AND BARRIERS SHALL BE REPAIRED OR REPLACED IF THEY SHOW SIGNS OF UNDERMINING, OR DETERIORATION.
- 2. ALL SEEDED AREAS SHALL BE CHECKED REGULARLY TO SEE THAT A GOOD STAND IS MAINTAINED. AREAS SHOULD BE FERTILIZED, WATERED, AND RESEEDED AS NEEDED.
- 3. THE COMPOST SOCK FILTRATION DEVICE SHALL BE INSPECTED PERIODICALLY FOR HEIGHT OF SEDIMENT AND CONDITION OF DEVICE. COMPOST SOCK SHALL BE REPAIRED TO ITS ORIGINAL CONDITIONS IF DAMAGED. SEDIMENT SHALL BE REMOVED FROM THE COMPOST SOCK WHEN IT REACHES ONE-THIRD THE HEIGHT OF THE COMPOST SOCK.
- 4. THE CONSTRUCTION ENTRANCES SHALL BE MAINTAINED IN A CONDITION WHICH WILL PREVENT TRACKING OR FLOW OF MUD ONTO PUBLIC RIGHTS-OF-WAY. THIS MAY REQUIRE PERIODIC TOP DRESSING OF THE CONSTRUCTION ENTRANCES AS CONDITIONS DEMAND.
- 5. THE TEMPORARY PARKING AND STORAGE AREA SHALL BE KEPT IN GOOD CONDITION (SUITABLE FOR PARKING AND STORAGE). THIS MAY REQUIRE PERIODIC TOP DRESSING OF THE TEMPORARY PARKING AS
- 6. OUTLET STRUCTURES IN THE SEDIMENTATION BASINS SHALL BE MAINTAINED IN OPERATIONAL CONDITIONS AT ALL TIMES. THE SEDIMENT BASINS/DITCHES SHALL BE CHECKED MONTHLY FOR DEPTH OF SEDIMENT. SEDIMENT SHALL BE REMOVED FROM SEDIMENT BASINS OR TRAPS WHEN THE DESIGN CAPACITY HAS BEEN REDUCED BY 10% AND AFTER CONSTRUCTION IS COMPLETE.
- 7. ALL MAINTENANCE OPERATIONS SHALL BE DONE IN A TIMELY MANNER BUT IN NO CASE LATER THAN TWENTY-FOUR (24) HOURS FOLLOWING THE INSPECTION. DIVERSION DIKES SHALL BE INSPECTED MONTHLY. ANY BREACHES SHALL BE PROMPTLY REPAIRED.
- 8. A MAINTENANCE REPORT SHALL BE COMPLETED DAILY AFTER EACH INSPECTION OF THE SEDIMENT AND EROSION CONTROL METHODS. THE REPORTS SHALL BE FILED IN AN ORGANIZED MANNER AND RETAINED ON-SITE DURING CONSTRUCTION. AFTER CONSTRUCTION IS COMPLETED, THE REPORTS SHALL BE SAVED FOR AT LEAST THREE YEARS. THE REPORTS SHALL BE AVAILABLE FOR ANY AGENCY THAT HAS JURISDICTION OVER EROSION CONTROL.
- 9. THE SUPERINTENDENT SHALL ORGANIZE THE TRAINING FOR INSPECTION PROCEDURES AND PROPER EROSION CONTROL METHODS FOR EMPLOYEES THAT COMPLETE INSPECTIONS AND REPORTS.
- 10. SILT FENCES SHALL BE REPAIRED TO THEIR ORIGINAL CONDITIONS IF DAMAGED. SEDIMENT SHALL BE REMOVED FROM THE SILT FENCES WHEN IT REACHES ONE-HALF THE HEIGHT OF THE SILT FENCE.

# VIII. OFFSITE TRACKING NOTES:

- MAJOR ROAD CONNECTED TO THE PROJECT SHALL BE CLEANED ONCE A DAY TO REMOVE ANY EXCESS MUD, DIRT OR ROCK RESULTING FROM CONSTRUCTION TRAFFIC. ALL TRUCKS HAULING MATERIALS OFFSITE SHALL BE COVERED WITH A TARPAULIN.
- 2. GENERAL CONTRACTOR SHALL DENOTE ON PLAN THE TEMPORARY PARKING AND STORAGE AREA WHICH SHALL ALSO BE USED AS THE EQUIPMENT MAINTENANCE AND CLEANING AREA, EMPLOYEE PARKING AREA, AND AREA FOR LOCATION PORTABLE FACILITIES, OFFICE TRAILERS, AND TOILET FACILITIES. HEAVY CONSTRUCTION EQUIPMENT PARKING AND MAINTENANCE AREAS SHALL BE DESIGNED TO PREVENT OIL. GREASE, AND LUBRICANTS FROM ENTERING SITE DRAINAGE FEATURES INCLUDING STORMWATER COLLECTION AND TREATMENT SYSTEMS. CONTRACTORS SHALL PROVIDE BROAD DIKES, HAY BALES OR SILT SCREENS AROUND, AND SEDIMENT SUMPS WITHIN, SUCH AREAS AS REQUIRED TO CONTAIN SPILLS OF OIL, GREASE OR LUBRICANTS. CONTRACTORS SHALL HAVE AVAILABLE, AND SHALL USE, ABSORBENT FILTER PADS TO CLEAN UP SPILLS AS SOON AS POSSIBLE AFTER OCCURRENCE.
- 3. ALL WASH WATER FROM CONCRETE TRUCKS, VEHICLE CLEANING, EQUIPMENT CLEANING, ETC. SHALL BE DETAINED ON SITE AND SHALL BE PROPERLY TREATED OR DISPOSED.
- 4. IF THE ACTION OF VEHICLES TRAVELING OVER THE GRAVEL CONSTRUCTION ENTRANCES IS NOT SUFFICIENT TO REMOVE THE MAJORITY OF DIRT OR MUD, THEN THE TIRES MUST BE WASHED BEFORE THE VEHICLES ENTER A PUBLIC ROAD. IF WASHING IS USED, PROVISIONS MUST BE MADE TO INTERCEPT THE WASH WATER AND TRAP THE SEDIMENT BEFORE IT IS CARRIED OFF THE SITE.
- STORM DRAINS MUST BE REMOVED IMMEDIATELY.

# IX. SPILL PREVENTION AND CONTROL NOTES:

## 1. GOOD HOUSEKEEPING

- A. SUPERINTENDENT SHALL INSPECT PROJECT AREA DAILY FOR PROPER STORAGE, USE, AND DISPOSAL OF CONSTRUCTION MATERIALS.
- B. STORE ONLY ENOUGH MATERIAL ON SITE FOR PROJECT COMPLETION.
- C. ALL SUBSTANCES SHOULD BE USED BEFORE DISPOSAL OF CONTAINER.
- D. ALL CONSTRUCTION MATERIALS STORED SHALL BE ORGANIZED AND IN THE PROPER CONTAINER AND IF POSSIBLE, STORED UNDER A ROOF OR PROTECTIVE COVER.
- E. PRODUCTS SHALL NOT BE MIXED UNLESS DIRECTED BY THE MANUFACTURER.
- F. ALL PRODUCTS SHALL BE USED AND DISPOSED OF ACCORDING TO THE MANUFACTURER'S RECOMMENDATIONS.

- A. MATERIALS SHOULD BE KEPT IN ORIGINAL CONTAINER WITH LABELS UNLESS THE ORIGINAL CONTAINERS CANNOT BE RESEALED. IF ORIGINAL CONTAINERS CANNOT BE USED, LABELS AND PRODUCT INFORMATION SHALL BE SAVED.
- B. PROPER DISPOSAL PRACTICES SHALL ALWAYS BE FOLLOWED IN ACCORDANCE WITH MANUFACTURER AND LOCAL/STATE REGULATIONS.

## 3. PRODUCT SPECIFIC PRACTICES

A. PETROLEUM PRODUCTS MUST BE STORED IN PROPER CONTAINERS AND CLEARLY LABELED. VEHICLES CONTAINING PETROLEUM PRODUCTS SHALL BE PERIODICALLY INSPECTED FOR LEAKS. PRECAUTIONS SHALL BE TAKEN TO AVOID LEAKAGE OF PETROLEUM PRODUCTS ON SITE.

- B. THE MINIMUM AMOUNT OF FERTILIZER SHALL BE USED AND MIXED INTO THE SOIL IN ORDER TO LIMIT EXPOSURE TO STORM WATER. FERTILIZERS SHALL BE STORED IN A COVERED SHED. THE CONTENTS OF ANY PARTIALLY USED BAGS OF FERTILIZER SHALL BE TRANSFERRED TO A SEALABLE PLASTIC BIN TO AVOID SPILLS.
- C. PAINT CONTAINERS SHALL BE SEALED AND STORED WHEN NOT IN USE. EXCESS PAINT MUST BE DISPOSED OF IN AN APPROVED MANNER.
- D. CONCRETE TRUCKS SHALL NOT BE ALLOWED TO WASH OUT OR DISCHARGE SURPLUS CONCRETE OR DRUM WASH WATER ON THE SITE.

#### X. SPILL CLEAN UP NOTES:

- ORGANIZE THE PROPER TRAINING FOR EMPLOYEES IN THE PROPER PRACTICES WHEN DEALING WITH IN ADDITION TO THE GOOD HOUSEKEEPING AND MATERIAL MANAGEMENT PRACTICES DISCUSSED ABOVE, THE
  - 1. SPILL CLEANUP INFORMATION SHALL BE POSTED ON SITE TO INFORM EMPLOYEES ABOUT CLEANUF PROCEDURES AND RESOURCES.
  - 2. THE FOLLOWING CLEAN-UP EQUIPMENT MUST BE KEPT ON-SITE NEAR THE MATERIAL STORAGE AREA: GLOVES, MOPS, RAGS, BROOMS, DUST PANS, SAND, SAWDUST, LIQUID ABSORBER, GOGGLES, AND TRASH
  - 3. SUFFICIENT OIL AND GREASE ABSORBING MATERIALS AND FLOTATION BOOMS SHALL BE MAINTAINED ONSITE AND READILY AVAILABLE TO CONTAIN AND CLEAN-UP FUEL OR CHEMICAL SPILLS AND LEAKS.
  - 4. ALL SPILLS SHALL BE CLEANED UP AS SOON AS POSSIBLE
  - 5. WHEN CLEANING A SPILL, THE AREA SHOULD BE WELL VENTILATED AND THE EMPLOYEE SHALL WEAR PROPER PROTECTIVE COVERING TO PREVENT INJURY.
  - 6. TOXIC SPILLS MUST BE REPORTED TO THE PROPER AUTHORITY REGARDLESS OF THE SIZE OF THE SPILL. 7. AFTER A SPILL, THE PREVENTION PLAN SHALL BE REVIEWED AND CHANGED TO PREVENT FURTHER SIMILAR
  - SPILLS FROM OCCURRING. THE CAUSE OF THE SPILL, MEASURES TO PREVENT IT, AND HOW TO CLEAN THE SPILL UP SHALL BE RECORDED. 8. THE SUPERINTENDENT SHALL BE THE SPILL PREVENTION AND CLEANUP COORDINATOR AND IS RESPONSIBLE FOR THE DAY TO DAY SITE OPERATIONS. THE SUPERINTENDENT ALSO OVERSEES THE SPILL

PREVENTION PLAN AND SHALL BE RESPONSIBLE FOR EDUCATING THE EMPLOYEES ABOUT SPILL

# XI. WIND EROSION CONTROL NOTES:

PREVENTION AND CLEANUP PROCEDURES.

- 1. WIND EROSION SHALL BE CONTROLLED BY EMPLOYING THE FOLLOWING METHODS AS NECESSARY AND APPROPRIATE:
- A. BARE EARTH AREAS SHALL BE WATERED DURING CONSTRUCTION AS NECESSARY TO MINIMIZE THE TRANSPORT OF FUGITIVE DUST. IT MAY BE NECESSARY TO LIMIT CONSTRUCTION VEHICLE SPEED IF BARE EARTH HAS NOT BEEN EFFECTIVELY WATERED. IN NO CASE SHALL FUGITIVE DUST BE ALLOWED TO LEAVE THE SITE UNDER CONSTRUCTION.
- B. DISTURBED PORTIONS OF THE SITE WHERE CONSTRUCTION ACTIVITY HAS PERMANENTLY STOPPED SHALL BE PERMANENTLY SEEDED (SEE PERMANENT STABILIZATION PRACTICES FOR DETAILS). THESE AREAS SHALL BE SEEDED NO LATER THAN 14 DAYS AFTER THE LAST CONSTRUCTION ACTIVITY OCCURRING IN THESE AREAS. REFER TO THE GRADING PLAN AND/OR LANDSCAPE PLAN. CLEARED SITE DEVELOPMENT AREAS NOT CONTINUALLY SCHEDULED FOR CONSTRUCTION ACTIVITIES SHALL BE COVERED WITH HAY OR OVERSEEDED AND PERIODICALLY WATERED SUFFICIENTLY TO STABILIZE THE TEMPORARY GROUNDCOVER (SEE TEMPORARY STABILIZATION PRACTICES FOR DETAILS).
- C. AT ANY TIME BOTH DURING AND AFTER SITE CONSTRUCTION THAT WATERING AND/OR VEGETATION ARE NOT EFFECTIVE IN CONTROLLING WIND EROSION AND/OR TRANSPORT OF FUGITIVE DUST, OTHER METHODS AS ARE NECESSARY FOR SUCH CONTROL SHALL BE EMPLOYED. THESE METHODS SHOULD INCLUDE ERECTION OF DUST CONTROL FENCES. A 6-FT GEOTEXTILE FILTER FABRIC SHOULD BE HANGING AGAINST THE EXISTING CHAIN LINK FENCE AND GATE.
- 2. ALL DUST ON THE SITE SHALL BE CONTROLLED. THE USE OF MOTOR OILS AND OTHER PETROLEUM BASED OR TOXIC LIQUIDS FOR DUST SUPPRESSION OPERATIONS IS PROHIBITED.

### XII. STORMWATER POLLUTION PREVENTION PRACTICES:(FOR PROJECTS OF 0.5 ACRES OR MORE CITY ORDINANCE NUMBER 13081)

- 1. TREE PROTECTION AND PRUNING SHALL BE ACCOMPLISHED AS DETAILED IN SPECIAL PROVISIONS, THE CONSTRUCTION PLANS, AND/OR PER TREE ORDINANCE 12636.
- 1. STABILIZED CONSTRUCTION ENTRANCE SHALL BE PROVIDED TO REDUCE SEDIMENT TRACKING OFFSITE. THE 2. THE STORM WATER POLLUTION PREVENTION PLAN, SWPPP, SUBMITTED TO PUBLIC WORKS, SHALL DESCRIBE IN DETAIL HOW THE CONSTRUCTION EFFORT WILL BE PHASED WITH REGARDS TO MINIMIZING EROSION PROBLEMS BY THE USE OF TEMPORARY AND PERMANENT EROSION CONTROL MEASURES, FOR THE VARIOUS SEQUENCES OF CONSTRUCTION OPERATIONS. ANY MODIFICATIONS MUST BE APPROVED BY THE CITY OF MIAMI - NPDES SECTION, DEPARTMENT OF PUBLIC WORKS.
  - 3. ENVIRONMENTAL CONTROL FEATURES AS PROVIDED IN THE STORMWATER POLLUTION PREVENTION PLAN (SWPPP), ARE TO BE INSTALLED AT ALL AREAS OF EXCAVATION OR FILL FOR DRAINAGE SYSTEM, OR STRUCTURE CONSTRUCTION PRIOR TO SUCH EXCAVATION OR FILL. INLET ENTRANCES ARE ALSO TO BE PROTECTED FROM SILTATION AS DETAILED ON SHEET 2 OF 4 OF THE MISC. 35-89-5 OF THE CITY OF MIAMI PUBLIC WORKS ENGINEERING STANDARD FOR DESIGN AND CONSTRUCTION MANUAL.
  - 4. ALL ENVIRONMENTAL CONTROL FEATURES ARE TO BE MAINTAINED THROUGHOUT THE LIFE OF THE PROJECT IN ACCORDANCE WITH NATIONAL POLLUTION DISCHARGE ELIMINATION SYSTEM (NPDES) REQUIREMENTS. THE CONTRACTOR MUST ENSURE THAT ALL EROSION CONTROL FEATURES FUNCTION PROPERLY AT ALL TIMES.
  - 5. ALL EROSION AND MATERIAL DEPOSITS MUST BE CONTAINED WITHIN THE PROJECT LIMITS.
  - 6. ANY DAMAGE OR INEFFECTIVE ROCK BAGS ARE TO BE REPLACED WITH NEW ONES. THE LOCATION OF ROCK BAGS INSTALLATION IS AS MENTIONED IN THE SWPPP PLANS. THE PROJECT ENGINEER MAY SPECIFY OTHER AREAS AS NECESSARY.
  - 7. DITCH BOTTOM INLETS SHALL BE PROTECTED FROM SEDIMENT INTAKE UNTIL THE PROJECT IS COMPLETE. ELEVATION OF GROUND OUTSIDE OF INLET TOP SHALL NOT BE HIGHER THAT INLET TOP. ROCK BAGS SHALL BE INSTALLED AROUND INLET TOP. COMPLETED INLETS IN PAVED AREAS SHALL ALSO BE PROTECTED WITH ROCK BAGS TO PREVENT SEDIMENT INTAKE.
  - 8. CURB INLETS SHALL BE PROTECTED FROM SEDIMENT INTAKE UNTIL THE PROJECT IS COMPETE. ALL EXPOSED SLOPED MATERIAL ADJACENT TO INLETS SHALL BE COVERED WITH EROSION CONTROL MATTING WITH OUTER LIMITS PROTECTED BY ROCK BAGS. ANY DAMAGED OR INEFFECTIVE ROCK BAGS ARE TO BY REPLACED WITH NEW ONES.
  - 9. STOCKPILED MATERIAL SHALL NOTE BE LEFT IN EROSION PRONE AREAS UNLESS PROTECTED BY COVER OR ROCK BAGS.

10. INSPECTION OF EROSION CONTROL MEASURES AND CONDITION OF ADJACENT PROPERTIES SHALL BE

- PERFORMED DAILY BY THE CONTRACTOR'S REPRESENTATIVE AND THE PROJECT ENGINEER. DEFICIENCIES SHALL BY NOTED AND CORRECTED. 11. ANY OFFSITE SEDIMENT DISCHARGE TO A MUNICIPAL SEPARATE STORMWATER SYSTEM ARISING FROM THE
- 12. THE USE OF SANITARY SEWERS, FRENCH DRAINS, COVER DITCHES AND/OR ROCK DRAINS FOR THE DISPOSAL OF WASTEWATER IS EXPRESSLY PROHIBITED. REFER TO PUBLIC WORKS BULLETIN NO. 25.

CONTRACTOR'S ACTIVITIES IS NOT ALLOWED. REFER TO PUBLIC WORKS BULLETIN NO. 25.

# XII. PROJECT DESCRIPTION:

13. PROJECT LOCATION: 8070 NW 36TH STREET DORAL, FLORIDA 33166

14. PROJECT LIMITS: FULL SITE: 0.91 ACRES

15. CONSTRUCTION ACTIVITY: CONSTRUCTION OF PROPOSED BUILDING, PARKING AREA, SIDEWALKS, LANDSCAPING, UTILITIES, AND DRAINAGE SYSTEM.

16. MAJOR SOIL DISTURBING ACTIVITIES: CLEARING AND GRUBBING, INSTALLATION OF DRAINAGE SYSTEM,

17. DEWATERING ACTIVITIES: IF ANY DEWATERING ACTIVITY IS REQUIRED FOR THIS PROJECT, THE CONTRACTOR SHALL BE RESPONSIBLE FOR SUBMITTING AN APPLICATION FOR CLASS V PERMIT TO THE DIVISION OF ENVIRONMENTAL RESOURCES MANAGEMENT.

INSTALLATION OF UTILITIES, CONSTRUCTION OF BUILDING FOUNDATION.

18. SOIL CHARACTERISTICS: THE SOIL TYPE WITHIN THE PROJECT'S LIMIT OF DISTURBANCE IS CLASSIFIED AS URBAN SOIL AND IS NOT HIGHLY ERODIBLE.

0.80

**EXISTING:** 19. RUNOFF COEFFICIENTS:

DURING CONSTRUCTION: PROPOSED: 0.90

# XII. SEQUENCE OF CONSTRUCTION

SEQUENCE OF SOIL DISTURBING ACTIVITIES AND IMPLEMENTATION OF CONTROLS:

- 1. PRIOR TO COMMENCEMENT OF ANY EARTH DISTURBING ACTIVITIES, INCLUDING CLEARING AND GRUBBING, INSTALL EROSION CONTROL MEASURES IN ACCORDANCE WITH THE EROSION CONTROL PLAN. STANDARD DETAILS, NPDES REQUIREMENTS, AND MIAMI-DADE COUNTY PUBLIC WORKS ENGINEERING STANDARD FOR DESIGN AND CONSTRUCTION MANUAL.
- 2. BEGIN CLEARING AND GRUBBING.
- 3. INSTALL DRAINAGE SYSTEM, INCLUDING: CONCRETE INLETS, DRAIN BASINS, DRAINAGE PIPES AND EXFILTRATION TRENCHES.
- 4. INSTALL INLET PROTECTION AND ROCK BAGS ON ALL INLETS AND MANHOLES IN THE LOCATIONS SHOWN ON THE PLANS AND PER THE STANDARD DETAILS PROVIDED AND MIAMI-DADE COUNTY PUBLIC WORKS ENGINEERING STANDARD FOR DESIGN AND CONSTRUCTION MANUAL.
- 5. PREPARE SUBBASE MATERIAL.
- BEGIN ASPHALT AND CONCRETE INSTALLATION.
- 7. AFTER COMPLETION OF SITE WORK, BEGIN SITE STABILIZATION AND PERMANENT SEEDING.
- 8. ONCE SITE STABILIZATION IS COMPLETE, CONTRACTOR TO CLEAN ALL CONSTRUCTION DEBRIS FROM
- 9. ONCE A UNIFORM 70% VEGETATIVE COVER OF PERENNIAL VEGETATION IS ACHIEVED ACROSS THE ENTIRE DISTURBED AREA THE REMOVAL OF TEMPORARY EROSION CONTROL MEASURES MAY BEGIN.

Store:

Raising Cane's Restaurant #0855 8070 NW 36th Stree

Designer's Information:

Coral Gables, Florida 33134 Telephone: 469-498-2100 www.csrsinc.com

95 Merrick Way, 3rd floor

Prototype Phase: 2021-1.0 (05-07-2021) 10-30-2021 Project Issue Date:

CSRS Project Manager

**ENTITLEMENTS** 

355 ALHAMBRA CIRCLE, SUITE 1400, CORAL GABLES, FL 33134 PHONE: 305-673-2025 WWW.KIMLEY-HORN.COM REGISTRY NO. 696 STATE OF

DATE: 2/16/2022 JUAN PABLO GONZALEZ PENA, P.E. ON THE DATE
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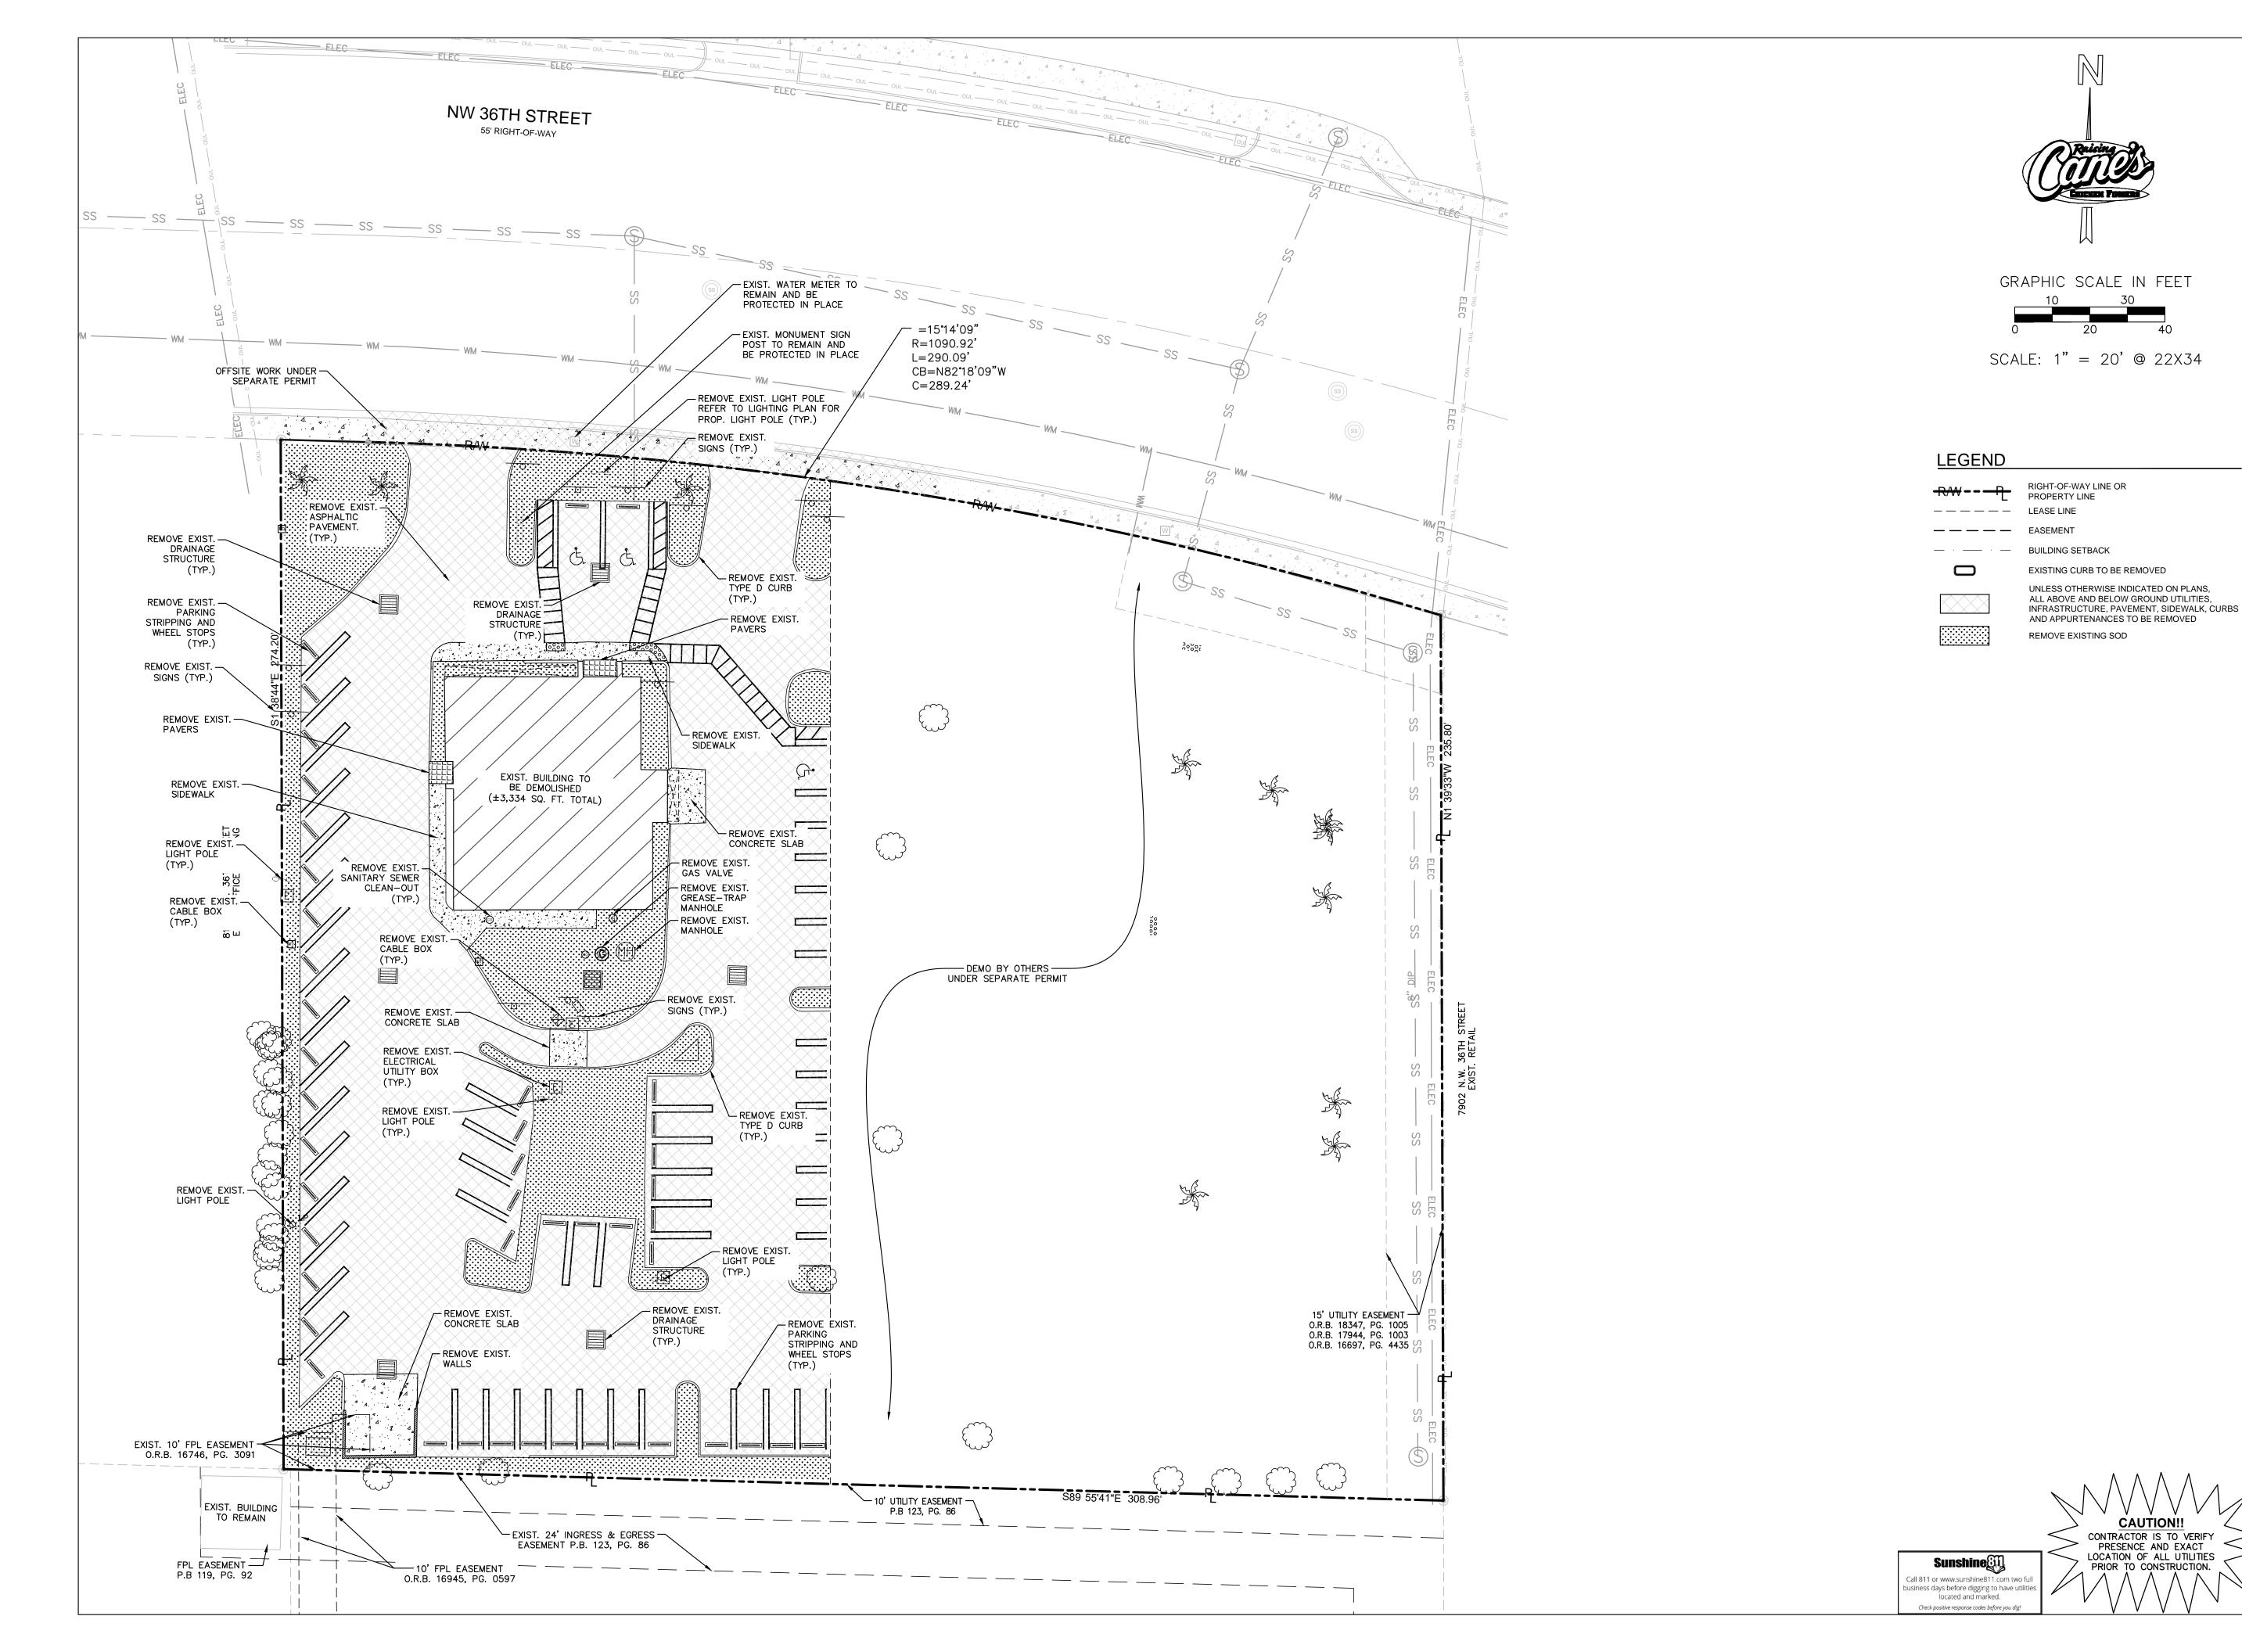
**EROSION CONTROL** 

Sheet Number:

Sheet Title:

Sheet Versions:

CAUTION!! CONTRACTOR IS TO VERIFY PRESENCE AND EXACT LOCATION OF ALL UTILITIES PRIOR TO CONSTRUCTION. all 811 or www.sunshine811 iness days before digging to have utiliti located and marked.





Store:

Raising Cane's
Restaurant #0855
8070 NW 36th Street
Doral, FL 33166
CUSTOM [A]

Designer's Information:

# CSRS

Coral Gables, Florida 33134 Telephone: 469-498-2100 www.csrsinc.com

95 Merrick Way, 3rd floor

Prototype Phase: 2021-1.0 (05-07-2021)

Project Issue Date: 10-30-2021

CSRS Project Manager:

ENTITLEMENTS

# Kimley»Horn

11-19-2021

355 ALHAMBRA CIRCLE, SUITE 1400, CORAL GABLES, FL 33134
PHONE: 305-673-2025
WWW.KIMLEY-HORN.COM REGISTRY NO. 696

No. 92190

DATE: 2/16/2022

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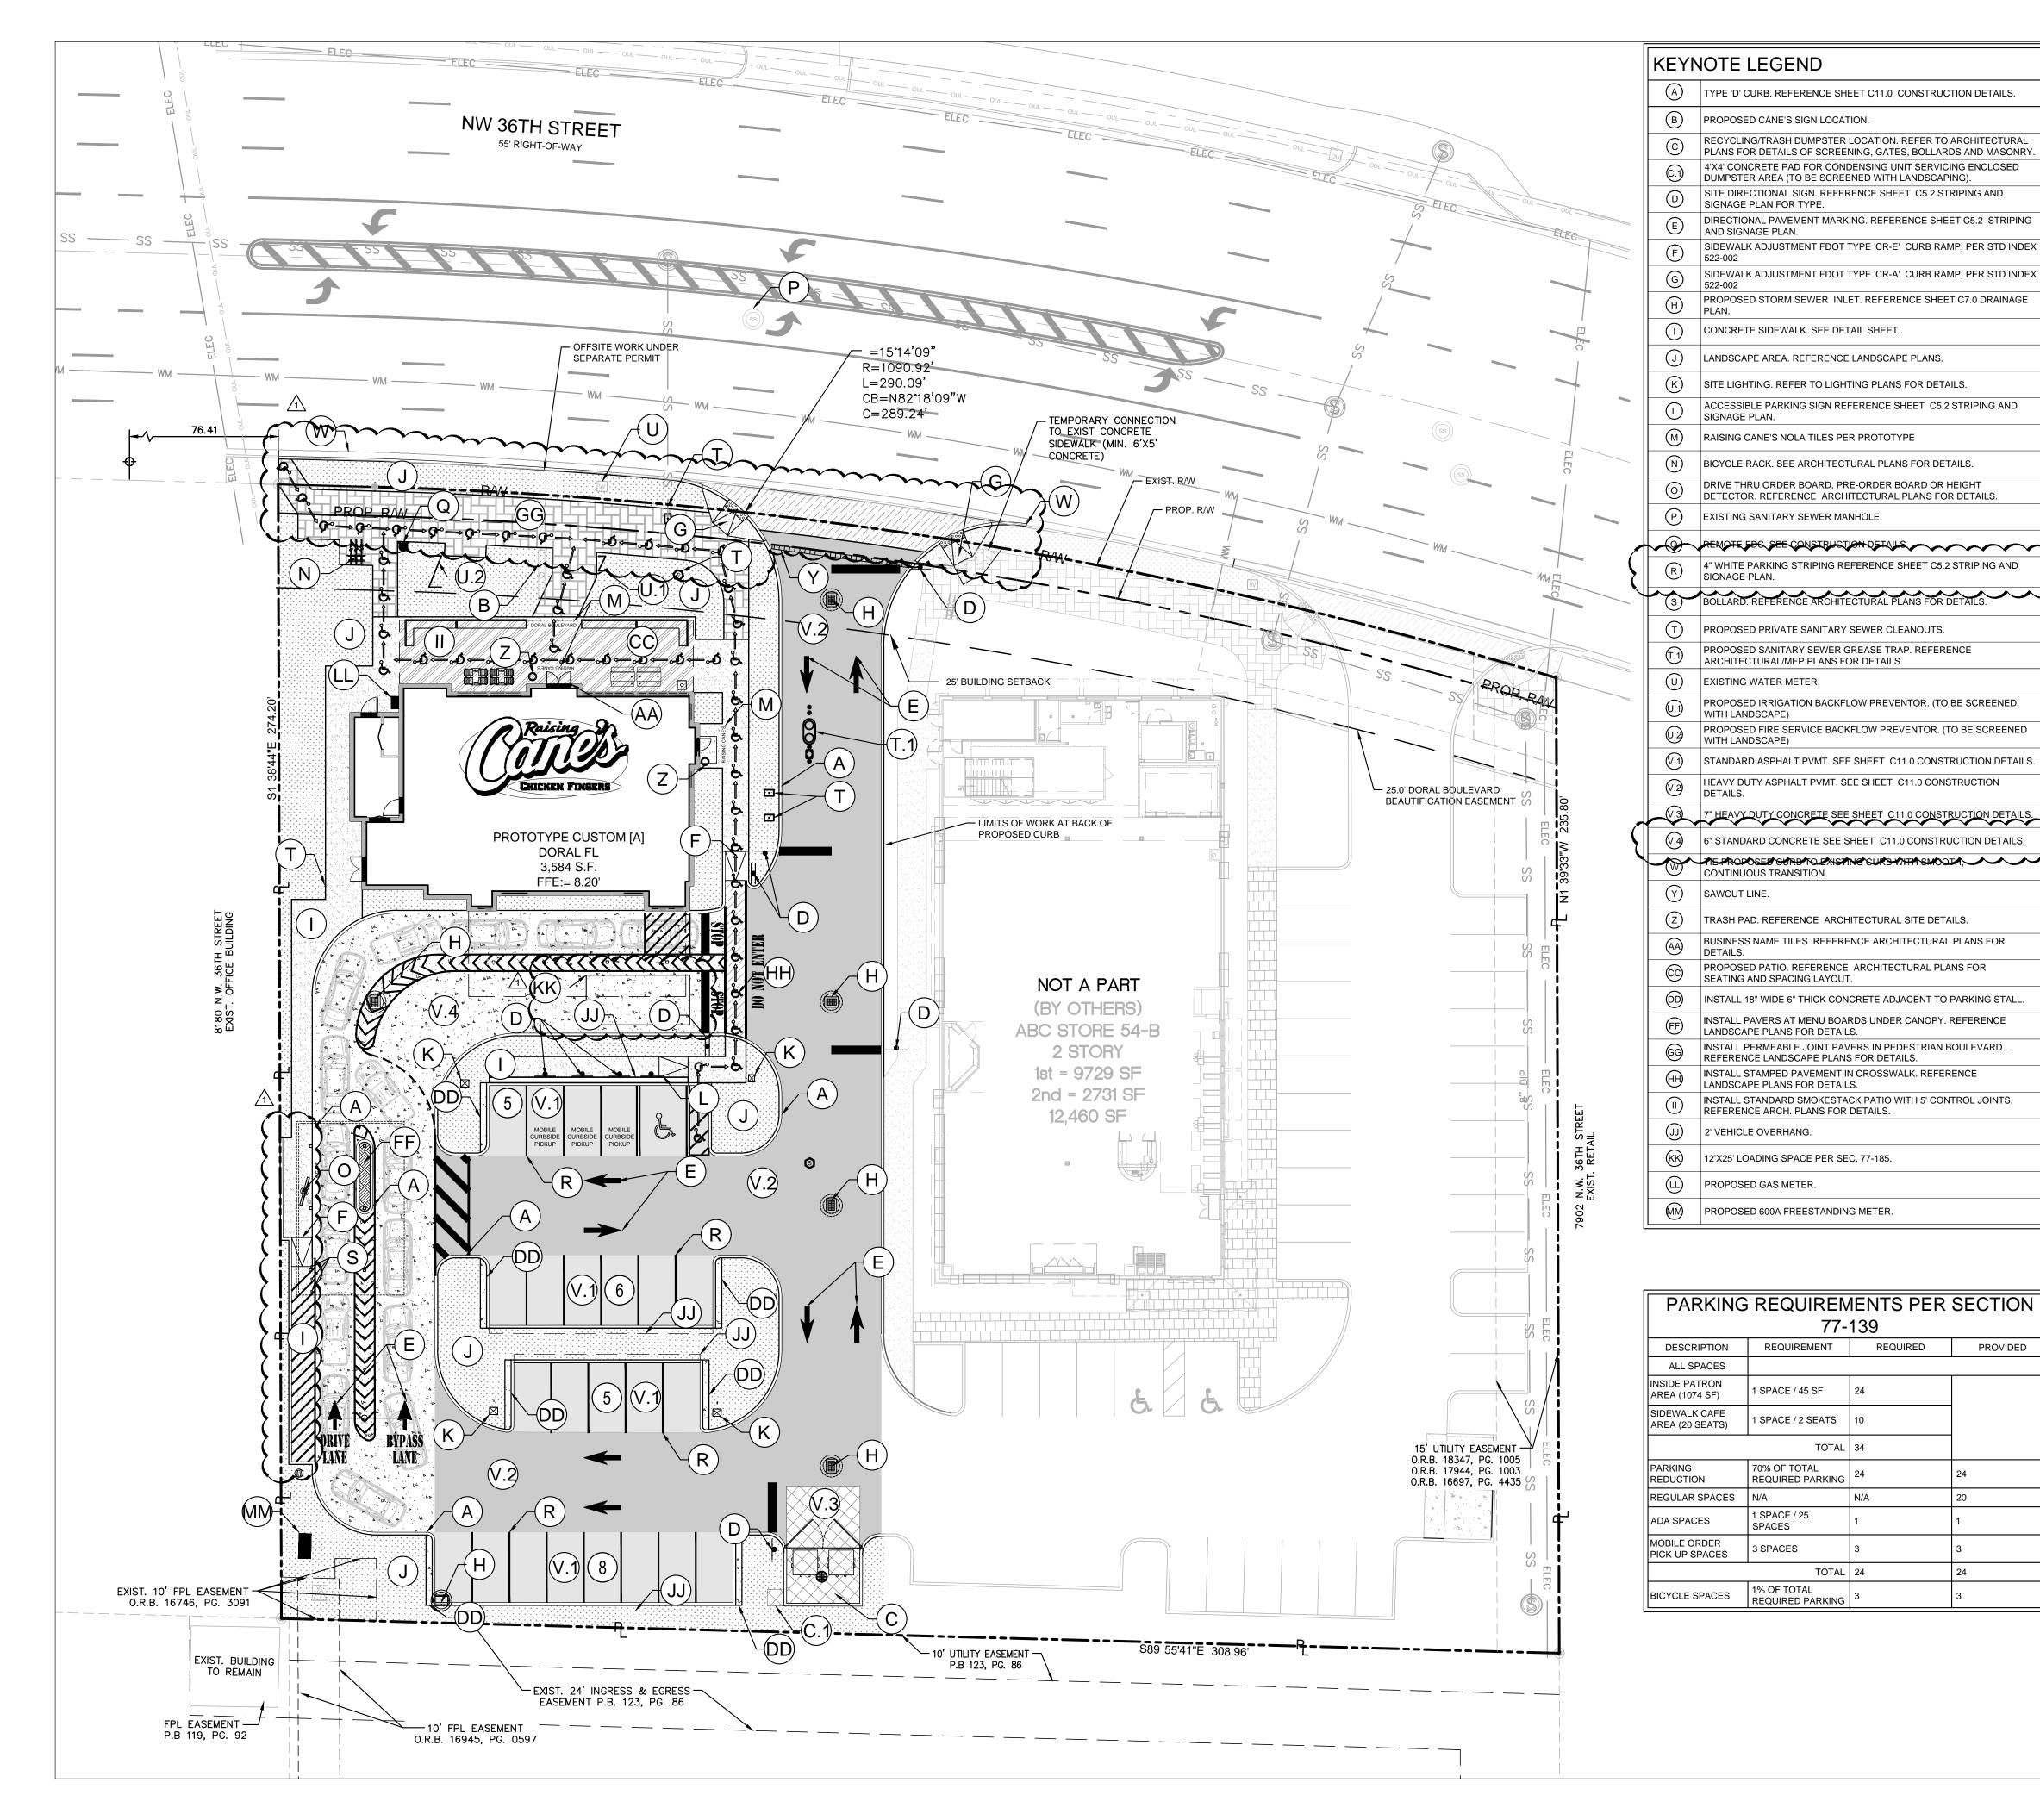
# Date Description

Sheet Title:

DEMOLITION PLAN

Sheet Number:

C4.0





GRAPHIC SCALE IN FEET

SCALE:  $1" = 20' \oplus 22X34$ 

# **LEGEND**

RIGHT-OF-WAY LINE OR PROPERTY LINE —— – – LEASE LINE EASEMENT **BUILDING SETBACK** PROPOSED CONCRETE CURB EXISTING CONCRETE CURB PROPOSED STANDARD ASPHALT PAVEMENT REFERENCE PAVEMENT DETAILS PROPOSED HEAVY DUTY ASPHALT PAVEMENT REFERENCE PAVEMENT DETAILS PROPOSED 7" HEAVY DUTY CONCRETE REFERENCE PAVEMENT DETAILS PROPOSED 6" STANDARD CONCRETE REFERENCE PAVEMENT DETAILS PROPOSED SIDEWALK PAVEMENT REFER TO CONSTRUCTION DETAILS PROPOSED PATTERNED CONCRETE REFER TO CONSTRUCTION DETAILS PROPOSED PATIO SIDEWALK PAVEMENT REFERENCE ARCH. PLANS FOR DETAILS PROPOSED PAVERS. REFERENCE LANDSCAPE PLANS FOR PATTERN AND MATERIAL DETAILS. PROPOSED PERMEABLE JOINT PAVERS REFERENCE LANDSCAPE PLANS FOR DETAILS

# SITE NOTES

ALL WORK AND MATERIALS SHALL COMPLY WITH ALL LOCAL JURISDICTION REGULATIONS AND CODES AND O.S.H.A. STANDARDS.

PROPOSED LANDSCAPE AREA

ACCESSIBLE ROUTE (LOCATION

PURPOSES ONLY, DO NOT PAINT)

- CONTRACTOR SHALL REFER TO THE ARCHITECTURAL/MEP PLANS FOR SITE LIGHTING & ELECTRICAL PLAN.
- REFERENCE ARCHITECTURAL PLANS FOR DUMPSTER ENCLOSURE
- ARE TO BE ABANDONED, REMOVED OR RELOCATED AS NECESSARY.

4. EXISTING STRUCTURES AND OR UTILITIES WITHIN CONSTRUCTION LIMITS

- SITE BOUNDARY, TOPOGRAPHY, UTILITY AND ROAD INFORMATION TAKEN FROM A SURVEY BY HADONNE DATED APRIL 06, 2021.
- ALL PROPOSED PAVING IN COUNTY R.O.W. AND EASEMENTS TO CONFORM TO FDOT AND MIAMI-DADE COUNTY STANDARDS. PER FEMA PANEL NUMBER 12086C0287L, COMMUNITY NUMBER 120041
- AND 120635 DATED SEPTEMBER 11, 2009, THE SITE IS WITHIN FLOOD
- BUILDING IS FIRE SPRINKLED.

Call 811 or www.sunshine811.com two siness days before digging to have utiliti located and marked.

REQUIRED

PROVIDED

TREE LOCATIONS ARE SHOWN FOR REFERENCE ONLY, REFER TO LANDSCAPE PLANS BY OTHERS.

| SITE                     | DATA   |
|--------------------------|--|
| EXISTING ZONING          | COMMERCIAL CORRIDOR<br>DISTRICT CC               |
| PROPOSED USE             | 2111 (RESTAURANT OR<br>CAFETERIA: RETAIL OUTLET) |
| LOT AREA                 | 41,068 SF (0.94 AC)                              |
| BUILDING AREA            | 3,584 SF   |
| FINISHED FLOOR ELEVATION | 8.20 FT  |
| IMPERVIOUS AREA          | 32,414 SF  |
| PERVIOUS AREA            | 8,654 SF   |

CAUTION!! PRIOR TO CONSTRUCTION.

CONTRACTOR IS TO VERIFY PRESENCE AND EXACT LOCATION OF ALL UTILITIES

Raising Cane's Restaurant #0855 8070 NW 36th Street Doral, FL 33166 CUSTOM [A] Designer's Information: 95 Merrick Way, 3rd floor Coral Gables, Florida 33134 Telephone: 469-498-2100 www.csrsinc.com 2021-1.0 (05-07-2021) Prototype Phase:

10-30-2021

Store:

**ENTITLEMENTS** 

11-19-2021

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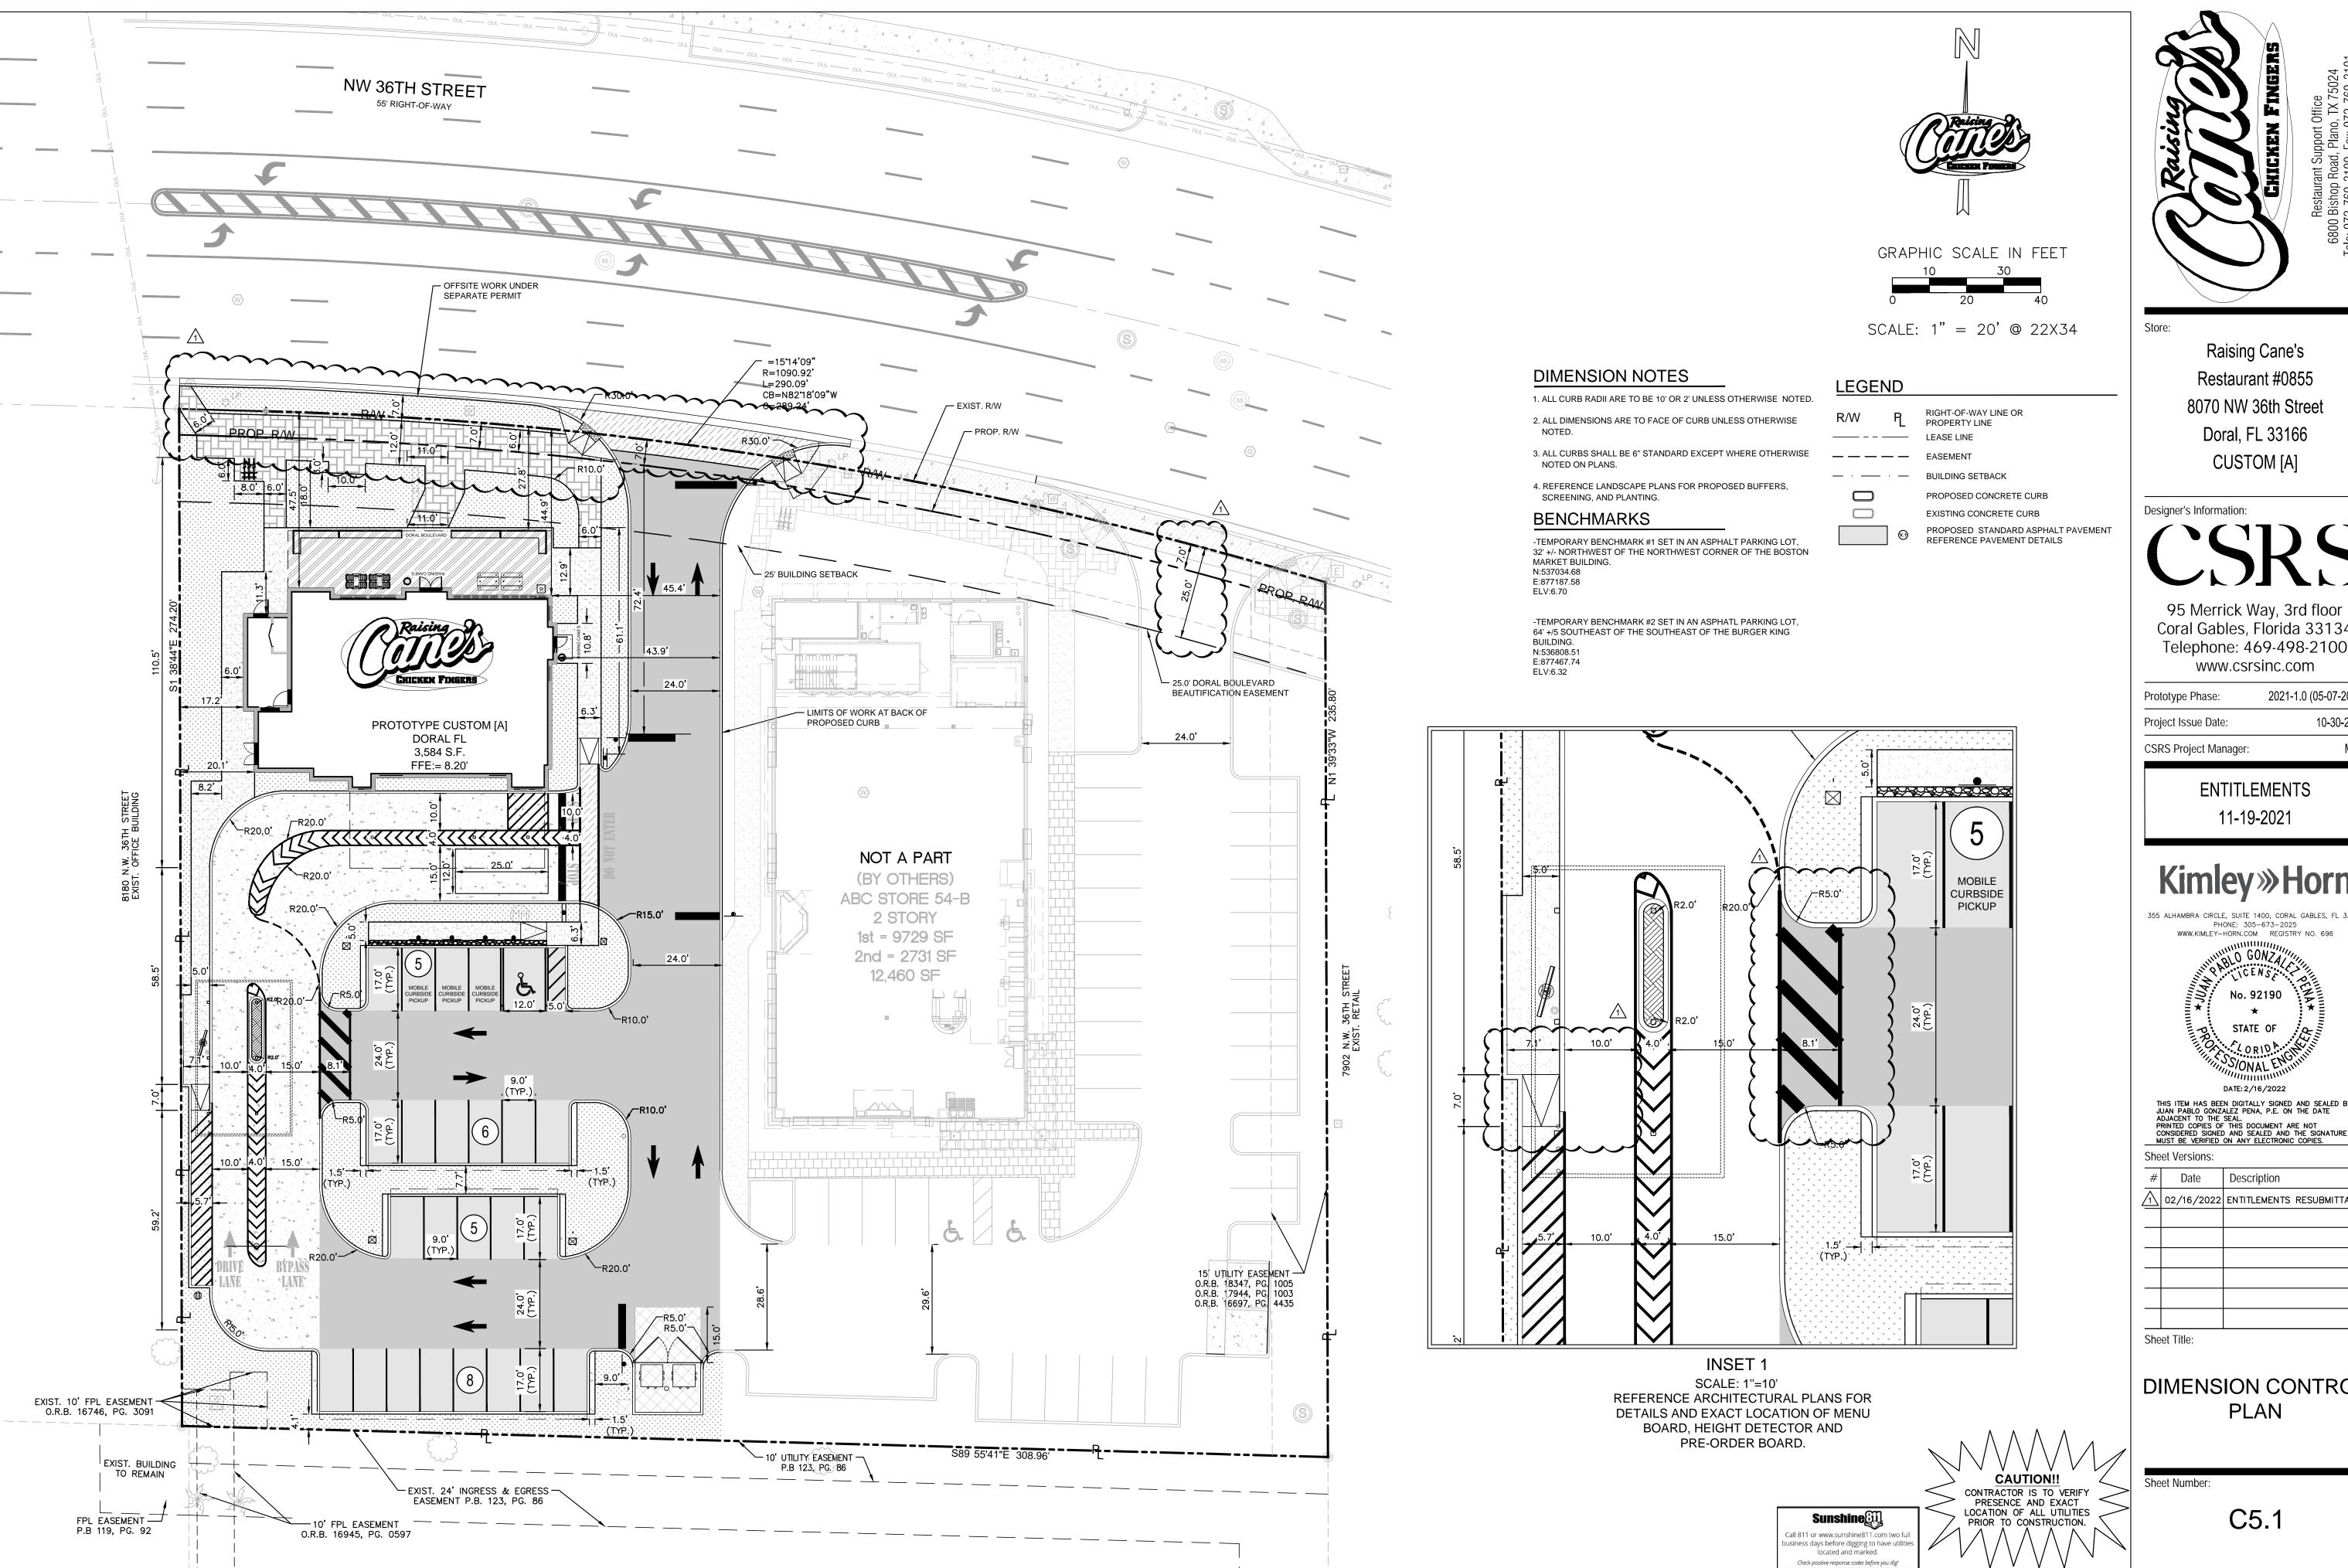
# Date Description 1 02/16/2022 ENTITLEMENTS RESUBMITTAL

Sheet Title:

SITE KEYNOTE PLAN

Sheet Number:

C5.0



Raising Cane's Restaurant #0855 8070 NW 36th Street Doral, FL 33166 CUSTOM [A]

Designer's Information:



Coral Gables, Florida 33134 Telephone: 469-498-2100 www.csrsinc.com

2021-1.0 (05-07-2021) Prototype Phase: 10-30-2021 Project Issue Date:

CSRS Project Manager:

**ENTITLEMENTS** 

11-19-2021

**Kimley** » Horn 355 ALHAMBRA CIRCLE, SUITE 1400, CORAL GABLES, FL 33134 PHONE: 305-673-2025 WWW.KIMLEY-HORN.COM REGISTRY NO. 696

STATE OF

DATE: 2/16/2022 THIS ITEM HAS BEEN DIGITALLY SIGNED AND SEALED BY JUAN PABLO GONZALEZ PENA, P.E. ON THE DATE ADJACENT TO THE SEAL.
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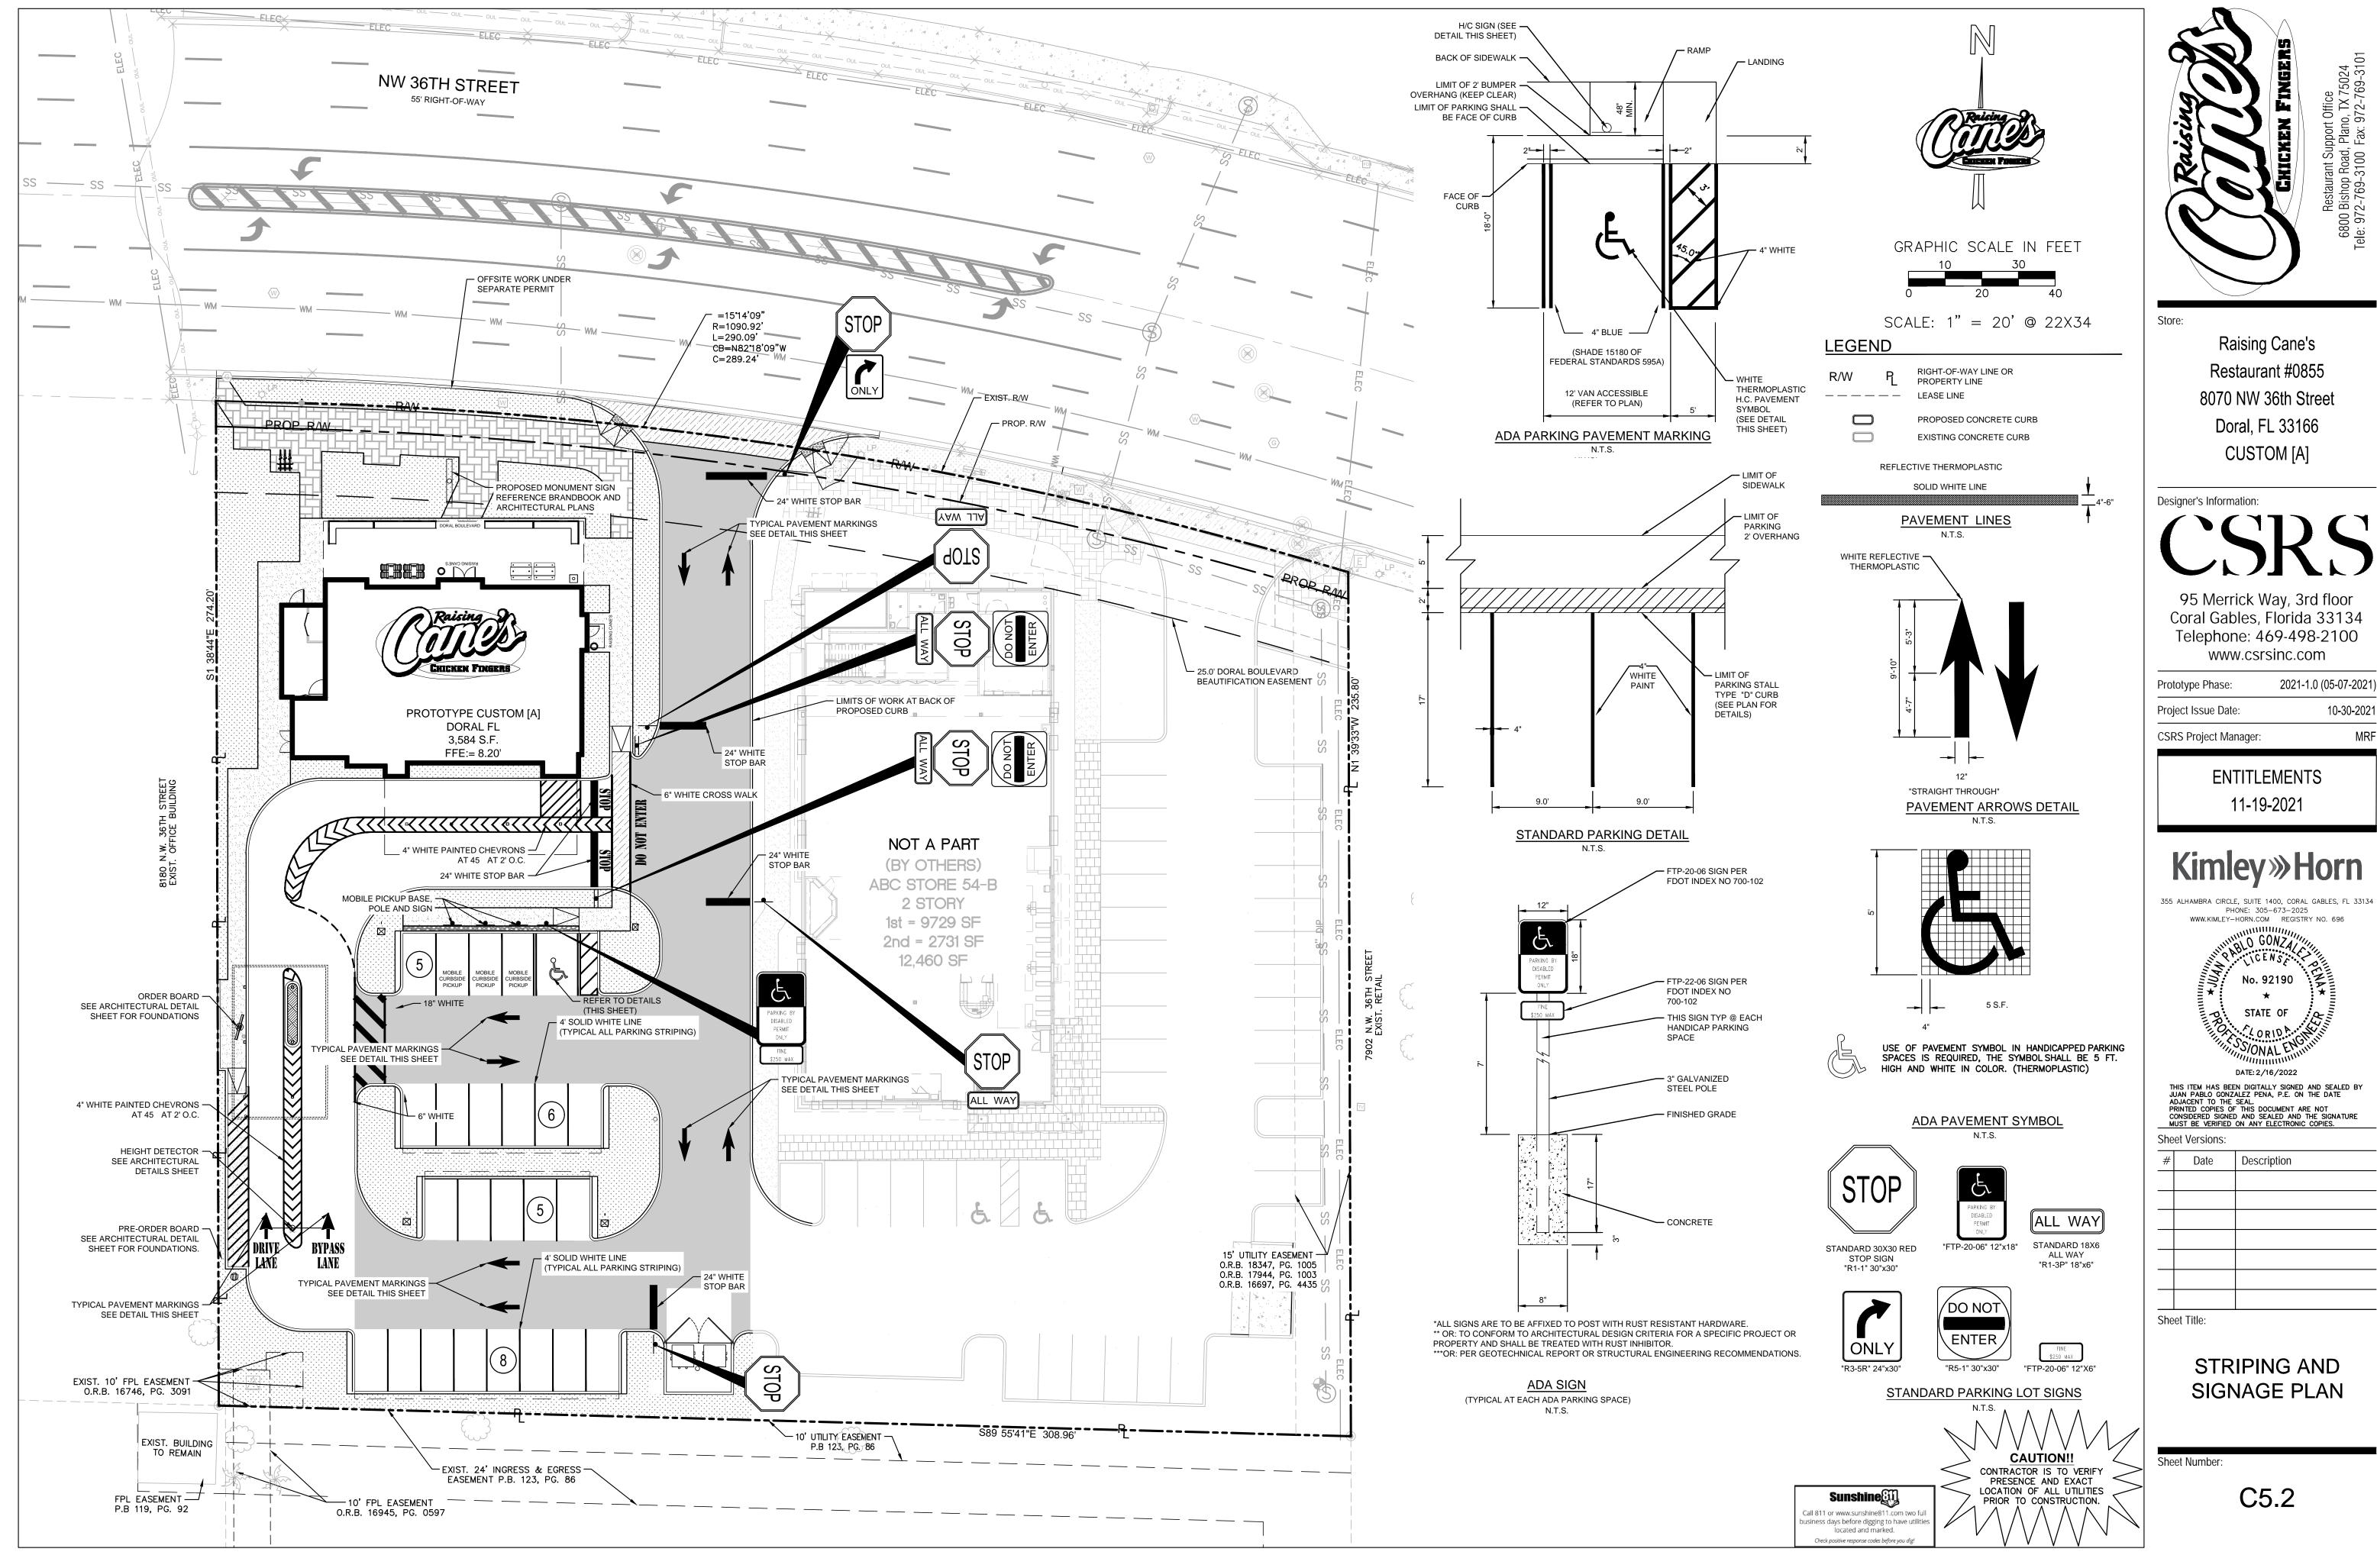
# Date Description 1 02/16/2022 ENTITLEMENTS RESUBMITTAL

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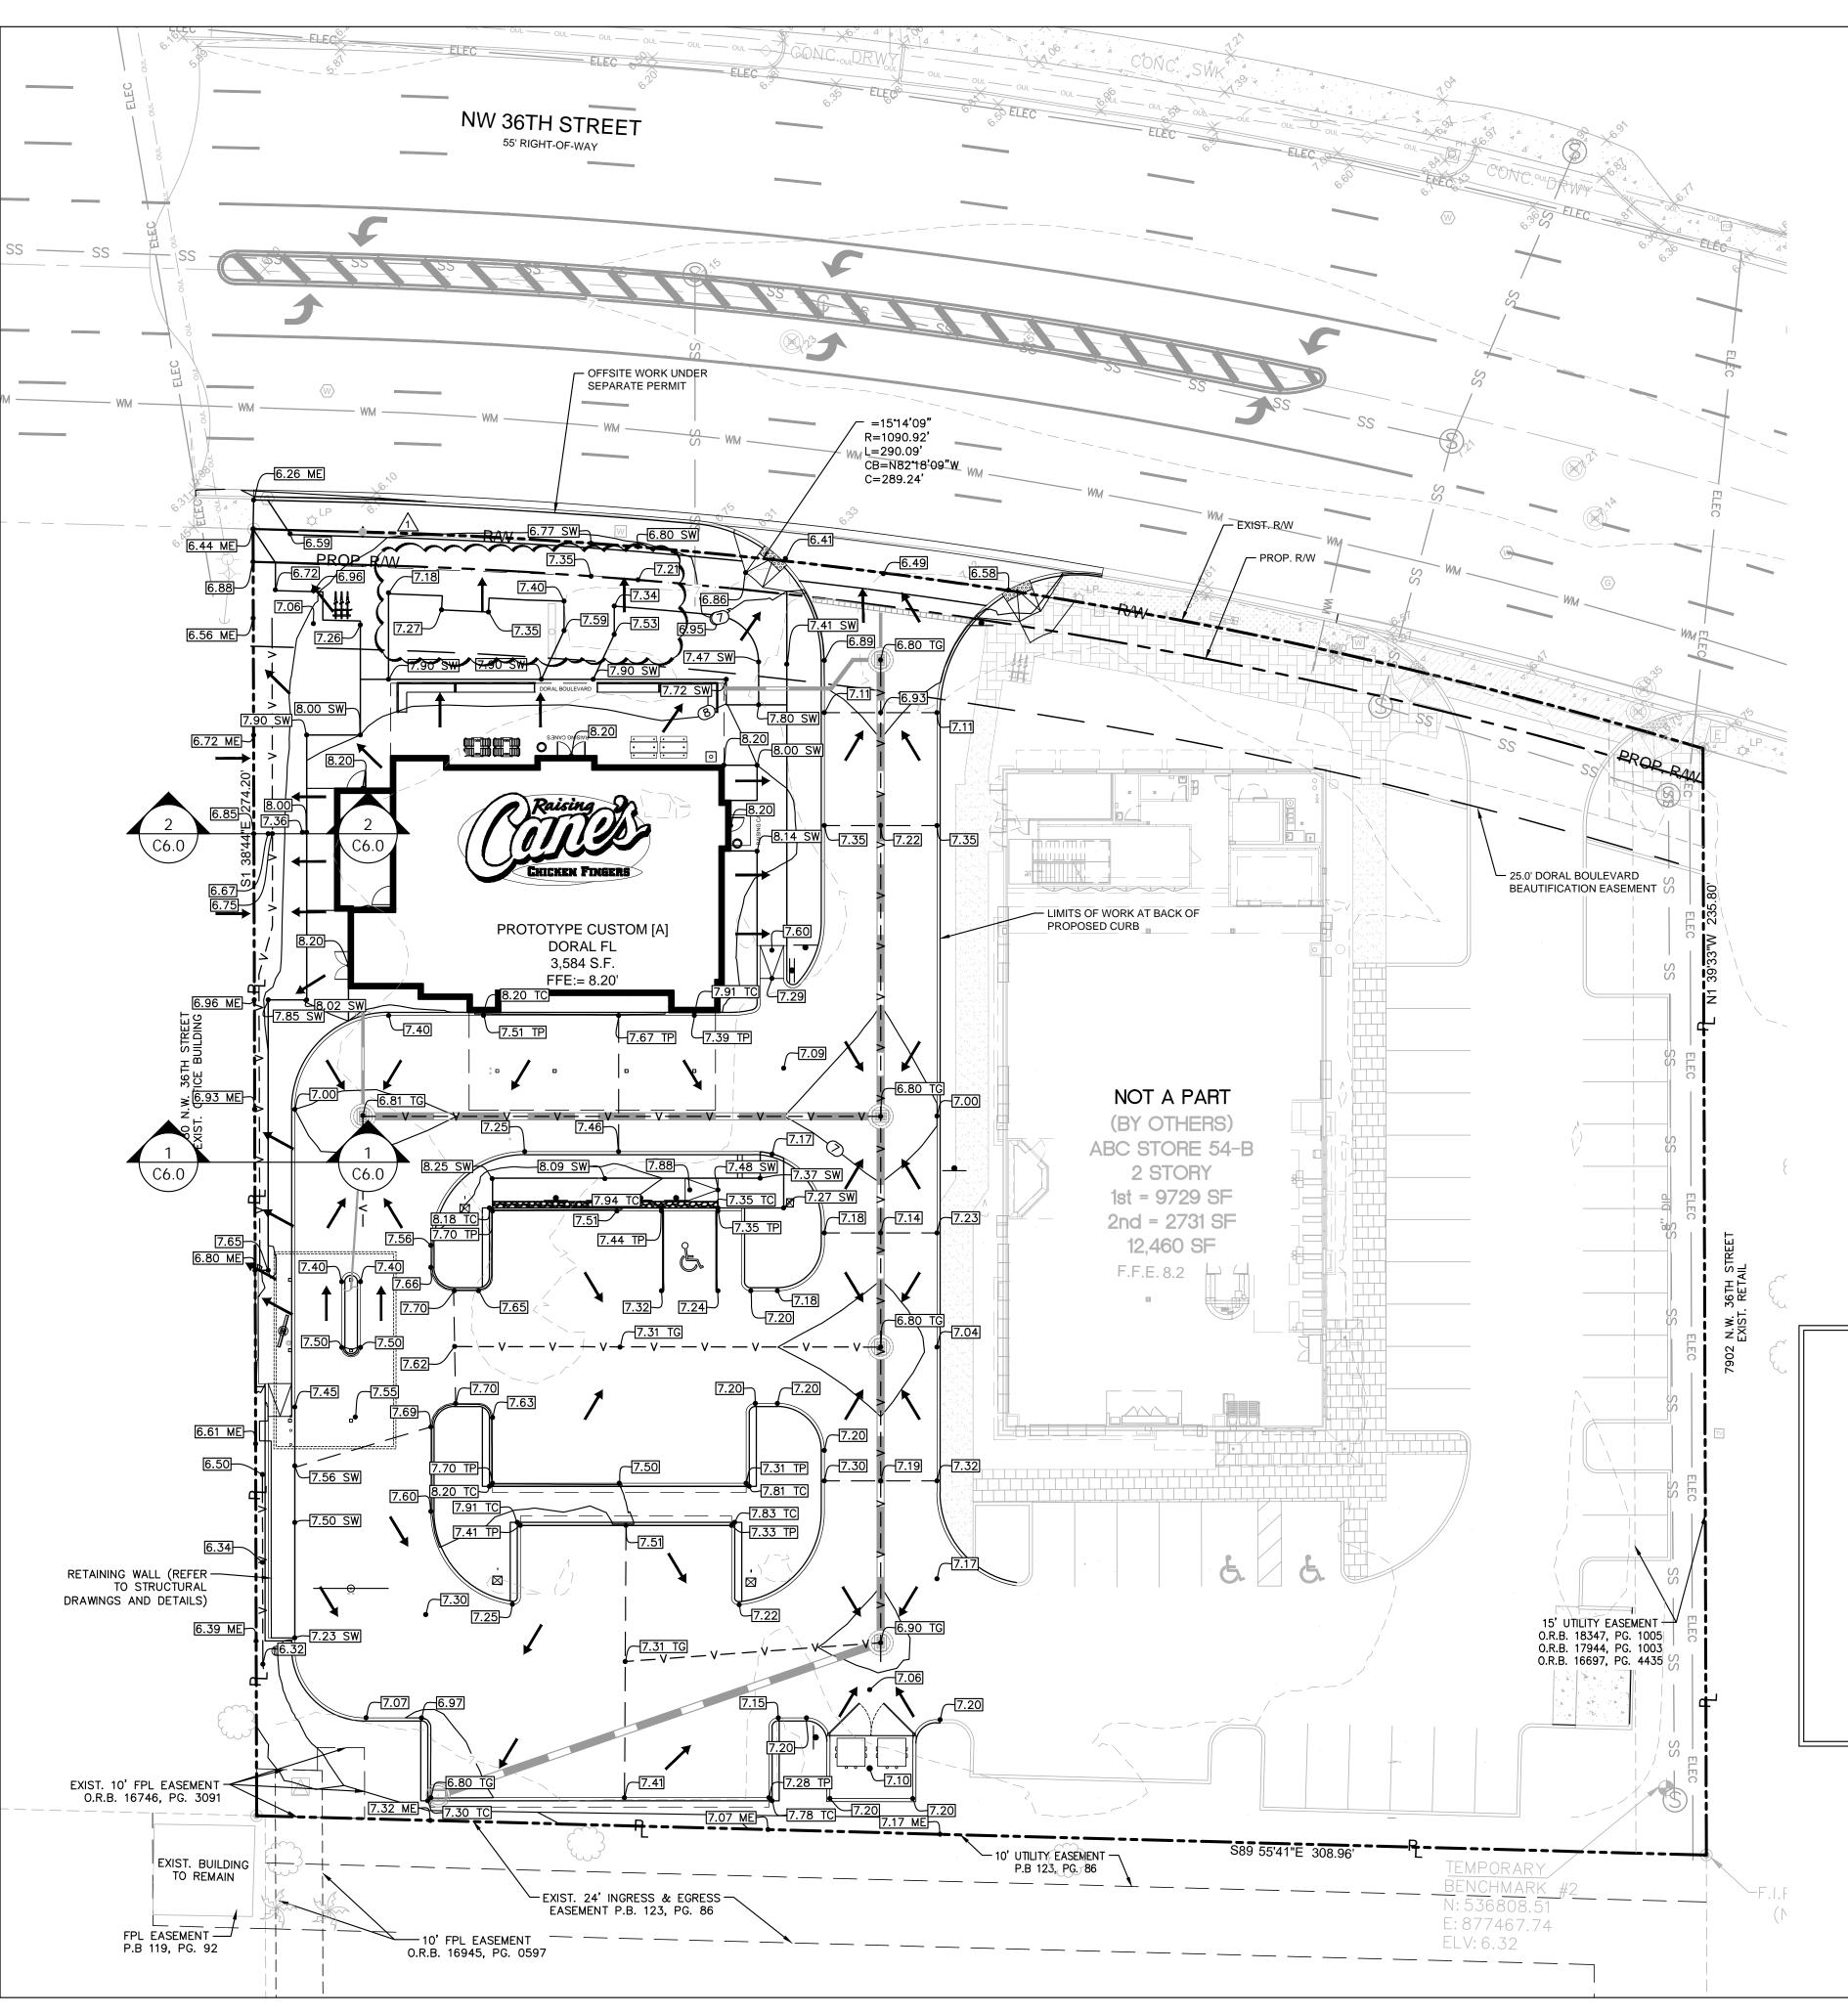
**DIMENSION CONTROL** PLAN

Sheet Number:

C5.1



2021-1.0 (05-07-2021) 10-30-2021



# **BENCHMARKS**

TEMPORARY BENCHMARK #1 SET IN AN ASPHALT PARKING LOT, 32' +/- NORTHWEST OF THE NORTHWEST CORNER OF THE BOSTON MARKET BUILDING. N:537034.68

E:877187.58 ELV:6.70

ELV:6.32

-TEMPORARY BENCHMARK #2 SET IN AN ASPHATL PARKING LOT, 64' +/5 SOUTHEAST OF THE SOUTHEAST OF THE BURGER KING N:536808.51 E:877467.74

## **GRADING NOTES**

- 1. ALL CONSTRUCTION TO BE IN ACCORDANCE WITH THESE PLANS AND THE CITY OF DORAL STANDARDS AND SPECIFICATIONS.
- PRIOR TO STARTING CONSTRUCTION, THE CONTRACTOR SHALL MAKE CERTAIN THAT ALL REQUIRED PERMITS AND APPROVALS HAVE BEEN OBTAINED. NO CONSTRUCTION OR FABRICATION SHALL BEGIN UNTIL THE CONTRACTOR HAS RECEIVED AND THOROUGHLY REVIEWED ALL PLANS AND OTHER DOCUMENTS APPROVED BY ALL OF THE PERMITTING AUTHORITIES. REFERENCE ARCHITECTURAL PLANS FOR DUMPSTER ENCLOSURE DETAILS.
- EXISTING THE GENERAL CONTRACTOR AND ALL SUB-CONTRACTORS SHALL VERIFY THE SUITABILITY OF ALL EXISTING AND PROPOSED SITE CONDITIONS INCLUDING GRADES AND DIMENSIONS BEFORE COMMENCEMENT OF ANY CONSTRUCTION. THE ENGINEER SHALL BE NOTIFIED IMMEDIATELY OF ANY DISCREPANCIES. MINOR ADJUSTMENTS TO FINISH GRADE TO ACCOMPLISH SPOT DRAINAGE ARE ACCEPTABLE, IF NECESSARY, UPON PRIOR APPROVAL OF ENGINEER. PAVING INSTALLED SHALL "FLUSH OUT" AT ANY JUNCTURE WITH EXISTING PAVING
- THE CONTRACTOR IS SPECIFICALLY CAUTIONED THAT THE LOCATION AND/OR ELEVATION OF EXISTING UTILITIES AS SHOWN ON THESE PLANS IS BASED ON RECORDS OF THE VARIOUS UTILITY COMPANIES, AND WHERE POSSIBLE, MEASUREMENTS TAKEN IN THE FIELD. THE INFORMATION IS NOT TO BE RELIED ON AS BEING EXACT OR COMPLETE THE CONTRACTOR MUST CALL THE APPROPRIATE UTILITY COMPANIES AT LEAST 72 HOURS BEFORE ANY EXCAVATION TO REQUEST EXACT FIELD LOCATION OF UTILITIES. IT SHALL BE THE RESPONSIBILITY OF THE CONTRACTOR TO RELOCATE ALL EXISTING UTILITIES WHICH CONFLICT WITH THE PROPOSED IMPROVEMENTS SHOWN ON THE PLANS.
- ALL CUT OR FILL SLOPES SHALL BE 4:1 OR FLATTER UNLESS OTHERWISE
- CONTRACTOR SHALL ADJUST AND/OR CUT EXISTING PAVEMENT AS NECESSARY TO ASSURE A SMOOTH FIT AND CONTINUOUS GRADE.
- CONTRACTOR SHALL ASSURE POSITIVE DRAINAGE AWAY FROM BUILDINGS FOR ALL NATURAL AND PAVED AREAS.
- TOPOGRAPHIC INFORMATION IS TAKEN FROM A TOPOGRAPHIC SURVEY BY LAND SURVEYORS. IF THE CONTRACTOR DOES NOT ACCEPT EXISTING TOPOGRAPHY AS SHOWN ON THE PLANS, WITHOUT EXCEPTION, THEN THE CONTRACTOR SHALL SUPPLY, AT THEIR EXPENSE, A TOPOGRAPHIC SURVEY BY A REGISTERED LAND SURVEYOR TO THE OWNER FOR REVIEW.
- 9. CONTRACTOR SHALL REFER TO ARCHITECTURAL PLANS FOR EXACT BUILDING FOOTPRINT DIMENSIONS.
- 10. CONTRACTOR SHALL REFER TO FINAL GEOTECH REPORT FOR BUILDING SUBGRADE AND SITE PREPARATION REQUIREMENTS.
- 11. CONTRACTOR SHALL ADJUST EXISTING VALVES, MANHOLE RIMS, ETC. AS NECESSARY TO MATCH FINISHED GRADE.
- ALL ELEVATIONS ARE TOP OF PAVEMENT UNLESS NOTED OTHERWISE. TO GET TOP OF CURB ELEVATIONS ADD 6" TO THE ELEVATION SHOWN.
- 13. GRADING FOR ALL SIDEWALKS AND ACCESSIBLE ROUTES INCLUDING CROSSING DRIVEWAYS SHALL CONFORM TO ADA STANDARDS. SLOPES SHALL NOT EXCEED 5% LONGITUDINAL SLOPE OR 2% CROSS SLOPE. SIDEWALK ACCESS TO EXTERNAL BUILDING DOORS SHALL BE ADA COMPLIANT. CONTRACTOR SHALL NOTIFY ENGINEER IMMEDIATELY IF ADA CRITERIA CANNOT BE MET AT ANY LOCATION.
- ANY PROPOSED CONTOURS SHOWN ARE APPROXIMATE. PROPOSED SPOT ELEVATIONS AND DESIGNATED GRADIENT ARE TO BE USED IN THE EVENT OF ANY DISCREPANCIES.
- 15. REFER TO EROSION CONTROL PLAN FOR EROSION CONTROL DEVICES TO BE INSTALLED PRIOR TO COMMENCING GRADING OPERATIONS.

ADJACENT SITE

16. ALL FILL TO BE PLACED SHALL BE IN ACCORDANCE WITH THE CURRENT APPLICABLE GEOTECHNICAL REPORT RECOMMENDATIONS.

SIDEWALK

THICKENED SIDEWALK DETAIL

N.T.S.

SECTION 1

SCALE: N.T.S.

THICKENED PORTION OF

CONCRETE SIDEWALK TO BE INCLUDED IN COST OF SIDEWALK

17. DO NOT BLOCK SWALE WITH LANDSCAPE.

CANE'S SITE

EXIST. -NATURAL GROUND

TOP OF CURB TOP OF PAVEMENT

**ENTITLEMENTS** 11-19-2021

# Kimley» Horn

Raising Cane's

Restaurant #0855

8070 NW 36th Street

Doral, FL 33166

CUSTOM [A]

www.csrsinc.com

2021-1.0 (05-07-2021)

10-30-2021

355 ALHAMBRA CIRCLE, SUITE 1400, CORAL GABLES, FL 33134 PHONE: 305-673-2025 WWW.KIMLEY-HORN.COM REGISTRY NO. 696



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**GRADING PLAN** 

Sheet Number:

Sheet Title:

C6.0

CAUTION!! CONTRACTOR IS TO VERIFY PRESENCE AND EXACT LOCATION OF ALL UTILITIES PRIOR TO CONSTRUCTION. Call 811 or www.sunshine811.com two siness days before digging to have utiliti located and marked.


CONCRETE SIDEWALK


<u>SWALE</u>


N.T.S.


SECTION 2

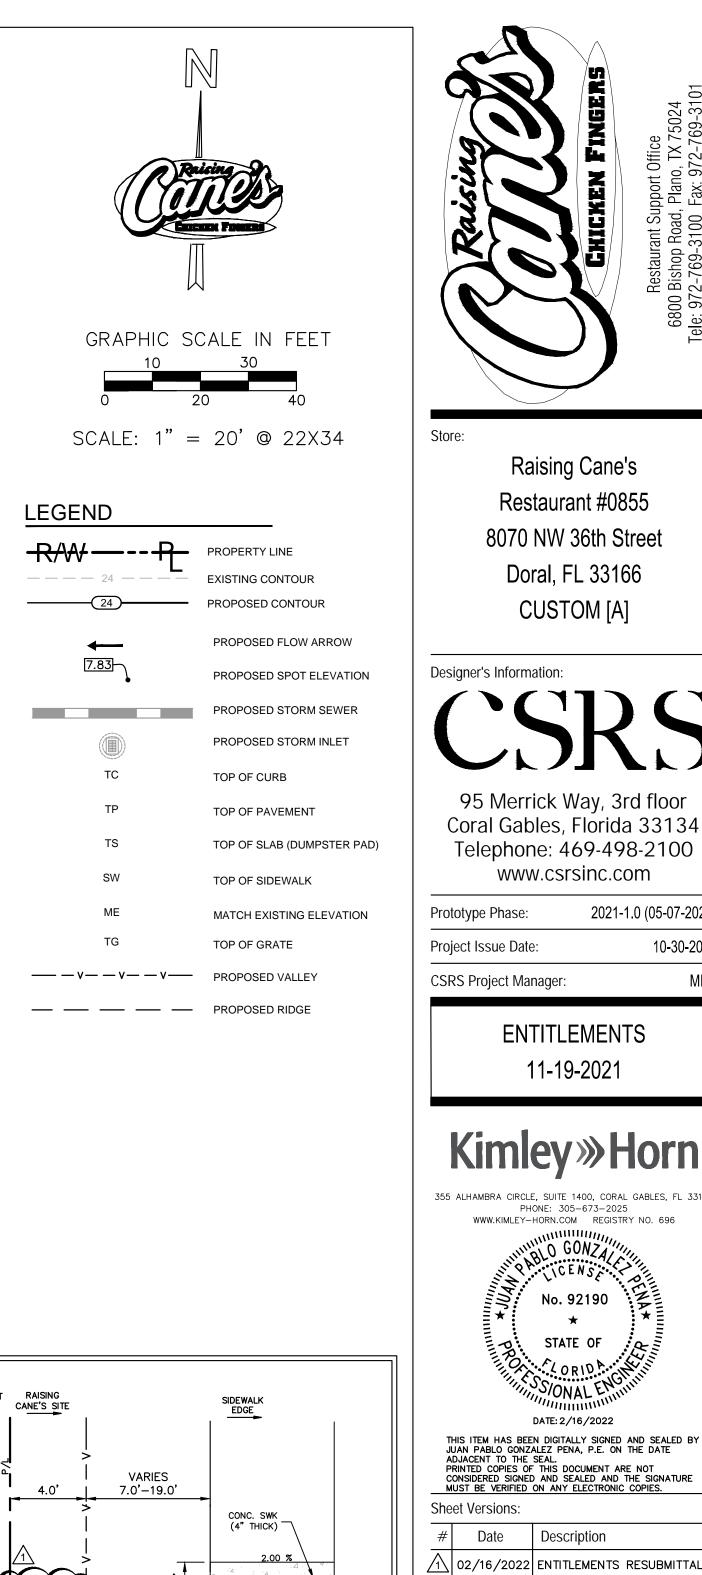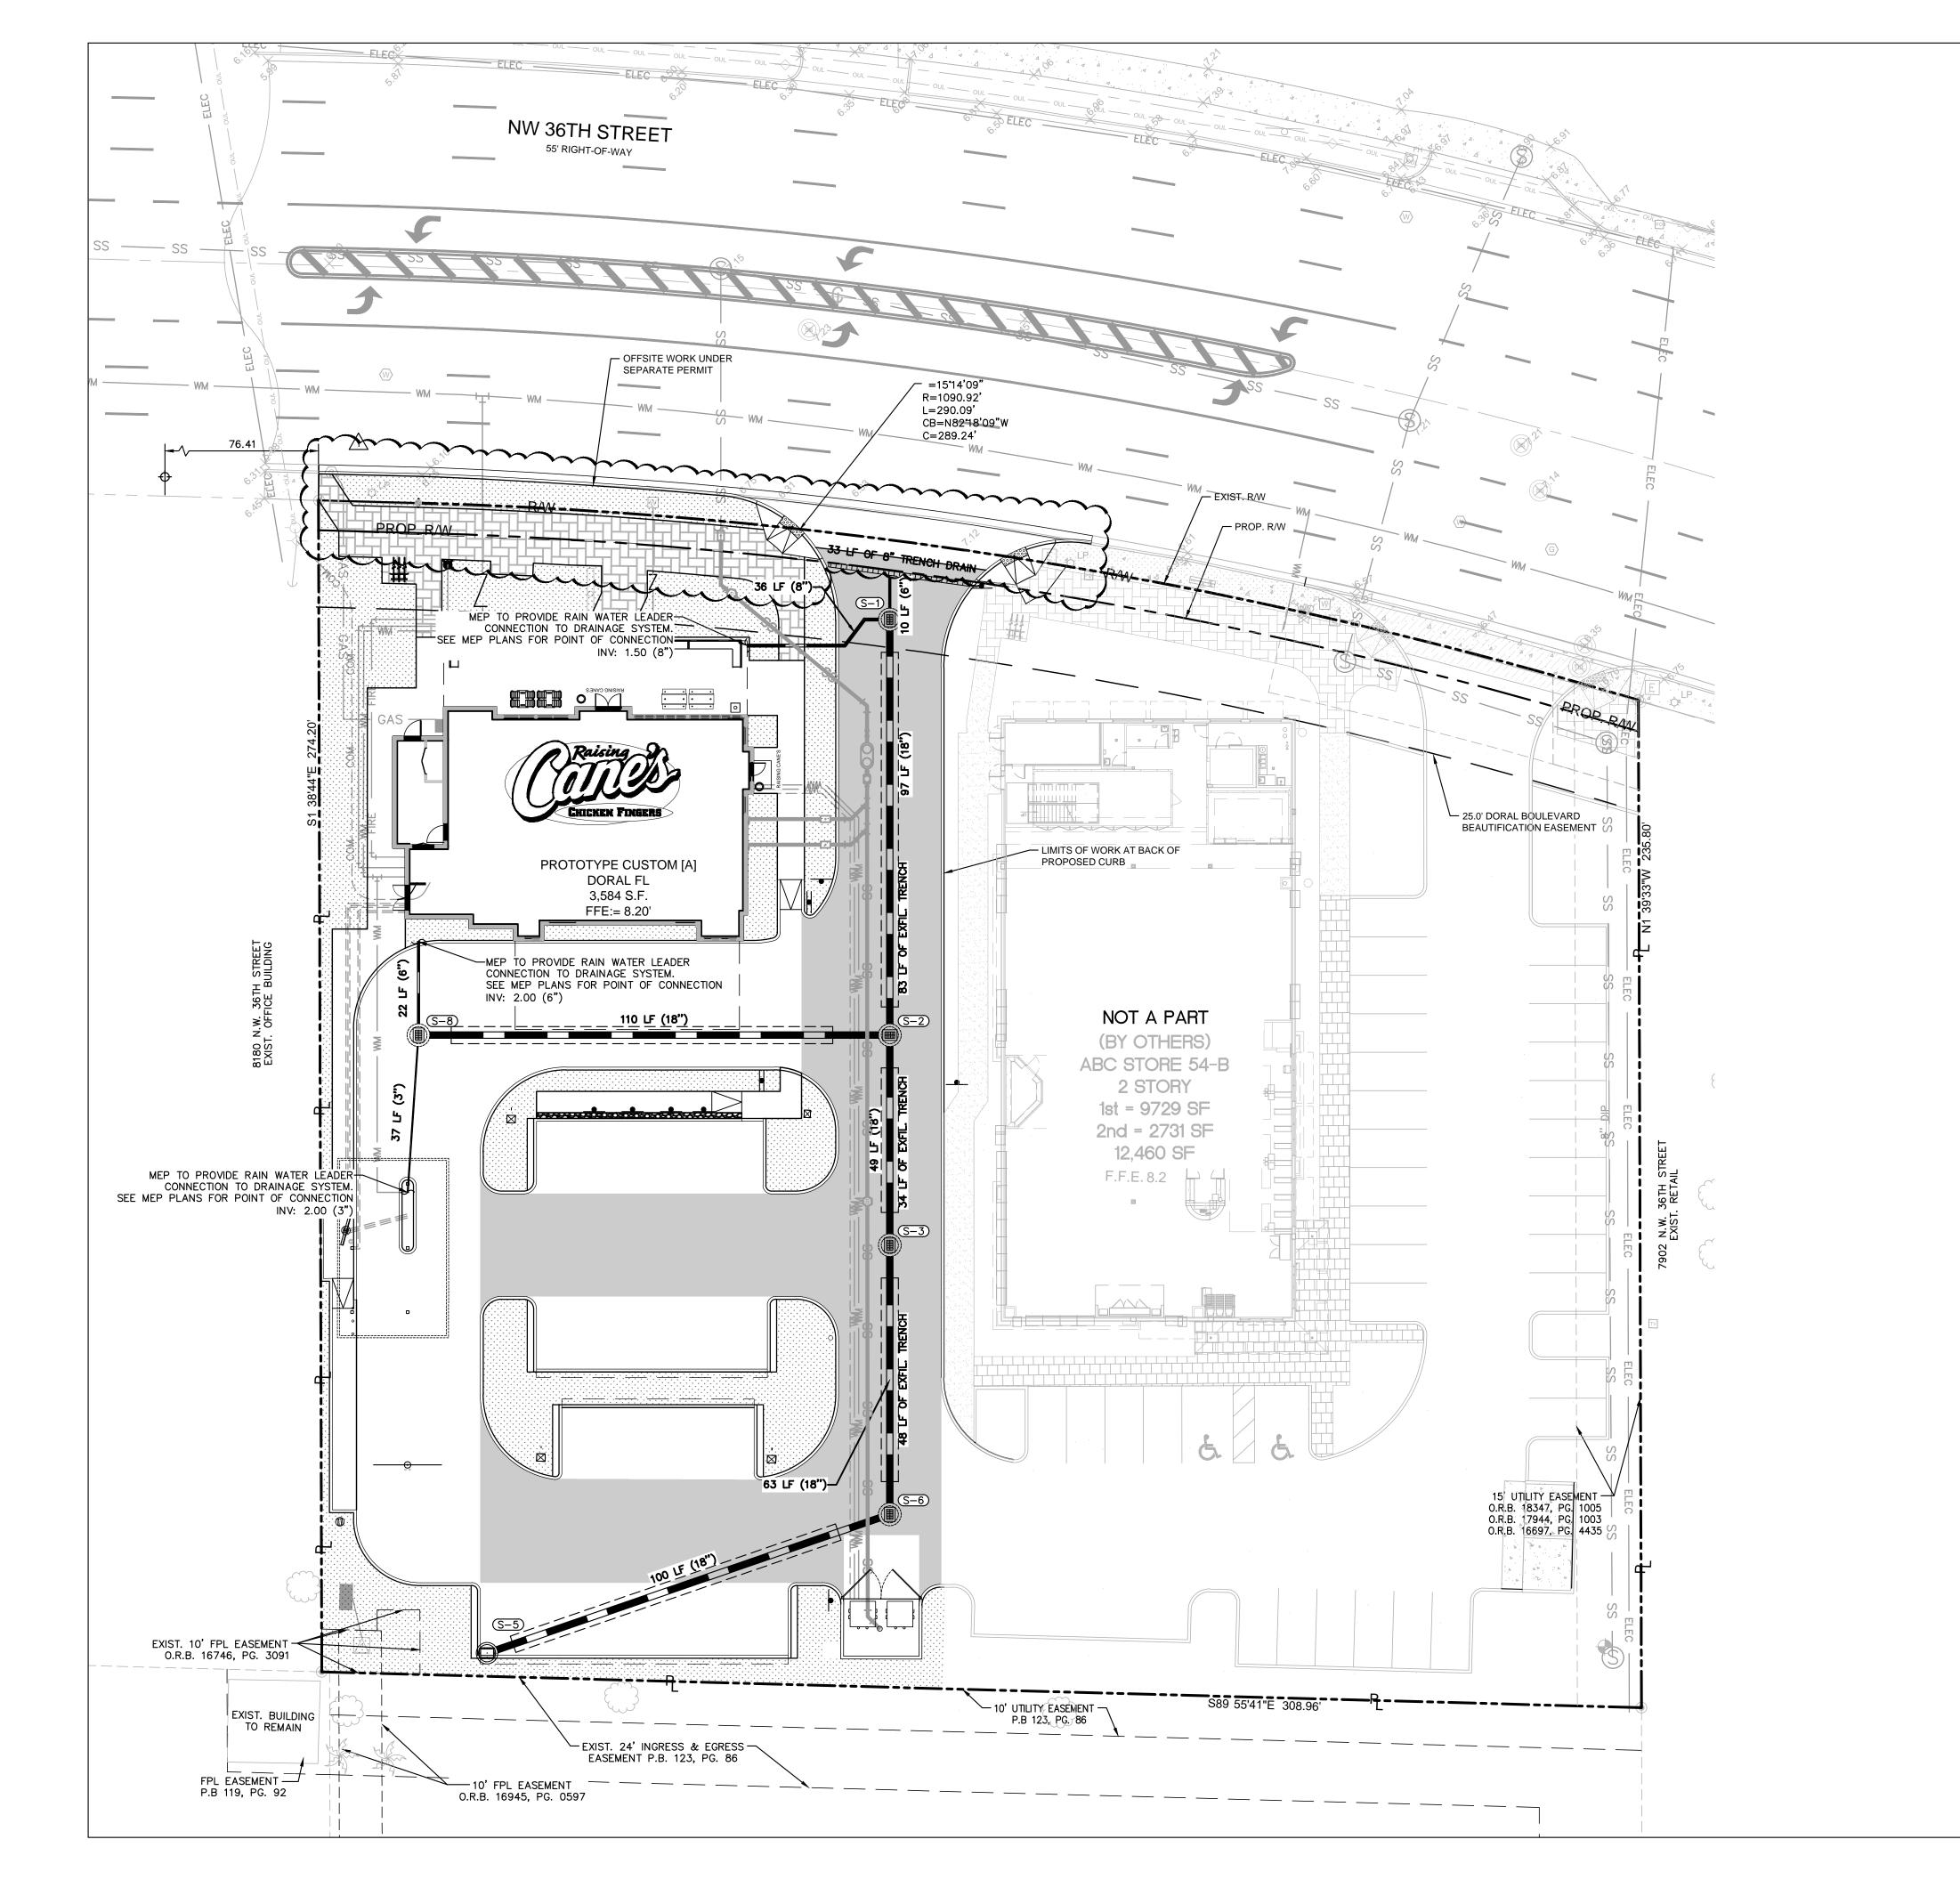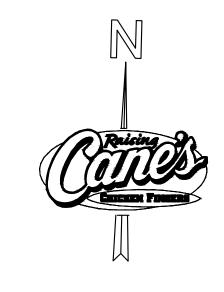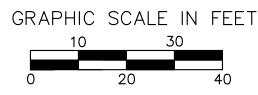SCALE: N.T.S.









SCALE:  $1" = 20' \oplus 22X34$ 

# **LEGEND**

RIGHT-OF-WAY LINE OR PROPERTY LINE BUILDING SETBACK

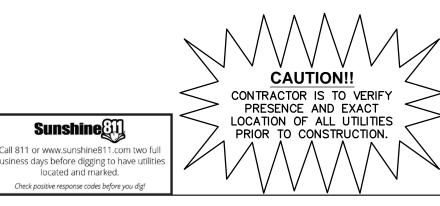
PROPOSED LINEAR TRENCH DRAIN (TO BE 8" ACO K200 DRAIN OR APPROVED EQUIVALENT) PROPOSED EXFILTRATION TRENCH AND HDPE DRAINAGE PIPE (U.O.N.) REFER TO DETAILS

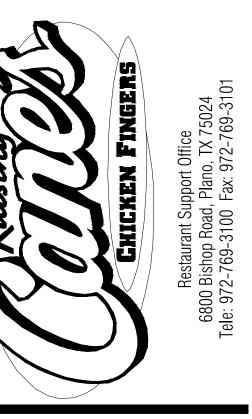
PROPOSED STORM SEWER MANHOLE

PROPOSED STORM SEWER INLET

|                  | DRAINAGE STRUCT   | JRE TABLE     |   |        |
|------------------|---|---------------|---|--------|
| STRUCTURE NUMBER | STRUCTURE TYPE  | RIM ELEVATION | INVERT ELEVATION                                      | воттом |
| S-1              | CATCH BASIN (4' DIA.) W/ USF<br>4105 FRAME AND 6627 GRATE | RIM = 6.80    | (8") 3.73 (W) *<br>(18") 2.00 (S)*<br>(6") 1.50 (N)   | -2.00  |
| S-2              | CATCH BASIN (5' DIA.) W/ USF<br>4105 FRAME AND 6627 GRATE | RIM = 6.80    | (18") 2.00 (N)*<br>(18") 2.00 (S)*<br>(18") 2.20 (W)  | -1.50  |
| S-3              | CATCH BASIN (5' DIA.) W/ USF<br>4105 FRAME AND 6627 GRATE | RIM = 6.80    | (18") 2.00 (N)*<br>(18") 2.00 (S)*                    | -1.50  |
| S-5              | TYPE P9 CURB INLET (4' DIA) INDICES 425-010 & 425-024     | RIM = 6.83    | (18") 2.00 (E)*                                       | -3.17  |
| S-6              | CATCH BASIN (5' DIA.) W/ USF<br>4105 FRAME AND 6627 GRATE | RIM = 6.90    | (18") 2.00 (W)*<br>(18") 2.00 (N)*                    | -1.50  |
| S-8              | CATCH BASIN (4' DIA.) W/ USF<br>4105 FRAME AND 6627 GRATE | RIM = 6.80    | (18") 2.20 (E)*<br>(3") 2.00 (S) *<br>(6") 2.00 (N) * | -1.50  |

located and marked.





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Sheet Title:

STORM DRAINAGE PLAN

Sheet Number:

C7.0

<sup>\*</sup> POLLUTION RETARDANT BAFFLE (PRB) REQUIRED (REFER TO DETAILS)

(NOT A PART OF M-DWASD NOTES NOR APPROVAL)

1. THE CONTRACTOR SHALL MAKE EVERY REASONABLE EFFORT TO PERFORM THE WORK AND MAINTAIN SAFETY TO THE PUBLIC AND WORKERS, AND THE PROTECTION OF PROPERTY THROUGHOUT CONSTRUCTION. ALL WORK SHALL BE PERFORMED IN ACCORDANCE WITH OSHA STANDARDS, AS APPLICABLE. CONTRACTOR MUST COMPLY WITH TRENCH SAFETY ACT.

2. ALL UTILITY CROSSING LINES IDENTIFIED ON PLANS AND PROFILES ARE BASED ON BEST AVAILABLE INFORMATION. CONTRACTOR SHALL VERIFY UTILITY INFORMATION WITH APPROPRIATE UTILITIES AND SUNSHINE STATE ONE CALL CENTER OF FLORIDA 811. CONTRACTOR TO INCLUDE ON AS-BUILTS ACCURATE ELEVATION AND LOCATION OF ALL UTILITY CONFLICTS.

3. ALL UTILITIES DAMAGED BY CONSTRUCTION MUST BE PROMPTLY REPAIRED TO THE CONDITION EXISTING PRIOR TO THE DAMAGING OF THE UTILITY. REPAIRS ARE INCIDENTAL TO THE INSTALLATION OF THE MAIN AND EXTENSIONS AND SHALL BE REPAIRED AT NO COST TO THE OWNER.

4. ALL EXISTING MANHOLES, ELECTRIC BOXES, METER BOXES, AND VALVE BOXES SHALL BE ADJUSTED TO THE PROPOSED GRADE.

5. PROPERTY DAMAGE RESULTING FROM WORK REQUIRED BY THIS CONTRACT SHALL BE CLEANED UP, REPAIRED OR REPLACED AT NO COST TO OWNER.

6. CONTRACTOR SHALL PROVIDE ALL MAINS, ALL FITTINGS, ATTACHMENTS, AND EQUIPMENT REQUIRED TO PERFORM TESTING PER M-DWASD STANDARDS. PIPE AND FITTINGS SHALL BE RESTRAINED IN ACCORDANCE WITH M-DWASD STANDARD DETAIL GS 2.0 (1 THRU 5 OF 5)

7. THE CONTRACTOR IS RESPONSIBLE FOR THE COST OF ALL INSPECTIONS.

8. ALL TRENCHES TO BE OVER-EXCAVATED A MINIMUM OF 6" TO PROVIDE FOR INSTALLATION OF ROCK BEDDING IN ACCORDANCE WITH M-DWASD STANDARDS.

9. SURFACE RESTORATION, PAVEMENT REPLACEMENT, SIDEWALK REPLACEMENT, TRENCH BACKFILLING AND COMPACTION SHALL COMPLY WITH M-DWASD STANDARD DETAILS GS1.9, SS18.0, A1.0, A1.1 AND A4.0, M-DCPWD STANDARD DETAIL R21.1 AND THE APPLICABLE CURRENT CITY OF MIAMI PUBLIC WORKS, M-DCPWD AND FDOT STANDARDS.

10. CONTRACTOR SHALL FIELD VERIFY THE HORIZONTAL AND VERTICAL LOCATIONS OF EXISTING SEWER LATERALS PRIOR TO THE CONSTRUCTION OF THE SANITARY SEWER CONNECTIONS. CONTRACTOR SHALL ADJUST THE ALIGNMENT OF THE SEWER CONNECTION AND PROVIDE THE REQUIRED FITTINGS AND CLEANOUTS AS NEEDED. ALL MODIFICATIONS TO ALIGNMENT SHALL BE CLEARLY RECORDED IN THE AS-BUILT DOCUMENTS.

11. THE APPROXIMATE LOCATION OF EXISTING UTILITIES SHOWN ON THE PLANS WERE PROVIDED BY THE RESPECTIVE UTILITY COMPANIES. THE EXACT HORIZONTAL AND VERTICAL LOCATIONS SHALL BE DETERMINED BY THE CONTRACTOR PRIOR TO CONSTRUCTION. IN ADDITION. THE CONTRACTOR SHALL BE RESPONSIBLE FOR VERIFYING IF "OTHER" UTILITIES (NOT SHOWN IN THE PLANS) EXIST WITHIN THE AREA OF CONSTRUCTION. SHOULD THERE BE UTILITY CONFLICTS THAT WERE NOT ANTICIPATED. THE CONTRACTOR SHALL NOTIFY THE ENGINEER IMMEDIATELY.

12. THE PERMITTEE WILL ENSURE THAT NO UNSAFE AREA(S) FOR PEDESTRIAN WILL REMAIN DURING ANY TIME OF CONSTRUCTION. PEDESTRIAN CONTROL FOR CLOSURE OF ROADS AND SIDEWALKS SHALL BE IN ACCORDANCE WITH THE F.D.O.T. ROADWAY AND TRAFFIC DESIGN STANDARDS INDEX SERIES 600.

13. ACCESS TO REMAIN OPEN AT ALL TIMES. THE PERMITTEE SHALL PROVIDE AND MAINTAIN SAFE TEMPORARY ACCESS TO ALL ADJACENT PROPERTY AT ALL TIMES AND SHALL MAINTAIN ACCOMMODATIONS FOR INTERSECTING AND CROSSING TRAFFIC WITHIN THE CONSTRUCTION ZONE. NO ROAD OR STREET CROSSING SHALL BE BLOCKED OR UNDULY RESTRICTED AS DETERMINED BY THE ENGINEER.

# **RER-DERM WATER-SEWER GENERAL NOTES**

- 1. A horizontal distance of at least 6 feet, and preferably 10 feet (outside to outside), shall be maintained between gravity or pressure sewer pipes and water pipes. The minimum horizontal separation can be reduced to 3 feet for vacuum-type sewers or for gravity sewers where the top of the sewer pipe is at least 6 inches below the bottom of the water pipe. When the above specified horizontal distance criteria cannot be met due to an existing underground facility conflict, smaller separations are allowed if one of the following
- a) The sewer pipes are designed and constructed equal to the water pipe and pressure tested at 150 psi. b) The sewer is encased in a watertight carrier pipe or concrete.
- c) The top of the sewer is at least 18 inches below the bottom of the water pipe
- 2. A vertical distance of at least 12 inches (outside to outside) shall be maintained between any water and sewer mains with sewer pipes preferably crossing under water mains. The minimum vertical separation can be reduced to 6 inches for vacuum-type sewers or for gravity sewers where the sewer pipe is below the water main. The crossing shall be arranged so that all water main joints are at least 6 feet from all joints in gravity and pressure sewer pipes. This distance can be reduced to 3 feet for vacuum-type sewers. When the above specified vertical distance criteria cannot be met due to an existing underground facility conflict, smaller separations
- a) The sewer pipes are designed and constructed equal to the water pipe and pressure tested at 150 psi. b) The sewer is encased in a watertight carrier pipe or concrete.
- 3. Air release valves shall be provided at high points of new force main sanitary sewers.
- 4. Gravity sanitary sewers constructed within a public wellfield protection area shall be C-900 PVC or Ductile Iron Pipe. The maximum allowable exfiltration rate of gravity sanitary sewers constructed in a public wellfield protection area shall be a) Residential Land Uses. Fifty (50) gallons per inch pipe diameter per mile per day, based on a minimum two (2) hour test having a minimum of two (2) feet of positive head above the crown of the pipe.
- b) Non-Residential Land Uses. Twenty (20) gallons per inch pipe diameter per mile per day, based on a minimum two (2) hour test having a minimum of two (2) feet of positive head above the crown of the pipe.
- c) Any observed leaks or any obviously defective joints or pipes shall be replaced even when the total leakage is below that allowed.
- 5. The maximum allowable exfiltration rate of gravity sanitary sewers constructed outside a public wellfield protection area shall be one hundred (100) gallons per inch pipe diameter per mile per day, based on a minimum two (2) hour test having a minimum of two (2) feet of positive head above the crown of the pipe. Any observed leaks or any obviously defective joints or pipes shall be replaced even when the total leakage is below that allowed.
- 6. Forcemain sanitary sewers constructed within a public wellfield protection area shall be ductile iron, C-900 PVC, HDPE or reinforced concrete pressure sewer pipes.
- 7. The maximum allowable exfiltration/leakage rate of forcemain sanitary sewers shall be:
- a) Ductile Iron, C-900 PVC, HDPE and PVC Pipe. The allowable leakage rate specified in American Water Works Association Standard (AWWAS) C600-82 at a test pressure of 100 psi for a duration of not less than two (2) hours
- b) Reinforced Concrete Pressure Pipe. Half (1/2) the allowable leakage rate specified in AWWA C600-82 at a test pressure of 100 psi for a duration of not less than two (2) hours. c) Any observed leaks or any obviously defective joints or pipes shall be replaced even when the total leakage is below that allowed.
- 8. The contractor shall verify nature, depth, and character of existing underground utilities prior to start of construction.
- 10. If any area of the work site is found to contain buried solid waste and/or ground or ground water contamination, the following shall

9. In no case shall a contractor install utility pipes, conduits, cables, etc. in the same trench above an existing water or sewer pipe

- a) All work in the area shall follow all applicable safety requirements (e.g., OSHA, etc.) and notification must be provided to the appropriate agencies
- b) Immediately notify the Environmental Monitoring and Restoration Division (EMRD). The EMRD can be contacted at (305) 372-6700.
- c) If contaminated soils and/or buried solid waste material is excavated during construction, then they require proper handling and disposal in accordance with the local, state and federal regulations. Be advised that the landfill owner/operator is the final authority on disposal and may have requirements beyond those provided by herein. If disposal within a Miami-Dade County owned landfill (Class I landfill) is appropriate and selected, please contact the Miami-Dade County Department of Solid Waste Management at (305) 594-6666 for information.
- d) The reuse of contaminated soils that are not returned to the original excavation requires prior approval of a Soil Management Plan from the Environmental Monitoring and Restoration Division. The EMRD can be contacted at (305) 372-6700.
- 11. Pumps must comply with the National Electrical Code (NEC) requirements for Class I, Group D, Division 1 locations (Explosion Proof).
- 12. The contractor is advised that a Tree Removal/Relocation Permit may be required prior to the removal and/or relocation of tree resources. Prior to removing or relocating any trees, the Contractor shall notify the Tree and Forest Resources Section of DERM at (305) 372-6574 or via e-mail at: tfrs@miamidade.gov, or contact the municipality with tree ordinance jurisdiction to obtain any required permits. Those trees not interfering with the construction shall be protected in place in accordance with the provisions of Section 24-49.5 of the Miami-Dade Code.
- 13. Please note that the demolition, removal, and/or disturbance of existing underground utilities that contain asbestos-cement pipes (ACP) are subject to the provisions of 40 CFR-61 Subpart M. Therefore, pursuant to the provisions of 40 CFR-61-145, a NOTICE OF DEMOLITION OR ASBESTOS RENOVATION form must be filed with the Air Quality Management Division (AQMD) of DERM, at least ten (10) working days prior to starting of any work. Note that the backfilling and burial of crushed ACP would cause these locations to be considered active disposal sites and subject to 40 CFR-61.154, and 40 CFR-61.151 a year after project completion. Existing standard operating procedures, as well as applicable federal, state and local regulatory criteria, must be followed and implemented to minimize any potential release of fugitive emissions, especially during project construction activities. The AQMD can be contacted via email at <u>asbestos@miamidade.gov</u> or 305-372-6925.

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REQUIREMENTS PER DEPARTMENT OF HEALTH

(NOT A PART OF M-DWASD REVIEW NOR APPROVAL)

### WATER MAIN HORIZONTAL SEPARATIONS

1. SEPARATIONS SHALL BE MEASURED OUTSIDE EDGE TO OUTSIDE EDGE.

- BETWEEN WATER MAINS AND, STORM SEWERS, STORMWATER FORCE MAINS, OR RECLAIMED WATER LINES, SHALL BE 3 FT. MINIMUM.
- BETWEEN WATER MAINS AND VACUUM TYPE SEWER PREFERABLY 10 FT. AND AT LEAST 3 FT. MINIMUM.
- GRAVITY OR PRESSURE SANITARY SEWERS, WASTEWATER FORCE MAINS OR RECLAIMED WATER PREFERABLY 10 FT. AND AT LEAST 6 FT. MAY BE REDUCED TO 3 FT. WHERE BOTTOM OF WATER MAIN IS AT LEAST 6 INCHES ABOVE TOP OF SEWER.
- 5. 10 FT. OF ANY PART OF ON-SITE SEWER TREATMENT OR DISPOSAL SYSTEM.

#### WATER MAIN VERTICAL SEPARATIONS

- 6. SEPARATIONS BETWEEN WATER MAINS AND GRAVITY SEWER, VACUUM TYPE SEWER, OR STORM SEWERS, TO BE PREFERABLY 12 INCHES,
- OR AT LEAST 6 INCHES ABOVE, OR AT LEAST 12 INCHES IF BELOW.\*

ALL MATERIALS AND LABOR UNDER THIS PROJECT SHALL BE IN STRICT ACCORDANCE WITH THE REQUIREMENTS OF THE

MIAMI-DADE WATER AND SEWER DEPARTMENT AND SHALL CONFORM TO THE STANDARDS AND SPECIFICATIONS AVAILABLE

3. ALL MAIN LINE VALVES SHALL BE INSTALLED COMPLETE WITH 10" RISER PIPES AND NO. 3 OR 53 VALVE BOXES FIRE

HYDRANTS AND SERVICE VALVES SHALL BE INSTALLED COMPLETE WITH 6" RISER PIPES AND NO. 2 VALVE BOXES.

4. ALL FORCE MAIN SERVICE CONNECTIONS INTO PRESSURE TRANSMISSION MAINS SHALL HAVE A SHUT OFF VALVE AND

6. ALL WATER METERS WILL BE INSTALLED BY THE MIAMI-DADE WATER AND SEWER DEPARTMENT, PROVIDING THE

7. FIRE HYDRANT REQUIREMENTS (NUMBER AND LOCATION) SHALL BE AS REQUIRED BY MIAMI-DADE COUNTY FIRE

AND ON FILE WITH THE DEPARTMENT. SUBMIT SHOP DRAWINGS FOR ALL MATERIALS.

5. ALL GRAVITY SYSTEMS SHALL BE CONSTRUCTED IN ACCORDANCE WITH DEPARTMENT STANDARDS.

2. COVER OVER WATER OR SEWER FORCE MAINS SHALL BE 4'-0" MIN.

CHECK VALVE AT THE POINT OF ENTRY.

APPROPRIATE CHARGES HAVE BEEN PREPAID.

- 7. PRESSURE SANITARY SEWER, WASTEWATER OR STORM WATER FORCE MAIN, OR RECLAIMED WATER, AT LEAST 12 INCHES ABOVE OR
- \* NOTE: CENTER 1 FULL LENGTH OF WATER MAIN PIPE AT CROSSINGS; ALTERNATIVELY ARRANGE PIPES SO JOINTS ARE AT LEAST 3 FEET FROM JOINTS IN VACUUM, STORM OR STORM FORCE MAINS. AT LEAST 6 FEET FROM JOINTS IN GRAVITY OF PRESSURE SEWERS, WASTEWATER FORCE MAINS OR RECLAIMED WATER.

#### TRENCH PROTECTION

TRENCH EXCAVATION PROTECTION SHALL BE ACCOMPLISHED AS REQUIRED BY THE PROVISIONS OF, PART 1926, SUBPART P, EXCAVATIONS, TRENCHING AND SHORING OF THE OCCUPATIONAL SAFETY AND HEALTH ADMINISTRATIONS STANDARDS AND INTERPRETATIONS.

> 1. AT THE COMPLETION OF ANY WATER AND SEWER JOB EITHER DONATION OR CONTRACT, THE CONTRACTOR SHALL a. RECORD DRAWING PRINTS WHICH HAVE BEEN SIGNED AND SEALED BY A FLORIDA LICENSED PROFESSIONAL SURVEYOR AND MAPPER (QTY. OF PRINTS AS REQUIRED BY THE DEPARTMENT).

### "RECORD DRAWING" FORMAT:

NOT A PART OF

APPROVAL

MDWASD NOTES OR

- a. 24"x 36" PRINTS
- b. PDF FILE c. CADD FILE (DWG OR DXF) ROTATED AND TRANSLATED TO STATE PLANE COORDINATES NAD 83 FLORIDA EAST
- d. THE WORDS "RECORD DRAWING" IN LARGE LETTERS e. TITLE BLOCK WITH DEPARTMENT DS, DW OR ER NUMBER AND PERTINENT INFORMATION
- f. Preferred scale to be 1"= 40' horizontally and 1"= 4' vertically\*
- g. STREET NOMENCLATURE h. SEPARATE RECORD DRAWINGS FOR WATER AND SEWER
- i. SEPARATE WATER AND SEWER PROFILE i. STATIONING STARTING WITH 0+00 AT PERMANENT REFERENCE POINT (I.E. &, \( \), ETC.) OR AS SHOWN ON
- DESIGN PERMIT PLANS. AND TO RUN CONTINUOUSLY TO END OF MAIN
- k. EASEMENTS, IF ANY, TIED TO PERMANENT REFERENCE POINT I. IDENTIFY ALL CONTROL LINES (I.E. BLDG. LINE, PROPERTY LINE, R/W, ETC.)
- m. ALL "PROPOSED" INFORMATION TO BE REMOVED FROM PRINTS, LEAVING ONLY RECORD DRAWING INFORMATION REFLECTED IN DRAWINGS

### 3. WATER "RECORD DRAWINGS" MUST INCLUDE:

- a. PLANS SHOWING PIPE SIZE, MATERIAL AND OFFSET OF MAIN, DEFLECTIONS (IF ANY), STATION OF SERVICES, HYDRANTS, VALVES, FITTINGS, IF ANY, ALL IN STATE PLANE COORDINATES. UTILITY CROSSINGS SHALL BE CLEARLY IDENTIFIED AND LOCATED.
- b. Profile showing top of ground and top of Pipe Elevations at Every 100' Station and at any CHANGE IN GRADE (WITH CORRESPONDING STATION), PIPE SIZE AND PIPE MATERIALS REFERENCED TO PLAN.

## 4. SEWER "RECORD DRAWINGS" MUST INCLUDE:

- a. PLAN SHOWING MANHOLE NUMBER. PIPE SIZE AND PIPE MATERIAL OF PIPE. DEFLECTION. SLOPE OF GRAVITY SEWER, LOCATION OF LATERALS WITH REFERENCE TO MANHOLE AND CLEANOUTS.
- b. The Northerly and Easterly Coordinates on all field obtained measurements and provided on ALL RECORD DRAWING SUBMITTALS
- c. PROFILE SHOWING MANHOLE NUMBER (AS PER PLAN). RIM AND INVERT ELEVATIONS (IF MORE THAN ONE INVERT, LABEL NORTH, SOUTH, ETC.), AND STATION STARTING AT 0+00 AT DOWNSTREAM MANHOLE.
- 5. FORCE MAIN "RECORD DRAWING" SAME AS WATER MAIN.
- 6. EACH RECORD DRAWING SHALL SHOW THE FLORIDA STATE PLANE COORDINATES (CURRENT READJUSTMENT) OF ALL THE MANHOLES AND VALVES AND OF AT LEAST TWO HORIZONTAL CONTROL POINTS PROPERLY IDENTIFIED AND LOCATED WITHIN THE PROJECT.

\* OTHER SCALE MAY BE PERMITTED, BUT MUST BE APPROVED BY THE DEPARTMENT PRIOR TO PREPARATION OF DRAWINGS.

| D1 1112 D217 | arringer i river i o | THE THUMBER        | 510 111111001 |          |               |            |
|--------------|----------------------|--------------------|---------------|----------|---------------|------------|
|              |                      |                    |               |          |               |            |
|              |                      |                    |               | ITEM     | CROSS<br>REF. | SPE<br>REF |
|              | <u>ISSUE DATE</u>    | <u>APPROVED BY</u> | STANDAR       | D DETAIL |               | <u></u>    |
|              | 03/11/2009           | V.F.C.             |               |          | G             | 2          |
| AMI-DADE     | 07/20/2016           | D.V.               | "RECORD       | DRAWING" | 0.            | .5         |

# FOR ALL PROJECTS WHERE

1. ALL EXISTING UTILITIES BEING REMOVED AND/OR RELOCATED MUST REMAIN ACTIVE AND IN SERVICE, UNTIL SUCH TIME WHEN

2. ALL WATER AND/OR SEWER FACILITIES LOCATED IN PRIVATE PROPERTY SHALL BE REMOVED AFTER ALL INSTALLED SERVICES FROM THEM HAVE BEEN TRANSFERRED TO THE ALREADY INSTALLED AND IN SERVICE NEW MAINS. ANY ASSOCIATED EXCLUSIVE EASEMENTS SHALL BE CLOSED AND RELEASED AFTER THE REMOVAL OF THE EXISTING WATER AND/OR SEWER FACILITIES.

WATER SERVICES AND/OR EXISTING WATER MAINS SUCH AS:

- CUT AND PLUGS
- WATER MAIN OFFSETS
- INTERCONNECTIONS
- SERVICE INSTALLATIONS/ RETIREMENTS/ SERVICE TRANSFERS
- HYDRANT INSTALLATIONS/ RETIREMENTS/ RELOCATIONS
- ANY WORK THAT MAY AFFECT THE QUALITY AND/OR QUANTITY OF WASD'S WATER, TRANSMISSION AND DISTRIBUTION SYSTEM

SHALL BE PREFORMED BY A LICENSED CONTRACTOR UNDER THE SUPERVISION OF WASD LICENSED OPERATOR AND WASD DONATIONS INSPECTOR UNDER THE SCOPE AND JURISDICTION OF THE CONTRACTOR'S RIGHT-OF-WAY PERMIT. PRIOR TO ANY WORK BEING DONE. THE LICENSED CONTRACTOR SHALL COORDINATE WITH WASD DONATION INSPECTOR FOR THE SCHEDULING OF LICENSED OPERATOR TO BE PRESENT FOR PROPOSED ACTIVITY.

CONTRACTOR IS TO VERIFY PRESENCE AND EXACT LOCATION OF ALL UTILITIES PRIOR TO CONSTRUCTION. all 811 or www.sunshine811.co ness days before digging to have utilit located and marked

NOTE

ALL EXISTING MAINS BEING IMPACTED BY THIS PROJECT AND ALL PROP WATER AND SEWER FORCE MAINS AND FITTINGS TO BE RESTRAINED PER GS 2.0

# NOTE

NO TREES NOR STRUCTURES CAN BE IN ANY MDWASD EASEMENT (TYP.)

## NOTE

VERTICAL SEPARATIONS AT ALL CROSSINGS TO COMPLY WITH MDWASD GS 2.5 SHEET 2 OF 2

Raising Cane's Restaurant #0855 8070 NW 36th Street Doral, FL 33166 CUSTOM [A]

Designer's Information:

Store:

Coral Gables, Florida 33134 Telephone: 469-498-2100 www.csrsinc.com

95 Merrick Way, 3rd floor

2021-1.0 (05-07-2021) Prototype Phase:

10-30-2021 Project Issue Date:

CSRS Project Manager:

11-19-2021

**ENTITLEMENTS** 

355 ALHAMBRA CIRCLE, SUITE 1400, CORAL GABLES, FL 33134 PHONE: 305-673-2025

WWW.KIMLEY-HORN.COM REGISTRY 696 STATE OF

DATE: 2/16/2022 THIS ITEM HAS BEEN DIGITALLY SIGNED AND SEALED BY JUAN PABLO GONZALEZ PENA, P.E. ON THE DATE ADJACENT TO THE SEAL. PRINTED COPIES OF THIS DOCUMENT ARE NOT CONSIDERED SIGNED AND SEALED AND THE SIGNATURE MUST BE VERIFIED ON ANY ELECTRONIC COPIES.

Sheet Versions:

SHEET 2 OF 2

Date Description /1\|02/16/2022|ENTITLEMENTS RESUBMITTAL

Sheet Title:

WATER & SEWER

Sheet Number:

CAUTION!!

REQUIREMENTS

DEPARTMENT OR THE APPROPRIATE FIRE AGENCY WITH INSTALLATION IN ACCORDANCE WITH DEPARTMENT STANDARDS. 8. CONTRACTOR MUST CALL MDWASD INSPECTION DIVISION TO ARRANGE FOR A PRECONSTRUCTION MEETING 2 FULL BUSINESS DAYS PRIOR TO PROPOSED START OF CONSTRUCTION. CONTACT ONE CALL CENTER 48 HRS PRIOR TO 9. CONTRACT INSPECTOR WILL INSPECT ANY FACILITIES APPROVED BY THE DEPARTMENT. ALL OTHER REQUIREMENTS OF THE PERMITTING AGENCY SHALL BE IN ACCORDANCE WITH THEIR STANDARDS AND REQUIREMENTS. 10. WORK PERFORMED UNDER THIS PROJECT WILL NOT BE CONSIDERED AS COMPLETE UNTIL FINAL ACCEPTANCE OF THE SYSTEM BY THE DEPARTMENT AND UNTIL THE FOLLOWING DOCUMENTS ARE RECEIVED AND APPROVED BY THE DEPARTMENT a. EASEMENTS, IF REQUIRED b. CONTRACTOR'S WAIVER AND RELEASE OF LIEN c. ABSOLUTE BILL OF SALE d. i. CONTRACTOR'S LETTER OF WARRANTY (I.E., LETTER AGREEMENT) ii DEVELOPER'S CONTRACT BOND (I.E., CONTRACT AGREEMENT). "RECORD DRAWING" PRINTS (24"x 36") SHOWING SPECIFIC LOCATIONS, DEPTH, ETC. OF ALL WATER AND SEWER FACILITIES AS LOCATED BY A LICENSED SURVEYOR & MAPPER, ALONG WITH PRINTS OF "RECORD DRAWINGS" WHICH HAVE BEEN SIGNED AND SEALED BY A REGISTERED SURVEYOR & MAPPER. (No. OF PRINTS: 3-FOR WATER, 4-FOR GRAVITY SEWER AND 5-FOR FORCE MAIN OR PUMP STATION PROJECTS). Submittal of final CAD Files required. f. H.R.S. LETTER OF RELEASE REQUIRED FOR ALL WATER PROJECTS q. BILL OF SALE SKETCH (8½"x 11") FOR WATER AND SEWER, SEPARATELY 11. ALL NEW CONNECTIONS FROM EXISTING DEPARTMENT MAINS TO BE MADE BY DEPARTMENT FORCES ONLY. THE CONTRACTOR TO EXCAVATE AT REQUIRED LOCATIONS, PROVIDE AND INSTALL MATERIAL WITH FITTINGS, PRIOR TO TAP. 12. AN APPROVED PAVING AND DRAINAGE PLAN MUST BE SUBMITTED TO MDWASD FOR ALL NEW SUBDIVISIONS PRIOR TO APPROVAL OF WATER AND SEWER PERMIT PLANS, UPON REQUEST. 13. UNLESS OTHERWISE SPECIFIED, ALL TAPS 20 INCHES AND SMALLER FOR CONNECTIONS TO EXISTING MAINS WILL BE DONE BY DEPARTMENT FORCES. UNDER NO CIRCUMSTANCES WILL THE CONTRACTOR BE PERMITTED TO TAP EXISTING MAINS IN THE SIZE RANGE SPECIFIED ABOVE. THE TAPPING SLEEVE AND TAPPING VALVE ARE FURNISHED AND INSTALLED BY THE CONTRACTOR UNDER THE SUPERVISION OF THE INSPECTOR. ITEM <u>issue date</u> | <u>approved by</u> STANDARD DETAIL V.F.C. 03/01/2010 STANDARD REQUIREMENTS 07/20/2016 D.V. WATER AND SEWER CONSTRUCTION SHEET 1 OF 2 WATER & SEWER DEPARTMEN

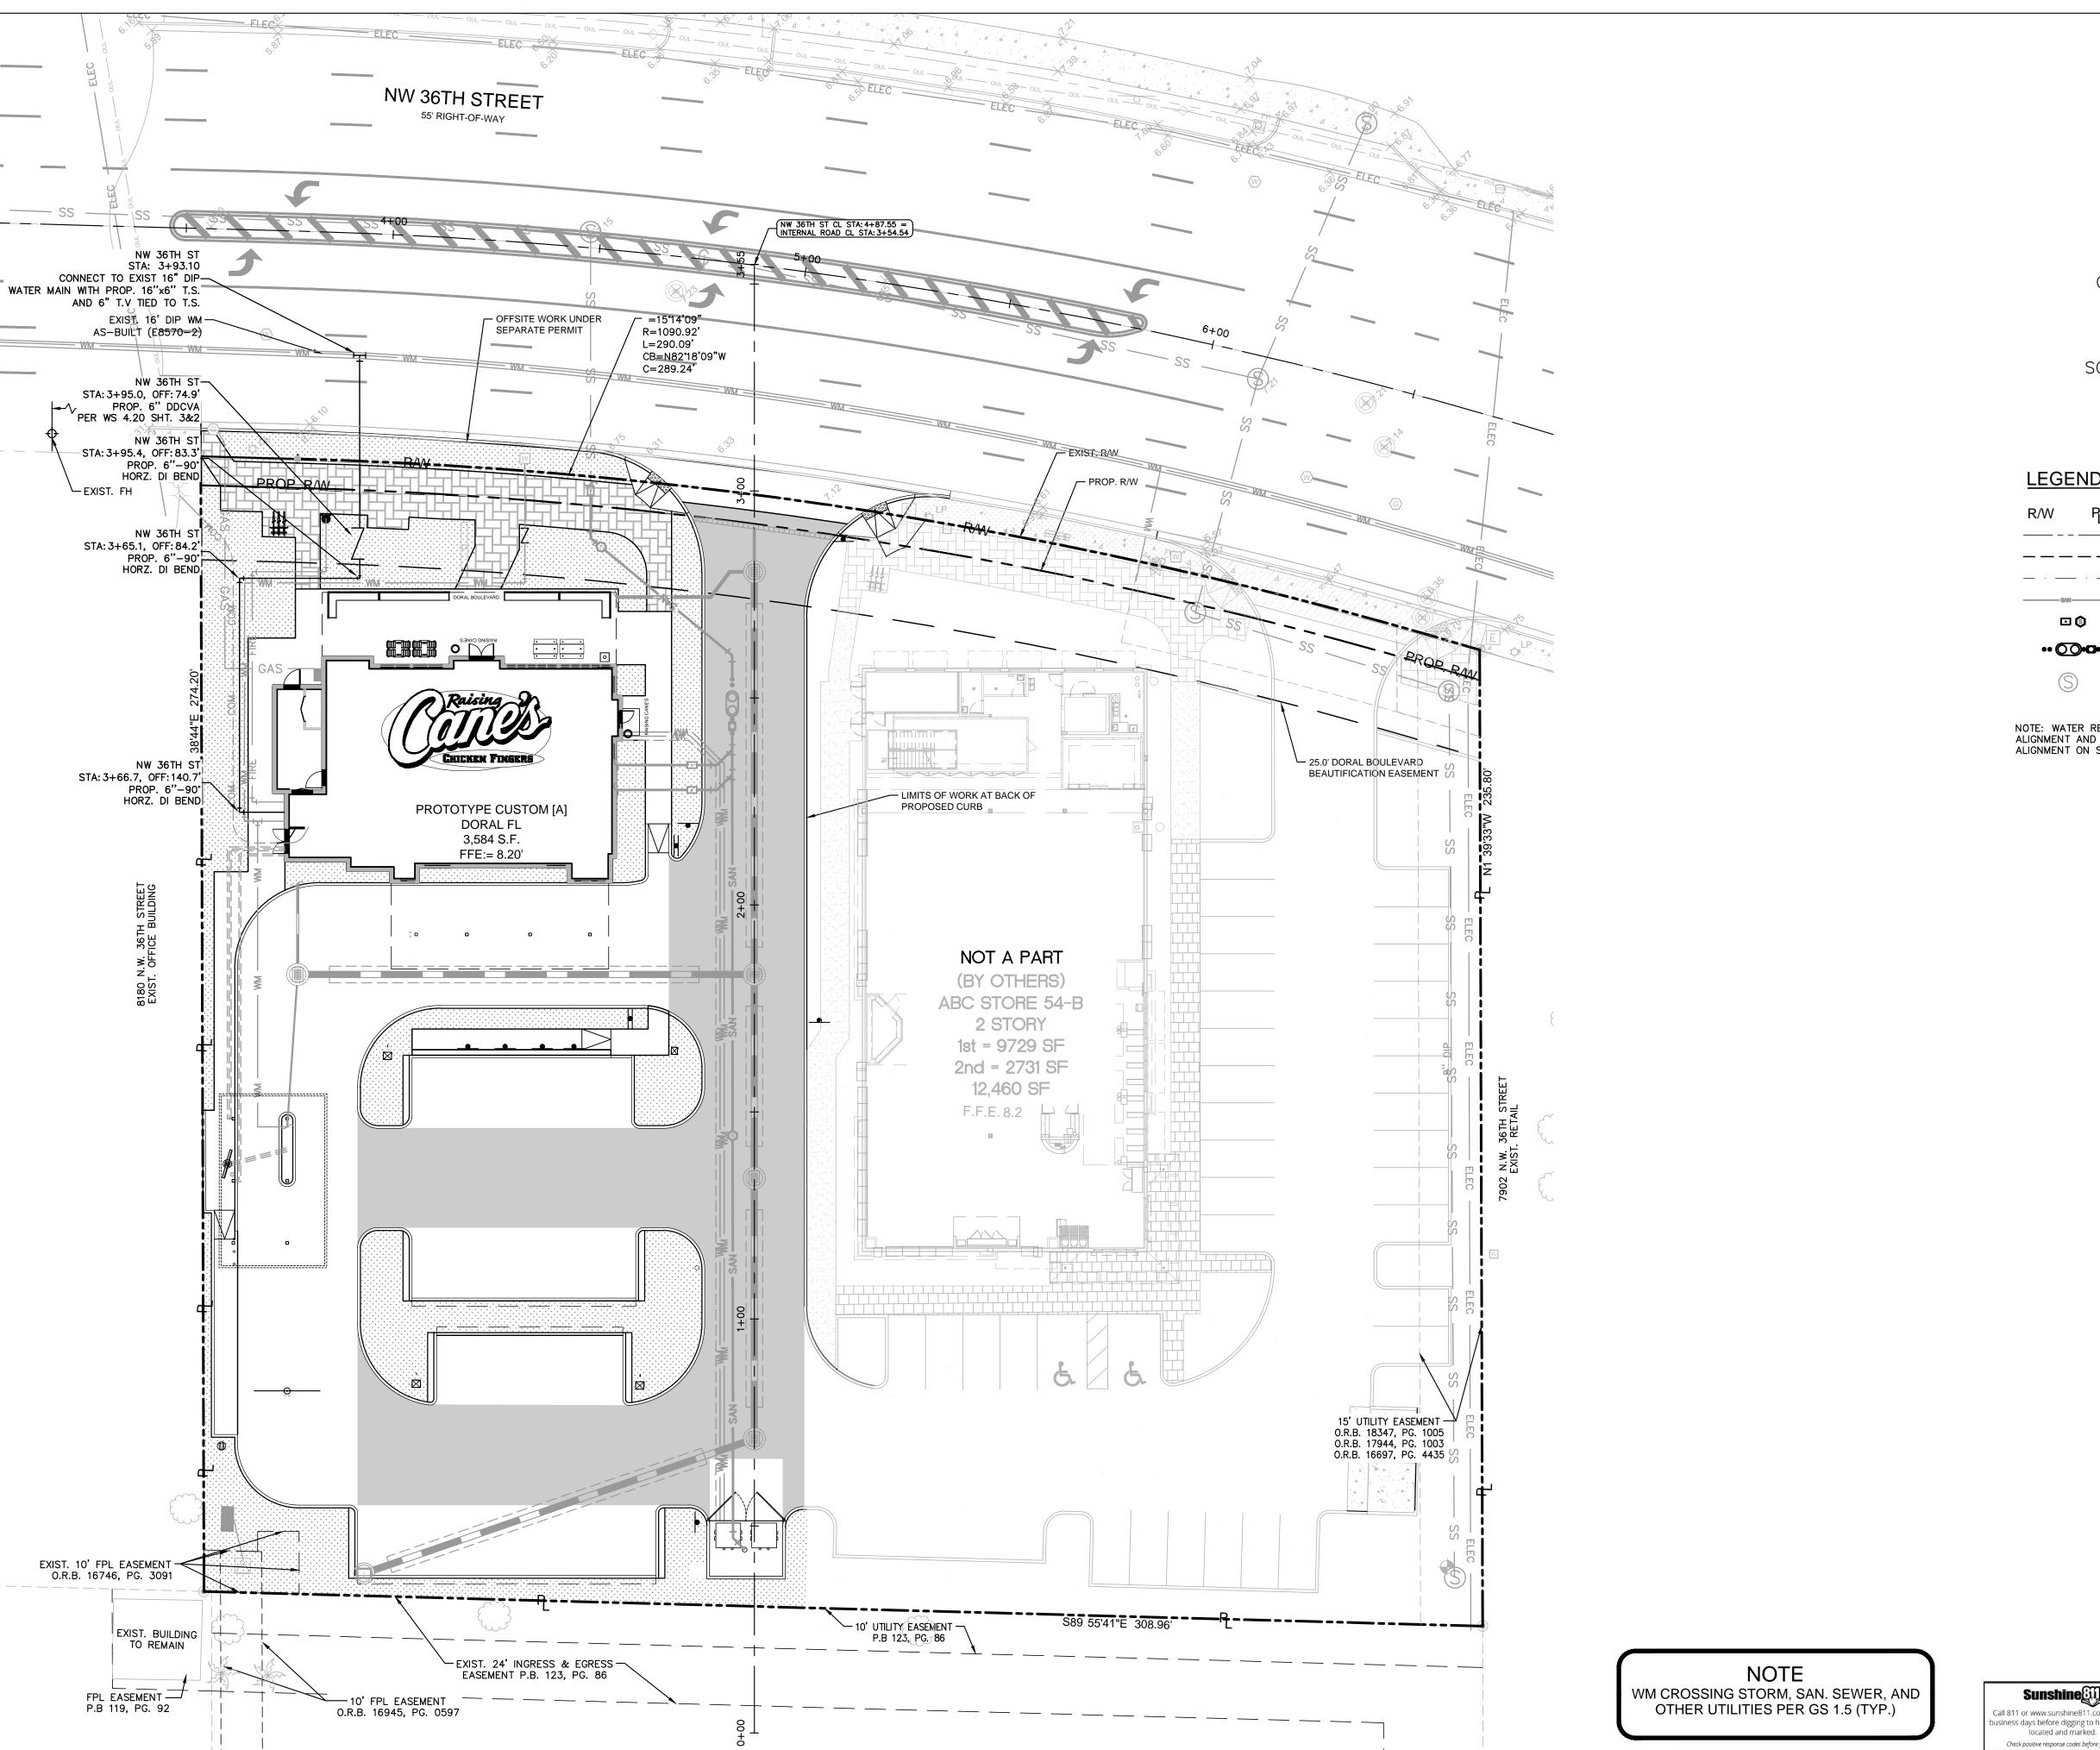
REMOVAL OF UTILITY LINES IS PROPOSED

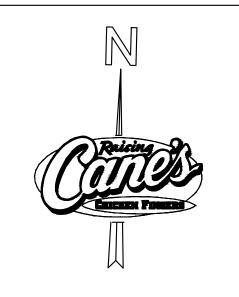
NEW REPLACING UTILITIES HAVE BEEN INSTALLED, IN SERVICE, ACCEPTED BY THE DEPARTMENT AND ALL RELATED SERVICES FROM THE EXISTING MAINS HAVE BEEN TRANSFERRED TO THE NEW ONES, BY LICENSED CONTRACTOR UNDER THE SUPERVISION OF WASD LICENSED OPERATOR AND WASD DONATIONS INSPECTOR UNDER THE SCOPE AND JURISDICTION OF THE CONTRACTOR'S RIGHT-OF-WAY PERMIT.

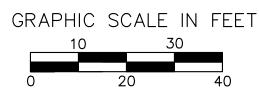
THE FOLLOWING ACTIVITIES ON EXISTING

MDWASD NOTES OR **APPROVAL** 

NOT A PART OF







SCALE:  $1" = 20' \oplus 22X34$ 

# **LEGEND**

RIGHT-OF-WAY LINE OR PROPERTY LINE —— – – LEASE LINE PROPOSED SANITARY SEWER LATERAL PROPOSED PRIVATE CLEANOUT PROPOSED GREASE TRAP EXISTING SANITARY SEWER

NOTE: WATER REFERS TO NW 36TH ST ALIGNMENT AND SEWER REFERS TO ALIGNMENT ON SITE

Store:

Raising Cane's Restaurant #0855 8070 NW 36th Street Doral, FL 33166 CUSTOM [A]

Designer's Information:

CSRS Project Manager:



95 Merrick Way, 3rd floor Coral Gables, Florida 33134 Telephone: 469-498-2100 www.csrsinc.com

2021-1.0 (05-07-2021) Prototype Phase: 10-30-2021 Project Issue Date:

**ENTITLEMENTS** 

11-19-2021

# **Kimley** » Horn

355 ALHAMBRA CIRCLE, SUITE 1400, CORAL GABLES, FL 33134 PHONE: 305-673-2025 WWW.KIMLEY-HORN.COM REGISTRY NO. 696 STATE OF

DATE: 2/16/2022 THIS ITEM HAS BEEN DIGITALLY SIGNED AND SEALED BY JUAN PABLO GONZALEZ PENA, P.E. ON THE DATE ADJACENT TO THE SEAL.
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**Sheet Versions:** 

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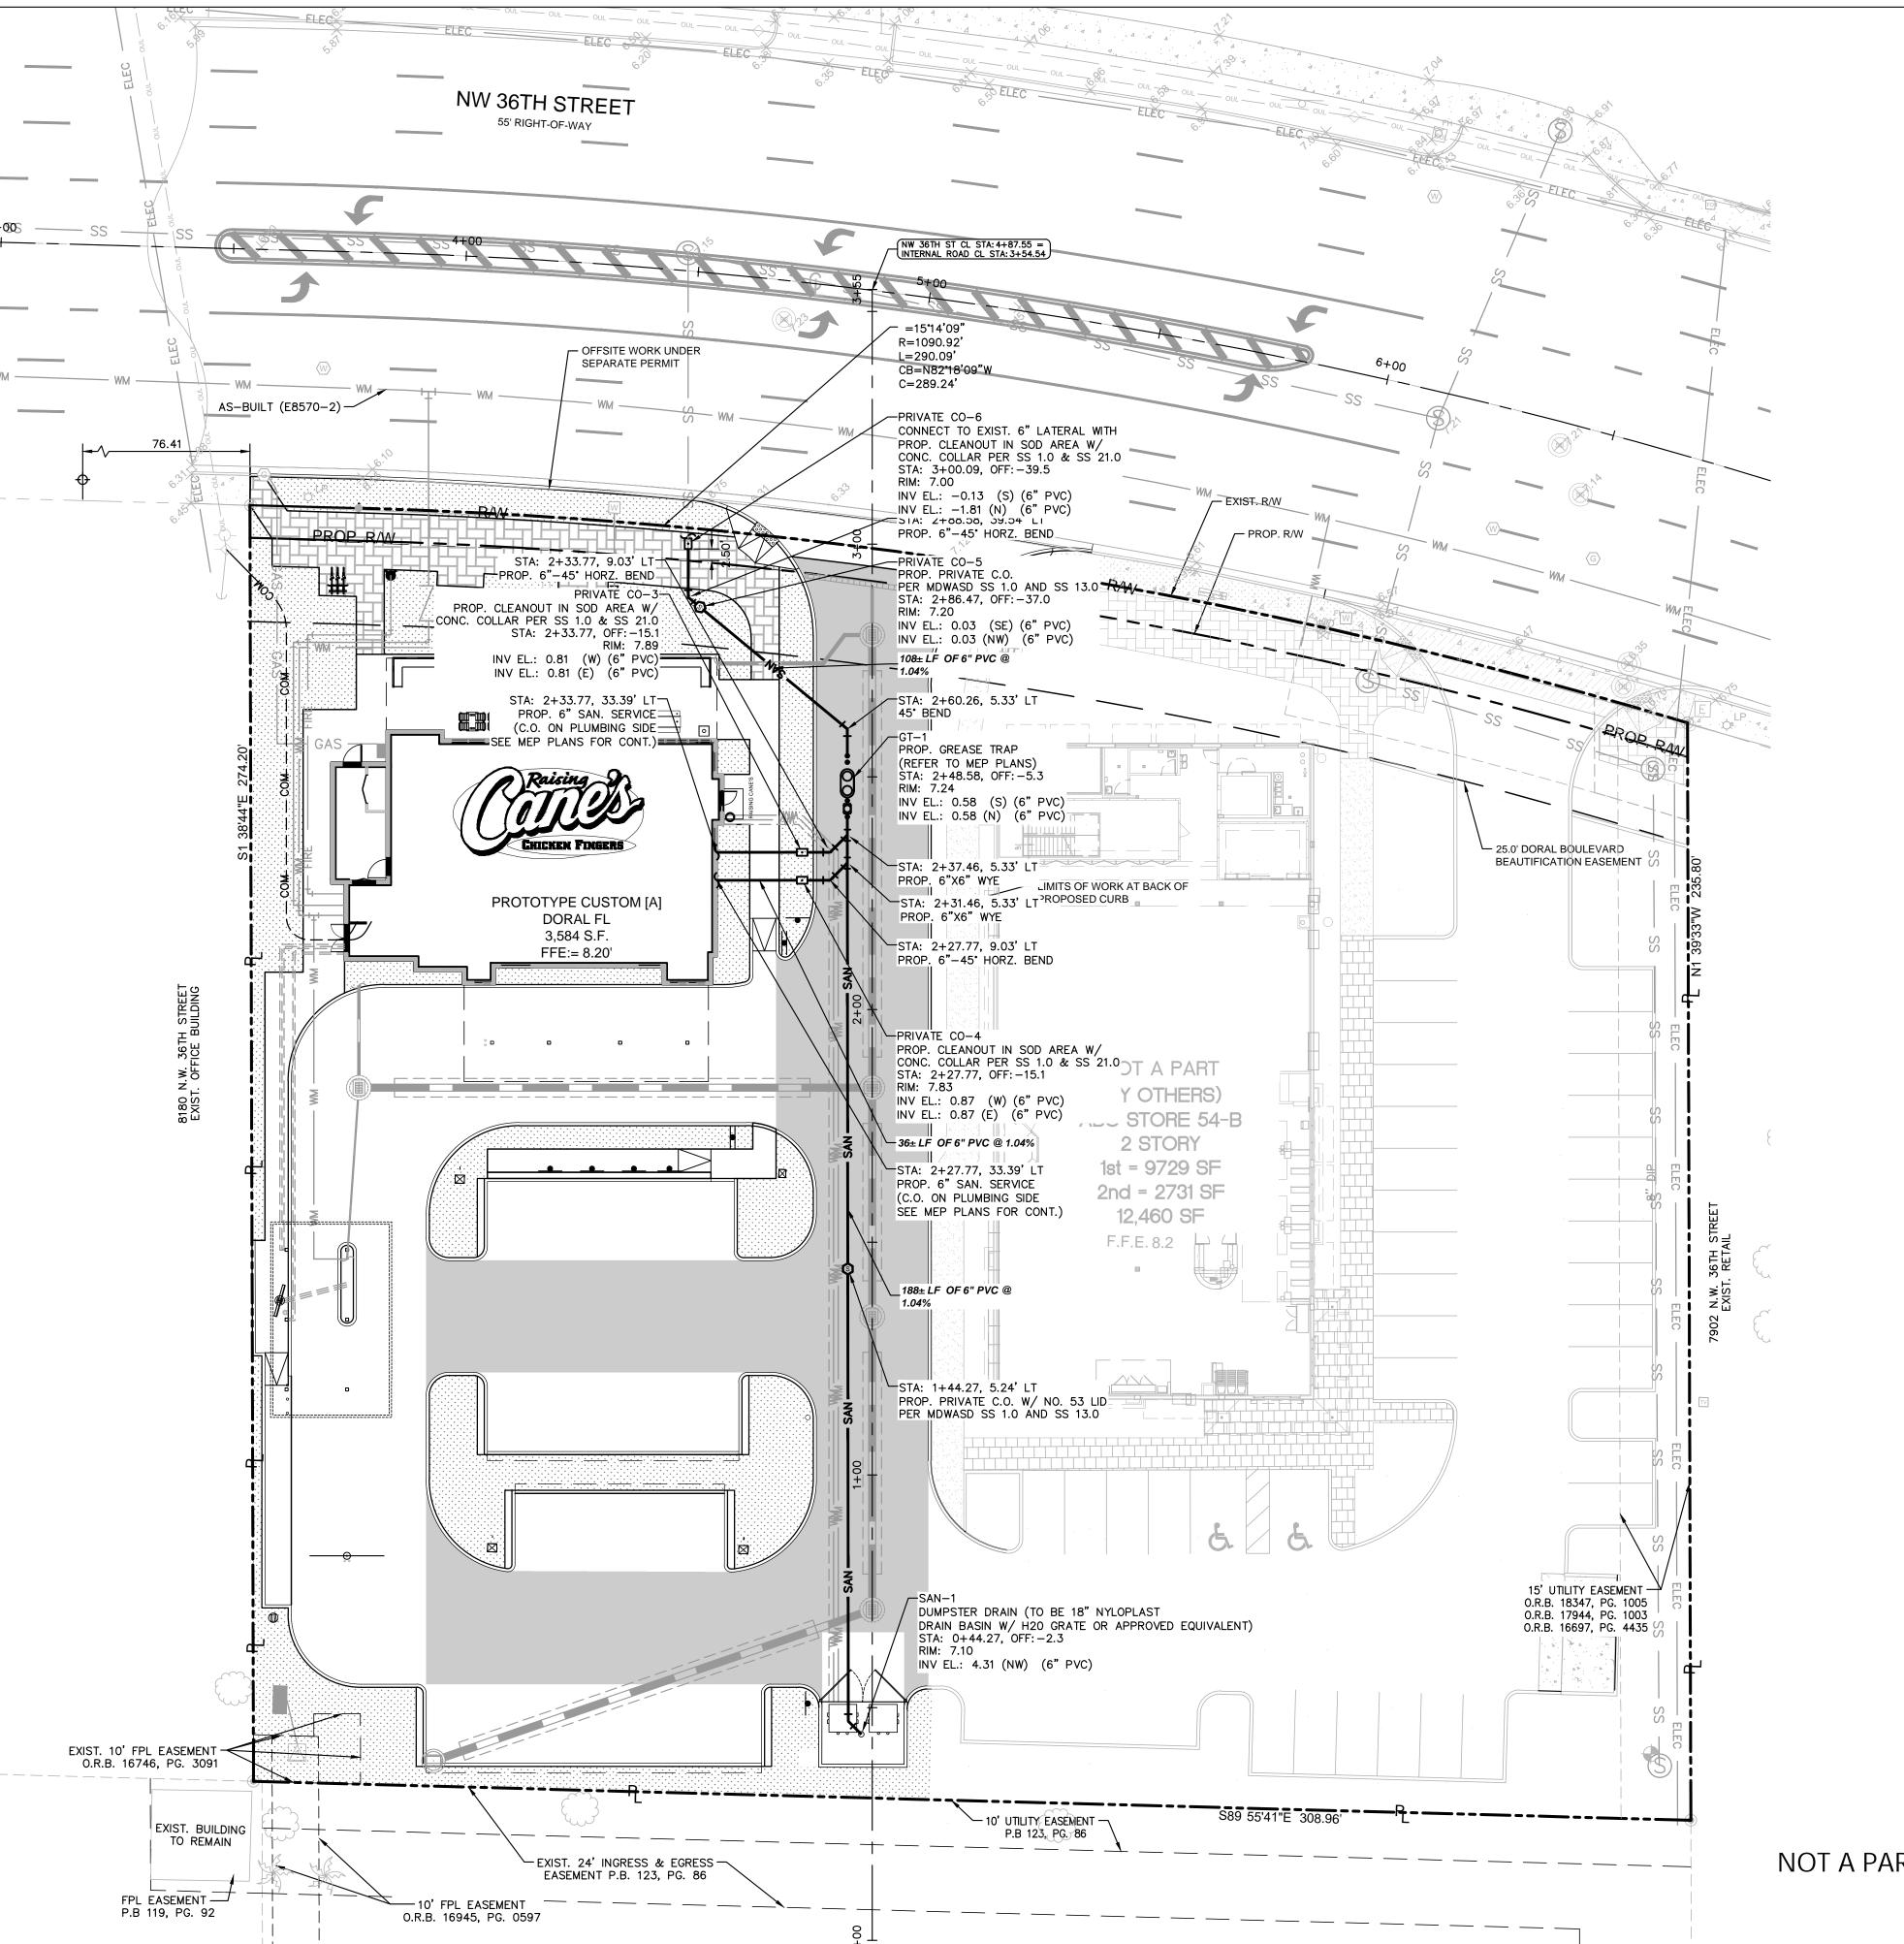
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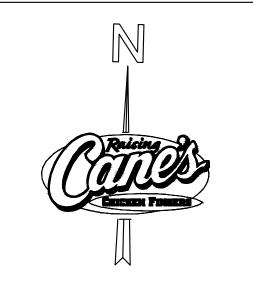
Sheet Number:

C9.1

WATER PLAN

**CAUTION!!** CONTRACTOR IS TO VERIFY PRESENCE AND EXACT
LOCATION OF ALL UTILITIES
PRIOR TO CONSTRUCTION. Call 811 or www.sunshine811.com two fu iness days before digging to have utilitie







SCALE: 1" = 20' @ 22X34

# LEGEND

| R/W  | Քլ           | RIGHT-OF-WAY LINE OR<br>PROPERTY LINE |
|------|--------------|---------------------------------------|
|      |              | LEASE LINE                            |
|      |              | EASEMENT                              |
|      | - · —        | BUILDING SETBACK                      |
|      |              | PROPOSED SANITARY SEWER LATERAL       |
| •    | <b>©</b>     | PROPOSED PRIVATE CLEANOUT             |
| •• @ | <b>)•</b> C• | PROPOSED GREASE TRAP                  |
| S    |              | EXISTING SANITARY SEWER               |

NOTE: WATER REFERS TO NW 36TH ST ALIGNMENT AND SEWER REFERS TO ALIGNMENT ON SITE EXICKEN FINGERS

Restaurant Support Office
6800 Bishop Road, Plano, TX 75024
Tele: 972-769-3101

Store:

Raising Cane's
Restaurant #0855
8070 NW 36th Street
Doral, FL 33166
CUSTOM [A]

Designer's Information:



95 Merrick Way, 3rd floor

Coral Gables, Florida 33134 Telephone: 469-498-2100 www.csrsinc.com

| Prototype Phase:    | 2021-1.0 (05-07-2021) |
|---------------------|-----------------------|
| Project Issue Date: | 10-30-2021            |
|                     |                       |

ENTITLEMENTS

CSRS Project Manager:

11-19-2021

# **Kimley** » Horn

355 ALHAMBRA CIRCLE, SUITE 1400, CORAL GABLES, FL 33134
PHONE: 305–673–2025
WWW.KIMLEY-HORN.COM REGISTRY NO. 696

NO. 92190

STATE OF

DATE: 2/16/2022

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SANITARY SEWER PLAN

Sheet Number:

Sheet Title:

C9.2

CAUTION!!

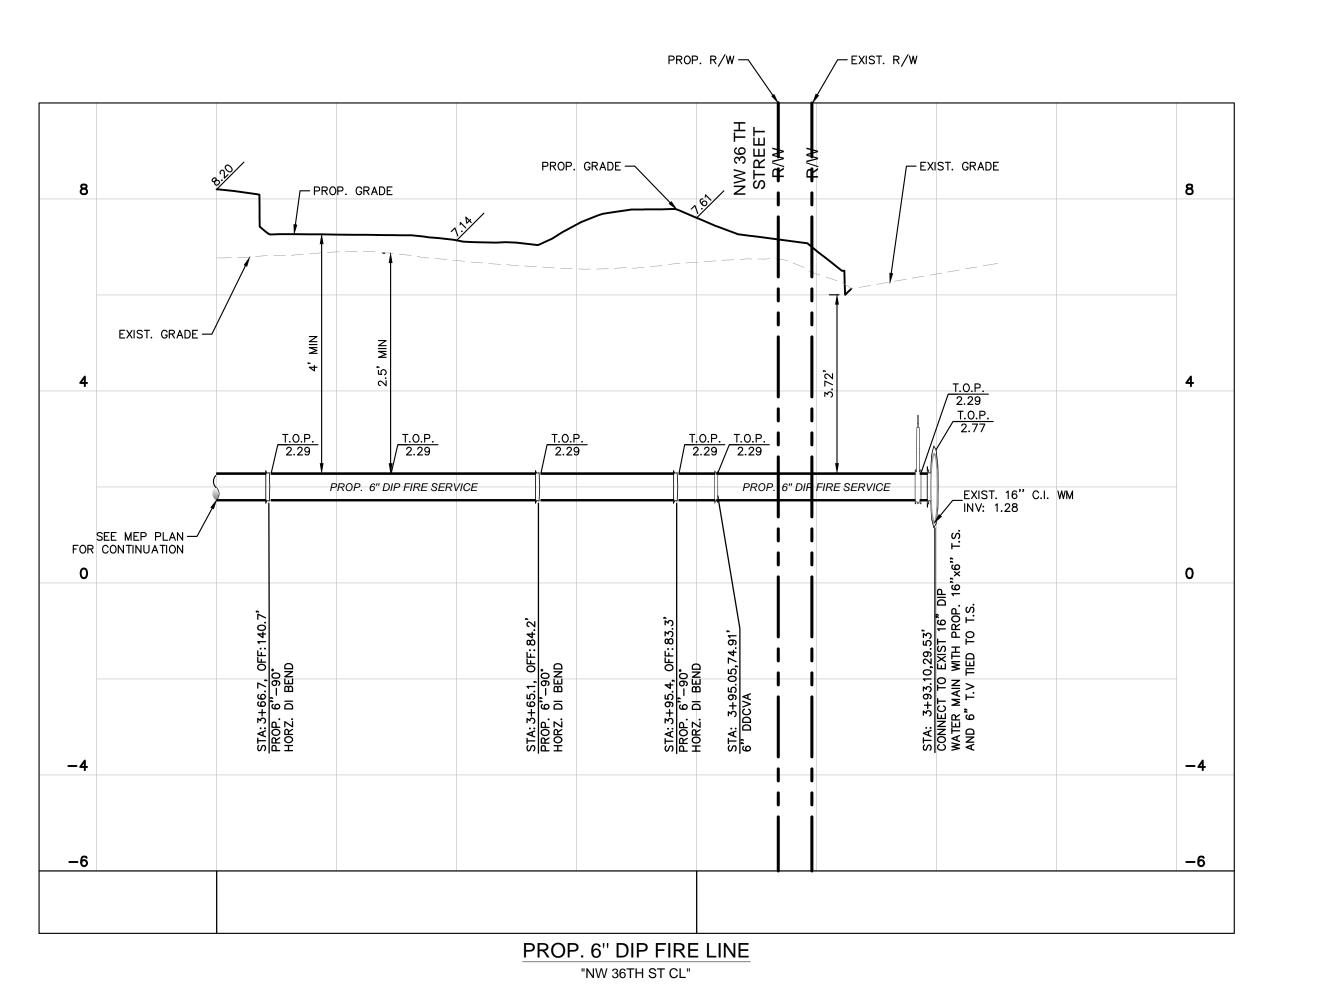
CONTRACTOR IS TO VERIFY
PRESENCE AND EXACT
LOCATION OF ALL UTILITIES
PRIOR TO CONSTRUCTION.

NOT A PART OF MDWASD REVIEW NOR APPROVAL

CAUTION CONTRACTOR IS TO PRESENCE AND

Sunshine

Call 811 or www.sunshine811.com two full outsiness days before digging to have utilitie located and marked.



GRAPHIC SCALE IN FEET
0 10 20 40

HORIZONTAL

4

1

0

RAISINGERS

Restaurant Support Office
6800 Bishop Road, Plano, TX 75024
Tale: 072 760 3100 Eav. 072 760 3101

Sto

Raising Cane's
Restaurant #0855
8070 NW 36th Street
Doral, FL 33166
CUSTOM [A]

Designer's Information:



95 Merrick Way, 3rd floor Coral Gables, Florida 33134 Telephone: 469-498-2100 www.csrsinc.com

Prototype Phase: 2021-1.0 (05-07-2021)

Project Issue Date:

CSRS Project Manager:

ENTITLEMENTS 11-19-2021

10-30-2021

# Kimley»Horn

355 ALHAMBRA CIRCLE, SUITE 1400, CORAL GABLES, FL 33134
PHONE: 305-673-2025
WWW.KIMLEY-HORN.COM REGISTRY NO. 696

No. 92190

\*
STATE OF

DATE: 2/16/2022

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Sheet Versions:

# Date Description

Sheet Title:

WATER PROFILE

Sheet Number:

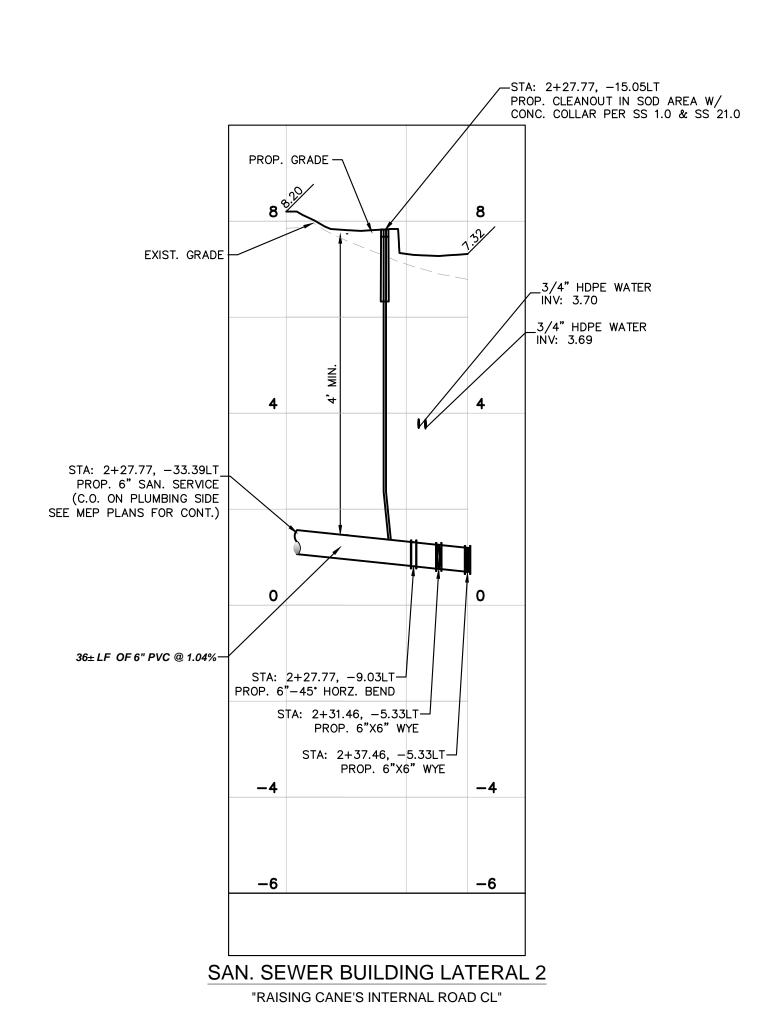
C9.3

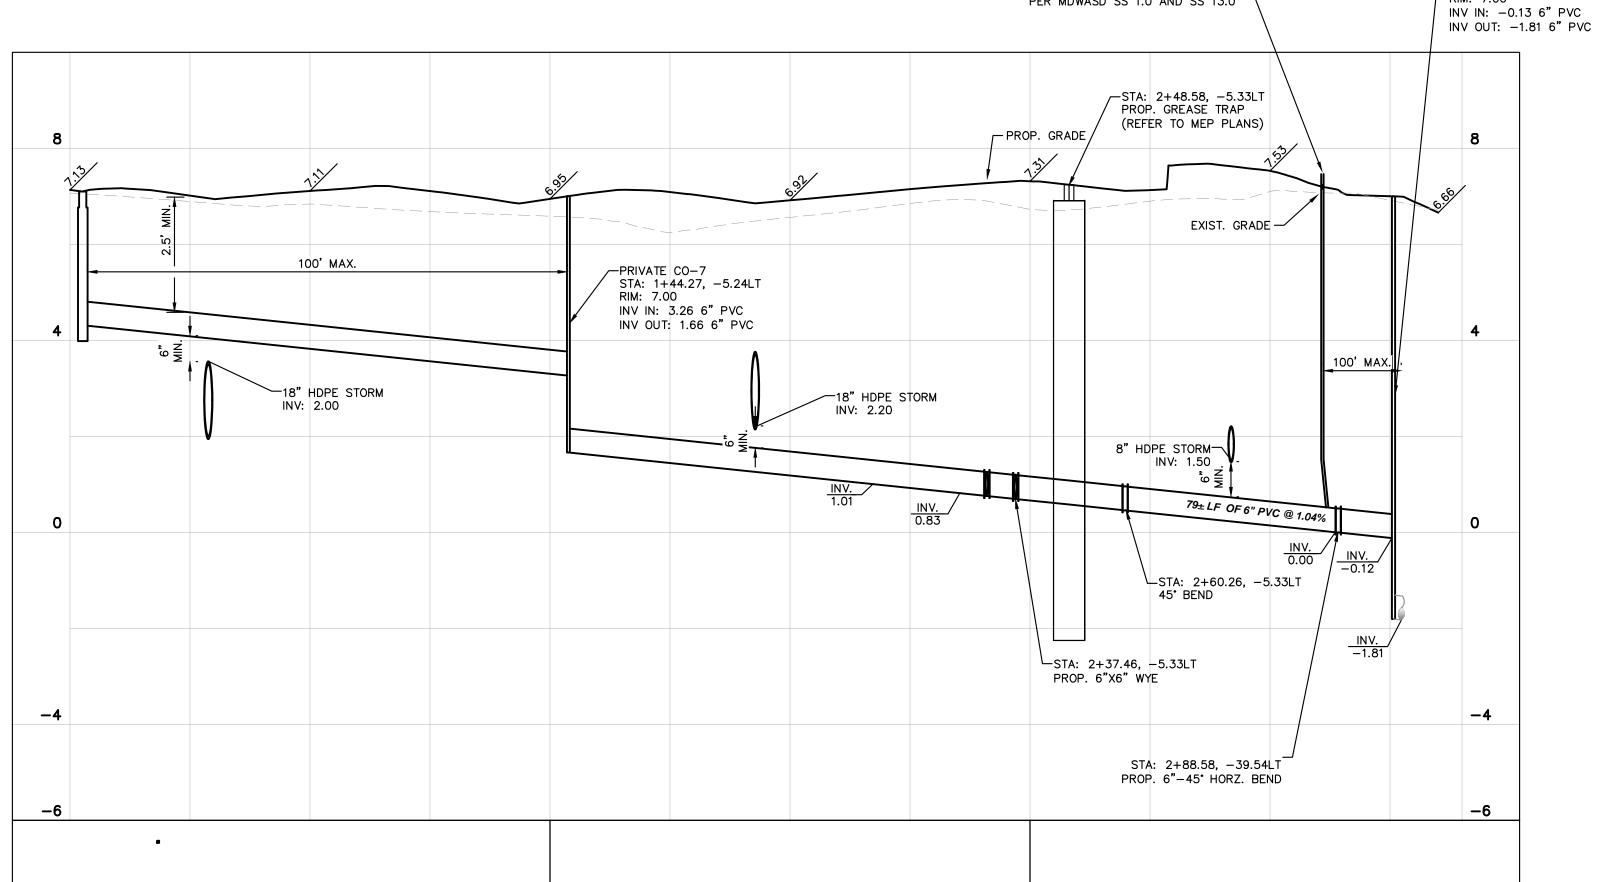
CAUTION!!

CONTRACTOR IS TO VERIFY PRESENCE AND EXACT LOCATION OF ALL UTILITIES PRIOR TO CONSTRUCTION.


Call 811 or www.sunshine811.com two full pusiness days before digging to have utilities located and marked.

Check positive response codes before you dig!





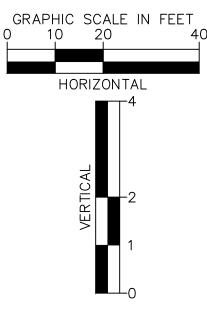SAN. SEWER BUILDING LATERAL 1 "RAISING CANE'S INTERNAL ROAD CL"





Store:

8070 NW 36th Street Doral, FL 33166 CUSTOM [A]

Designer's Information:

95 Merrick Way, 3rd floor Coral Gables, Florida 33134 Telephone: 469-498-2100 www.csrsinc.com

2021-1.0 (05-07-2021)

MRF

Prototype Phase:

Project Issue Date:

10-30-2021 CSRS Project Manager:

**ENTITLEMENTS** 11-19-2021

355 ALHAMBRA CIRCLE, SUITE 1400, CORAL GABLES, FL 33134 PHONE: 305-673-2025 WWW.KIMLEY-HORN.COM REGISTRY NO. 696 STATE OF

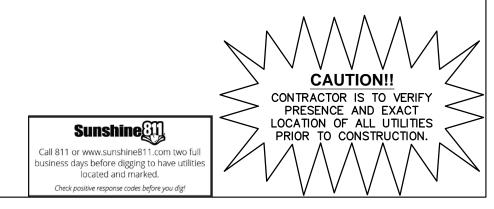
DATE: 2/16/2022

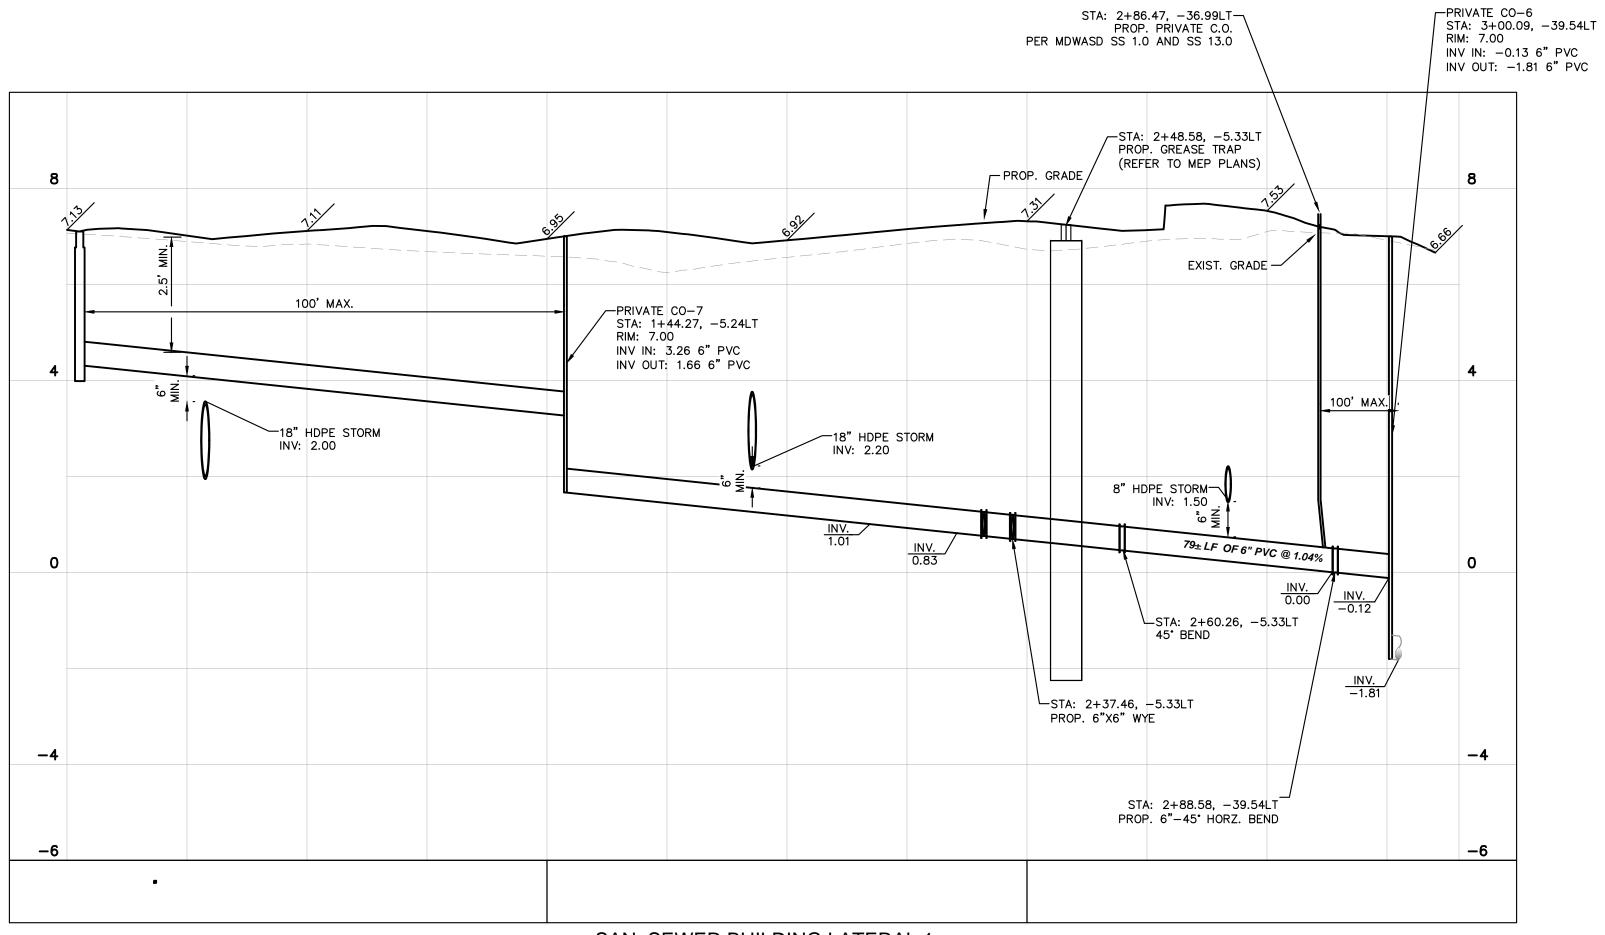
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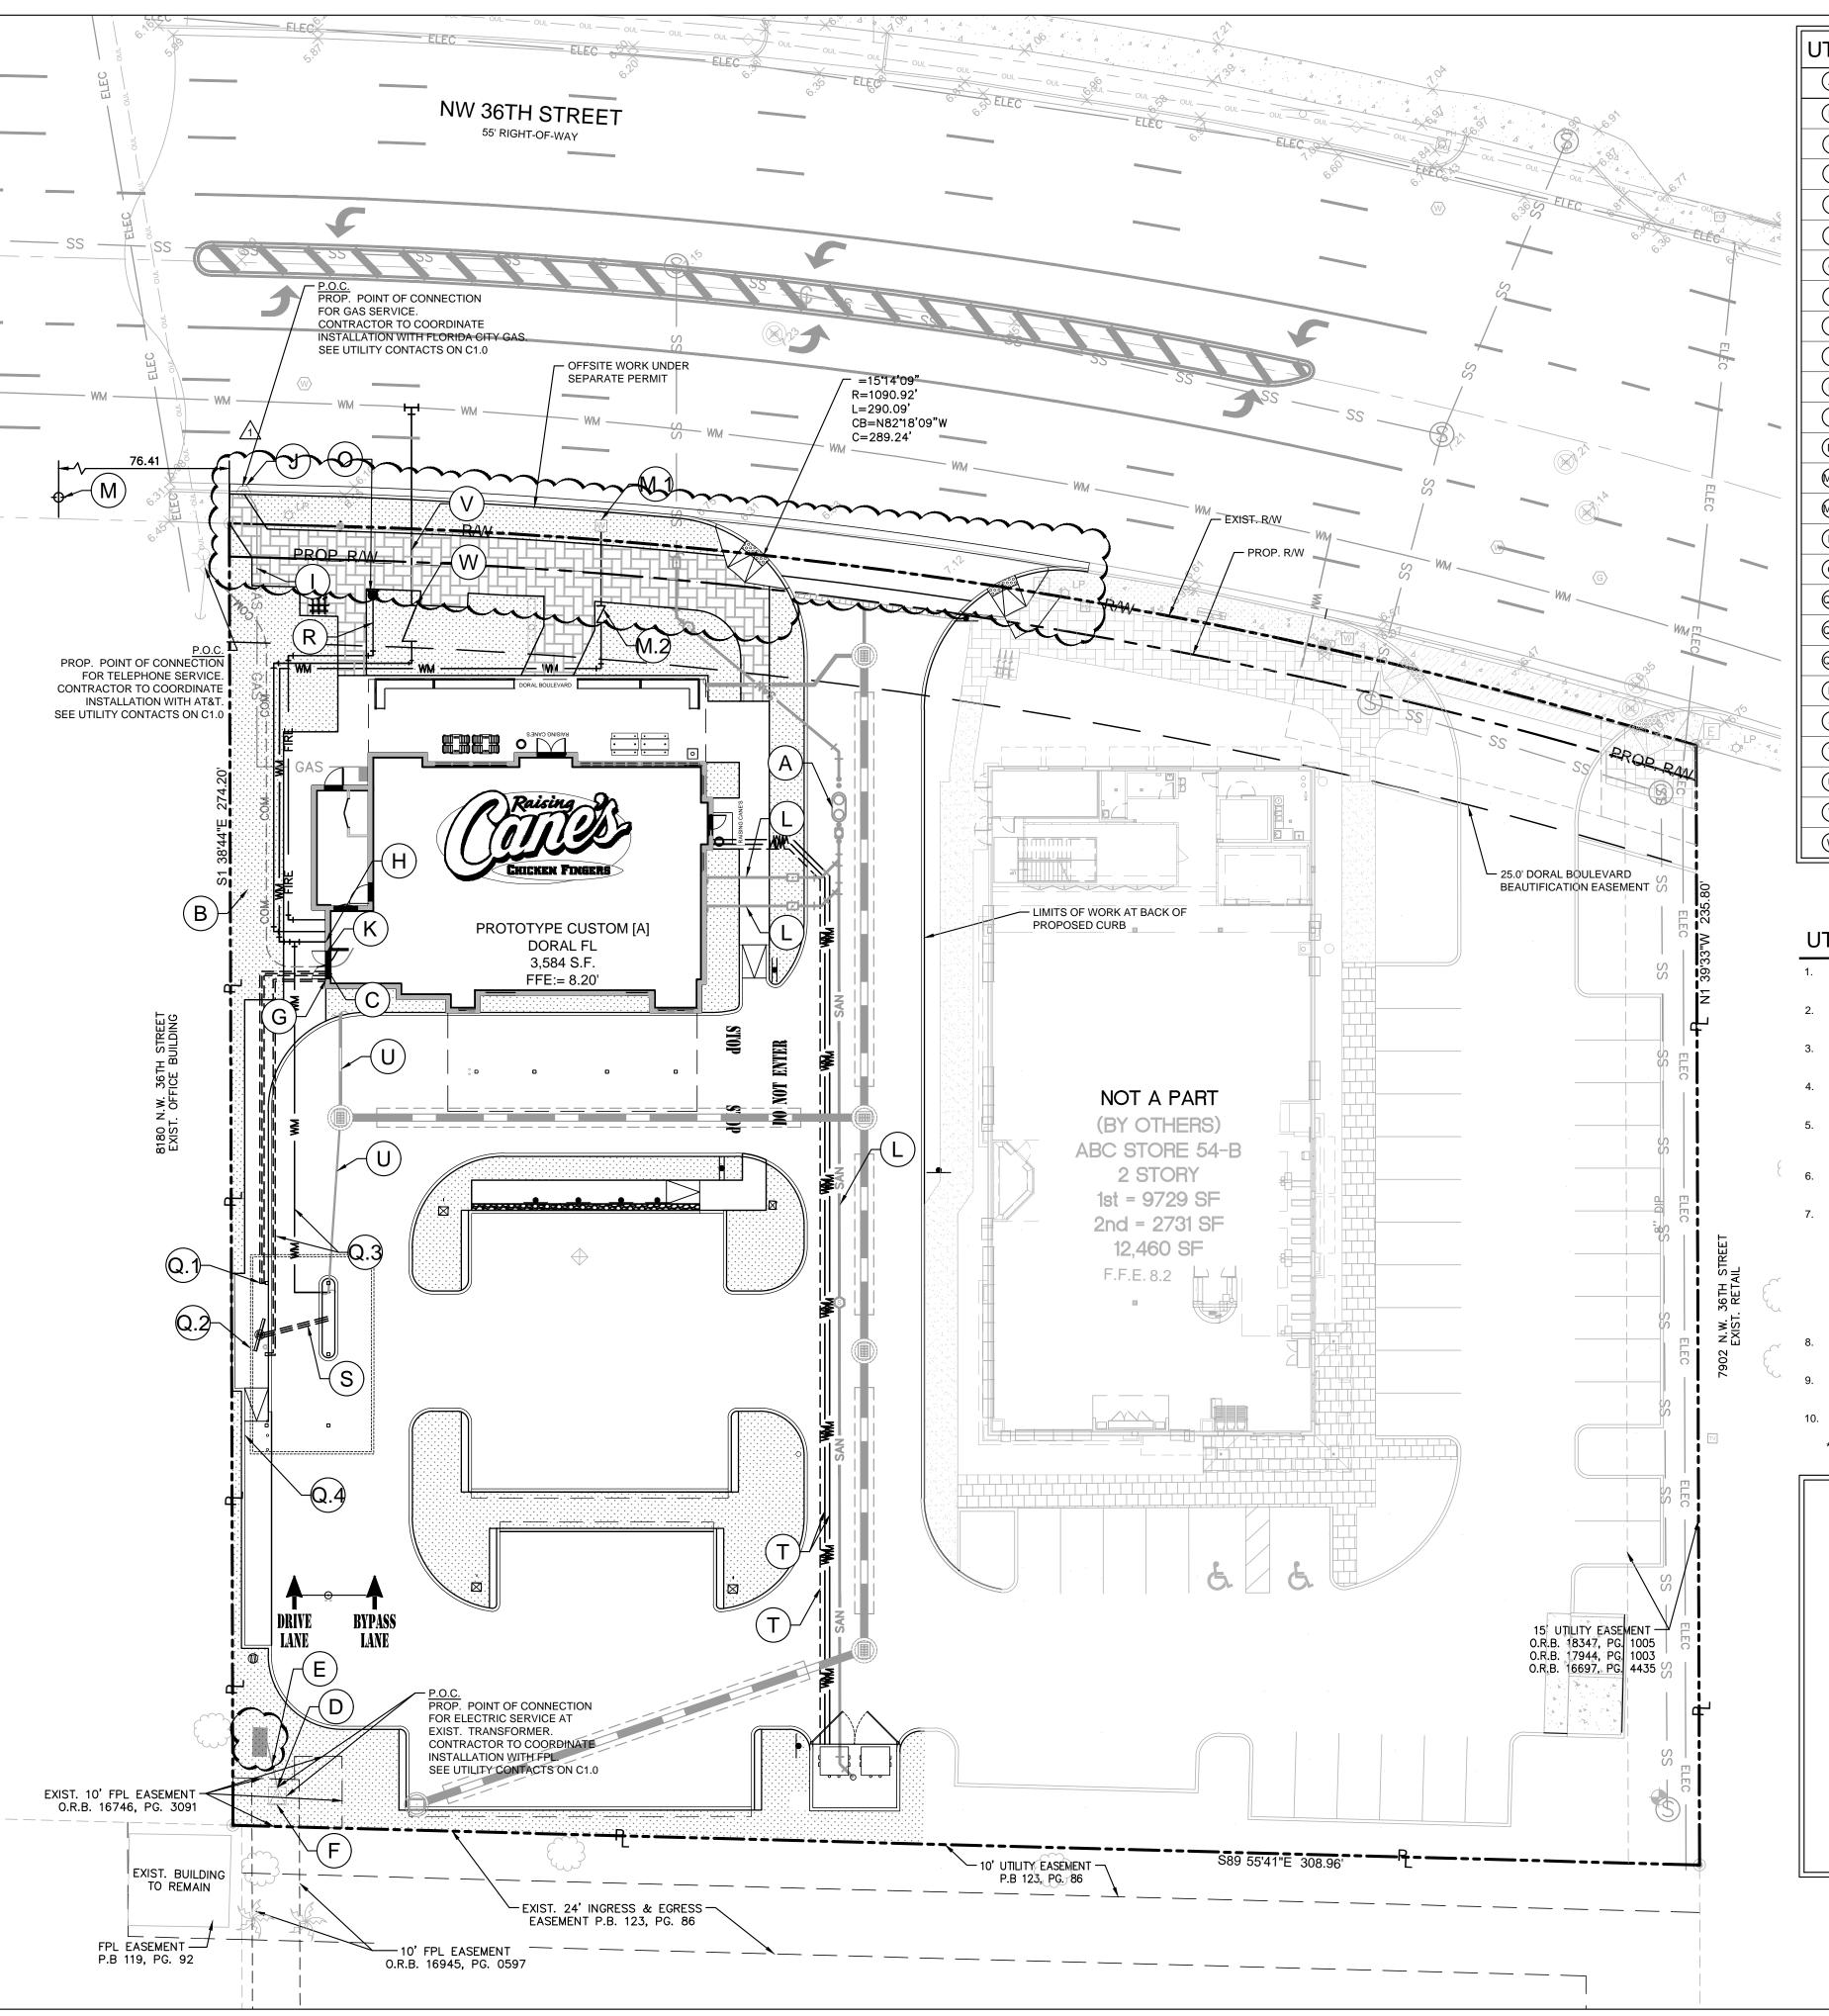
SEWER PROFILES

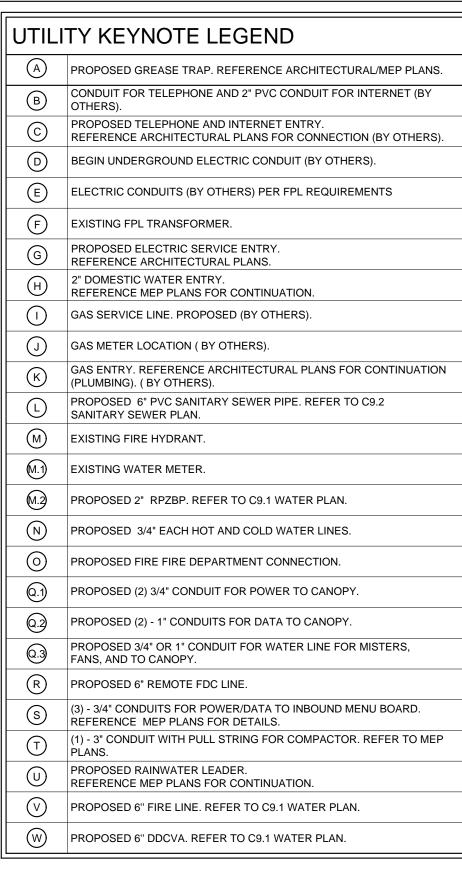
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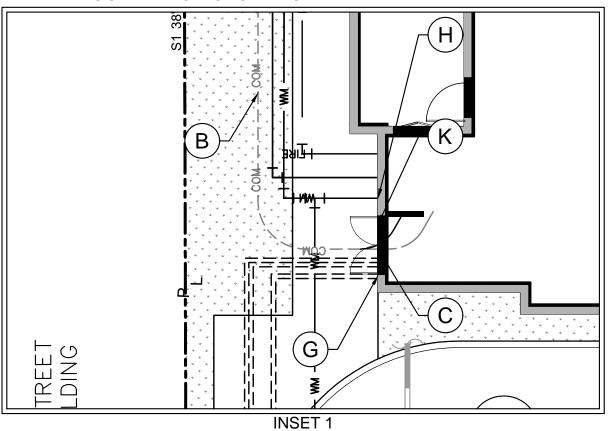




### UTILITY NOTES

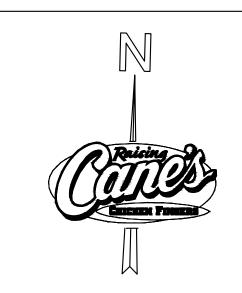
- REFER TO MEP PLANS FOR EXACT LOCATION OF ALL UTILITY CONNECTIONS INTO BUILDING.
- REFER TO CITY AND MDWASD STANDARDS AND DETAILS FOR TRENCHING, BEDDING, BACKFILL, AND TRENCH COMPACTION REQUIREMENTS.
- 3. REFER TO ARCHITECTURAL/MEP PLANS FOR LOCATION AND SIZING OF SLEEVES FOR FRANCHISE UTILITIES, IRRIGATION, ETC.
- CONTRACTOR SHALL NOTIFY THE UTILITY AUTHORITIES INSPECTORS 72 HOURS BEFORE CONNECTING TO ANY EXISTING LINE.
- CONTRACTOR IS RESPONSIBLE FOR COMPLYING TO THE SPECIFICATIONS OF THE CITY AND COUNTY WITH REGARDS TO MATERIALS AND INSTALLATION OF UTILITIES AND WITH THE GUIDELINES FOR UTILITY CROSSINGS.
- 6. IT IS THE CONTRACTOR'S RESPONSIBILITY TO DEFLECT ELECTRIC, GAS, CABLE, AND TELEPHONE CONDUIT AND PIPING AS REQUIRED TO AVOID UTILITY CONFLICTS.
- 7. THE CONTRACTOR IS SPECIFICALLY CAUTIONED THAT THE LOCATION AND/OR ELEVATION OF EXISTING UTILITIES AS SHOWN ON THESE PLANS IS BASED ON RECORDS OF THE VARIOUS UTILITY COMPANIES, AND WHERE POSSIBLE, MEASUREMENTS TAKEN IN THE FIELD. THE INFORMATION IS NOT TO BE RELIED ON AS BEING EXACT OR COMPLETE. THE CONTRACTOR MUST CALL THE APPROPRIATE UTILITY COMPANIES AT LEAST 72 HOURS BEFORE ANY EXCAVATION TO REQUEST EXACT FIELD LOCATION OF UTILITIES. IT SHALL BE THE RESPONSIBILITY OF THE CONTRACTOR TO RELOCATE ALL EXISTING UTILITIES WHICH CONFLICT WITH THE PROPOSED IMPROVEMENTS SHOWN ON THE PLANS.
- 8. CONTRACTOR IS RESPONSIBLE FOR ALL NECESSARY PERMITS, INSPECTIONS AND/OR CERTIFICATIONS REQUIRED BY CITY CODES AND/OR UTILITY SERVICE COMPANIES.
- CONTRACTOR SHALL COORDINATE WITH ALL UTILITY COMPANIES FOR INSTALLATION REQUIREMENTS AND SPECIFICATIONS IN REGARDS TO TAPS, HYDRANTS, VALVES, ETC.
- CONTRACTOR IS RESPONSIBLE FOR PAVEMENT REPLACEMENT REQUIRED FOR ALL
- UTILITY INSTALLATIONS PER CITY AND COUNTY STANDARDS.

  \*FRANCHISE UTILITIES ARE SHOWN FOR REFERENCE ONLY.
  FINAL DESIGN PENDING FROM UTILITIES.\*



 ${\sf SCALE: 1"=10'}\\ {\sf NOTE: REFERENCE MEP PLANS FOR EXACT LOCATION OF ALL UTILITY BUILDING ENTRIES.}$ 

Call 811 or www.sunshine811.com two fu business days before digging to have utilitie located and marked.



GRAPHIC SCALE IN FEET

10 30

SCALE:  $1" = 20' \otimes 22X34$ 

# LEGEND

RIGHT-OF-WAY LINE OR PROPERTY LINE \_\_\_\_\_ - \_ \_\_\_ LEASE LINE EASEMENT **BUILDING SETBACK** PROPOSE GAS LINE PROPOSED UNDERGROUND COMMUNICATIONS PROPOSED UNDERGROUND ELECTRIC LINE PROPOSED WATER LINE PROPOSED FIRE LINE PROPOSED SANITARY SEWER LINE PROPOSED STORM DRAINAGE LINE EXISTING WATER LINE EXISTING SANITARY SEWER LINE **EXISTING OVERHEAD UTILITY LINE** PROPOSED BEND PROPOSED REDUCED BACKFLOW PREVENTER (RPZBP) PER MDWASD EXISTING FIRE HYDRANT

EXISTING WATER METER

**EXISTING SEWER MANHOLE** 



Store:

Raising Cane's
Restaurant #0855
8070 NW 36th Street
Doral, FL 33166
CUSTOM [A]

Designer's Information:

CSRS

95 Merrick Way, 3rd floor Coral Gables, Florida 33134 Telephone: 469-498-2100 www.csrsinc.com

Prototype Phase: 2021-1.0 (05-07-2021)

Project Issue Date: 10-30-2021

\_\_\_\_

CSRS Project Manager:

**ENTITLEMENTS** 

11-19-2021

# **Kimley** » Horn

355 ALHAMBRA CIRCLE, SUITE 1400, CORAL GABLES, FL 33134
PHONE: 305-673-2025
WWW.KIMLEY-HORN.COM REGISTRY NO. 696

NO. 92190

STATE OF

ORIO

DATE: 2/16/2022

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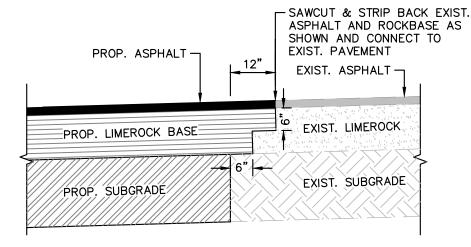
Sheet Title:

WATER, SEWER AND DRAINAGE UTILITY PLAN (PRIVATE)

Sheet Number:

C10.0





1. ALL MATERIALS SHALL BE IN ACCORDANCE WITH THE FDOT STANDARD SPECIFICATIONS FOR ROAD AND BRIDGE CONSTRUCTION, CURRENT EDITION, AND CONSTRUCTED IN ACCORDANCE WITH THE FDOT DESIGN STANDARDS FOR DESIGN, CONSTRUCTION, MAINTENANCE AND UTILITY OPERATIONS ON THE STATE HIGHWAY SYSTEM, CURRENT

2. CONTRACTOR RESPONSIBLE FOR RETURNING ALL AREAS AFFECTED BY WORK TO A CONDITION AS GOOD OR AS

6" UNREINFORCED -

(TYPE 1), 28 DAY

(ASTM C-31)

MIN. COMPRESSION

STRENGTH 4000 PSI

PORTLAND CEMENT

CONCRETE PAVEMENT

# CONNECTION TO EXIST PAVEMENT (SAWCUT) DETAIL

#### —PROP. TYPE "D" CURB (SHOWN FOR REFERENCE ONLY. REFER TO PLANS FOR ACTUAL CURB TYPE). REFER TO LATEST FDOT STANDARD FOR CURB AND CURB AND GUTTER DETAILS. ₹ 1.5" FC 9.5 -6" LIMEROCK BASE COURSE (PRIMED) COMPACTED TO 98% MIN OF MAX DENSITY PER AASHTO T-180 WITH A LBR VALUE OF 100 — 12" STABILIZED SUBGRADE WITH A MINIMUM LBR OF 40 COMPACTED TO AT LEAST 98% OF THE MODIFIED PROCTOR MAXIMUM DRY DENSITY (ASTM D-1557)

NOTES:
REFER TO GEOTECHNICAL REPORT FOR PAVEMENT DESIGN, BASE, AND SUBGRADE PARAMETERS. BITUMINOUS ASPHALT COURSE MAY BE INSTALLED IN TWO SEPARATE LIFTS TO ALLOW MOBILIZATION OF EQUIPMENT. THE SECOND LIFT OF ASPHALT SHALL NOT BE PLACED UNTIL ALL OTHER WORK ON THE SITE HAS BEEN COMPLETED. UPON COMPLETION OF SECOND LIFT OF ASPHALT, ANY SCRATCHES GOUGES, OR LOSS OF AGGREGATE WILL NOT BE ACCEPTED. CONTRACTOR TO REMEDY ALL HOLES, BLEMISHES, ETC. PRIOR TO THE UNIFORM INSTALLATION OF SECOND LIFT. AFTER SECOND LIFT OF ASPHALT IS INSTALLED, ROLLING IS REQUIRED.

# STANDARD ASPHALT PAVEMENT DETAIL

-PROP. TYPE "D" CURB (SHOWN FOR REFERENCE ONLY. REFER TO PLANS FOR ACTUAL CURB TYPE). REFER TO LATEST FDOT STANDARD FOR CURB AND CURB AND GUTTER DETAILS. -1.5" SP 12.5 -8" LIMEROCK BASE COURSE (PRIMED) COMPACTED TO 98% MIN OF MAX DENSITY PER AASHTO T-180 WITH A LBR VALUE OF 100 -12" STABILIZED SUBGRADE WITH A MINIMUM LBR OF 40 COMPACTED TO AT LEAST 98% OF THE MODIFIED PROCTOR MAXIMUM DRY DENSITY (ASTM D-1557)

REFER TO GEOTECHNICAL REPORT FOR PAVEMENT DESIGN, BASE, AND SUBGRADE PARAMETERS.

BITUMINOUS ASPHALT COURSE MAY BE INSTALLED IN TWO SEPARATE LIFTS TO ALLOW MOBILIZATION OF EQUIPMENT. THE SECOND LIFT OF ASPHALT SHALL NOT BE PLACED UNTIL ALL OTHER WORK ON THE SITE HAS BEEN COMPLETED. UPON COMPLETION OF SECOND LIFT OF ASPHALT, ANY SCRATCHES GOUGES, OR LOSS OF AGGREGATE WILL NOT BE ACCEPTED. CONTRACTOR TO REMEDY ALL HOLES, BLEMISHES, ETC. PRIOR TO THE UNIFORM INSTALLATION OF SECOND LIFT. AFTER SECOND LIFT OF ASPHALT IS INSTALLED, ROLLING IS REQUIRED.

# HEAVY DUTY ASPHALT PAVEMENT DETAIL

— 12" WHITE CROSSWALK REFER TO PLAN FOR WIDTH MARKINGS — PATTERN IMPRINTED INTO SURFACE — (WHEN NOTED (SEE PLANS FOR PAVEMENT MATERIAL IN PLANS) AND LAYOUT, AND NOTES FOR (TYP. BOTH SPECIFICATIONS) SIDES) **\*** 4 EXPANSION JOINT IF ADJACENT TO RIGID PAVEMENT OR CURB MINIMUM I BR OF 40

CONTRACTOR SHALL PROVIDE PATTERNED PATTERN WITH INTEGRAL COLOR PER FDOT SPECIFICATION 523 "PATTERNED PAVEMENT" FOR VEHICULAR USE. CROSSWALKS SHALL UTILIZE A 4" X 8"

RUNNING BOND PATTERN. REFER TO PLANS FOR LOCATION.

2. ALL HORIZONTAL SURFACES FINISHES SHALL BE SLIP RESISTANT WITH A COEFFICIENT OF FRICTION THAT MEETS ALL FEDERAL, STATE, AND LOCAL CODE CRITERIA. ALL JOINTING / STAMPING WIDTH AND DEPTH SHALL MEET ALL FEDERAL, STATE, AND LOCAL CODE CRITERIA.

# PATTERNED PAVEMENT DETAIL

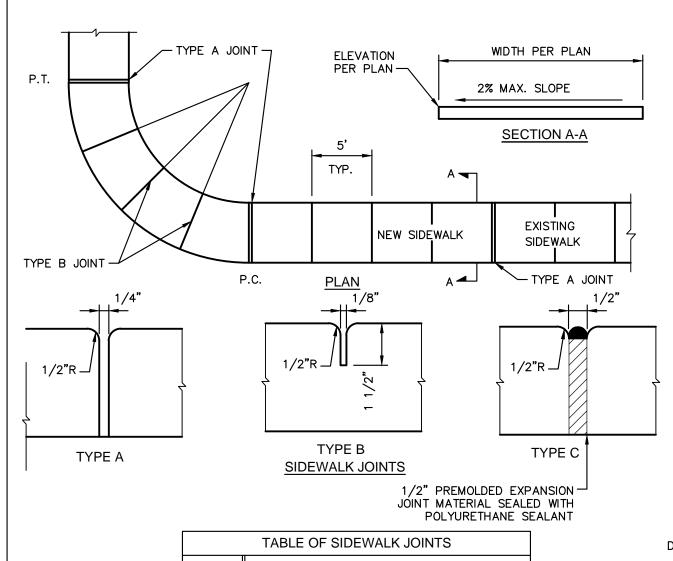
#### BRUSH OR BURLAP FINISH-(REFER TO PATTERNED PAVEMENT DÈTAIL IF PATTERNED CONCRETE IS CALLED OUT IN THE PLANS) BRUSH OR BURLAP FINISH-4 4 4 4 7" UNREINFORCED -PORTLAND CEMENT CONCRETE PAVEMENT -12" STABILIZED SUBGRADE (TYPE 1), 28 DAY WITH A MINIMUM LBR OF MIN. COMPRESSION 40 COMPACTED TO AT STRENGTH 4000 PSI LEAST 98% OF THE (ASTM C-31)MODIFIED PROCTOR MAXIMUM DRY DENSITY (ASTM D-1557)

REFER TO GEOTECHNICAL REPORT FOR PAVEMENT DESIGN, BASE, AND SUBGRADE PARAMETERS. REFER TO GEOTECHNICAL REPORT FOR PAVEMENT DESIGN, BASE, AND SUBGRADE PARAMETERS. CONCRETE SHALL HAVE A SOLAR REFLECTIVE INDEX (SRI) OF AT LEAST 29

# STANDARD CONCRETE PAVEMENT DETAIL

CONCRETE SHALL HAVE A SOLAR REFLECTIVE INDEX (SRI) OF AT LEAST 29


NOTE: CONCRETE JOINTS SHALL BE PER FDOT STANDARD 350-001 (REFER TO JOINT PLAN FOR LOCATION)



LOCATION P.C. AND P.T. OF CURVES. JUNCTION OF EXISTING AND NEW SIDEWALK. 5'-0" CENTER TO CENTER ON SIDEWALK. WHERE SIDEWALK ABUTS CONCRETE CURBS, DRIVEWAYS, AND SIMILAR STRUCTURES

SIDEWALK THICKNESS = 4" (3000 PSI @ 28 DAYS)

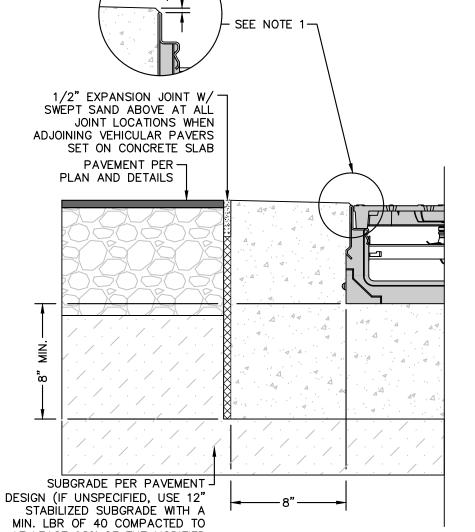CONCRETE SIDEWALK DETAIL



AT LEAST 98% OF THE MODIFIED

HEAVY DUTY CONCRETE PAVEMENT DETAIL

NOTE: CONCRETE JOINTS SHALL BE PER FDOT STANDARD 350-001

(REFER TO JOINT PLAN FOR LOCATION)

PROCTOR MAXIMUM DRY DENSITY (ASTM D-1557)STANDARD INSTALLATION ON SUBGRADE NOTES:

# THE FINISHED LEVEL OF THE CONCRETE SURROUND MUST BE APPROX. 1/8" ABOVE THE TOP OF THE

2. CONCRETE SHALL BE UNREINFORCED PORTLAND CEMENT CONCRETE WITH 28 DAY MIN COMPRESSION STRENGTH OF 4000 PSI

# TRENCH DRAIN DETAIL

N.T.S.

-12" STABILIZED

SUBGRADE WITH A

COMPACTED TO AT

LEAST 98% OF THE

MODIFIED PROCTOR

(ASTM D-1557)

MAXIMUM DRY DENSIT

- ACO H200K-13 SLABDRAIN - LOAD CLASS C TRENCH DRAIN OR APPROVED EQUIVALENT (REFER TO PLAN FOR

FOR INSTALLATION AND MATERIALS DETAILS)

TYPE C EXPANSION -

RIGID PAVEMENT

**INSTALLATION ON CONCRETE SLAB** 

JOINT WHEN ADJOINING

IZE AND LAYOUT. REFER TO MANUFACTURER'S SPECS

- PAVEMENT PER

PLAN AND DETAILS\*

— COLD JOINT

- CONCRETE SLAB (6" MIN)

# PERMEABLE JOINT PAVER INSTALLATION NOTES

## CRUSHED STONE FILLER, BEDDING, BASE AND SUBBASE

- CRUSHED STONE WITH 90% FRACTURED FACES, LA ABRASION < 40 PER ASTM C 131.
  - DO NOT USE ROUNDED RIVER GRAVELS. ALL STONE MATERIALS SHALL BE WASHED WITH LESS THAN 2% PASSING THE NO. 200 SIEVE.
- D. JOINT/OPENING FILLER, BEDDING, BASE AND SUBBASE: CONFORMING TO ASTM D448 GRADATION.

### GENERAL

- ACTIVITIES SHALL BE REMOVED BEFORE APPLICATION OF THE [GEOTEXTILE] AND SUBBASE MATERIALS. KEEP AREA WHERE PAVEMENT IS TO BE CONSTRUCTED FREE FROM SEDIMENT DURING ENTIRE JOB. [GEOTEXTILES] BASE AND BEDDING
- MATERIALS CONTAMINATED WITH SEDIMENT SHALL BE REMOVED AND REPLACED WITH CLEAN MATERIALS.

1. ANY EXCESS THICKNESS OF SOIL APPLIED OVER THE EXCAVATED SOIL SUBGRADE TO TRAP SEDIMENT FROM ADJACENT CONSTRUCTION

### GEOTEXTILES

- 1. PLACE ON TOP OF SOIL BASE AND SUBGRADE. SECURE IN PLACE TO PREVENT WRINKLING FROM VEHICLE TIRES AND TRACKS.
- 2. OVERLAP A MINIMUM OF [0.3 M (12 IN.)] [0.6 M (24 IN.)] IN THE DIRECTION OF DRAINAGE
- 3. MATERIALS SHOULD MEET FDOT SPECIFICATIONS FOR TYPE D-3 GEOTEXTILES

### OPEN-GRADED SUBBASE AND BASE

- MOISTEN, SPREAD AND COMPACT THE NO. 2 SUBBASE IN MAXIMUM 8 IN. (200 MM) LIFTS [WITHOUT WRINKLING OR FOLDING THE GEOTEXTILE. PLACE SUBBASE TO PROTECT GEOTEXTILE FROM WRINKLING UNDER EQUIPMENT TIRES AND TRACKS.] DO NOT PLACE SUBBASE AGGREGATE ON A SUBGRADE [OR GEOTEXTILE] WITH WATER PONDED ON IT.
- FOR EACH LIFT, MAKE AT LEAST TWO PASSES IN THE VIBRATORY MODE THEN AT LEAST TWO IN THE STATIC MODE WITH A MINIMUM 10 T (8 T) VIBRATORY ROLLER UNTIL THERE IS NO VISIBLE MOVEMENT OF THE NO. 2 STONE. DO NOT CRUSH AGGREGATE WITH THE ROLLER
- USE A MINIMUM 13,500 LBF (60 KN) PLATE COMPACTOR WITH A COMPACTION INDICATOR TO COMPACT AREAS THAT CANNOT BE REACHED BY
- THE VIBRATORY ROLLER. DO NOT CRUSH THE AGGREGATE WITH THE PLATE COMPACTOR. THE SURFACE TOLERANCE OF THE COMPACTED NO. 2 SUBBASE SHALL BE  $\pm 2$  1/2 IN. ( $\pm 65$ MM) OVER A 10 FT (3 M) STRAIGHTEDGE.
- MOISTEN. SPREAD AND COMPACT THE NO. 57 BASE LAYER IN ONE 4 IN. (100 MM) THICK LIFT. ON THIS LAYER, MAKE AT LEAST TWO PASSES IN THE VIBRATORY MODE THEN AT LEAST TWO IN THE STATIC MODE WITH A MINIMUM 10 T (8 T) VIBRATORY ROLLER UNTIL THERE IS NO VISIBLE MOVEMENT OF THE NO. 57 STONE. DO NOT CRUSH AGGREGATE WITH THE ROLLER.
- 6. THE SURFACE TOLERANCE THE COMPACTED NO. 57 BASE SHOULD NOT DEVIATE MORE THAN. ±1 IN. (25 MM) OVER A 10 FT (3 M)

# BEDDING LAYER

- MOISTEN, SPREAD AND SCREED THE NO. 8 STONE BEDDING MATERIAL. MAINTAIN A CONSISTENT 2 IN. (50 MM THICKNESS PRIOR TO COMPACTION WITH THE PAVERS.
- FILL VOIDS LEFT BY REMOVED SCREED RAILS WITH NO. 8 STONE.
- THE SURFACE TOLERANCE OF THE SCREEDED NO. 8 BEDDING LAYER SHALL BE ±3/8 IN (10 MM) OVER A 10 FT (3 M) STRAIGHTEDGE. DO NOT SUBJECT SCREEDED BEDDING MATERIAL TO ANY PEDESTRIAN OR VEHICULAR TRAFFIC BEFORE PAVING UNIT INSTALLATION BEGINS.

# PERMEABLE INTERLOCKING CONCRETE PAVERS AND JOINT/OPENING FILL MATERIAL

- LAY THE PAVING UNITS IN THE PATTERN(S) AND JOINT WIDTHS SHOWN ON THE DRAWINGS. MAINTAIN STRAIGHT PATTERN LINES.
- FILL GAPS AT THE EDGES OF THE PAVED AREA WITH CUT UNITS. CUT PAVERS SUBJECT TO TIRE TRAFFIC SHALL BE NO SMALLER THAN 1/3 OF A WHOLE UNIT.
- CUT PAVERS AND PLACE ALONG THE EDGES WITH A [DOUBLE-BLADED SPLITTER OR] MASONRY SAW.
- FILL THE OPENINGS AND JOINTS WITH [NO. 8] STONE.
- REMOVE EXCESS AGGREGATE ON THE SURFACE BY SWEEPING PAVERS CLEAN.
- COMPACT AND SEAT THE PAVERS INTO THE BEDDING MATERIAL USING A LOW-AMPLITUDE, 75-90 HZ PLATE COMPACTOR CAPABLE OF AT
- LEAST 5,000 LBF (22 KN). THIS WILL REQUIRE AT LEAST TWO PASSES WITH THE PLATE COMPACTOR. APPLY ADDITIONAL AGGREGATE TO THE OPENINGS AND JOINTS IF NEEDED, FILLING THEM COMPLETELY. REMOVE EXCESS AGGREGATE BY SWEEPING THEN COMPACT THE PAVERS. THIS WILL REQUIRE AT LEAST TWO PASSES WITH THE PLATE COMPACTOR.
- ALL PAVERS WITHIN 6 FT (2 M) OF THE LAYING FACE MUST BE LEFT FULLY COMPACTED AT THE COMPLETION OF EACH DAY.
- THE FINAL SURFACE TOLERANCE OF COMPACTED PAVERS SHALL NOT DEVIATE MORE THAN ±3/8 (10 MM) UNDER A 10 FT (3 M) LONG
- 10. THE SURFACE ELEVATION OF PAVERS SHALL BE 1/8 TO 1/4 IN. (3 TO 6 MM) ABOVE ADJACENT DRAINAGE INLETS, CONCRETE COLLARS OR CHANNELS.

# FIELD QUALITY CONTROL

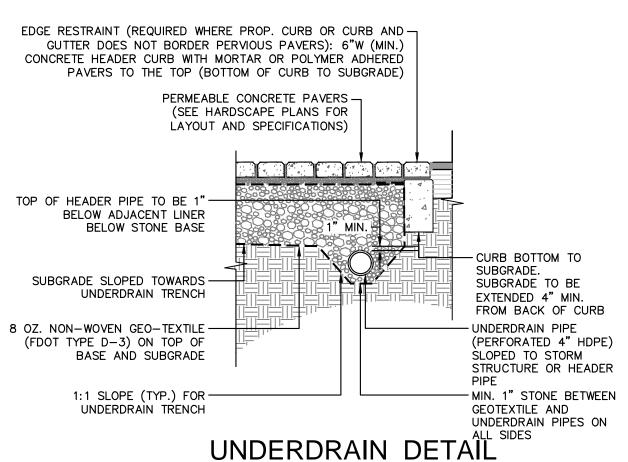
- AFTER SWEEPING THE SURFACE CLEAN, CHECK FINAL ELEVATIONS FOR CONFORMANCE TO THE DRAWINGS.
- B. LIPPAGE: NO GREATER THAN 1/8 IN. (3 MM) DIFFERENCE IN HEIGHT BETWEEN ADJACENT PAVERS.
- E. VERIFY THE SURFACE INFILTRATION AT A MINIMUM OF 100 IN./HOUR USING TEST METHOD C 1781.

# VEHICULAR PAVER MATERIAL

1. UNLESS OTHERWISE SPECIFIED IN THE PLANS, PAVERS SHALL BE 4.5 X 9 X 3 VEHICULAR RATED PERMEABLE JOINT PAVERS AS MANUFACTURED BY: HANOVER ARCHITECTURAL PRODUCTS OR APPROVED EQUIVALENT.

MATERIALS SHALL HAVE A NON-SLIP FINISH WITH MINIMUM STATIC AND DYNAMIC COEFFICIENT OF FRICTION OF 0.5.

- 2. PAVERS SHALL BE LAID IN A RUNNING BOND PATTERN LAID LONGITUDINALLY PERPENDICULAR TO THE DIRECTION OF VEHICLE TRAVEL (I.E.
- FOR PARKING SPACES WHICH FACE EAST, PAVERS SHALL BE LAID SUCH THAT THE LONGER DIMENSION IS GOING NORTH-SOUTH). 3. CONTRACTOR SHALL SUBMIT DETAILED SHOP DRAWINGS INCLUDING PRODUCT DATA AND SLIP COEFFICIENT INFORMATION FOR COMMENT, REVIEW, AND EVALUATION BY LANDSCAPE ARCHITECT AND CIVIL ENGINEER PRIOR TO PROCUREMENT, FABRICATION, AND INSTALLATION.




CONCRETE HEADER CURB WITH MORTAR OR POLYMER ADHERED PAVERS TO THE TOP (BOTTOM OF CURB TO SUBGRADE) PERMEABLE CONCRETE PAVERS (SEE HARDSCAPE -PLANS FOR LAYOUT AND SPECIFICATIONS) NO. 8 AGGREGATE IN OPENINGS AND JOINTS -PER MANUFACTURER RECOMMENDATIONS BEDDING COURSE 1½" MIN. THICK (TYP. NO. 8 AGGREGATE) 4" THICK NO. 57 STONE OPEN-GRADED -BASE (SEE NOTES FOR COMPACTION) 6" MIN. NO. 2 STONE SUBBASE (SEE -NOTES FOR COMPACTION) (FOR NON-VEHICULAR PERVIOUS AREAS) 8" MIN. NO. 2 STONE SUBBASE (SEE -NOTES FOR COMPACTION) (FOR VEHICULAR PERVIOUS AREAS) 8 OZ. NON-WOVEN GEO-TEXTILE (FDOT TYPE D-3) ON TOP OF BASE AND SUBGRADE 12" MIN. SUB-GRADE COMPACTED TO 95% -AASHTO T-99 DENSITY AND MIN. LBR OF 40% CURB BOTTOM TO SUBGRADE. SUBGRADE TO -BE EXTENDED 4" MIN. FROM BACK OF CURB

# PERVIOUS PAVER DETAIL (VEHICULAR & PEDESTRIAN)

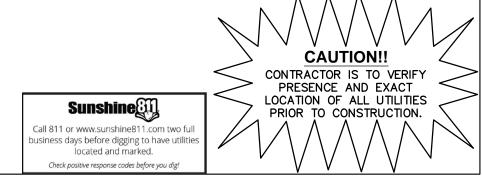(NOTE: STONE SUBBASE IS DIFFERENT FOR CORRESPONDING AREA)

EDGE RESTRAINT (REQUIRED WHERE PROP. CURB OR CURB AND -

GUTTER DOES NOT BORDER PERVIOUS PAVERS): 6"W (MIN.)



Store:

Restaurant #0855 8070 NW 36th Street Doral, FL 33166 CUSTOM [A]

Raising Cane's

Designer's Information:

95 Merrick Way, 3rd floor Coral Gables, Florida 33134 Telephone: 469-498-2100 www.csrsinc.com

2021-1.0 (05-07-2021) Prototype Phase:

10-30-2021 Project Issue Date:

MRF CSRS Project Manager

**ENTITLEMENTS** 

11-19-2021

355 ALHAMBRA CIRCLE, SUITE 1400, CORAL GABLES, FL 33134 PHONE: 305-673-2025 WWW.KIMLEY-HORN.COM REGISTRY NO. 696 No. 92190 STATE OF

DATE: 2/16/2022 THIS ITEM HAS BEEN DIGITALLY SIGNED AND SEALED BY JUAN PABLO GONZALEZ PENA, P.E. ON THE DATE ADJACENT TO THE SEAL.
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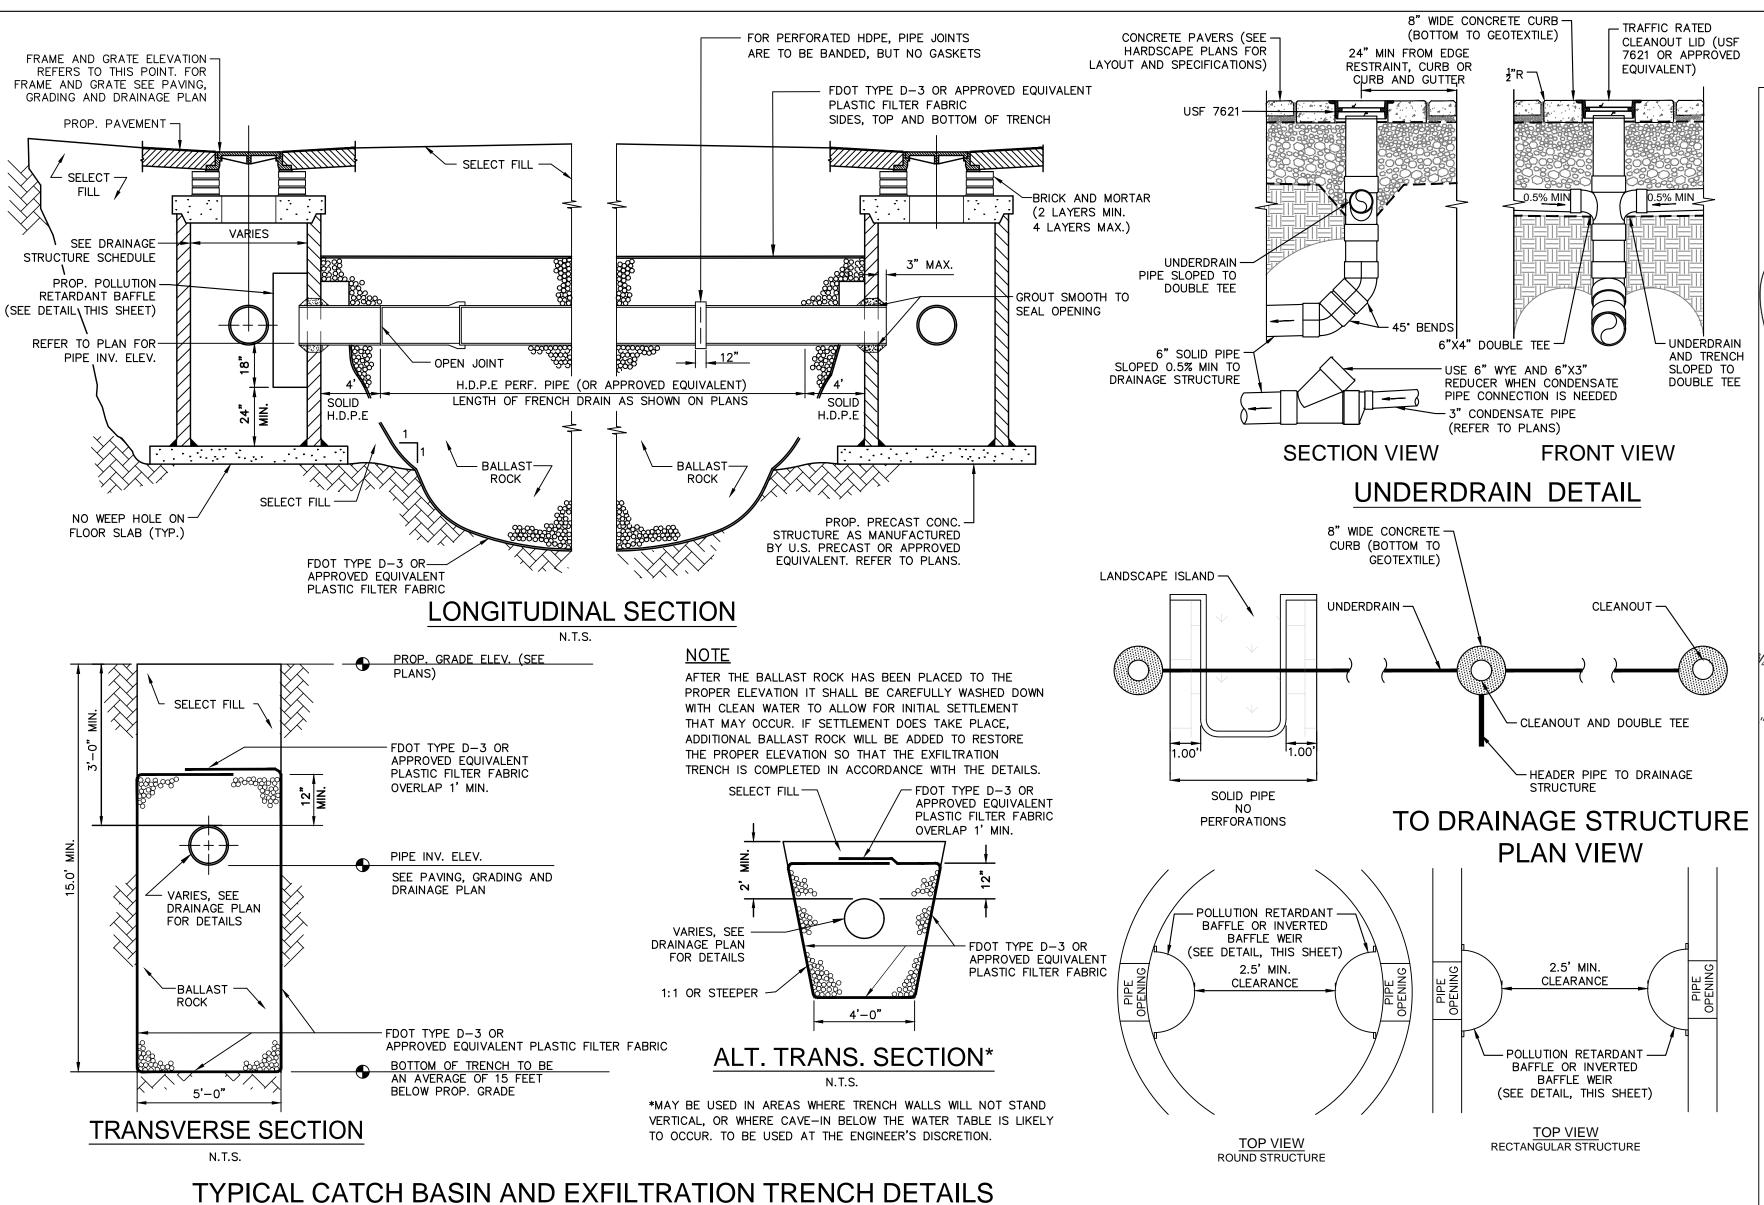
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CONSTRUCTION

**DETAILS** 

Sheet Number:

C11.0



AS PER M.D.C.P.W.D. STANDARD DETAIL SD 1.1 (SHEETS 1 AND 2 OF 3)

PRB CLEARANCE DETAILS N.T.S

# DRAINAGE STRUCTURE STRUCTURAL NOTES:

<u>DESIGN CRITERIA:</u> DESIGN, FABRICATION AND ERECTION OF PRECAST CONCRETE SHALL BE IN ACCORDANCE WITH ACI 318—99 BUILDING CODE REQUIREMENTS FOR REINFORCED CONCRETE AND PCI DESIGN HANDBOOK. DESIGN OF CAST-IN-PLACE CONCRETE SHALL BE IN ACCORDANCE WITH ACI 318-99.

DESIGN LIVE LOADS: THE TOP SLAB OF DRAINAGE STRUCTURE SHALL BE DESIGNED TO CARRY TRAFFIC LOADS (HS 20 LOADING).

GEOTECHNICAL CRITERIA: SOIL BEARING PRESSURE UNDER STRUCTURE ASSUMED TO BE AT MINIMUM 2000 PSF. PRIOR TO INSTALLATION OF DRAINAGE STRUCTURE THE SOIL BEARING CAPACITY OF THE FOUNDATION MUST BE CONFIRMED BY THE CONTRACTOR, THROUGH A CERTIFIED GEOTECHNICAL

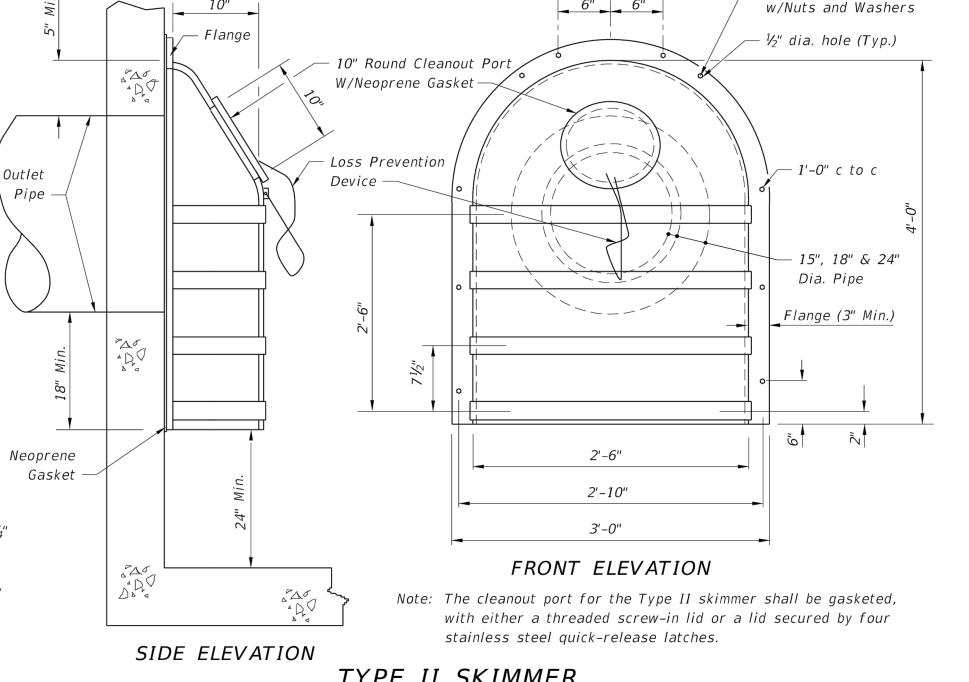
CONCRETE: CONCRETE SHALL BE NORMAL WEIGHT, AND SHALL ATTAIN A 28, DAY COMPRESSIVE STRENGTH OF 4000 PSI AND SHALL MEET THE REQUIREMENT OF ASTM C478. CONCRETE COVER FOR REINFORCEMENT SHALL BE 2 INCHES EXCEPT FOOTING BOTTOM BARS SHALL HAVE 3" COVER.

REINFORCING: REINFORCING STEEL SHALL CONFORM TO ASTM A615, GRADE 60, AND SHALL BE OF U.S. MANUFACTURE.

MORTAR: MORTAR GROUT TO SEAL THE PIPE, TOP SLABS, AND LEVELING COURSE SHALL BE OF SUCH A MIX THAT SHRINKAGE WILL NOT CAUSE LEAKAGE INTO OR OUT OF THE UNIT. CONTRACTOR SHALL SUBMIT SHOP DRAWINGS FOR MORTAR FOR ENGINEER REVIEW AND APPROVAL.

SHOP DRAWINGS: CONTRACTOR SHALL SUBMIT SHOP DRAWINGS, SIGNED AND SEALED BY A FLORIDA LICENSED ENGINEER, FOR PRECAST STRUCTURES TO THE ENGINEER FOR REVIEW AND APPROVAL PRIOR TO THE CONSTRUCTION OF

MANHOLE RING & COVER: ALL MANHOLE RINGS AND COVERS, WITHIN PRIVATE PROPERTY, SHALL HAVE THE WORD "STORM SEWER" CAST ON COVER.



- 1. The Frenchdrain Skimmer is a hooded cover, mounted over an outlet in a catchbasin, that prevents oil and floating debris from exiting the basin. Use this skimmer in Frenchdrain Catchbasins and in other locations where there is a need to prevent oil,
- 2. Place neoprene gasket material between the skimmer and the catchbasin at all points of contact. Trim the gasket neatly to extend  $\frac{1}{2}$  inch beyond the joint on all sides.
- 3. Skimmer baffle, cleanout pipe and angles shall be primarily constructed of either galvanized steel, aluminum, polyvinyl chloride polyethylene, fiberglass or acrylonitrite butadiene styrene. All steel components, other than stainless, shall be hot-dip galvanized.
- 4. Mounting hardware, hinges and latches shall all be stainless steel. Loss prevention device shall be either stainless steel chair
- 5. Material used in construction of skimmer bodies (baffles) and cleanout pipe shall comply with Standard Specification 943 for
- 6. All costs for furnishing and installing a frenchdrain skimmer shall be included in the cost of the basin in which it is installed. Retrofit skimmers shall be paid for as 'modify existing structure'.
- 7. Plastic Skimmers shall contain a minimum of 1.5% by weight of carbon black for UV protection.

## DESIGN NOTES

- 1. The contractor may submit an alternative design prefabricated Frenchdrain Skimmer for approval by the Engineer.
- 2. Show, in the plans, the location of the basin and indicate the interior side(s) of the basin on which a skimmer will be installed.
- 3. Type I Skimmer dimensions shall be based on the outlet pipe diameter as shown in the dimension table.
- 4. Type II Skimmers are to be used only with outlet pipe diameters of 15", 18", and 24".

# POLLUTION RETARDANT BAFFLE (PRB) DETAIL

N.T.S.

(PER FDOT DESIGN STANDARDS INDEX No. 241)

Date Description

> CONSTRUCTION **DETAILS**

STATE OF

DATE: 2/16/2022

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10-30-2021

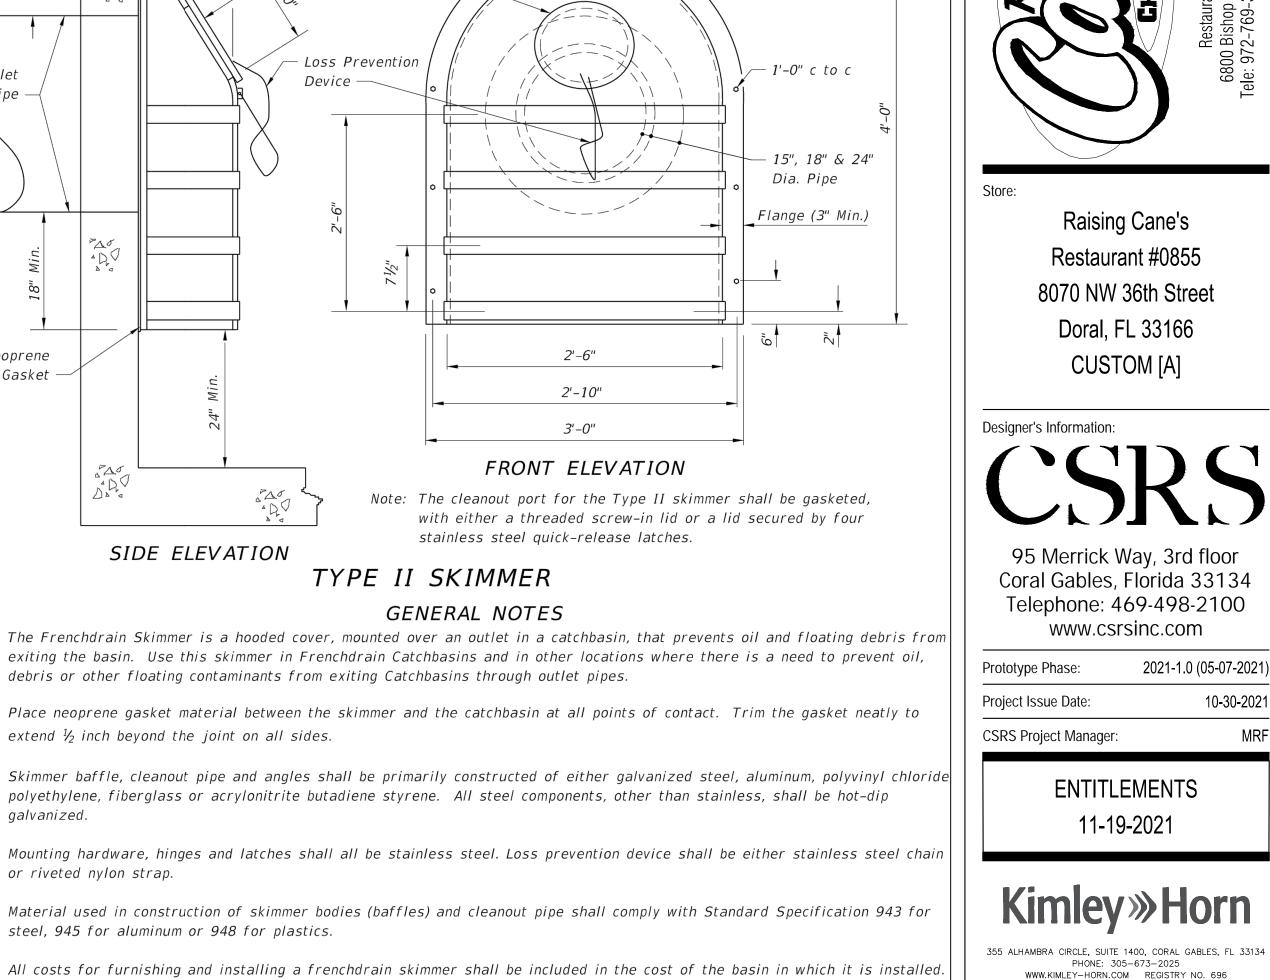
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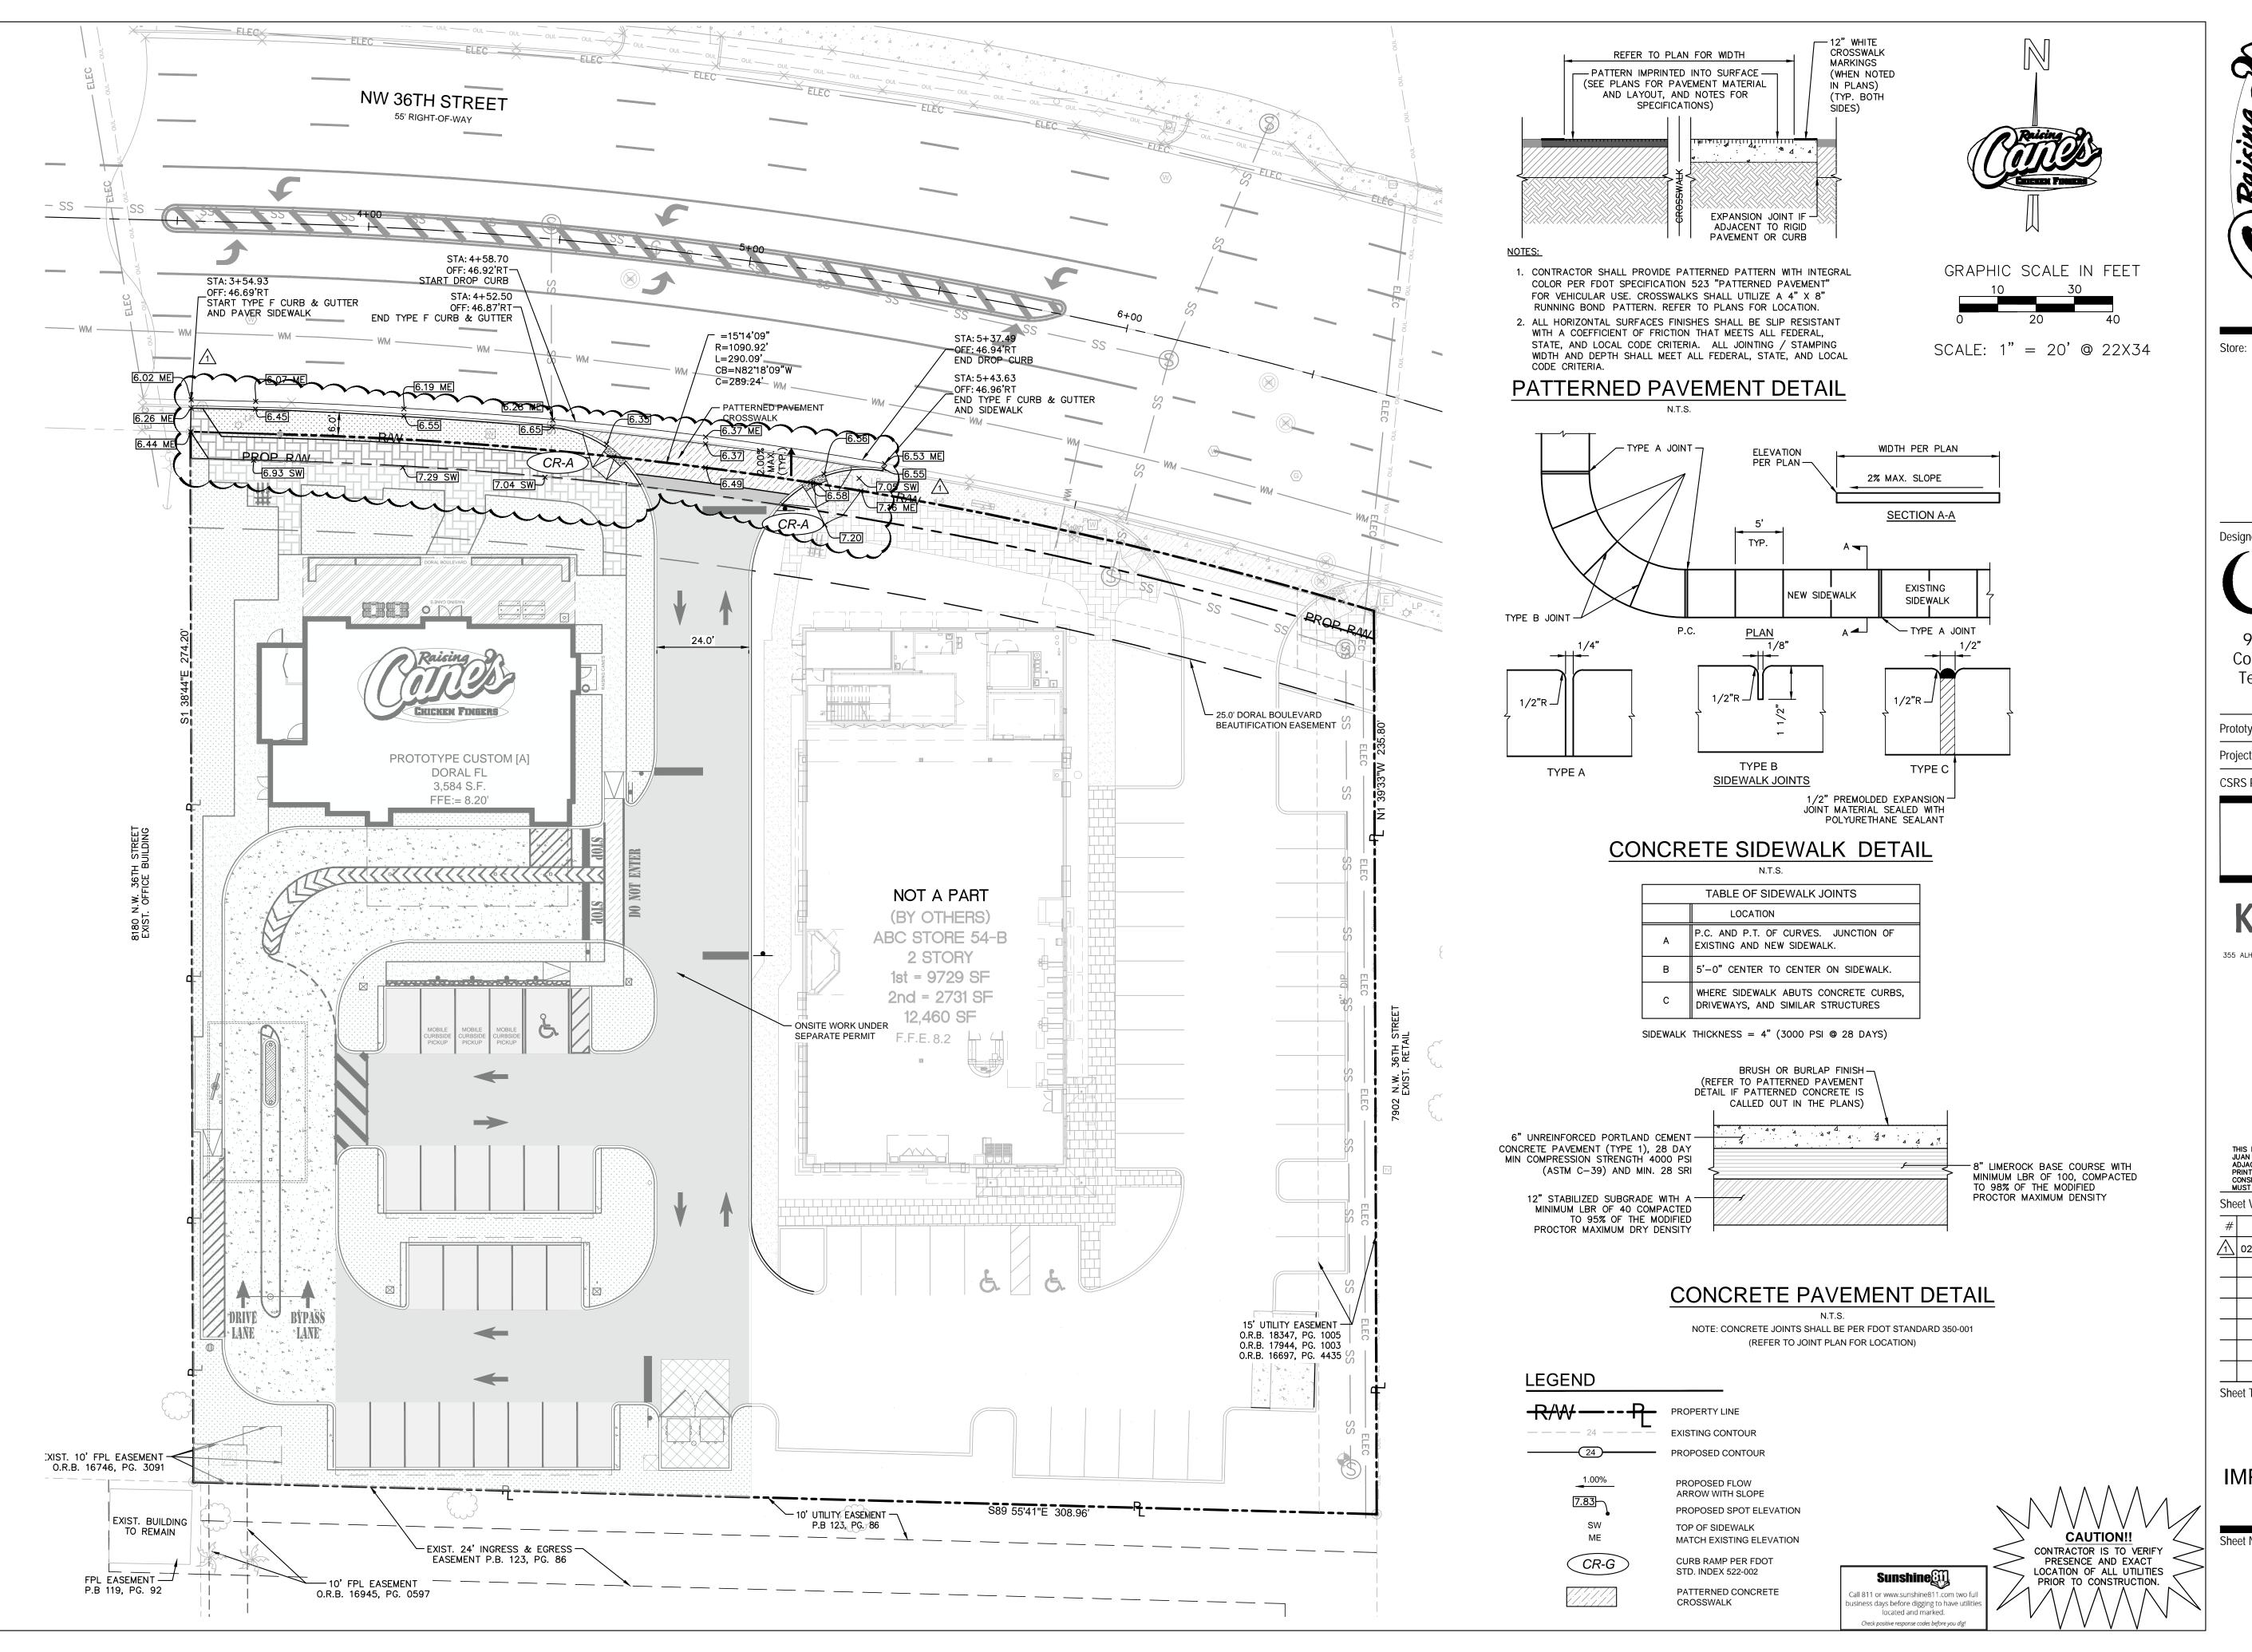
C11.1

CAUTION!! CONTRACTOR IS TO VERIFY PRESENCE AND EXACT LOCATION OF ALL UTILITIES PRIOR TO CONSTRUCTION. Call 811 or www.sunshine811. iness days before digging to have utilit located and marked.



`— Centerline

- Ten  $\frac{1}{4}$ "Ø x 2" Studs



Raising Cane's Restaurant #0855 8070 NW 36th Street Doral, FL 33166 CUSTOM [A]

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**ENTITLEMENTS** 

# **Kimley** » Horn

11-19-2021

355 ALHAMBRA CIRCLE, SUITE 1400, CORAL GABLES, FL 33134 PHONE: 305-673-2025 WWW.KIMLEY-HORN.COM REGISTRY NO. 696

> STATE OF DATE: 2/16/2022

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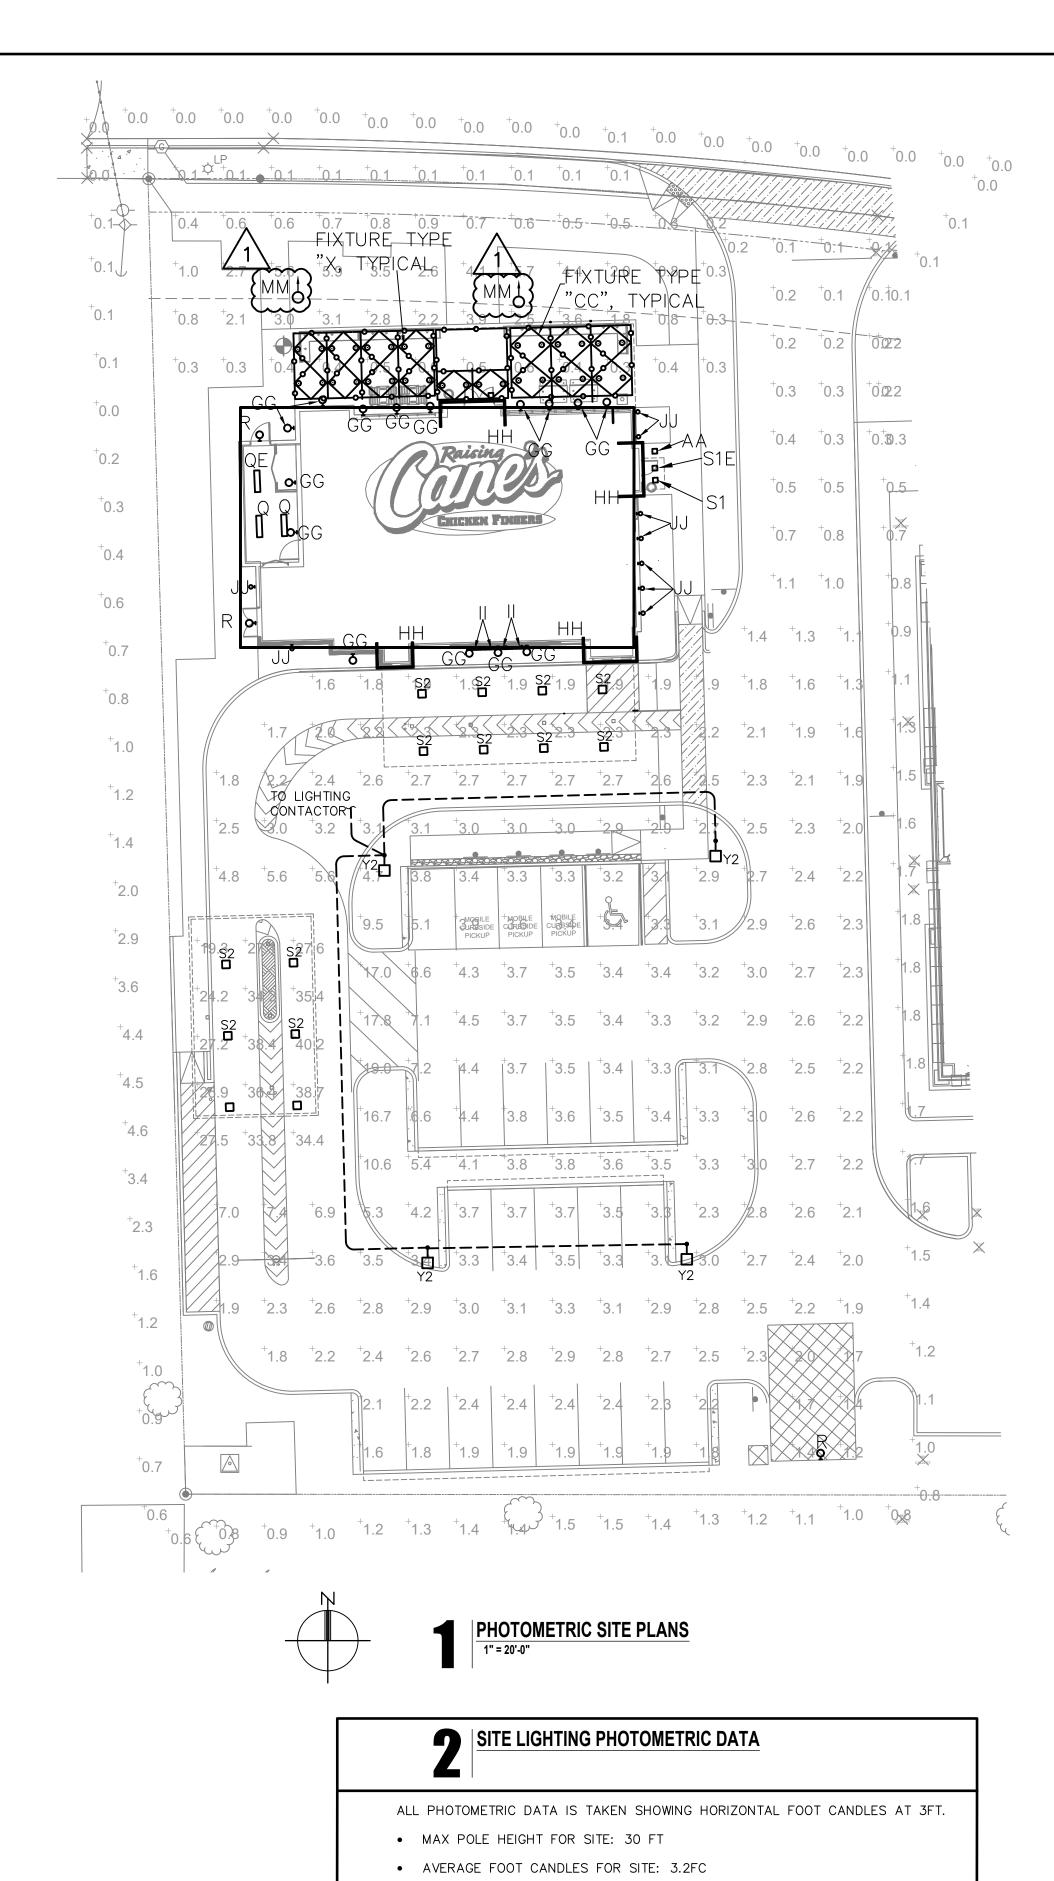
# Date Description 1 02/16/2022 ENTITLEMENTS RESUBMITTAL

Sheet Title:

OFFSITE **IMPROVEMENT PLAN** 

Sheet Number:

C12.0



MAXIMUM FOOT CANDLES FOR SITE: 17FC

MAXIMUM FOOT CANDLES AT PERIMETER: 4.8FC

S1E

2'-0" ENCLOSED, GASKETED LED STRIP FIXTURE WITH REINFORCED FIBERGLASS HOUSING. FIXTURE SHALL BE LISTED FOR WET LOCATIONS. LITHONIA/DMW2-L24-3000LM-ACL-MD-MVOLT-GZ1-35K-80-PS1050 VOLTAGE: 120 FINISH: LAMP: QUANTITY-2'-0" ENCLOSED, GASKETED LED STRIP FIXTURE WITH REINFORCED FIBERGLASS HOUSING. PROVIDE BATTERY BACKUP TO ACTIVATE IN THE EVENT OF A POWER

MANUF/NUMBER: LITHONIA/DMW2-L24-3000LM-ACL-MD-MVOLT-GZ1-35K-80

MANUF/NUMBER: ATLAS/WLMFC43LED VOLTAGE: FINISH: QUANTITY-

LED WALL PACK WITH DIE CAST ALUMINUM HOUSING, SPECULAR REFLECTOR AND BOROSILICATE GLASS REFRACTOR. FIXTURE SHALL BE LISTED FOR WET LOCATIONS.

OUTAGE. FIXTURE SHALL BE LISTED FOR WET LOCATIONS. SENSOR.

MANUF/NUMBER: ACUITY BRANDS/LDN6SQ27/15MVOLTEZ1HSGU REMARKS: SUPPLIED WITH AWNING. CONTRACTOR SHALL CONNECT TO CIRCUIT INDICATED ON MANUF/NUMBER: ACUITY BRANDS/LDN6SQ27/15MVOLTEZ1ELHSG

SUPPLIED WITH AWNING. CONTRACTOR SHALL CONNECT TO CIRCUIT INDICATED ON PLAN, AND PROVIDE A BATTERY BACKUP MOUNTED ABOVE THE TRUSSES ON THE INTERIOR TO POWER THE LIGHT IN THE CASE OF A POWER OUTAGE.

MANUF/NUMBER: LSI/CRUS-SC-LED-SS-50-UE-WHT REMARKS: SUPPLIED WITH MENU CANOPY. CONTRACTOR SHALL CONNECT TO CIRCUIT INDICATED ON PLAN.

MANUF/NUMBER: WAC LIGHTING/FM-2605-BK VOLTAGE: FINISH: **BLACK** QUANTITY-

> 3" LED PENDANT MOUNTED CYLINDER WITH CLEAR SATIN REFLECTOR AND BLACK HOUSING. SHALL BE ENERGY STAR RATED, AND HAVE 0-10V DIMMING. COLOR TEMPERATURE SHALL BE 3000K.

MANUF/NUMBER: LITHONIA/RSX2-LED-P6-50K-R3-HS FINISH: DARK BRONZE QUANTITY- 1 LAMP:

> WATTS- 250 TYPE- LED LED POLE MOUNTED FIXTURE WITH SEGMENTED ALUMINUM OPTICS AND HOUSE SIDE REMARKS: SHIELD. 30' TALL SQUARE STRAIGHT STEEL POLE, LITHONIA SSS-30-5G-DM19-DDB

MANUF/NUMBER: LITHONIA/RSX2-LED-P6-R5 VOLTAGE: 208 DARK BRONZE FINISH: QUANTITY- 1 WATTS- 250

LAMP:

LAMP:

TYPE- LED LED POLE MOUNTED FIXTURE WITH SEGMENTED ALUMINUM OPTICS AND HOUSE SIDE REMARKS: SHIELD. 30' TALL SQUARE STRAIGHT STEEL POLE, LITHONIA SSS-30-5G-DM19-DDB

MANUF/NUMBER: PERFORMANCE LIGHTING/75460-NS/310374 VOLTAGE: 120 FINISH: BLACK

QUANTITY- 1

WATTS- 24 TYPE- LED GROUND MOUNTED LIGHTING FIXTURE. PROVIDE WITH NON-SLIP LENS. REFER TO REMARKS:

DETAIL 2 ON E3.2 FOR CONCRETE MOUNTING. MANUF/NUMBER: TIVOLI/LSL-B-18-S-30-C/LS-CABLE-110/LS-LOCK-4/JT-60-1-5-12-D VOLTAGE: 120

> FINISH: **BLACK** QUANTITY- 1 WATTS- 30 TYPE- LED

STRING LED LIGHTING FIXTURE. PROVIDE WITH ALL MOUNTING HARDWARE AND REMARKS: DRIVERS. COORDINATE SUCH THAT THE LIGHT HAS ALL PERIPHERALS TO BE A COMPLETE WORKING SYSTEM.

DD REMARKS: LED STRING LIGHTS FOR INSTALLATION AFTER LANDSCAPING HAS GROWN. DO NOT

PROVIDE, THEY SHALL BE PROVIDED AT A LATER DATE BY LANDSCAPING TO BE PLACED IN THE PLANTERS AND TREES AROUND THE PREMESIS. POWER VIA EXTERIOR RECEPTACLE CALLED OUT ON E2.1.

LIGHTING FIXTURE SCHEDULE (EXTERIOR)

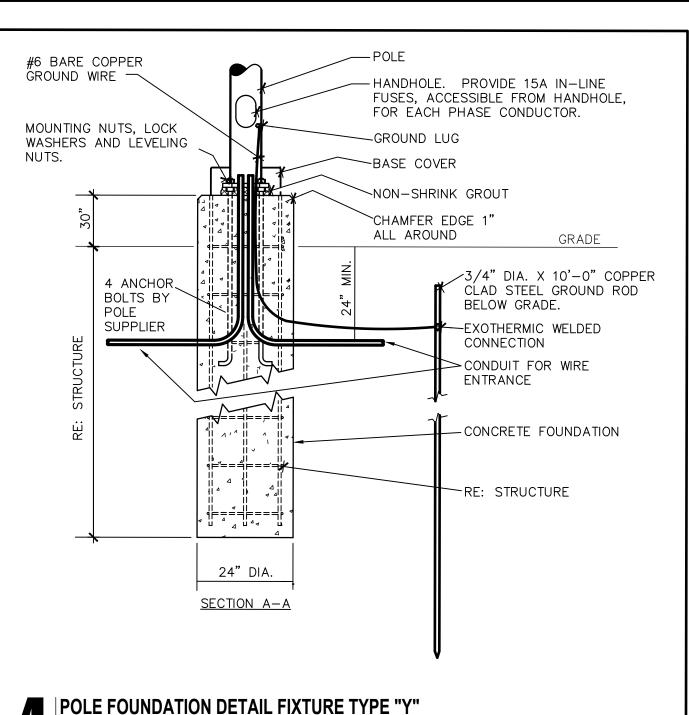
WHITE

QUANTITY-

VOLTAGE:

FINISH:

MANUF/NUMBER: BOCK/VW15-G0/41/G-G0/LVX01-19W-30K-120 VOLTAGE: FINISH: **BLACK** QUANTITY-WATTS-LED JELLY JAR LIGHTING FIXTURE. COORDINATE ELEVATION AND LOCATION WITH ARCHITECTURAL ELEVATIONS. CUSTOM LED COVE LIGHT PROVIDED BY AGI AND INSTALLED BY CONTRACTOR MANUF/NUMBER: VOLTAGE: 120 FINISH: **BLACK** QUANTITY-LAMP: LED WALL MOUNTED WRAP LIGHTS TO BE MOUNTED IN ARCHITECTURAL ELEMENT AT THE ROOF PARAPITS. PROVIDE ALL NECESSARY PERIPHERALS TO HAVE A COMPLETE AND WORKING SYSTEM. PROVIDE DRIVERS IN THE CLOSEST ACCESSIBLE CEILING SPACE OR DIRECTLY NEXT TO AN ACCESS HATCH. DO NOT MOUNT DRIVERS II (BLUE DOG) MANUF/NUMBER: SPI LIGHTING/SEW-12146-3FT-L43W-AN08-120-277V-30K-3FT-RUN-OAP 18'-DF-MCS VOLTAGE: **BLACK** FINISH: QUANTITY-LAMP: REMARKS: LED WALL MOUNTED SIGN LIGHTER. COORDINATE ELEVATION AND LOCATION WITH ARCHITECTURAL ELEVATIONS. PROVIDE THIS FOR THE BLUE DOG MURAL. II (FLAMING MANUF/NUMBER: SPI LIGHTING/SEW-12146-3FT-L43W-AN08-120-277V-30K-3FT-RUN-OAL 14'-DF-MCS ARROWAND VOLTAGE: 120 MURAL). FINISH: **BLACK** QUANTITY-LED WALL MOUNTED SIGN LIGHTER. COORDINATE ELEVATION AND LOCATION WITH ARCHITECTURAL ELEVATIONS. PROVIDE THIS FOR THE FLAMING ARROW. MANUF/NUMBER: MODERN FORMS/CI-WS-W70612 VOLTAGE: 120 FINISH: QUANTITY-LED WALL MOUNTED ACCENT LIGHT. COORDINATE ELEVATION AND LOCATION WITH ARCHITECTURAL ELEVATIONS. MANUF/NUMBER: GLOBAL LIGHTING PERSPECTIVE/GC7023-G2LED40-T3-40K 277 VOLTAGE: FINISH: **BLACK** LED PEDESTRIAN LIGHT TYPE 3 OPTICS. PROVIDE WITH GP206-10 POLE AND 4" FOUNDATION. COORDINATE POLE FOUNDATION WITH CIVIL. \.....



Restaurant:


Raising Cane's Restaurant #0855 8070 NW 36th Street Doral, FL 33166 CUSTOM [A]

Designer's Information:

8555 United Plaza Blvd. Baton Rouge, Louisiana 70809 Telephone: 225 769-0546 www.csrsinc.com

| Prototype Phase:      | 2021-2.   |
|-----------------------|-----------|
| Project Issue Date:   | 00-00-000 |
| CSRS Project Manager: | LI        |

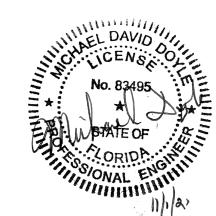50% Check Set 11-02-2021




**ENGINEERS** 8417 Kelwood Avenue Baton Rouge, Louisiana 70806 225.926.5600

www.astengineers.us

| # | Date       | Description     |
|---|------------|-----------------|
| 1 | 01/19/2022 | PERMIT COMMENTS |
| 2 | 02/16/2022 | REVISION 1      |
|   |            |                 |
|   |            |                 |
|   |            |                 |
|   |            |                 |
|   |            |                 |

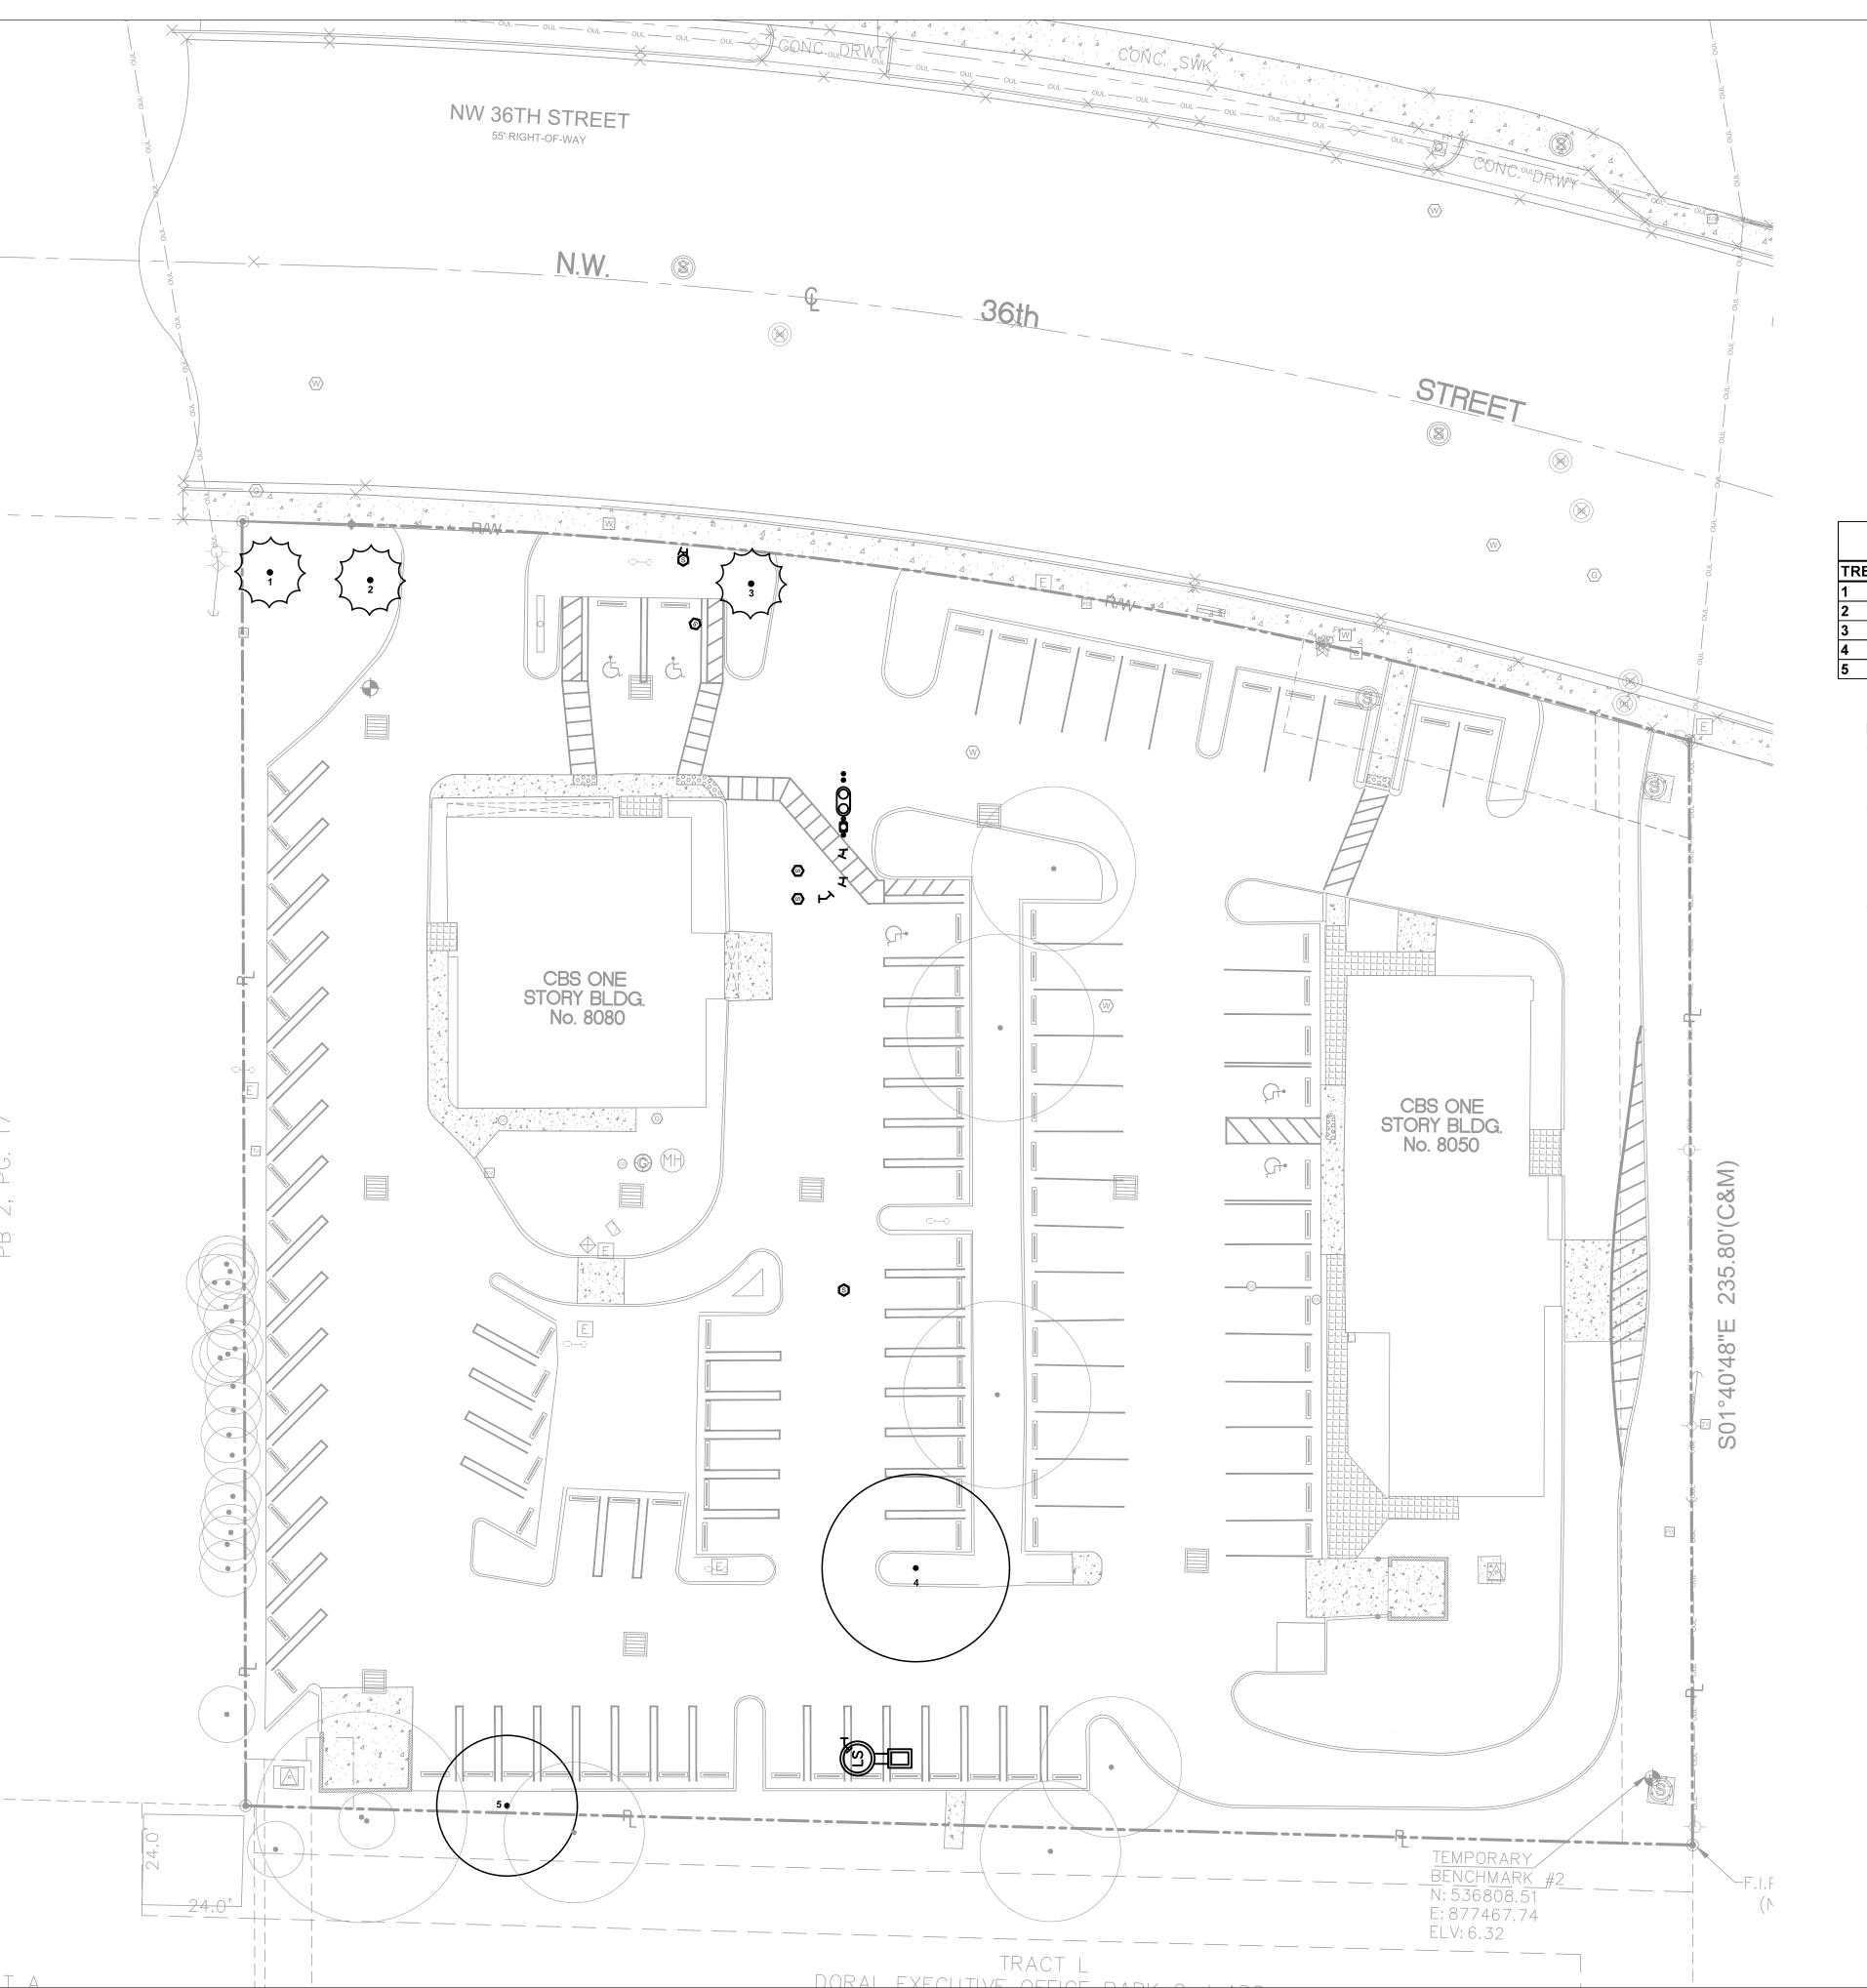Photometric Site Plan





GRAPHIC SCALE IN FEET

SCALE: 1" = 20' @ 22X34

| TREE INVENTORY |                    |                  |           |             |             |  |
|----------------|--------------------|------------------|-----------|-------------|-------------|--|
| TREE NO.       | SCIENTIFIC NAME    | COMMON NAME      | DBH (IN.) | HEIGHT (FT) | CANOPY (FT) |  |
| 1              | Roystonea regia    | Royal Palm       | 18        | 50          | 15          |  |
| 2              | Roystonea regia    | Royal Palm       | 18        | 40          | 15          |  |
| 3              | Roystonea regia    | Royal Palm       | 18        | 40          | 15          |  |
| 4              | Conocarpus erectus | Green Buttonwood | 25        | 45          | 40          |  |
| 5              | Bucida buceras     | Black Olive      | 20        | 45          | 30          |  |

- Information utilized in preparation of the Tree Inventory and Tree Disposition plans ascertained from and reliant upon 'ALTA/NSPS Land Title Survey' prepared by Hadonne, Corp., dated December 22, 2021.
- Protective barriers shall be installed at the perimeter of preserved vegetation at the commencement of any site improvements and shall remain in place until completion of construction. Barriers shall be highly visible with brightly colored all-weather mesh material or equivalent. Refer to Civil Engineering plans for additional requirements and details.
- Contractor shall take all necessary precautionary measures during the removal of trees and palms under powerlines to insure a safe condition. Contractor shall engage a licensed ISA certified arborist experienced with working around high voltage to supervise the removal work.

# TREE SURVEY GRAPHIC LEGEND

TREE #

EXISTING CANOPY TREE



EXISTING TREE

NOT IN SCOPE

siness days before digging to have utili located and marked.



Raising Cane's Restaurant #0855 8070 NW 36th Street Doral, FL 33166 CUSTOM [A]

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6767 Perkins Road, Suite 200 Baton Rouge, Louisiana 70808 Telephone: 225 769-0546 www.csrsinc.com

| rototype Phase: | 2021-1.0 (05-07-2021) |
|-----------------|-----------------------|
|                 |                       |

Project Issue Date:

CSRS Project Manager:

**ENTITLEMENTS** 

10-30-2021

11-19-2021

# **Kimley** » Horn

355 ALHAMBRA CIRCLE, SUITE 1400, CORAL GABLES, FL 33134 PHONE: 305-673-2025 WWW.KIMLEY-HORN.COM CA 00000696

THIS ITEM HAS BEEN DIGITALLY SIGNED AND SEALED BY BENJAMIN VAN JOHNSON, PLA ON THE DATE ADJACENT TO THE SEAL. PRINTED COPIES OF THIS
DOCUMENT ARE NOT
CONSIDERED SIGNED
AND SEALED AND THE
SIGNATURE MUST BE
VERIFIED ON ANY
ELECTRONIC COPIES.

DATE: 2/16/2022

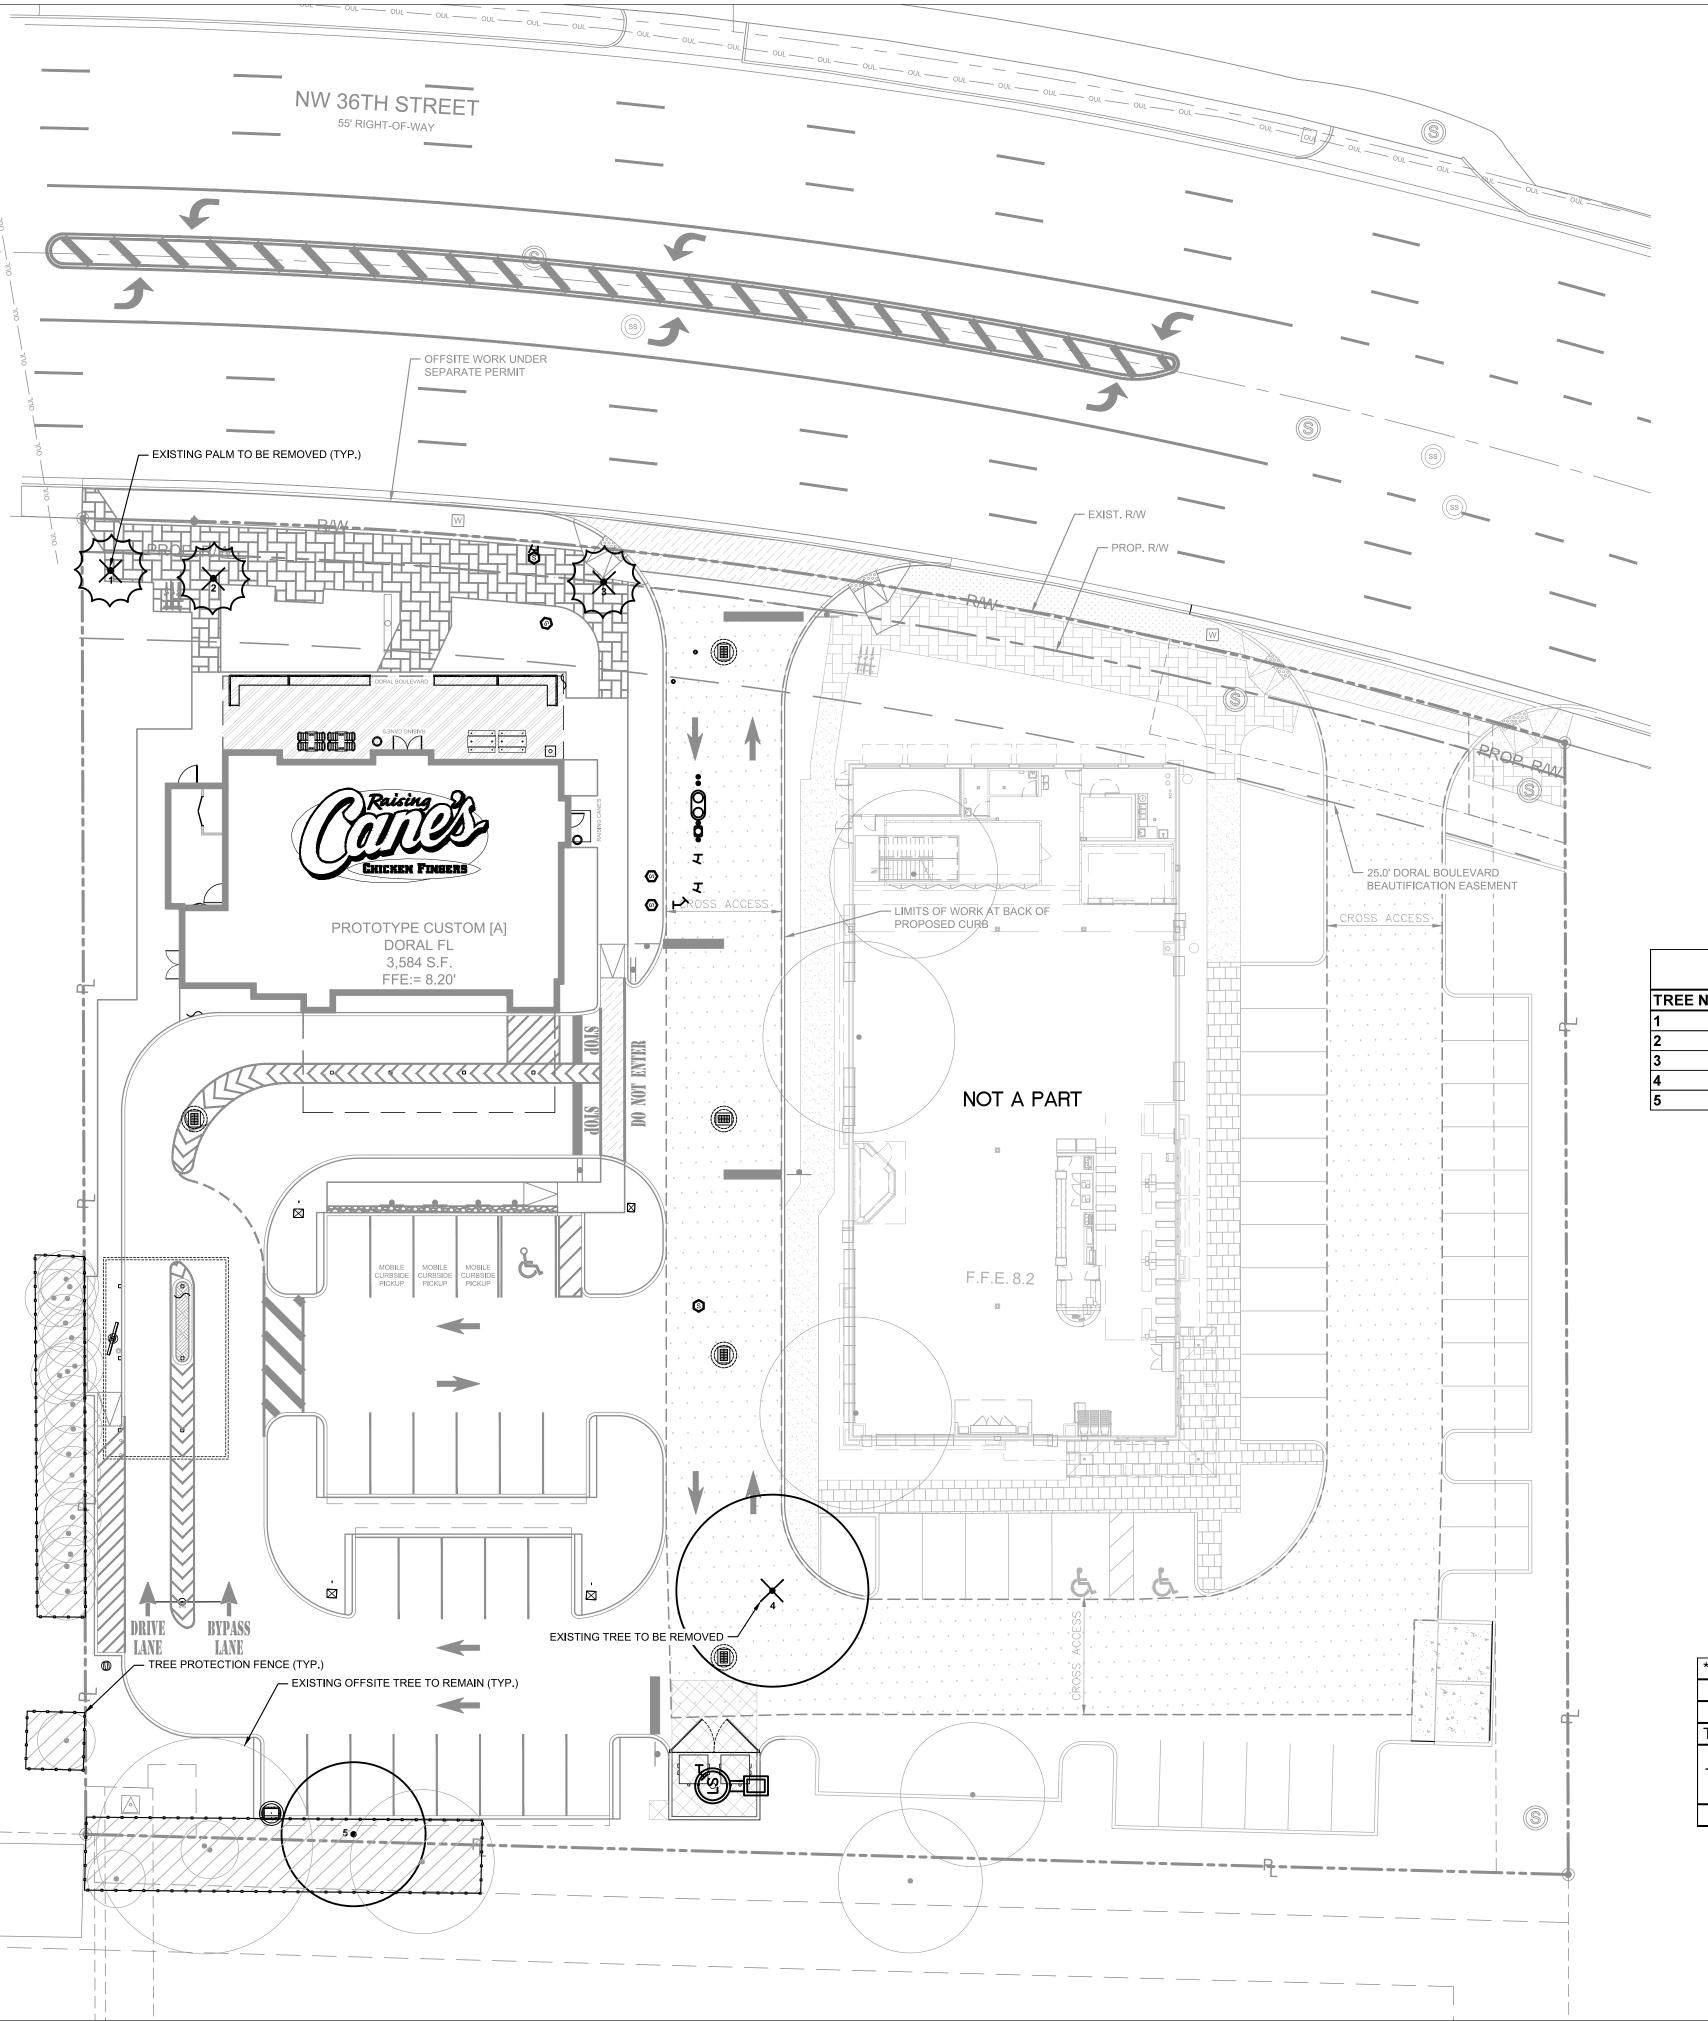
| She | et Versions: |                        |
|-----|--------------|------------------------|
| #   | Date         | Description            |
| 1   | 02/16/2022   | ENTITLEMENTS RESUBMITT |
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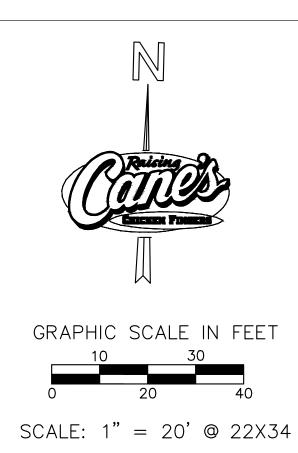
TREE SURVEY

Sheet Title:

Sheet Number: L-100

**CAUTION!!** CONTRACTOR IS TO VERIFY
PRESENCE AND EXACT
LOCATION OF ALL UTILITIES
PRIOR TO CONSTRUCTION.





#### TREE DISPOSITION COMMON NAME DBH (IN.) HEIGHT (FT) CANOPY (FT) DISPOSITION SCIENTIFIC NAME Roystonea regia Royal Palm Remove Royal Palm Remove Roystonea regia 18 15 Royal Palm 18 40 15 Remove Roystonea regia Conocarpus erectus **Green Buttonwood** 25 45 40 Remove

20

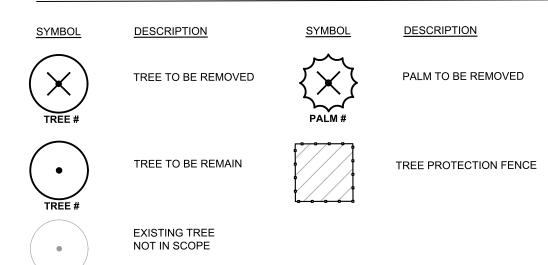
45

30

Remain

# TREE DISPOSITION GRAPHIC LEGEND

**Black Olive** 



Bucida buceras

• The contractor shall be responsible for consulting an ISA Certified Arborist to provide written direction and be present at the time of any work being performed within the existing tree canopy limits (critical root zone). Contractor shall hand excavate all operations within the critical root zone to prevent adverse impacts to the existing root system.

| *Specimen Canopy Removed =    | 1,256 sf  |
|-------------------------------|---|
| Other Canopy Removed =        | 529 sf  |
| Total Canopy to be Replaced = | 3,042 sf  |
| Total Replacement Provided =  | 15,200 SF See Sheet L-300 for Replacement Table |
| * Specimen to be replac       | ed by double the canopy removed.                |





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2021-1.0 (05-07-2021) Prototype Phase:

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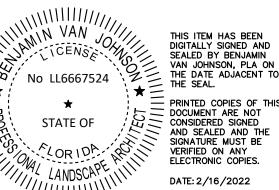
10-30-2021 Project Issue Date:

CSRS Project Manager:

**ENTITLEMENTS** 11-19-2021

355 ALHAMBRA CIRCLE, SUITE 1400, CORAL GABLES, FL 33134 PHONE: 305-673-2025

WWW.KIMLEY-HORN.COM CA 00000696



| She | Sheet Versions: |                          |  |  |  |  |  |
|-----|-----------------|--------------------------|--|--|--|--|--|
| #   | Date            | Description              |  |  |  |  |  |
| 1   | 02/16/2022      | ENTITLEMENTS RESUBMITTAL |  |  |  |  |  |
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|     |                 |                          |  |  |  |  |  |
|     |                 |                          |  |  |  |  |  |

Sheet Title:

TREE DISPOSITION PLAN

Sheet Number: L-200

located and marked.

```
TREE REMOVAL/TRANSPLANT SPECIFICATIONS
 PART 1 - EXPLANATION OF NATURAL RESOURCE PRESERVATION PROCEDURES
                                                                                                                                                      1. Natural Resource Contractor shall remove and discard all trees shown on the tree removal plan
       The sequence of operation is critical to the protection of the trees.
                                                                                                                                                             to be removed, see Existing Tree Schedule. All trees shown to be removed shall be
        A. Tree canopy pruning is to compensate for root loss and damage.
                                                                                                                                                              felled with a chain saw and stump ground 6" below surface. Any tree shown to be removed and
       B. Fertilization is to stimulate root systems to heal quickly and grow back in root-pruned areas. It also
                                                                                                                                                             is in an area where compaction is critical the tree shall be felled with a chain saw and stump
               produces faster availability of food to a root system that is less efficient due to the damage incurred.
                                                                                                                                                              removed by Clearing Contractor. Care must be taken not to damage trees marked for
        C. Root pruning is to remove the roots with a trenching procedure that is less damaging to the roots than
                                                                                                                                                      2. Clearing Contractor is to clear all remaining trees after the Natural Resource Fencing is installed.
                regular construction.
                                                                                                                                                             If fence is damaged, repair is to be performed immediately. See Fence Penalties. Care must be
        D. Mulching is to increase moisture-holding capacity and keep the temperature of the soil more constant.
                                                                                                                                                              taken not to damage trees marked for preservation.
                                                                                                                                                      3. All wood from removals shall be hauled from the site the same day, except for tops. All tops are
                                                                                                                                                             to be mulched and stockpiled or hauled directly to mulched areas, if scheduling permits. (See
         A. Combo Fence - Combination silt and natural resource protection fence (see detail).
                                                                                                                                                              landscape plans for mulching). All excess wood chips should be hauled off site after landscaping
        B. Critical Root Zone - The mass of roots surrounding a tree that is required by the tree to live. The critical
               root zone is often much larger than the canopy. Shown on the plans as dashed circles.
                                                                                                                                                      4. Clearing Contractor is to haul off all stumps.
        C. DBH - Diameter Breast High - Indicates the location on the trunk, approximately 4.5' above ground, to
                                                                                                                                                      5. All burn pits if applicable must be approved by the Project Urban Forester and owner.
                measure the diameter of a tree.
        D. Grade - Refers specifically to grade on the Significant Tree or Transplant Schedule. The grade of a tree
                refers to the overall health and appearance of the tree. The grades range from "A" being excellent to "D"
                                                                                                                                                      1. All clean backfill/clean topsoil necessary for transplant operations shall fall within the limits
                being hazardous.
                                                                                                                                                             of the planting specifications, located elsewhere in the contract documents.
        E. Preserve Trees - Trees that are to be saved in place.
        F. Project Urban Forester - A representative, hired and paid for by the owner, that supervises
                                                                                                                                               H. Machine Dug Transplant Operation
               the construction of the procedures shown on the natural resource plans.

    Dig transplant-receiving hole.

        G. Protection Zones/Areas - Any area enclosed partially or completely by a fence shown on the natural
                                                                                                                                                      2. Set spade dug root ball into receiving hole 4"-6" above existing grade.
                                                                                                                                                      3. Wash sand or topsoil into air pockets between root ball and receiving hole.
        H. Spade Transplant - A tree transplanted using a tree spade machine.
                                                                                                                                                      4. Install topsoil ring, 4" high, 10" wide, around perimeter of root ball. Mix MycorrTree Tree
        I. Transplanted Trees - Trees that are to be moved by hand, spade, crane or gantry to another location.
                                                                                                                                                              Saver Mycorrhizal Transplant Inoculant into topsoil ring. See Part 4 Section B for procedure.
                                                                                                                                                      5. Install 4"-6" mulch from perimeter of root ball to within 6" of tree trunk.
 PART 3 - PRODUCTS FOR TREE TREATMENT
                                                                                                                                                      6. Cover topsoil ring with 1" of mulch and extend mulch 4"-6" deep, 6" away from perimeter of
       Every effort shall be made to utilize chemicals of an organic or biodegradable nature in order to offer the
       least impact to the natural environment. Contractor is responsible for mixing, applying, and disposal of
                                                                                                                                                      Water transplant.
       all chemicals in accordance with strict adherence to manufacturer's directions, unless otherwise directed
       in these drawings.
                                                                                                                                               I. Holding Area for Transplants
       A. Chemical Treatments.
                                                                                                                                                      1. Coordinate with Owner's Representative for location. Coordinate construction and scheduling with
                1. Recommended Fertilizer:
                                                                                                                                                             Owner's Representative
                        a. "XL Injecto Feed", product of Doggett Corp., Lebanon, New Jersey (908) 236-6335.
                                                                                                                                                     2. Install protection fencing surrounding holding area after all transplants have been moved unless otherwise
                               Apply a 12/24/24 ratio with a dilution rate 1/3 more water than specified on bag.
                                                                                                                                                              instructed by Owner's Representaive.
                2. Recommended Wetting Agent:
                                                                                                                                                      3. Transplants shall be placed into the soil at the holding area unless the soil is deemed
                       a. "APSA-80", product of Amway Corp. (800) 253-7088.
                                                                                                                                                              unacceptable by Project Landscape Architect. If unacceptable soil is encountered, the holding area
                3. Mycorrhizal Treatment:
                                                                                                                                                              shall be relocated to a new location or excavated to a depth determined by Project Landscape Architect
                       a. Plant Health Care, Inc. (800) 421-9051.
                                                                                                                                                              and new approved topsoil installed. Transplants shall be backfilled with approved topsoil
                               Products of the same type from other sources shall not be excluded, provided they possess like
                                                                                                                                                      4. Install three (3) 12" tensiometers. One on opposite corners and one in the middle of the holding
                               physical and functional characteristics and are approved by the Project Landscape Architect.
                                                                                                                                                             area. Project Landscape Architect shall adjust locations of tensiometers per observations in the field.
                                                                                                                                                      5. General Contractor shall supply temporary irrigation to the holding area. Temporary irrigation
                                                                                                                                                             shall consist of above the ground PVC or Polyethylene pipe, spray or rotor heads (with head to
                1. "Astro", a product of FMC Corporation. (800) 321-1362.
                                                                                                                                                              head coverage) and a controller. Set schedule per Part 7.
       C. Fencing Materials.
                                                                                                                                      PART 5 - PENALTIES
                 1. Woven wire fence (Minimum 14.5 gauge maximum 6" mesh spacing).
                2. Artic Vinyl Flagging, Color: International Orange. Forestry Suppliers Catalog (800) 647-5368.
                                                                                                                                                      1. If any damage to trees or other natural resources should occur by accident or negligence during
                       Artic Vinyl Flagging is required due to strength and longevity. No substitution without approval
                                                                                                                                                              the construction period, the Project Urban Forester shall appraise the damage and make
                       of Project Urban Forester.
                                                                                                                                                              recommendations to the owner for repair by the General Contractor
                3. 6' T-Bar Post.
                                                                                                                                                      2. If any tree that is designated to be saved is deemed substantially damaged or dead due to
                4. T-Bar Post Caps.
                                                                                                                                                             construction damage, at the sole discretion of Project Landscape Architect, the following penalties will
                         a. Rebar Caps. Brilliant Orange mushroom type as manufactured by Mutual Industries
                                                                                                                                                              a. Trees 1" - 12" of trunk diameter, measured at 1' from the ground will be valued at
                       b. R-4 T-Bar Post Caps as manufactured by RammFence (800) 434-8455 or equal.
                                                                                                                                                                     $300.00 per diameter inch.
                                                                                                                                                              b. Trees 13" and above of trunk diameter measured at 4.5' from the ground will be valued
                                                                                                                                                                     at $400.00 per diameter inch.
 PART 4 - EXECUTION
                                                                                                                                                              c. If any tree designated to be saved is removed from the site without permission of the
        A. Tree Canopy Pruning Operation
                                                                                                                                                                     owner's representative, the penalty will be $600.00 per inch.
                 1. Trees to be pruned shall include only trees affected by construction or as designated on
                       Significant Tree or Transplant Schedule. This item is to be coordinated by the Project Urban
                                                                                                                                               B. Repair of Damaged Natural Resource Fences
                                                                                                                                                         . If any damage to Natural Resource Fences should occur by accident or negligence, the General
                2. All pruning shall be done in accordance with ANSI A300 (Part 1) Pruning.
                                                                                                                                                              Contractor will be responsible for immediate repairs of the initial damage. Fines will be imposed
                3. Certified Arborist shall perform all pruning.
                4. Pruning shall consist of the following methods:
                                                                                                                                                              a. First time offense, a fine of $200.00 will be imposed.
                         a. Cleaning, see Sect. 5.6.1.
                                                                                                                                                              b. In the event the fence is not repaired within 24 hours to the Owner's Representative's
                        b. Interfering branch removal.
                                                                                                                                                                     satisfaction, an additional fine of $100.00 per day will be imposed, until the fence is
                       c. Raising, see Sect. 5.6.4. Height to be 6' (min.) in parking lot areas only.
                                                                                                                                                                     satisfactorily repaired.
                                                                                                                                                              c. In the event a natural resource is damaged due to fence being down, a fine of $200.00
                1. Only trees affected by construction or as shown on the Tree Removal Plan shall be treated
                                                                                                                                                                     plus the cost of repair or replacement of the natural resource as appraised by the Project
                                                                                                                                                                      Landscape Architect will be imposed.
                2. Trees specified to receive fertilizer shall be treated in the fall of 2008. Preserve Tree Injectable
                       Fertilizer Treatment. See detail sheet.
                                                                                                                                        PART 6 - NATURAL RESOURCE PROTECTION SEQUENCE
                        a. Mix fertilizer with a dilution rate 1/3 more water than label instructions into a tank with
                                                                                                                                               A. The sequence of tree treatment and preservation measures shall be:
                               agitation capability (15lbs. = 133 Gallons).

    Root Pruning and Root Barriers.

                        b. Mix Wetting Agent at a rate of 5 oz. Per 100 gallons of fertilizer solution into same
                                                                                                                                                        2. Natural Resource Fencing.
                              tank with fertilizer. Agitate mix.
                                                                                                                                                        3. Clearing and Grading.
                       c. Inject the mixture with a hydraulic injection system set at 100 to 150 p.s.i. for sandy
                                                                                                                                                       4. Tree Pruning.
                                                                                                                                                       Fertilization.
                                Inject at the rate of one third (1/3) gallon at each injection site.
                                                                                                                                                       Insecticide
                         d. Critical Root Zone areas shall be injected, where possible, in the Critical Root Zone
                                                                                                                                                               General Contractor's Surveyor shall stake all site improvements in order to facilitate accurate
                               area plus 2' beyond Critical Root Zone, but not beyond Root Prunes. See detail.
                                                                                                                                                               location of trenching and fencing operations.
                         e. Fertilizer shall be installed prior to installation of any aeration systems.
                                                                                                                                               B. Maintain and repair Natural Resource fencing during site construction operations.
                               AT THE REQUEST OF THE SPECIFIER, EMPTY PRODUCT BAGS TO BE
                                                                                                                                               C. General Contractor's access to Fenced protection areas will be permitted only
                               RETURNED TO THE SPECIFIER FOR PROOF OF USE.
                                                                                                                                                     with approval of owner's representative.
                3. Transplant Injectable Fertilizer Treatment.
                                                                                                                                               D. Perform any excavation or grading required within the fenced root zone areas by hand. This
                       a. Mix fertilizer with a dilution rate 1/3 more water than label instructions into a tank with
                                                                                                                                                      operation is to be supervised by the Project Landscape Architect or Owner's Representative.
                               agitation capability (15lbs. = 133 Gallons).
                                                                                                                                               E. Limit required grading to 3" cut or fill within the fenced tree root zone areas. All grading to be
                        b. Mix Wetting Agent at a rate of 5 oz. Per 100 gallons of fertilizer solution into same
                                                                                                                                                     supervised by the Owner's Representative.
                              tank with fertilizer. Agitate mix
                                                                                                                                                F. Clear by hand designated trees, shrubs, vines and groundcover from protected root zone areas.
                       c. Inject the mixture with a hydraulic injection system set at 100 to 150 p.s.i. for sandy
                                                                                                                                               G. Do not install conduit, sprinklers, or any utility line in any critical root zone area without the
                               soils, 200 p.s.i. for silt/clay soils, into the upper 6-12 inches of soil with a soil probe.
                                                                                                                                                     approval of the Project Landscape Architect.
                               Inject at the rate of one third (1/3) gallon at each injection site.
                        d. See transplant details on this sheet for injection locations.
                              EMPTY PRODUCT BAGS TO BE STOCKPILED FOR INSPECTION BY PROJECT
                                                                                                                                              Every effort shall be made to water the transplants as shown below. The Landscape
                                LANDSCAPE ARCHITECT PRIOR TO DISPOSAL.
                                                                                                                                               Architect and/or Owner's Representative shall inspect all irrigation zones during the initial irrigation
                4. Transplant Inoculant & Biostimulant. See Detail Sheet.
                                                                                                                                              months and adjust settings accordingly to insure proper watering. Water in all transplants immediately
                        a. Use one 3 oz. Packet of MycorTree Tree Saver Transplant Mycorrhizal Transplant
                                                                                                                                              after planting. Tree Relocation Contractor shall water by hand or by temporary irrigation, all
                                Inoculant for every 1-foot diameter of root ball. Mix inoculant in 10" wide topsoil ring
                                                                                                                                              transplants after planting as required by Landscape Architect or Owner's Representative until permanent
                               around the root ball.
                                                                                                                                               irrigation is installed and operating. Irrigation Contractor shall install systems and set controllers as
                        b. Mix one 4 oz. Bag of MycorTree Tree Saver Injectable Mycorrhizal Inoculant and 4
                               packs (to equal 1 pound) PHC BioPack per 100 gallons of water.
                                                                                                                                               A. Transplant Irrigation Zones & Holding Area Zones
                         c. Agitate for 10 minutes
                                                                                                                                                       Use the following watering schedule for all transplants:
                         d. Inject the mixture with a hydraulic injection system set at 100 to 150 p.s.i. for sandy
                                                                                                                                                        1. Set the controller to water for the following limits:
                               soils, 200 p.s.i. for silt/clay soils, into the upper 6-12 inches of soil with a soil probe.
                                                                                                                                                               First 90 days = 15 minutes, 4 times a week. (0.5" per application = 2" per week)
                               Inject at the rate of one third (1/3) gallon at each injection site. See transplant details on
                                                                                                                                                               90 days - 270 days = 2 times a week.(1" per application = 2" per week)
                               this sheet for injection locations.
                                                                                                                                                               270 days on = 2 times a week.(0.5" per application = 1" per week)
                                      EMPTY PRODUCT BAGS TO BE STOCKPILED FOR INSPECTION BY PROJECT
                                                                                                                                                               Irrigation within current watering restrictions, as applicable.
                                      LANDSCAPE ARCHITECT PRIOR TO DISPOSAL.
                       Transplant Maintenance
                                a. Approximately one year after planting, the Tree Relocation Contractor shall refertilize
                                      all transplants utilizing the same procedure.
                        1. Apply "Astro" as a topical solution if recommended by Project Landscape Architect or by these plans.
                               Notify Project Landscape Architect if an infestation is noticed. Apply around base of trunk to soil line,
                               trunk and any limb 1/3 the size of the trunk to 25'-30' high. Insure complete coverage. Reapply
                               "Astro" 2-3 months after initial application utilizing same procedure.
                       2. Follow all manufacturers' recommendations concerning application when applying "Astro".
                               Read all warning labels. Any pets, as well as, the pets food and water bowls should be removed
                               from the area and any swimming pools should be covered. Coordinate with Project Urban
                               Forester for further instruction.
                D. Root Pruning Trenching Operation
                         1. Trenching locations shall be approved in the field by the Project Landscape Architect.
                       2. Trenching equipment that will turn at high RPM's is preferred. Trenching equipment is to be
                               used to perform all root pruning operations.
                              A minimum depth of three feet is required. Clean cut roots in trench on tree side with loppers or
                               chain saw after trenching is complete.
                       3. The trench shall be backfilled and compacted immediately.
                       4. Contractor shall root prune hardwood species per the written specifications of a licensed ISA certified arborist
                            prior to relocation or a minimum of 90 days, whichever is more stringent. Contractor shall ensure material is
                            properly braced to ensure a safe condition at all times and require appropriate watering during root pruning
```

to ensure survival.

E. Natural Resource Protection (or Tree Protection) Fencing

2. Fencing is to be located accurately per plan by General Contractors Surveyor.


1. See details for types and locations.

6'H "PERIMETER PLUS" CONSTRUCTION FENCE BY CONWED PLASTICS 1) OR OWNER'S REPRESENTATIVE APPROVED EQUAL. SUBMIT PRODUCT INFORMATION FOR APPROVAL PRIOR TO INSTALLATION. 2) 8' TALL METAL "T" POSTS OR 2" x 2" X 8' PRESSURE TREATED WOOD POSTS WITH 24" BURIAL BELOW GRADE. INSTALLATION NOTES A. POST SELECTION SHOULD BE BASED ON EXPECTED STRENGTH NEEDS AND THE LENGTH OF TIME FENCE WILL BE IN PLACE. FLEXIBLE FIBERGLASS ROD POSTS ARE **ELEVATION** RECOMMENDED FOR PARKS, ATHLETIC EVENTS AND CROWD CONTROL INSTALLATIONS. METAL "T" POSTS OR TREATED WOOD POSTS ARE TYPICALLY USED FOR CONSTRUCTION AND OTHER APPLICATIONS. B. POSTS SHOULD BE DRIVEN INTO THE GROUND TO A DEPTH OF 1/4 OF THE HEIGHT OF THE POST, FOR EXAMPLE, A 8' POST SHOULD BE SET AT LEAST 2' INTO THE C. SPACE POSTS EVERY 6' (MIN.) TO 8' (MAX.). PLAN VIEW D. SECURE FENCING TO POST WITH NYLON CABLE TIES (AVAILABLE FROM CONWED PLASTICS). WOOD STRIPS MAY BE ALSO BE USED TO PROVIDE ADDITIONAL SUPPORT AND PROTECTION BETWEEN TIES AND POSTS. NOTE: IF WIRE TIES ARE USED, AVOID DIRECT CONTACT WITH FENCE. WIRE MAY DAMAGE FENCE OVER TIME. TREE/SHRUB PROTECTOR

Barrier Detail

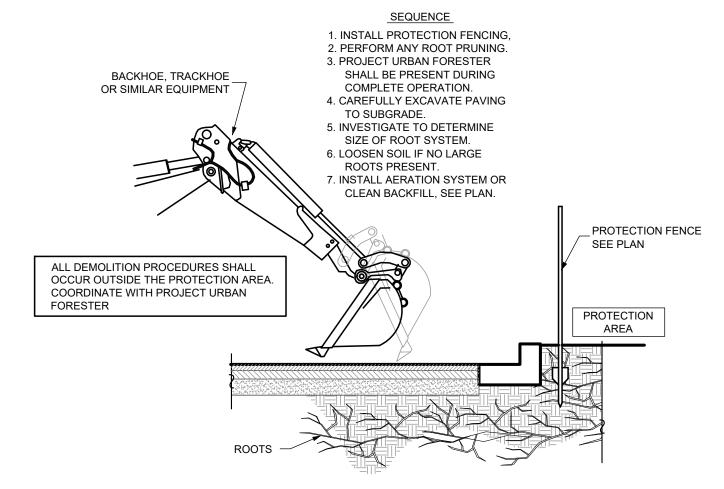SEQUENCE 1. INSTALL PROTECTION FENCING. 2. PERFORM ANY ROOT PRUNING. 3. BREAK OR CUT CURB A 6' SECTION OF CURB. 4. CAREFULLY ROTATE CURB SECTION AWAY FROM ROOTS. 5. COORDINATE ALL DEMOLITION OPERATIONS w/ PROJECT URBAN FORESTER. ROTATE 6. INSTALL NEW BACKFILL OR CURB AWAY \_ SIDEWALK/CURB. FROM TREE PROTECTION FENCE BACKHOE, TRACKHOE SEE PLAN OR SIMILAR EQUIPMENT PROTECTION ALL DEMOLITION PROCEDURES SHALL OCCUR OUTSIDE THE PROTECTION AREA. COORDINATE WITH PROJECT URBAN FORESTER.





© DEMOLITION PROCEDURE - PAVEMENT







Raising Cane's Restaurant #0855 8070 NW 36th Street Doral, FL 33166 CUSTOM [A]

Designer's Information:

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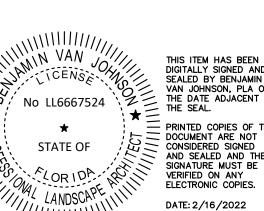
**ENTITLEMENTS** 

10-30-2021

11-19-2021

355 ALHAMBRA CIRCLE, SUITE 1400, CORAL GABLES, FL 33134 PHONE: 305-673-2025


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| She | et Versions: |                          |
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| #   | Date         | Description              |
| 1   | 02/16/2022   | ENTITLEMENTS RESUBMITTAL |
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|     |              |                          |
|     |              |                          |
|     |              |                          |
| She | et Title:    |                          |

TREE DISPOSITION **NOTES AND DETAILS** 

Sheet Number:



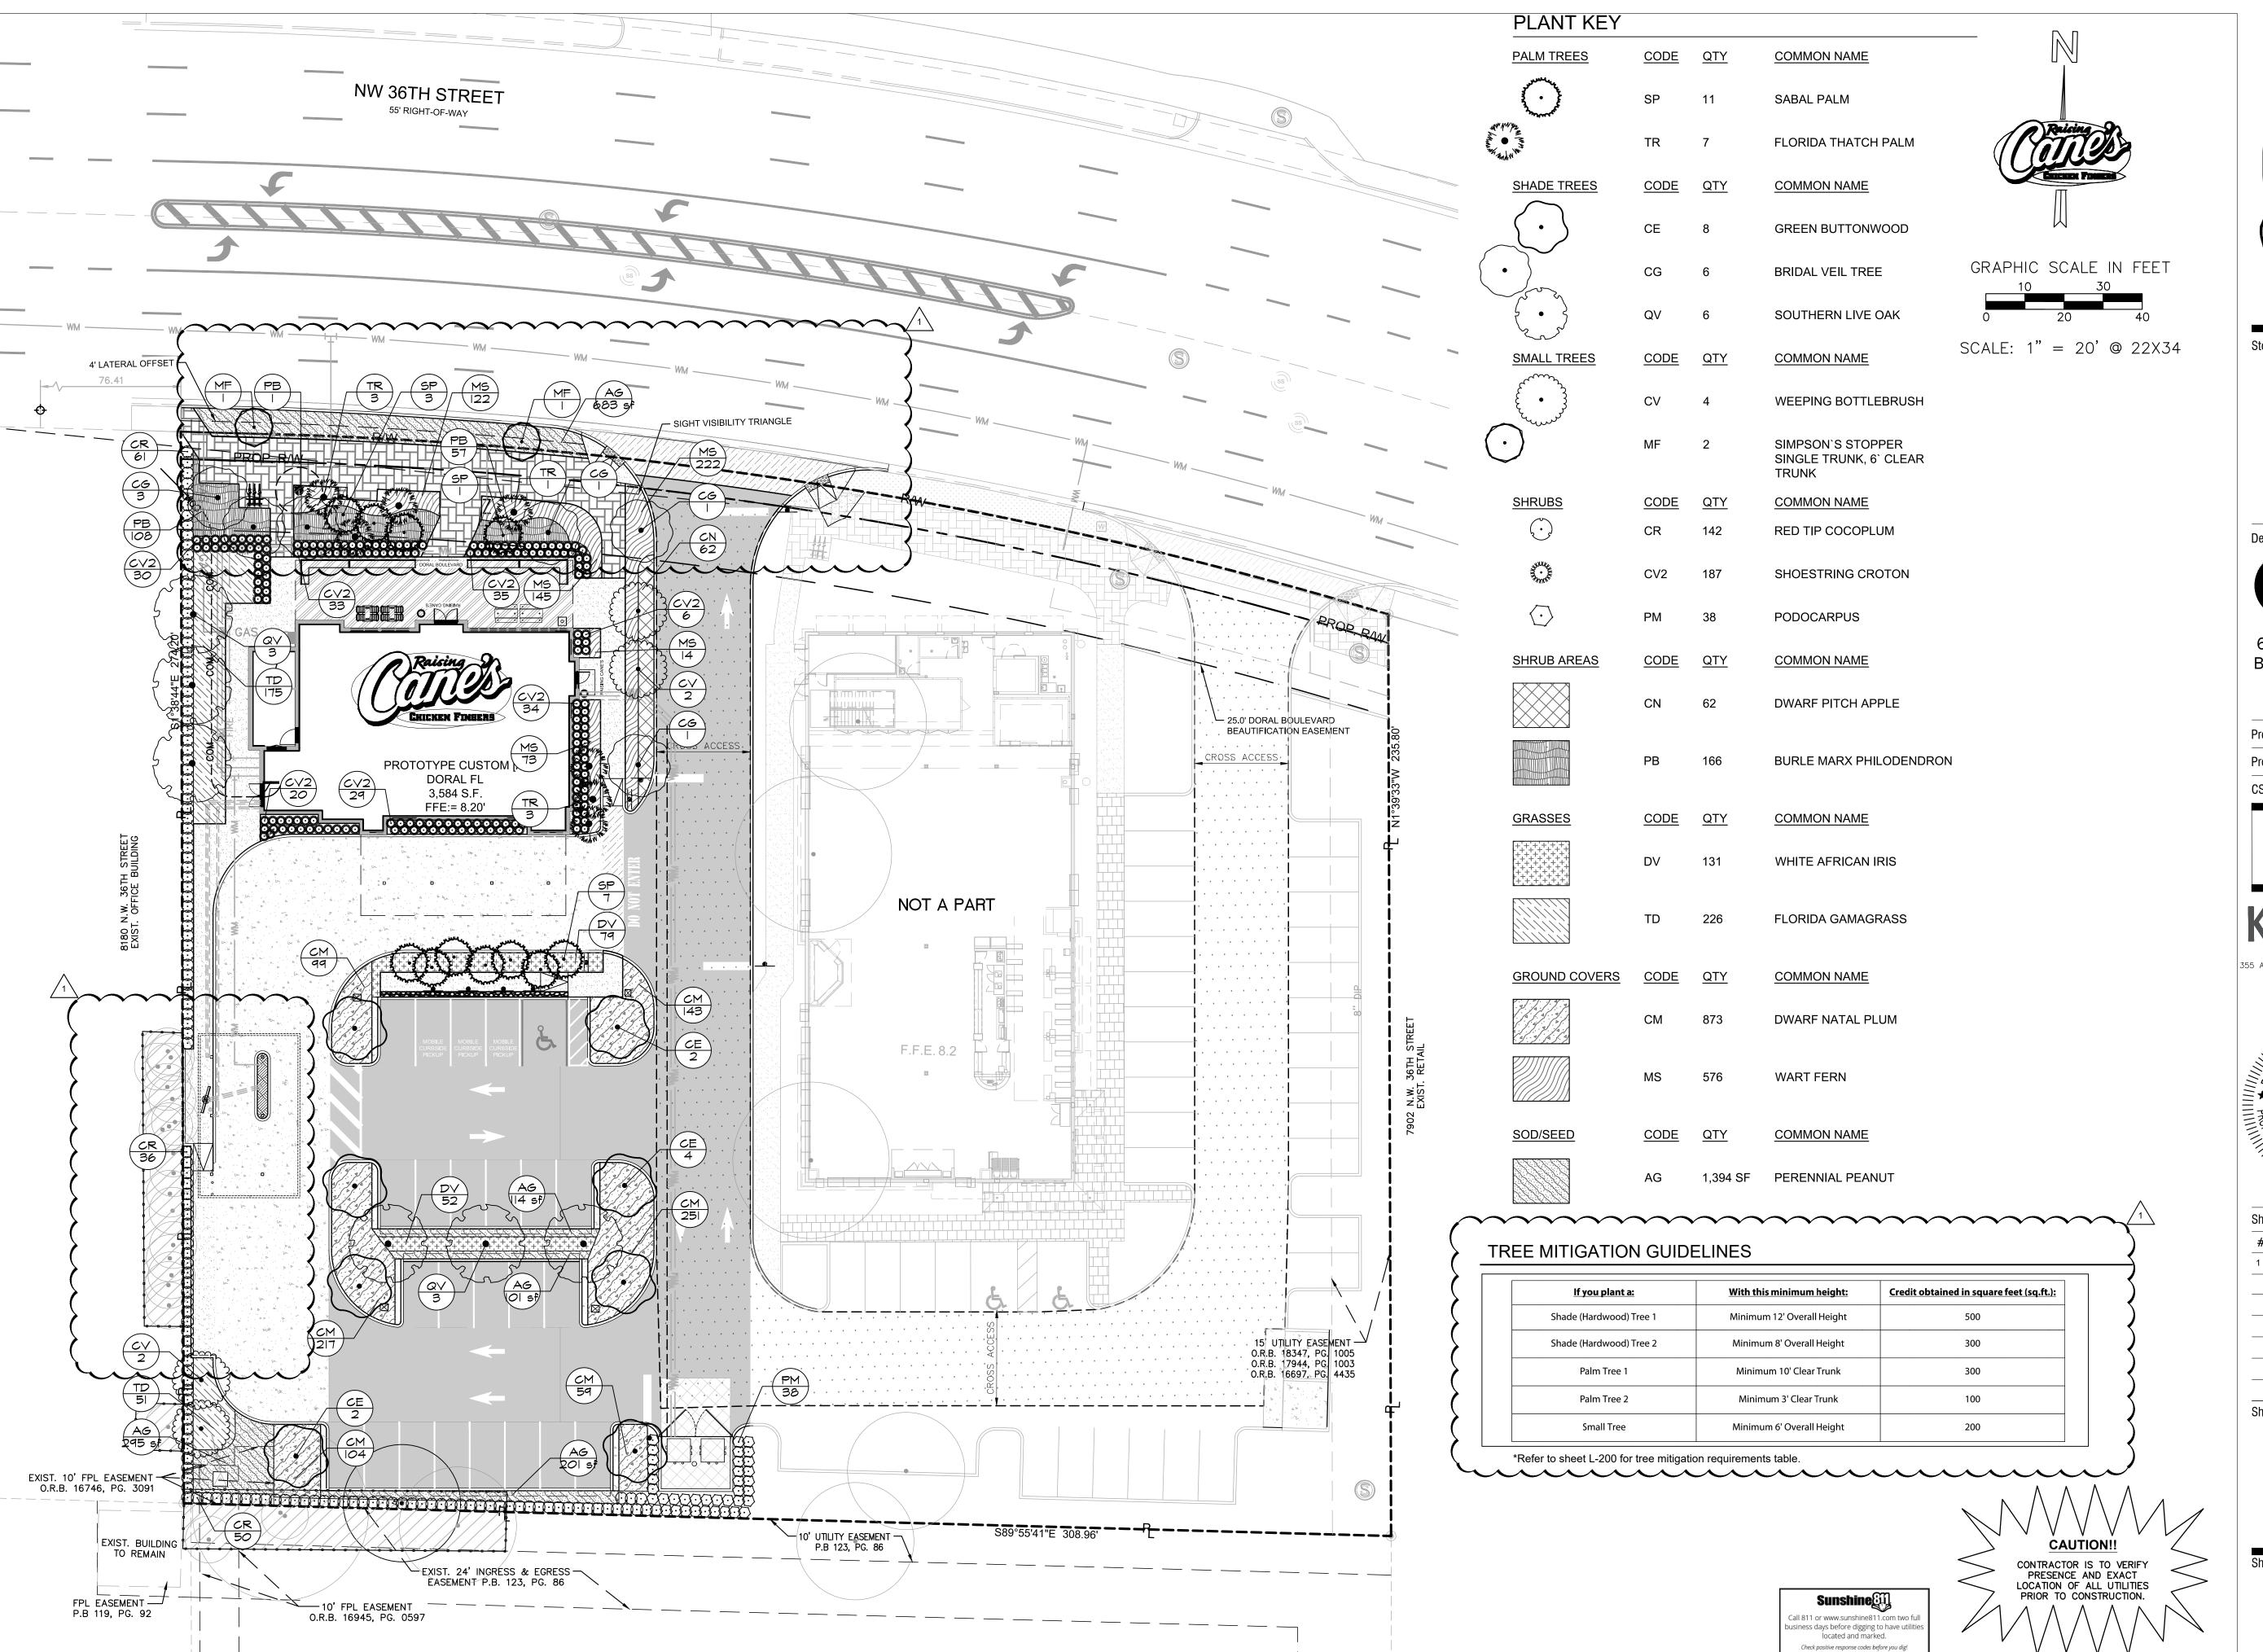CHICKEN FINGERS

Restaurant Support Office
6800 Bishop Road, Plano, TX 75024

Tele: 972-769-3101

Store:

Raising Cane's
Restaurant #0855
8070 NW 36th Street
Doral, FL 33166
CUSTOM [A]

Designer's Information:

6767 Perkins Road, Suite 200 Baton Rouge, Louisiana 70808 Telephone: 225 769-0546 www.csrsinc.com

Prototype Phase: 2021-1.0 (05-07-2021)

Project Issue Date:

CSRS Project Manager:


ENTITLEMENTS

11-19-2021

10-30-2021

# **Kimley** » Horn

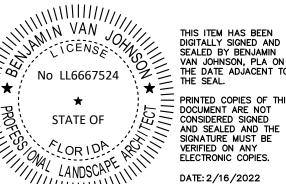355 ALHAMBRA CIRCLE, SUITE 1400, CORAL GABLES, FL 33134 PHONE: 305-673-2025 WWW.KIMLEY-HORN.COM CA 00000696



| Sheet Versions: |            |                          |  |  |  |
|-----------------|------------|--------------------------|--|--|--|
| #               | Date       | Description              |  |  |  |
| 1               | 02/16/2022 | ENTITLEMENTS RESUBMITTAL |  |  |  |
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Sheet Title:

LANDSCAPE PLAN

Sheet Number:

| PLANT SCH                                       | EDULE |            |  |        |                |                        |
|---|-------|------------|--|--------|----------------|------------------------|
| PALM TREES                                      | CODE  | <u>QTY</u> | BOTANICAL / COMMON NAME  | CONT   | CAL            | <u>HT</u>              |
|   | SP    | 11         | SABAL PALMETTO / SABAL PALM  | FG     | 10" DBH MIN    | 15` - 18` CT STAGGERED |
| AND         | TR    | 7          | THRINAX RADIATA / FLORIDA THATCH PALM                                    | FG     | 4" DBH         | 6` - 10` HT STAGGERED  |
| SHADE TREES                                     | CODE  | <u>QTY</u> | BOTANICAL / COMMON NAME  | CONT   | CAL            | <u>HT</u>              |
|   | CE    | 8          | CONOCARPUS ERECTUS / GREEN BUTTONWOOD                                    | FG     | 3" CAL MIN     | 14` HT MIN             |
|   | CG    | 6          | CAESALPINIA GRANADILLO / BRIDAL VEIL TREE                                | FG     | 3" CAL MIN     | 14` HT MIN             |
|   | QV    | 6          | QUERCUS VIRGINIANA / SOUTHERN LIVE OAK                                   | FG     | 3" CAL MIN     | 14` HT MIN             |
| SMALL TREES                                     | CODE  | <u>QTY</u> | BOTANICAL / COMMON NAME  | CONT   | <u>CAL</u>     | <u>HT</u>              |
| £ • 33  | CV    | 4          | CALLISTEMON VIMINALIS / WEEPING BOTTLEBRUSH                              | FG     | 2.5" CAL MIN   | 10` HT MIN             |
| $\odot$   | MF    | 2          | MYRCIANTHES FRAGRANS / SIMPSON`S STOPPER<br>SINGLE TRUNK, 6` CLEAR TRUNK | FG     | 2.5" CAL MIN   | 12` HT MIN             |
| SHRUBS  | CODE  | <u>QTY</u> | BOTANICAL / COMMON NAME  | CONT   | SPACING        | SIZE                   |
| $\odot$   | CR    | 142        | CHRYSOBALANUS ICACO 'RED TIP' / RED TIP COCOPLUM                         | CONT   | 30" OC         | 36" X 36"              |
| 0   | CV2   | 187        | CODIAEUM VARIEGATUM 'SHOESTRING' / SHOESTRING CROTON                     | CONT   | 24" OC         | 24" X 24"              |
| $\odot$   | РМ    | 38         | PODOCARPUS MACROPHYLLUS / PODOCARPUS                                     | CONT   | 30" OC         | 24" X 48"              |
| SHRUB AREAS                                     | CODE  | <u>QTY</u> | BOTANICAL / COMMON NAME  | CONT   | SPACING        | SIZE                   |
|   | CN    | 62         | CLUSIA ROSEA 'NANA' / DWARF PITCH APPLE                                  | CONT   | 24" OC         | 24" X 24"              |
|   | РВ    | 166        | PHILODENDRON X 'BURLE MARX' / BURLE MARX PHILODENDRON                    | CONT   | 18" OC         | 18" X 18"              |
| GRASSES   | CODE  | QTY        | BOTANICAL / COMMON NAME  | CONT   | SPACING        | SIZE                   |
| ++++++++<br>++++++++<br>++++++++++<br>+++++++++ | DV    | 131        | DIETES VEGETA / WHITE AFRICAN IRIS                                       | CONT   | 24" OC         | 24" HT MIN             |
|   | TD    | 226        | TRIPSACUM FLORIDANUM / FLORIDA GAMAGRASS                                 | CONT   | 24" OC         | 24" HT MIN             |
| GROUND COVERS                                   | CODE  | <u>QTY</u> | BOTANICAL / COMMON NAME  | CONT   | SPACING        | SIZE                   |
|   | СМ    | 873        | CARISSA MACROCARPA 'EMERALD BLANKET' / DWARF NATAL PLUM                  | CONT   | 18" OC         | 18" X 18"              |
|   | MS    | 576        | MICROSORUM SCOLOPENDRIA / WART FERN                                      | CONT   | 15" OC         | 12" X 12"              |
| SOD/SEED  | CODE  | QTY        | BOTANICAL / COMMON NAME  | CONT   | <u>SPACING</u> | SIZE                   |
|   | AG    | 1,394 SF   | ARACHIS GLABRATA / PERENNIAL PEANUT                                      | PALLET | SOD            | SOD                    |

# LANDSCAPE LEGEND

| OP                    | EN SPACE   |  |  |                            | _                | REQUIRED  | PROVIDED ^  |
|-----------------------|--|--|--|----------------------------|------------------|---|---|
| Α.                    | Square feet of open space required by  | Chp. 71, as indicated o  | n site plan:   |                            | •                |   |   |
|                       | Net Lot area = <b>41,068</b>   | x <u>10%</u>   |  |                            | _                | <b>4,107</b> SF   | 6,407 SF  |
| B.                    | Square feet of parking lot open space  | • •  |  | •                          |                  | •   |   |
|                       | The number of parking spaces   | = <b>24</b> x 1  | 0 SF per parkin  | g space=                   | -                | <b>240</b> SF   | 2,247 SF  |
| C.                    | Total SF of landscaped open space re   | quired by Chp. 71 = A +  | В  |                            | -                | 4,347 SF (  | 8,654 SF  |
| LA۱                   | VN AREA CALCULATION  |  |  |                            |                  | '   |   |
| Α.                    | Total square feet of landscape open sp   | pace required by Chp. 7  | 1 =  |                            | _                | <b>4,347</b> SF   |   |
| B.                    | Maximum lawn area permitted =  | <b>20%</b> x required landsca  | pe open space :  | =                          |                  | <b>869</b> SF   | - SF  |
|                       | Note: Very dry tolerant grasses and love in the Landscape Manual, may be used specified.   |  |  |                            |                  |   |   |
|                       | ES   |  | $\wedge$   |                            |                  |   |   |
| Α.                    | The number of site trees required per r  |  | $\sqrt{1}$   | 21 site trees              | per net lot area |   | /   |
|                       | lace the existing number of trace that m   |  |  |                            |                  |   |   |
|                       | •  | neet minimum requireme   |  | 1 existing t               | <b>,</b>         |   |   |
| Б                     | 1  | required trees x net lot ac  |  | 1 existing to 20 trees - 6 | <b>,</b>         | 19 trees  | 32 trees  |
| B.                    | 30% palm trees allowed (two palms = 6  | required trees x net lot acone tree) =   | creage =   | /                          | <b>,</b>         | 10 "trees"  | 9 "trees"   |
|                       | 30% palm trees allowed (two palms = c<br>Percentage of native trees required = t   | required trees x net lot acone tree) = the number of trees provi   | creage =   | 20 trees - e               | <b>,</b>         | 10 "trees"<br>10 trees                                  | 9 "trees" 25 trees  |
| C.                    | 30% palm trees allowed (two palms = c<br>Percentage of native trees required = t<br>Percentage of low maintenance and dr   | required trees x net lot acone tree) = the number of trees provi   | creage =   | 20 trees - e               | <b>,</b>         | 10 "trees"  | 9 "trees"   |
|                       | 30% palm trees allowed (two palms = 6) Percentage of native trees required = t Percentage of low maintenance and dr Street trees (max. average spacing of  | required trees x net lot acone tree) = the number of trees provictions to learn trees = provictions of the content trees = provictions of tree | creage =   | 20 trees - e               | <b>,</b>         | 10 "trees" 10 trees 16 trees                            | 9 "trees" 25 trees 28 trees   |
| C.<br>D.              | 30% palm trees allowed (two palms = 6 Percentage of native trees required = 1 Percentage of low maintenance and dr Street trees (max. average spacing of  114 linear feet along str  | required trees x net lot acone tree) = the number of trees proviought tolerant trees = provious of the contract trees = provious of trees = provious  | creage =ded x 30% = rovided trees x 5                                      | 20 trees - 6               | <b>,</b>         | 10 "trees"<br>10 trees                                  | 9 "trees" 25 trees  |
| C.                    | 30% palm trees allowed (two palms = control of palms)  Percentage of native trees required = to the percentage of low maintenance and do street trees (max. average spacing of the percentage of | required trees x net lot acone tree) = the number of trees proviought tolerant trees = provious of the contract trees = provious (a.): the number of trees provious (b.): the number of trees provious (b.): the number of trees are provious (b.): the numb | creage =ded x 30% = rovided trees x 5                                      | 20 trees - 6               | <b>,</b>         | 10 "trees" 10 trees 16 trees 3 trees                    | 9 "trees" 25 trees 28 trees *3 trees                                |
| C.<br>D.<br>E.        | 30% palm trees allowed (two palms = 6 Percentage of native trees required = t Percentage of low maintenance and dr Street trees (max. average spacing of  114 linear feet along str  Street trees located directly beneath po  | required trees x net lot acone tree) = the number of trees proviought tolerant trees = proviought tolerant trees = proviought (a.c.): the number of trees proviought tolerant trees = proviought trees = pr | creage = ded x 30% = rovided trees x 5                                     | 20 trees - 6               | <b>,</b>         | 10 "trees" 10 trees 16 trees 3 trees - trees            | 9 "trees" 25 trees 28 trees  *3 trees  - trees                      |
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| C.<br>D.<br>E.<br>F.  | 30% palm trees allowed (two palms = 6 Percentage of native trees required = t Percentage of low maintenance and dr Street trees (max. average spacing of  114 linear feet along str  Street trees located directly beneath po  | required trees x net lot acone tree) = the number of trees proviought tolerant trees = proviought tolerant trees = proviought (a.c.): the number of trees proviought tolerant trees = proviought trees = pr | creage = ded x 30% = rovided trees x 5                                     | 20 trees - 6               | <b>,</b>         | 10 "trees" 10 trees 16 trees 3 trees - trees            | 9 "trees" 25 trees 28 trees  *3 trees  - trees                      |
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| C.  D.  E.  F.        | 30% palm trees allowed (two palms = 6 Percentage of native trees required = t Percentage of low maintenance and dr Street trees (max. average spacing of  114 linear feet along str Street trees located directly beneath po  0 linear feet along str Total number of trees provided: require  | required trees x net lot acone tree) = the number of trees proviought tolerant trees = proviought trees = pr | creage = ded x 30% = rovided trees x 5 e spacing of 25' e s = ubs required | 20 trees - 6               | <b>,</b>         | 10 "trees" 10 trees 16 trees  3 trees - trees 22 trees  | 9 "trees" 25 trees 28 trees  *3 trees  - trees 35 trees             |
| C. D. E. F.           | 30% palm trees allowed (two palms = 6 Percentage of native trees required = t Percentage of low maintenance and dr Street trees (max. average spacing of  114 linear feet along str Street trees located directly beneath po  0 linear feet along str Total number of trees provided: require  | required trees x net lot acone tree) = the number of trees proviought tolerant trees = proviought trees = pr | creage = ded x 30% = rovided trees x 5 e spacing of 25' e s = ubs required | 20 trees - 6               | <b>,</b>         | 10 "trees" 10 trees 16 trees  3 trees  - trees 22 trees | 9 "trees" 25 trees 28 trees  *3 trees  - trees 35 trees  429 shrubs |
| C. D. E. F. SHI A. B. | 30% palm trees allowed (two palms = 6 Percentage of native trees required = t Percentage of low maintenance and dr Street trees (max. average spacing of  114 linear feet along str Street trees located directly beneath po  0 linear feet along str Total number of trees provided: require  | required trees x net lot acone tree) = the number of trees proviought tolerant trees = proviought trees = pr | creage = ded x 30% = rovided trees x 5 e spacing of 25' e s = ubs required | 20 trees - 6               | <b>,</b>         | 10 "trees" 10 trees 16 trees  3 trees  - trees 22 trees | 9 "trees" 25 trees 28 trees  *3 trees  - trees 35 trees  429 shrubs |
| C. D. E. F. SHI A. B. | 30% palm trees allowed (two palms = 6 Percentage of native trees required = t Percentage of low maintenance and dr Street trees (max. average spacing of  114 linear feet along str Street trees located directly beneath po  0 linear feet along str Total number of trees provided: required  RUBS The total number of trees required The number of shrubs required x 50% streets  | required trees x net lot acone tree) = the number of trees proviought tolerant trees = proviought trees = pr | creage = ded x 30% = rovided trees x 5 e spacing of 25' e s = ubs required | 20 trees - 6               | <b>,</b>         | 10 "trees" 10 trees 16 trees  3 trees  - trees 22 trees | 9 "trees" 25 trees 28 trees  *3 trees  - trees 35 trees  429 shrubs |

# Planting Notes:

- 1. Contractor shall refer to the landscape planting details, plant list, general notes and all contract documents
- 2. Plant list quantities are provided for convenience. In the event of quantity discrepancies the drawing shall take precedence. Any discrepancies shall be brought to the attention of the landscape architect prior to
- 3. Plant sizes listed are the minimum size that will be accepted for that plant. Contractor shall submit photographs for review and evaluation by Landscape Architect.

accommodate two (2) street trees within the right-of-way

- 4. Any substitution in size and/or plant material must be approved by the landscape architect in writing. All plants will be subject to approval by Landscape Architect and/or owners representative before planting can
- 5. Contractor shall field adjust location of plant material as necessary to avoid damage to existing underground utilities and/or interfere with existing above ground elements. all changes required shall be completed at the contractor's expense and shall be coordinated with the owner's representative and the landscape architect.
- 6. The contractor shall bear all costs of testing of soils, amendments, etc. associated with the work and included in the specifications.
- 7. Contractor shall familiarize him/herself with the limits of work and existing conditions and verify all information. If discrepancies exist, contractor shall notify owner's representative and Landscape Architect in writing within seven calendar days of notice to proceed.
- 8. All new and transplanted plant material shall be irrigated by an automatic underground irrigation system, meeting all required federal, state, and municipal requirements. Contractor shall submit shop drawings and specifications for evaluation and review by Landscape Architect prior to commencement of work.
- 9. Contractor shall verify in field all existing infastracture to remain and shall insure final layout of plant material complies with FDM 212.11 in order to maintain required sight lines. Final placement of plant material shall be reviewed in field prior to final installation with the client and Kimley-Horn landscape architect. Bed lines may be adjusted slightly in the field based upon on-site conditions to reconcile any potential unforeseen conflicts from verified site conditions.
- 10. Contractor shall maintain sight triangles in perpetuity to insure a safe condition and receive written confirmation from the Client that they shall do so after the guarantee period expires. Contractor shall submit written evidence of such confirmation to the landscape architect prior to project close out.



siness days before digging to have utili located and marked.



Raising Cane's Restaurant #0855 8070 NW 36th Street Doral, FL 33166 CUSTOM [A]

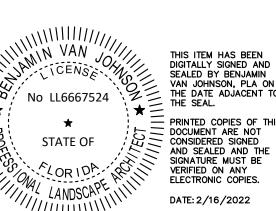
Designer's Information:

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| ototype Phase:    | 2021-1.0 (05-07-2021   |
|-------------------|------------------------|
| oject Issue Date: | 10-30-202 <sup>-</sup> |

11-19-2021

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| # | Date       | Description              |
|---|------------|--------------------------|
| 1 | 02/16/2022 | ENTITLEMENTS RESUBMITTAL |
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|   |            |                          |

LANDSCAPE SCHEDULE AND CODE LEGEND

Sheet Number:

#### GENERAL LANDSCAPE SPECIFICATIONS AND NOTES

#### A. SCOPE OF WORK

- 1. THE WORK CONSISTS OF: FURNISHING ALL LABOR, MATERIALS, EQUIPMENT, TOOLS, TRANSPORTATION, AND ANY OTHER APPURTENANCES NECESSARY FOR THE COMPLETION OF THIS PROJECT AS SHOWN ON THE DRAWINGS, AS INCLUDED IN THE PLANT LIST, AND AS HEREIN SPECIFIED.
- 2. WORK SHALL INCLUDE MAINTENANCE AND WATERING OF ALL CONTRACT PLANTING AREAS UNTIL CERTIFICATION OF ACCEPTABILITY BY THE OWNER.

#### B. PROTECTION OF EXISTING STRUCTURES

1. ALL EXISTING BUILDINGS, WALKS, WALLS, PAVING, PIPING, OTHER SITE CONSTRUCTION ITEMS, AND PLANTING ALREADY COMPLETED OR ESTABLISHED SHALL BE PROTECTED FROM DAMAGE BY THE CONTRACTOR UNLESS OTHERWISE SPECIFIED. ALL DAMAGE RESULTING FROM NEGLIGENCE SHALL BE REPAIRED OR REPLACED TO THE SATISFACTION OF THE OWNER, AT NO COST TO THE OWNER.

#### C. PROTECTION OF EXISTING PLANT MATERIALS OUTSIDE LIMIT OF WORK

1. THE CONTRACTOR SHALL BE RESPONSIBLE FOR ALL UNAUTHORIZED CUTTING OR DAMAGE TO TREES AND SHRUBS EXISTING OR OTHERWISE, CAUSED BY CARELESS EQUIPMENT OPERATION, MATERIAL STOCKPILING, ETC. THIS SHALL INCLUDE COMPACTION BY DRIVING OR PARKING INSIDE THE DRIP-LINE AND SPILLING OIL, GASOLINE, OR OTHER DELETERIOUS MATERIALS WITHIN THE DRIP-LINE. NO MATERIALS SHALL BE BURNED WHERE HEAT WILL DAMAGE ANY PLANT. EXISTING TREES KILLED OR DAMAGED SO THAT THEY ARE MISSHAPEN AND/ OR UNSIGHTLY SHALL BE REPLACED AT THE COST TO THE CONTRACTOR OF ONE HUNDRED DOLLARS (\$100) PER CALIPER INCH ON AN ESCALATING SCALE WHICH ADDS AN ADDITIONAL TWENTY (20) PERCENT PER INCH OVER FOUR (4) INCHES CALIPER AS FIXED AND AGREED LIQUIDATED DAMAGES. CALIPER SHALL BE MEASURED SIX (6) INCHES ABOVE GROUND LEVEL FOR TREES UP TO AND INCLUDING FOUR (4) INCH CALIPER AND TWELVE (12) INCHES ABOVE GROUND LEVEL FOR TREES OVER FOUR (4) INCH CALIPER.

## D. MATERIALS

### 1. GENERAL

a. MATERIALS LISTED BELOW SHALL BE SUBMITTED FOR APPROVAL. UPON SUBMITTALS' APPROVAL, DELIVERY OF MATERIALS MAY COMMENCE.

| MATERIAL    | SUBMITTAL  |
|-------------|--|
| MULCH       | PRODUCT DATA   |
| TOPSOIL MIX | AMENDMENT MIX/ PRODUCT DATA/ TEST RESULTS  |
| PLANTS      | PHOTOGRAPHS OF ONE (1) OF EACH SPECIES (OR TAGGED IN NURSERY) INDICATE SIZES (HEIGHT/WIDTH AND QUALITY PER SPEC. CLIENT REQUESTED TAGGING MAY SUBSTITUTE PHOTOS. |
| FERTILIZER  | PRODUCT DATA   |
| INNOCULANT  | PRODUCT DATA   |
| HERBICIDE   | PRODUCT DATA   |

### 2. PLANT MATERIALS

- a. PLANT SPECIES AND SIZE SHALL CONFORM TO THOSE INDICATED ON THE DRAWINGS. NOMENCLATURE SHALL CONFORM TO STANDARDIZED PLANT NAMES. 1942 EDITION. ALL NURSERY STOCK SHALL BE IN ACCORDANCE WITH GRADES AND STANDARDS FOR NURSERY PLANTS, LATEST EDITION, PUBLISHED BY THE FLORIDA DEPARTMENT OF AGRICULTURE AND CONSUMER SERVICES. ALL PLANTS SHALL BE FLORIDA GRADE NO. 1 OR BETTER AS DETERMINED BY THE FLORIDA DIVISION OF PLANT INDUSTRY. ALL PLANTS SHALL BE HEALTHY, VIGOROUS, SOUND, WELL-BRANCHED, AND FREE OF DISEASE AND INSECTS, INSECT EGGS AND LARVAE AND SHALL HAVE ADEQUATE ROOT SYSTEMS. TREES FOR PLANTING IN ROWS SHALL BE UNIFORM IN SIZE AND SHAPE. ALL MATERIALS SHALL BE SUBJECT TO APPROVAL BY THE OWNER. WHERE ANY REQUIREMENTS ARE OMITTED FROM THE PLANT LIST, THE PLANTS FURNISHED SHALL BE NORMAL FOR THE VARIETY. PLANTS SHALL BE PRUNED PRIOR TO DELIVERY ONLY WITH APPROVAL FROM OWNER OR OWNER'S REPRESENTATIVE. NO SUBSTITUTIONS SHALL BE MADE WITHOUT WRITTEN PERMISSION FROM THE OWNER'S REPRESENTATIVE.
- b. MEASUREMENTS: THE HEIGHT AND/OR WIDTH OF TREES SHALL BE MEASURED FROM THE GROUND OR ACROSS THE NORMAL SPREAD OF BRANCHES WITH THE PLANTS IN THEIR NORMAL POSITION. THIS MEASUREMENT SHALL NOT INCLUDE THE IMMEDIATE TERMINAL GROWTH. PLANTS LARGER IN SIZE THAN THOSE SPECIFIED IN THE PLANT LIST MAY BE USED IF APPROVED BY THE OWNER. IF THE USE OF LARGER PLANTS IS APPROVED, THE BALL OF EARTH OR SPREAD OF ROOTS SHALL BE INCREASED IN PROPORTION TO THE SIZE OF THE PLANT.
- c. INSPECTION: PLANTS SHALL BE SUBJECT TO INSPECTION AND APPROVAL AT THE PLACE OF GROWTH, OR UPON DELIVERY TO THE SITE, AS DETERMINED BY THE OWNER, FOR QUALITY, SIZE, AND VARIETY; SUCH APPROVAL SHALL NOT IMPAIR THE RIGHT OF INSPECTION AND REJECTION AT THE SITE DURING PROGRESS OF THE WORK OR AFTER COMPLETION FOR SIZE AND CONDITION OF ROOT BALLS OR ROOTS, LATENT DEFECTS OR INJURIES. REJECTED PLANTS SHALL BE REMOVED IMMEDIATELY FROM THE SITE. NOTICE REQUESTING INSPECTION SHALL BE SUBMITTED IN WRITING BY THE CONTRACTOR AT LEAST ONE (1) WEEK PRIOR TO ANTICIPATED DATE.

## E. SOIL MIXTURE

- 1. SOIL MIXTURE (PLANTING MEDIUM FOR PLANT PITS) SHALL CONSIST OF 50% COARSE SAND AND 50% FLORIDA PEAT, AS DESCRIBED BELOW.
- 2. SOIL FOR USE IN PREPARING SOIL MIXTURE FOR BACKFILLING PLANT PITS SHALL BE FERTILE, FRIABLE, AND OF A LOAMY CHARACTER; REASONABLY FREE OF SUBSOIL, CLAY LUMPS, BRUSH WEEDS AND OTHER LITTER; FREE OF ROOTS, STUMPS, STONES LARGER THAN 2" IN ANY DIRECTION, AND OTHER EXTRANEOUS OR TOXIC MATTER HARMFUL TO PLANT GROWTH. IT SHALL HAVE A PH BETWEEN 5.5 AND 7.0 SUBMIT SAMPLE AND PH TESTING RESULTS FOR APPROVAL.
- 3. SAND SHALL BE COARSE, CLEAN, WELL-DRAINING, NATIVE SAND. CONTRACTOR SHALL SUBMIT RESULTS OF SOIL TEST FOR THE SOIL AND SAND PROPOSED FOR USE UNDER THIS CONTRACT FOR APPROVAL BY THE OWNER.
- 4. CONTRACTOR TO SUBMIT SAMPLES OF SOIL MIXTURE FOR OWNER'S REPRESENTATIVE APPROVAL PRIOR TO PLANT INSTALLATION OPERATIONS COMMENCE.
- 5. CONTRACTOR SHALL PROVIDE PH TEST RESULT FOR ALL MIX COMPONENTS.
- CONTRACTOR SHALL PROVIDE PENETROMETER ON-SITE AT ALL TIMES FOR COMPACTION INSPECTION AT THE DISCRETION OF THE LANDSCAPE ARCHITECT.
- 7. PENETROMETER CRITERIA / SPECIFICATION SHALL RANGE FROM APPROX. 75 PSI TO LESS THAN 300 PSI OR AS DETERMINE BY LANDSCAPE ARCHITECT.

- 8. SOIL SHALL BE SUPPLIED BY ATLAS PEAT & SOIL INC. 9621 STATE RD, BOYNTON BEACH, FLORIDA 33472. PHONE: 561-734-7300 OR APPROVED EQUAL.
- 9. FINAL MIX SHALL BE TESTED TO HAVE A SATURATED WEIGHT OF NO MORE THAN 110 POUNDER PER CUBIC FOOT WHEN COMPACTED TO 85% STANDARDS PROCTOR.

#### F. WATER

- 1. WATER NECESSARY FOR PLANTING AND MAINTENANCE SHALL BE OF SATISFACTORY QUALITY TO SUSTAIN AN ADEQUATE PLANT GROWTH AND SHALL NOT CONTAIN HARMFUL, NATURAL OR MAN-MADE ELEMENTS DETRIMENTAL TO PLANTS. WATER MEETING THE ABOVE STANDARD SHALL BE OBTAINED ON THE SITE FROM THE OWNER, IF AVAILABLE, AND THE CONTRACTOR SHALL BE RESPONSIBLE TO MAKE ARRANGEMENTS FOR ITS USE BY HIS TANKS, HOSES, SPRINKLERS, ETC.. IF SUCH WATER IS NOT AVAILABLE AT THE SITE, THE CONTRACTOR SHALL PROVIDE SATISFACTORY WATER FROM SOURCES OFF THE SITE AT NO ADDITIONAL COST TO THE OWNER.
- 2. CONTRACTOR SHALL INSURE ALL PLANT MATERIAL RECEIVES APPROPRIATE WATER THROUGHOUT THE GUARANTEE PERIOD SO PLANT MATERIAL THRIVES AND ESTABLISHES READILY.
- 3. CONTRACTOR SHALL SUBMIT A WATERING SCHEDULE FOR WRITTEN APPROVAL BY THE CLIENT

\*WATERING/IRRIGATION RESTRICTIONS MAY APPLY - REFER TO PROPERTY'S JURISDICTIONAL AUTHORITY.

#### G. FERTILIZER

CONTRACTOR SHALL PROVIDE FERTILIZER APPLICATION SCHEDULE TO OWNER, AS
APPLICABLE TO SOIL TYPE, PLANT INSTALLATION TYPE, AND SITE'S PROPOSED USE.
SUGGESTED FERTILIZER TYPES SHALL BE ORGANIC OR OTHERWISE
NATURALLY-DERIVED.

\*FERTILIZER RESTRICTIONS MAY APPLY - REFER TO PROPERTY'S JURISDICTIONAL AUTHORITY.

#### 4 MIII CH

1. MULCH MATERIAL SHALL BE MOISTENED AT THE TIME OF APPLICATION TO PREVENT WIND DISPLACEMENT, AND APPLIED AT A MINIMUM DEPTH OF 3 INCHES. CLEAR MULCH FROM EACH PLANT'S CROWN (BASE). TYPE OF MATERIAL: "FLORIMULCH" OR SHREDDED, STERILE EUCALYPTUS MULCH.

### I. DIGGING AND HANDLING

- 1. PROTECT ROOTS OR ROOT BALLS OF PLANTS AT ALL TIMES FROM SUN, DRYING WINDS, WATER AND FREEZING, AS NECESSARY UNTIL PLANTING. PLANT MATERIALS SHALL BE ADEQUATELY PACKED TO PREVENT DAMAGE DURING TRANSIT. TREES TRANSPORTED MORE THAN TEN (10) MILES OR WHICH ARE NOT PLANTED WITHIN THREE (3) DAYS OF DELIVERY TO SITE SHALL BE SPRAYED WITH AN ANTITRANSPIRANT PRODUCT ("WILTPRUF" OR EQUAL) TO MINIMIZE TRANSPIRATIONAL WATER LOSS.
- 2. BALLED AND BURLAPPED PLANTS (B&B) SHALL BE DUG WITH FIRM, NATURAL BALLS OF SOIL OF SUFFICIENT SIZE TO ENCOMPASS THE FIBROUS AND FEEDING ROOTS OF THE PLANTS. NO PLANTS MOVED WITH A ROOT BALL SHALL BE PLANTED IF THE BALL IS CRACKED OR BROKEN. PLANTS BALLED AND BURLAPPED OR CONTAINER GROWN SHALL NOT BE HANDLED BY STEMS.
- 3. PLANTS MARKED "BR" IN THE PLANT LIST SHALL BE DUG WITH BARE ROOTS, COMPLYING WITH FLORIDA GRADES AND STANDARDS FOR NURSERY PLANTS, CURRENT EDITION. CARE SHALL BE EXERCISED THAT THE ROOTS DO NOT DRY OUT DURING TRANSPORTATION AND PRIOR TO PLANTING.
- 4. PROTECTION OF PALMS (IF APPLICABLE): ONLY A MINIMUM OF FRONDS SHALL BE REMOVED FROM THE CROWN OF THE PALM TREES TO FACILITATE MOVING AND HANDLING. CLEAR TRUNK (CT) SHALL BE AS SPECIFIED AFTER THE MINIMUM OF FRONDS HAVE BEEN REMOVED. ALL PALMS SHALL BE BRACED PER PALM PLANTING DETAIL.
- 5. EXCAVATION OF TREE PITS SHALL BE PERFORMED USING EXTREME CARE TO AVOID DAMAGE TO SURFACE AND SUBSURFACE ELEMENTS SUCH AS UTILITIES OR HARDSCAPE ELEMENTS, FOOTERS AND PREPARED SUB-BASES.

## J. CONTAINER GROWN STOCK

- 1. ALL CONTAINER GROWN MATERIAL SHALL BE HEALTHY, VIGOROUS, WELL-ROOTED PLANTS ESTABLISHED IN THE CONTAINER IN WHICH THEY ARE SOLD. THE PLANTS SHALL HAVE TOPS WHICH ARE OF GOOD QUALITY AND ARE IN A HEALTHY GROWING CONDITION. FLORIDA #1 OR BETTER.
- 2. AN ESTABLISHED CONTAINER GROWN PLANT SHALL BE TRANSPLANTED INTO A CONTAINER AND GROWN IN THAT CONTAINER SUFFICIENTLY LONG FOR THE NEW FIBROUS ROOTS TO HAVE DEVELOPED SO THAT THE ROOT MASS WILL RETAIN ITS SHAPE AND HOLD TOGETHER WHEN REMOVED FROM THE CONTAINER. CONTAINER GROWN STOCK SHALL NOT BE HANDLED BY THEIR STEMS.
- 3. PLANT ROOTS BOUND IN CONTAINERS ARE NOT ACCEPTABLE.
- 4. SUBSTITUTION OF NON-CONTAINER GROWN MATERIAL FOR MATERIAL EXPLICITLY SPECIFIED TO BE CONTAINER GROWN WILL NOT BE PERMITTED WITHOUT WRITTEN APPROVAL IS OBTAINED FROM THE OWNER OR OWNER'S REPRESENTATIVE.

## K. COLLECTED STOCK

1. WHEN THE USE OF COLLECTED STOCK IS PERMITTED AS INDICATED BY THE OWNER OR OWNER'S REPRESENTATIVE, THE MINIMUM SIZES OF ROOTBALLS SHALL BE EQUAL TO THAT SPECIFIED FOR THE NEXT LARGER SIZE OF NURSERY GROWN STOCK OF THE SAME VARIETY.

## L. NATIVE STOCK

1. PLANTS COLLECTED FROM WILD OR NATIVE STANDS SHALL BE CONSIDERED NURSERY GROWN WHEN THEY HAVE BEEN SUCCESSFULLY RE-ESTABLISHED IN A NURSERY ROW AND GROWN UNDER REGULAR NURSERY CULTURAL PRACTICES FOR A MINIMUM OF TWO (2) GROWING SEASONS AND HAVE ATTAINED ADEQUATE ROOT AND TOP GROWTH TO INDICATE FULL RECOVERY FROM TRANSPLANTING INTO THE

## M. MATERIALS LIST

1. QUANTITIES NECESSARY TO COMPLETE THE WORK ON THE DRAWINGS SHALL BE FURNISHED BY THE CONTRACTOR. QUANTITY ESTIMATES HAVE BEEN MADE CAREFULLY, BUT THE LANDSCAPE ARCHITECT OR OWNER ASSUMES NO LIABILITY FOR OMISSIONS OR ERRORS. SHOULD A DISCREPANCY OCCUR BETWEEN THE PLANS AND THE PLANT LIST QUANTITY, THE LANDSCAPE ARCHITECT SHALL BE NOTIFIED FOR CLARIFICATION PRIOR TO BIDDING OR INSTALLATION. ALL DIMENSIONS AND/OR SIZES SPECIFIED SHALL BE THE MINIMUM ACCEPTABLE SIZE.

## N. FINE GRADING

FINE GRADING UNDER THIS CONTRACT SHALL CONSIST OF FINAL FINISHED GRADING
OF LAWN AND PLANTING AREAS THAT HAVE BEEN ROUGH GRADED BY OTHERS.
BERMING AS SHOWN ON THE DRAWINGS SHALL BE THE RESPONSIBILITY OF THE
CONTRACTOR, UNLESS OTHERWISE NOTED.

- 2. THE CONTRACTOR SHALL FINE GRADE THE LAWN AND PLANTING AREAS TO BRING THE ROUGH GRADE UP TO FINAL FINISHED GRADE ALLOWING FOR THICKNESS OF SOD AND/OR MULCH DEPTH. THIS CONTRACTOR SHALL FINE GRADE BY HAND AND/OR WITH ALL EQUIPMENT NECESSARY INCLUDING A GRADING TRACTOR WITH FRONT-END LOADER FOR TRANSPORTING SOIL WITHIN THE SITE.
- 3. ALL PLANTING AREAS SHALL BE GRADED AND MAINTAINED FOR POSITIVE DRAINAGE TO SURFACE/SUBSURFACE STORM DRAIN SYSTEMS. AREAS ADJACENT TO BUILDINGS SHALL SLOPE AWAY FROM THE BUILDINGS. REFER TO CIVIL ENGINEER'S PLANS FOR FINAL GRADES.

#### O. PLANTING PROCEDURES

- 1. 1. CLEANING UP BEFORE COMMENCING WORK: THE CONTRACTOR SHALL CLEAN WORK AND SURROUNDING AREAS OF ALL RUBBISH OR OBJECTIONABLE MATTER. ALL MORTAR, CEMENT, AND TOXIC MATERIAL SHALL BE REMOVED FROM THE SURFACE OF ALL PLANT BEDS. THESE MATERIALS SHALL NOT BE MIXED WITH THE SOIL. SHOULD THE CONTRACTOR FIND SUCH SOIL CONDITIONS BENEATH THE SOIL WHICH WILL IN ANY WAY ADVERSELY AFFECT THE PLANT GROWTH, HE SHALL IMMEDIATELY CALL IT TO THE ATTENTION OF THE OWNER'S REPRESENTATIVE. FAILURE TO DO SO BEFORE PLANTING SHALL MAKE THE CORRECTIVE MEASURES THE RESPONSIBILITY OF THE CONTRACTOR.
- 2. VERIFY LOCATIONS OF ALL UTILITIES, CONDUITS, SUPPLY LINES AND CABLES, INCLUDING BUT NOT LIMITED TO: ELECTRIC, GAS (LINES AND TANKS), WATER, SANITARY SEWER, STORMWATER SYSTEMS, CABLE, AND TELEPHONE. PROPERLY MAINTAIN AND PROTECT EXISTING UTILITIES. CALL NATIONAL ONE CALL 811 TO LOCATE UTILITIES.
- 3. SUBGRADE EXCAVATION: CONTRACTOR IS RESPONSIBLE TO REMOVE ALL EXISTING AND IMPORTED LIMEROCK AND LIMEROCK SUB-BASE FROM ALL LANDSCAPE PLANTING AREAS TO A MINIMUM DEPTH OF 36". CONTRACTOR IS RESPONSIBLE TO BACKFILL THESE PLANTING AREAS TO ROUGH FINISHED GRADE WITH CLEAN TOPSOIL FROM AN ON-SITE SOURCE OR AN IMPORTED SOURCE. IF LIMEROCK OR OTHER ADVERSE CONDITIONS OCCUR IN PLANTED AREAS AFTER 36" DEEP EXCAVATION BY THE CONTRACTOR, AND ADEQUATE PERCOLATION CAN NOT BE ACHIEVED, CONTRACTOR SHALL UTILIZE PLANTING DETAIL THAT ADDRESSES POOR DRAINAGE.
- 4. FURNISH NURSERY'S CERTIFICATE OF COMPLIANCE WITH ALL REQUIREMENTS AS HEREIN SPECIFIED AND REQUIRED. INSPECT AND SELECT PLANT MATERIALS BEFORE PLANTS ARE DUG AT NURSERY OR GROWING SITE.
- 5. GENERAL COMPLY WITH APPLICABLE FEDERAL, STATE, COUNTY, AND LOCAL REGULATIONS GOVERNING LANDSCAPE MATERIALS AND WORK. CONFORM TO ACCEPTED HORTICULTURAL PRACTICES AS USED IN THE TRADE. UPON ARRIVAL AT THE SITE, PLANTS SHALL BE THOROUGHLY WATERED AND PROPERLY MAINTAINED UNTIL PLANTED. PLANTS STORED ON-SITE SHALL NOT REMAIN UNPLANTED FOR A PERIOD EXCEEDING TWENTY-FOUR (24) HOURS. AT ALL TIMES, METHODS CUSTOMARY IN GOOD HORTICULTURAL PRACTICES SHALL BE EXERCISED.
- 6. THE WORK SHALL BE COORDINATED WITH OTHER TRADES TO PREVENT CONFLICTS.

  COORDINATE PLANTING WITH IRRIGATION WORK TO ASSURE AVAILABILITY OF WATER

  AND PROPER LOCATION OF IRRIGATION APPURTENANCES AND PLANTS.
- 7. ALL PLANTING PITS SHALL BE EXCAVATED TO SIZE AND DEPTH IN ACCORDANCE WITH THE USA STANDARD FOR NURSERY STOCK 260.1, UNLESS SHOWN OTHERWISE ON THE DRAWINGS, AND BACKFILLED WITH THE PREPARED PLANTING SOIL MIXTURE AS SPECIFIED IN SECTION E. TEST ALL TREE PITS WITH WATER BEFORE PLANTING TO ASSURE PROPER DRAINAGE PERCOLATION IS AVAILABLE. NO ALLOWANCE WILL BE MADE FOR LOST PLANTS DUE TO IMPROPER PERCOLATION. IF POOR PERCOLATION EXISTS, UTILIZE "POOR DRAINAGE CONDITION" PLANTING DETAIL. TREES SHALL BE SET PLUMB AND HELD IN POSITION UNTIL THE PLANTING MIXTURE HAS BEEN FLUSHED INTO PLACE WITH A SLOW, FULL HOSE STREAM. ALL PLANTING SHALL BE PERFORMED BY PERSONNEL FAMILIAR WITH PLANTING PROCEDURES AND UNDER THE SUPERVISION OF A QUALIFIED LANDSCAPE FOREMAN. PROPER "JETTING IN" SHALL BE ASSURED TO ELIMINATE AIR POCKETS AROUND THE ROOTS. "JET STICK" OR EQUAL IS RECOMMENDED.
- 8. TAKE ALL NECESSARY PRECAUTIONS TO AVOID DAMAGE TO BUILDINGS AND BUILDING STRUCTURES WHILE INSTALLING TREES.
- 9. SOIL MIXTURE SHALL BE AS SPECIFIED IN SECTION E OF THESE SPECIFICATIONS.
- 10. TREES AND SHRUBS SHALL BE SET STRAIGHT AT AN ELEVATION THAT, AFTER SETTLEMENT, THE PLANT CROWN WILL STAND ONE (1) TO TWO (2) INCHES ABOVE GRADE. EACH PLANT SHALL BE SET IN THE CENTER OF THE PIT. PLANTING SOIL MIXTURE SHALL BE BACKFILLED, THOROUGHLY TAMPED AROUND THE BALL, AND SETTLED BY WATER (AFTER TAMPING).
- 11. AMEND PINE AND OAK PLANT PITS WITH ECTOMYCORRHIZAL SOIL APPLICATION PER MANUFACTURER'S RECOMMENDATION. ALL OTHER PLANT PITS SHALL BE AMENDED WITH ENDOMYCORRHIZAL SOIL APPLICATION PER MANUFACTURER'S RECOMMENDATION. PROVIDE PRODUCT INFORMATION SUBMITTAL PRIOR TO INOCULATION.
- 12.FILL HOLE WITH SOIL MIXTURE, MAKING CERTAIN ALL SOIL IS SATURATED. TO DO THIS, FILL HOLE WITH WATER AND ALLOW TO SOAK MINIMUM TWENTY (20) MINUTES, STIRRING IF NECESSARY TO GET SOIL THOROUGHLY WET. PACK LIGHTLY WITH FEET. ADD MORE WET SOIL MIXTURE. DO NOT COVER TOP OF BALL WITH SOIL MIXTURE, ONLY WITH MULCH. ALL BURLAP, ROPE, WIRES, BASKETS, ETC..., SHALL BE REMOVED FROM THE SIDES AND TOPS OF BALLS, BUT NO BURLAP SHALL BE PULLED FROM UNDERNEATH.
- 13. PRUNING: TREES SHALL BE PRUNED, AT THE DIRECTION OF THE OWNER OR OWNER'S REPRESENTATIVE, TO PRESERVE THE NATURAL CHARACTER OF THE PLANT. ALL SOFT WOOD OR SUCKER GROWTH AND ALL BROKEN OR BADLY DAMAGED BRANCHES SHALL BE REMOVED WITH A CLEAN CUT. ALL PRUNING TO BE PERFORMED BY LICENSED ARBORIST, IN ACCORDANCE WITH ANSI A-300.
- 14. SHRUBS AND GROUND COVER PLANTS SHALL BE EVENLY SPACED IN ACCORDANCE WITH THE DRAWINGS AND AS INDICATED ON THE PLANT LIST. CULTIVATE ALL PLANTING AREAS TO A MINIMUM DEPTH OF 6", REMOVE AND DISPOSE ALL DEBRIS. MIX TOP 4" TO ACHEIVE SOIL MIXTURE AS SPECIFIED IN SECTION E. THOROUGHLY WATER ALL PLANTS AFTER INSTALLATION.
- 15. TREE GUYING AND BRACING SHALL BE INSTALLED BY THE CONTRACTOR IN ACCORDANCE WITH THE PLANS TO INSURE STABILITY AND MAINTAIN TREES IN AN UPRIGHT POSITION. IF THE CONTRACTOR AND OWNER DECIDE TO WAIVE THE TREE GUYING AND BRACING, THE OWNER SHALL NOTIFY THE LANDSCAPE ARCHITECT IN WRITING AND AGREE TO INDEMNIFY AND HOLD HARMLESS THE LANDSCAPE ARCHITECT IN THE EVENT UNSUPPORTED TREES PLANTED UNDER THIS CONTRACT FALL AND DAMAGE PERSON OR PROPERTY.
- 16.MULCHING: PROVIDE A THREE INCH (MINIMUM) LAYER OF SPECIFIED MULCH OVER THE ENTIRE AREA OF EACH SHRUB BED, GROUND COVER, VINE BED, AND TREE PIT PLANTED UNDER THIS CONTRACT.

17. HERBICIDE WEED CONTROL: ALL PLANT BEDS SHALL BE KEPT FREE OF NOXIOUS WEEDS UNTIL FINAL ACCEPTANCE OF WORK. IF DIRECTED BY THE OWNER, "ROUND-UP" SHALL BE APPLIED FOR WEED CONTROL BY QUALIFIED PERSONNEL TO ALL PLANTING AREAS IN SPOT APPLICATIONS PER MANUFACTURER'S PRECAUTIONS AND SPECIFICATIONS. PRIOR TO FINAL INSPECTION, TREAT ALL PLANTING BEDS WITH AN APPROVED PRE-EMERGENT HERBICIDE AT AN APPLICATION RATE RECOMMENDED BY THE MANUFACTURER. (AS ALLOWED BY JURISDICTIONAL AUTHORITY)

#### P. LAWN SODDING

- 1. THE WORK CONSISTS OF LAWN BED PREPARATION, SOIL PREPARATION, AND SODDING COMPLETE, IN STRICT ACCORDANCE WITH THE SPECIFICATIONS AND THE APPLICABLE DRAWINGS TO PRODUCE A TURF GRASS LAWN ACCEPTABLE TO THE OWNER.
- 2. LAWN BED PREPARATION: ALL AREAS THAT ARE TO BE SODDED SHALL BE CLEARED OF ANY ROUGH GRASS, WEEDS, AND DEBRIS, AND THE GROUND BROUGHT TO AN EVEN GRADE. THE ENTIRE SURFACE SHALL BE ROLLED WITH A ROLLER WEIGHING NOT MORE THAN ONE-HUNDRED (100) POUNDS PER FOOT OF WIDTH. DURING THE ROLLING, ALL DEPRESSIONS CAUSED BY SETTLEMENT SHALL BE FILLED WITH ADDITIONAL SOIL, AND THE SURFACE SHALL BE REGRADED AND ROLLED UNTIL PRESENTING A SMOOTH AND EVEN FINISH TO THE REQUIRED GRADE.
- 3. SOIL PREPARATION: PREPARE LOOSE BED FOUR (4) INCHES DEEP. HAND RAKE UNTIL ALL BUMPS AND DEPRESSIONS ARE REMOVED. WET PREPARED AREA THOROUGHLY.

### 4. SODDING

- a. THE CONTRACTOR SHALL SOD ALL AREAS THAT ARE NOT PAVED OR PLANTED AS DESIGNATED ON THE DRAWINGS WITHIN THE CONTRACT LIMITS, UNLESS SPECIFICALLY NOTED OTHERWISE.
- b. THE SOD SHALL BE CERTIFIED TO MEET FLORIDA STATE PLANT BOARD SPECIFICATIONS, ABSOLUTELY TRUE TO VARIETAL TYPE, AND FREE FROM WEEDS, FUNGUS, INSECTS AND DISEASE OF ANY KIND.
- c. SOD PANELS SHALL BE LAID TIGHTLY TOGETHER SO AS TO MAKE A SOLID SODDED LAWN AREA. SOD SHALL BE LAID UNIFORMLY AGAINST THE EDGES OF ALL CURBS AND OTHER HARDSCAPE ELEMENTS, PAVED AND PLANTED AREAS. ADJACENT TO BUILDINGS, A 24 INCH STONE MULCH STRIP SHALL BE PROVIDED REFER TO DETAILS. IMMEDIATELY FOLLOWING SOD LAYING, THE LAWN AREAS SHALL BE ROLLED WITH A LAWN ROLLER CUSTOMARILY USED FOR SUCH PURPOSES, AND THEN THOROUGHLY IRRIGATED. IF, IN THE OPINION OF THE OWNER, TOP-DRESSING IS NECESSARY AFTER ROLLING TO FILL THE VOIDS BETWEEN THE SOD PANELS AND TO EVEN OUT INCONSISTENCIES IN THE SOD, CLEAN SAND, AS APPROVED BY THE OWNER'S REPRESENTATIVE, SHALL BE UNIFORMLY SPREAD OVER THE ENTIRE SURFACE OF THE SOD AND THOROUGHLY WATERED IN. FERTILIZE INSTALLED SOD AS ALLOWED BY PROPERTY'S JURISDICTIONAL AUTHORITY.
- 5. DURING DELIVERY, PRIOR TO, AND DURING THE PLANTING OF THE LAWN AREAS, THE SOD PANELS SHALL AT ALL TIMES BE PROTECTED FROM EXCESSIVE DRYING AND UNNECESSARY EXPOSURE OF THE ROOTS TO THE SUN. ALL SOD SHALL BE STACKED SO AS NOT TO BE DAMAGED BY SWEATING OR EXCESSIVE HEAT AND MOISTURE.

#### 6. LAWN MAINTENANCE:

- a. WITHIN THE CONTRACT LIMITS, THE CONTRACTOR SHALL PRODUCE A DENSE, WELL ESTABLISHED LAWN. THE CONTRACTOR SHALL BE RESPONSIBLE FOR THE REPAIR AND RE-SODDING OF ALL ERODED, SUNKEN OR BARE SPOTS (LARGER THAN 12"X12") UNTIL CERTIFICATION OF ACCEPTABILITY BY THE OWNER'S REPRESENTATIVE. REPAIRED SODDING SHALL BE ACCOMPLISHED AS IN THE ORIGINAL WORK (INCLUDING REGRADING IF NECESSARY).
- b. CONTRACTOR RESPONSIBLE FOR ESTABLISHING AND MAINTAINING SOD/LAWN UNTIL ACCEPTANCE BY THE OWNER'S REPRESENTATIVE. PRIOR TO AND UPON ACCEPTANCE, CONTRACTOR TO PROVIDE WATERING/IRRIGATION SCHEDULE TO OWNER. OBSERVE ALL APPLICABLE WATERING RESTRICTIONS AS SET FORTH BY THE PROPERTY'S JURISDICTIONAL AUTHORITY.

## Q. CLEAN

 UPON COMPLETION OF ALL PLANTING WORK AND BEFORE FINAL ACCEPTANCE, THE CONTRACTOR SHALL REMOVE ALL MATERIAL, EQUIPMENT, AND DEBRIS RESULTING FROM HIS WORK. ALL PAVED AREAS SHALL BE BROOM-CLEANED AND THE SITE LEFT IN A NEAT AND ACCEPTABLE CONDITION AS APPROVED BY THE OWNER'S AUTHORIZED REPRESENTATIVE.

## R. PLANT MATERIAL MAINTENANCE

1. ALL PLANTS AND PLANTING INCLUDED UNDER THIS CONTRACT SHALL BE MAINTAINED BY WATERING, CULTIVATING, SPRAYING, AND ALL OTHER OPERATIONS (SUCH AS RE-STAKING OR REPAIRING GUY SUPPORTS) NECESSARY TO INSURE A HEALTHY PLANT CONDITION BY THE CONTRACTOR UNTIL CERTIFICATION OF ACCEPTABILITY BY THE OWNER'S REPRESENTATIVE. MAINTENANCE AFTER THE CERTIFICATION OF ACCEPTABILITY SHALL BE IN ACCORDANCE WITH THE SPECIFICATIONS IN THIS SECTION. CONTRACTORS ARE REQUESTED TO PROVIDE A BID ESTIMATE TO COVER LANDSCAPE AND IRRIGATION MAINTENANCE FOR A PERIOD OF 90 CALENDAR DAYS COMMENCING AFTER ACCEPTANCE.

## S. MAINTENANCE (ALTERNATE BID ITEM)

1. CONTRACTORS ARE REQUESTED TO PROVIDE A BID ESTIMATE FOR MAINTENANCE FOLLOWING THE INITIAL 90-DAY MAINTENANCE PERIOD ON A COST-PER-MONTH BASIS.

## T. FINAL INSPECTION AND ACCEPTANCE OF WORK

1. FINAL INSPECTION AT THE END OF THE WARRANTY PERIOD SHALL BE ON PLANTING, CONSTRUCTION AND ALL OTHER INCIDENTAL WORK PERTAINING TO THIS CONTRACT. ANY REPLACEMENT AT THIS TIME SHALL BE SUBJECT TO THE SAME ONE (1) YEAR WARRANTY (OR AS SPECIFIED BY THE LANDSCAPE ARCHITECT OR OWNER IN WRITING) BEGINNING WITH THE TIME OF REPLACEMENT AND ENDING WITH THE SAME INSPECTION AND ACCEPTANCE HEREIN DESCRIBED.

## U. WARRANTY

- 1. THE LIFE AND SATISFACTORY CONDITION OF ALL PLANT MATERIAL INSTALLED BY THE LANDSCAPE CONTRACTOR SHALL BE WARRANTED BY THE CONTRACTOR FOR A MINIMUM OF ONE (1) CALENDAR YEAR COMMENCING AT THE TIME OF CERTIFICATION OF ACCEPTABILITY BY THE OWNER'S REPRESENTATIVE.
- 2. REPLACEMENT: ANY PLANT NOT FOUND IN A HEALTHY GROWING CONDITION AT THE END OF THE WARRANTY PERIOD SHALL BE REMOVED FROM THE SITE AND REPLACED AS SOON AS WEATHER CONDITIONS PERMIT. ALL REPLACEMENTS SHALL BE PLANTS OF THE SAME KIND AND SIZE AS SPECIFIED IN THE PLANT LIST. THEY SHALL BE FURNISHED PLANTED AND MULCHED AS SPECIFIED UNDER "PLANTING", AT NO ADDITIONAL COST TO THE OWNER.
- 3. IN THE EVENT THE OWNER DOES NOT CONTRACT WITH THE CONTRACTOR FOR LANDSCAPE (AND IRRIGATION) MAINTENANCE, THE CONTRACTOR IS ENCOURAGED TO VISIT THE PROJECT SITE PERIODICALLY DURING THE ONE YEAR WARRANTY PERIOD TO EVALUATE MAINTENANCE PROCEDURES BEING PERFORMED BY THE OWNER, AND SHALL NOTIFY THE OWNER IN WRITING OF MAINTENANCE PROCEDURES OR CONDITIONS WHICH THREATEN VIGOROUS AND HEALTHY PLANT GROWTH. IT IS SUGGESTED SUCH SITE VISITS SHALL BE CONDUCTED A MINIMUM OF ONCE PER MONTH FOR A PERIOD OF TWELVE (12) MONTHS FROM THE DATE OF ACCEPTANCE.

Restaurant Support Office

Store:

Raising Cane's
Restaurant #0855
8070 NW 36th Street
Doral, FL 33166
CUSTOM [A]

Designer's Information:

Baton Rouge, Louisiana 70808
Telephone: 225 769-0546
www.csrsinc.com

6767 Perkins Road, Suite 200

Prototype Phase: 2021-1.0 (05-07-2021)

Project Issue Date: 10-30-2021

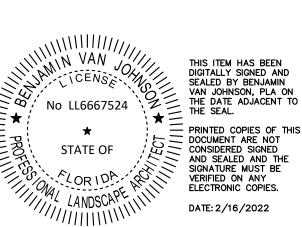
CSRS Project Manager:

**ENTITLEMENTS** 

MRF

11-19-2021

355 ALHAMBRA CIRCLE, SUITE 1400, CORAL GABLES, FL 33134 PHONE: 305—673—2025 WWW.KIMLEY—HORN.COM CA 00000696

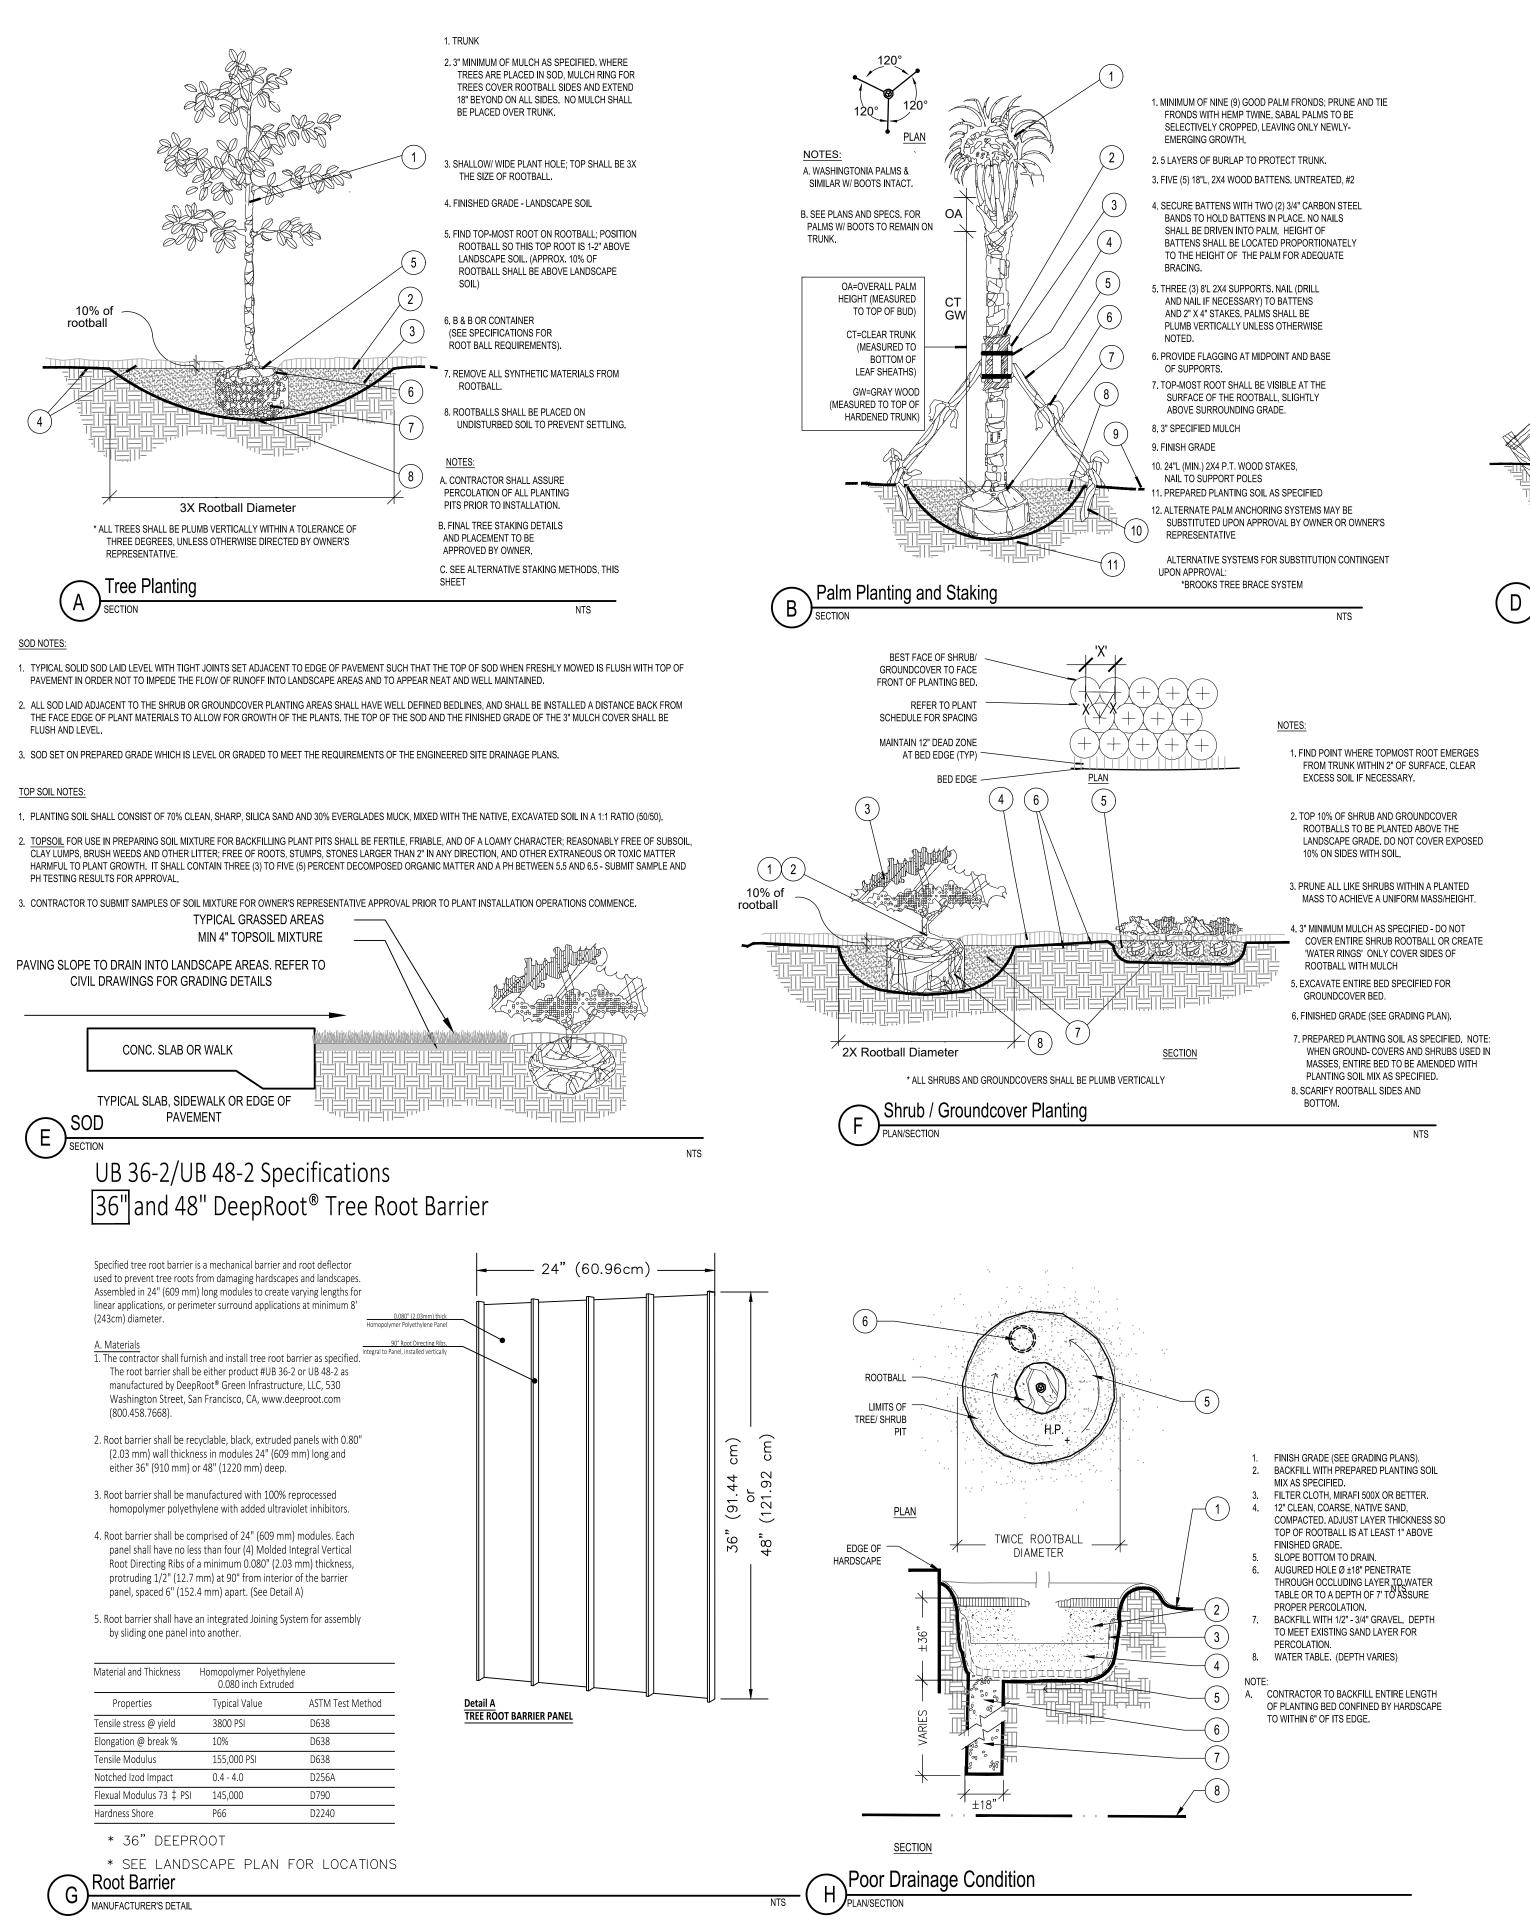


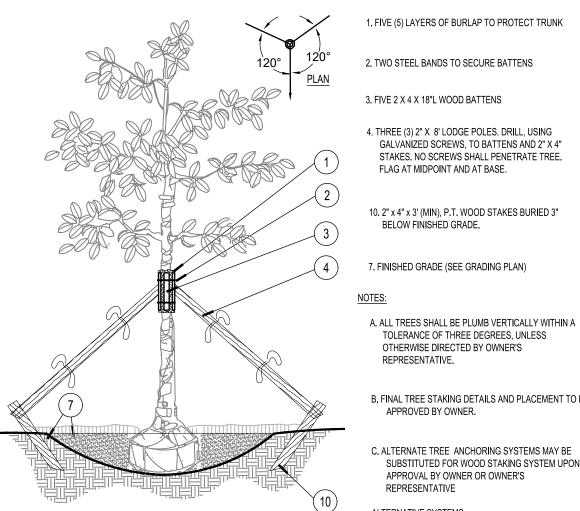
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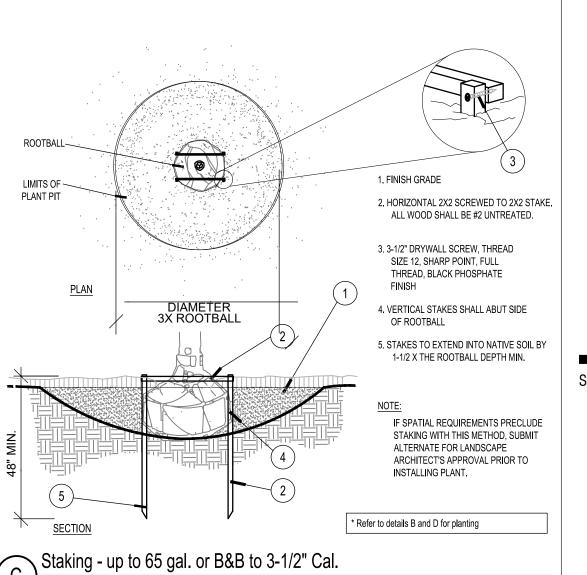
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B. FINAL TREE STAKING DETAILS AND PLACEMENT TO BE APPROVED BY OWNER. C. ALTERNATE TREE ANCHORING SYSTEMS MAY BE SUBSTITUTED FOR WOOD STAKING SYSTEM UPON APPROVAL BY OWNER OR OWNER'S REPRESENTATIVE ALTERNATIVE SYSTEMS: \*BROOKS TREE BRACE SYSTEM \*ARBOR TIE TREE BRACING Large Tree Staking - 100 Gal + or B&B 4" + D. RUBBER HOSE/WIRE SYSTEMS ARE NOT ALLOWED.



Store:

Raising Cane's Restaurant #0855 8070 NW 36th Street Doral, FL 33166 CUSTOM [A]

Designer's Information:

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6767 Perkins Road, Suite 200

2021-1.0 (05-07-2021) Prototype Phase:

Project Issue Date:

CSRS Project Manager:

**ENTITLEMENTS** 

10-30-2021

11-19-2021

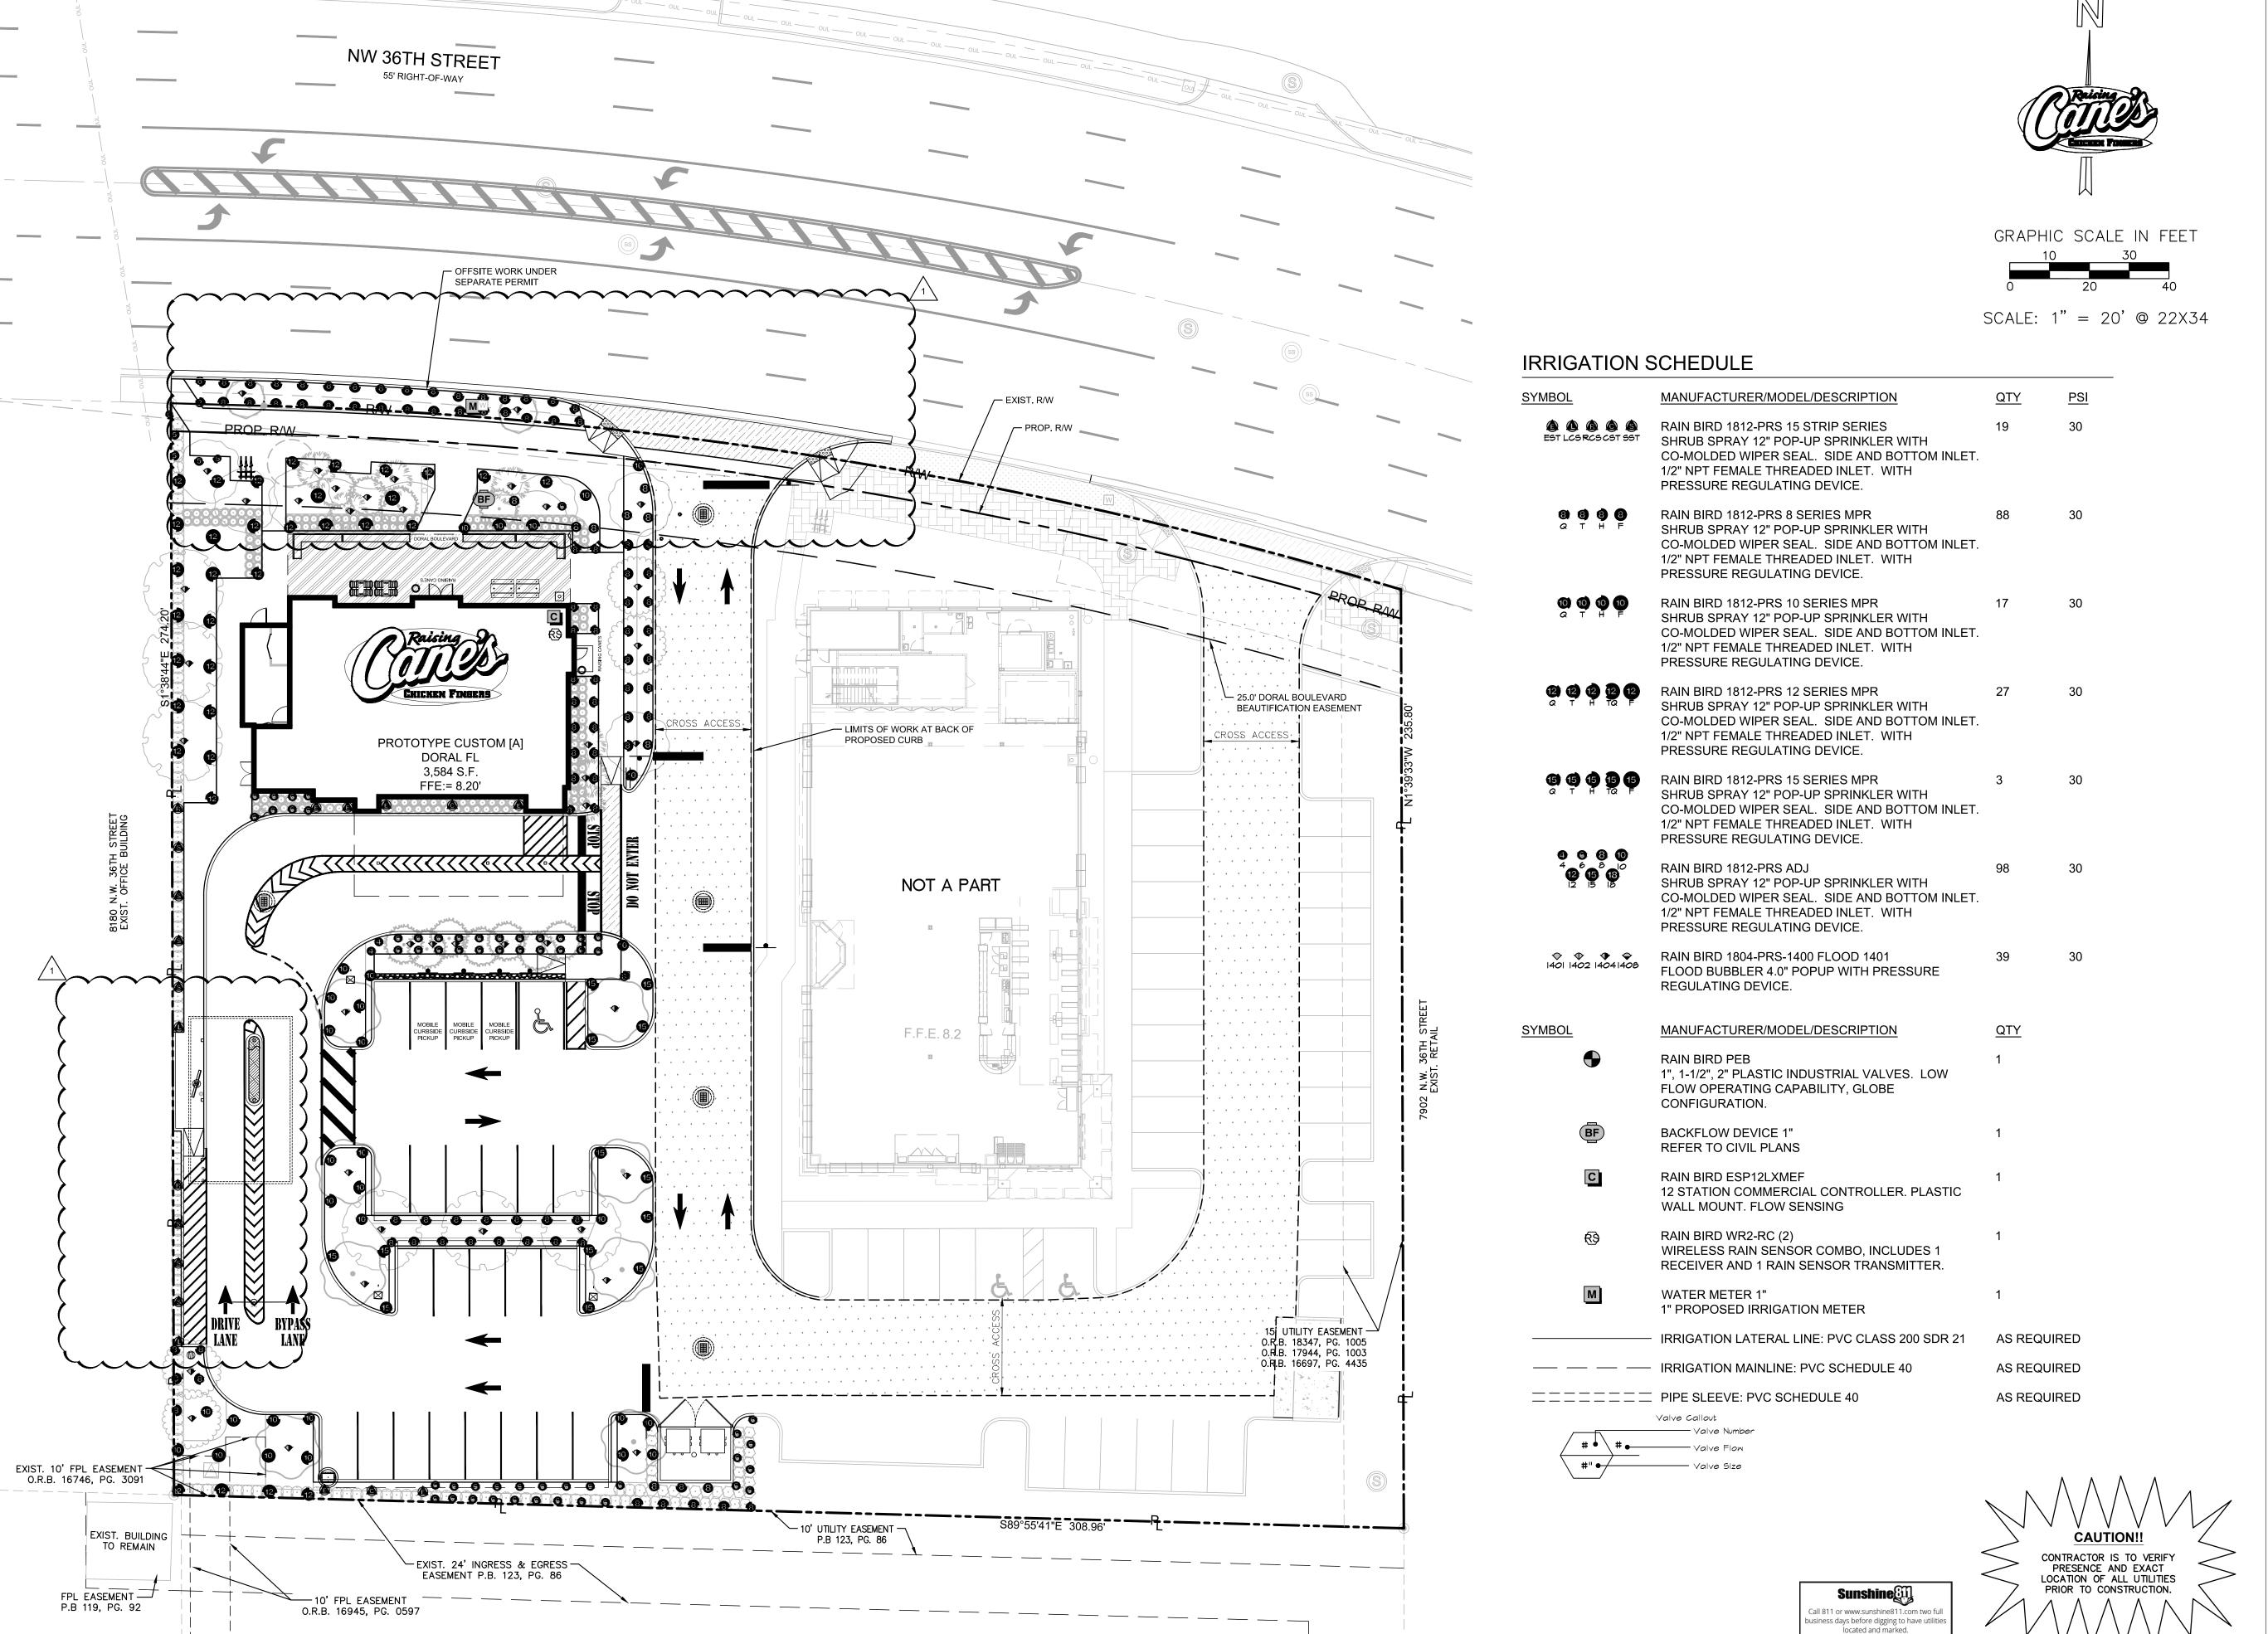
355 ALHAMBRA CIRCLE, SUITE 1400, CORAL GABLES, FL 33134 PHONE: 305-673-2025 WWW.KIMLEY-HORN.COM CA 00000696

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LANDSCAPE DETAILS

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Store:

Raising Cane's
Restaurant #0855
8070 NW 36th Street
Doral, FL 33166
CUSTOM [A]

Designer's Information:

# CSRS

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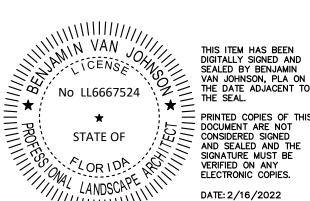
CSRS Project Manager: M

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ENTITLEMENTS 11-19-2021

# **Kimley Morn**

355 ALHAMBRA CIRCLE, SUITE 1400, CORAL GABLES, FL 33134 PHONE: 305-673-2025 WWW.KIMLEY-HORN.COM CA 00000696



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IRRIGATION PLAN

Sheet Number:

### GENERAL IRRIGATION SPECIFICATIONS AND NOTES

#### UNDERGROUND IRRIGATION SYSTEM

#### PART I: GENERAL

#### 1.01 SCOPE

- A. THE WORK COVERED BY THIS SPECIFICATION SHALL INCLUDE THE FURNISHING OF ALL LABOR, MATERIALS, TOOLS AND EQUIPMENT NECESSARY TO PERFORM AND COMPLETE THE INSTALLATION OF AN AUTOMATIC IRRIGATION SYSTEM AS SPECIFIED HEREIN AND AS SHOWN ON THE DRAWINGS AND ANY INCIDENTAL WORK NOT SHOWN OR SPECIFIED WHICH CAN REASONABLY BE DETERMINED TO BE PART OF THE WORK AND NECESSARY TO PROVIDE A COMPLETE AND FUNCTIONAL SYSTEM.
- B. THE WORK COVERED BY THIS SPECIFICATION ALSO INCLUDES ALL PERMITS, FEDERAL, STATE AND LOCAL TAXES AND ALL OTHER COSTS, BOTH FORESEEABLE AND UNFORESEEABLE AT THE TIME OF CONSTRUCTION
- C. NO DEVIATION FROM THESE SPECIFICATIONS, THE ACCOMPANYING DRAWINGS, OR AGREEMENT IS AUTHORIZED OR SHALL BE MADE WITHOUT PRIOR WRITTEN AUTHORIZATION SIGNED BY THE OWNER OR HIS DULY APPOINTED REPRESENTATIVE.

#### 1.02 QUALITY ASSURANCE

- A. INSTALLER QUALIFICATIONS: A FIRM SPECIALIZING IN IRRIGATION WORK WITH NOT LESS THAN FIVE (5) YEARS OF EXPERIENCE IN INSTALLING IRRIGATION SYSTEMS SIMILAR TO THOSE REQUIRED FOR THIS PROJECT.
- B. COORDINATION: COORDINATE AND COOPERATE WITH OTHER CONTRACTORS TO ENABLE THE WORK TO PROCEED AS RAPIDLY AND EFFICIENTLY AS POSSIBLE.
- C. INSPECTION OF SITE: THE CONTRACTOR SHALL ACQUAINT HIMSELF WITH ALL SITE CONDITIONS, INCLUDING UNDERGROUND UTILITIES BEFORE CONSTRUCTION IS TO BEGIN. CONTRACTOR SHALL COORDINATE PLACEMENT OF UNDERGROUND MATERIALS WITH CONTRACTORS PREVIOUSLY WORKING UNDERGROUND IN THE VICINITY OR THOSE SCHEDULED TO DO UNDERGROUND WORK IN THE VICINITY. CONTRACTOR IS RESPONSIBLE FOR MINOR ADJUSTMENTS IN THE LAYOUT OF THE WORK TO ACCOMMODATE EXISTING
- D. PROTECTION OF EXISTING PLANTS AND SITE CONDITIONS: THE CONTRACTOR SHALL TAKE NECESSARY PRECAUTIONS TO PROTECT SITE CONDITIONS TO REMAIN. SHOULD DAMAGES BE INCURRED, THIS CONTRACTOR SHALL REPAIR THE DAMAGE TO ITS ORIGINAL CONDITION AT HIS OWN EXPENSE. ANY DISRUPTION, DESTRUCTION, OR DISTURBANCE OF ANY EXISTING PLANT, TREE, SHRUB, OR TURF, OR ANY STRUCTURE SHALL BE COMPLETELY RESTORED TO THE SATISFACTION OF THE OWNER AND HIS REPRESENTATIVES, SOLELY AT THE CONTRACTOR'S EXPENSE.
- E. PROTECTION OF WORK AND PROPERTY: THE CONTRACTOR SHALL BE LIABLE FOR AND SHALL TAKE THE FOLLOWING ACTIONS AS REQUIRED WITH REGARD TO DAMAGE TO ANY OF THE OWNER'S PROPERTY.
  - 1. ANY EXISTING BUILDING, EQUIPMENT, PIPING, PIPE COVERINGS, ELECTRICAL SYSTEMS, SEWERS, SIDEWALKS, ROADS, GROUNDS, LANDSCAPING OR STRUCTURE OF ANY KIND (INCLUDING WITHOUT LIMITATION, DAMAGE FROM LEAKS IN THE PIPING SYSTEM BEING INSTALLED OR HAVING BEEN INSTALLED BY CONTRACTOR) DAMAGED BY THE CONTRACTOR, OR BY HIS AGENTS, EMPLOYEES, OR SUBCONTRACTORS, DURING THE COURSE OF HIS WORK, WHETHER THROUGH NEGLIGENCE OR OTHERWISE, SHALL BE REPLACED OR REPAIRED BY CONTRACTOR AT HIS OWN EXPENSE IN A MANNER SATISFACTORY TO OWNER, WHICH REPAIR OR REPLACEMENT SHALL BE A CONDITION PRECEDENT TO OWNER'S OBLIGATION TO MAKE FINAL PAYMENT UNDER THE CONTRACT.
  - 2. CONTRACTOR SHALL ALSO BE RESPONSIBLE FOR DAMAGE TO ANY WORK COVERED BY THESE SPECIFICATIONS BEFORE FINAL ACCEPTANCE OF THE WORK. HE SHALL SECURELY COVER ALL OPENINGS INTO THE SYSTEMS AND COVER ALL APPARATUS, EQUIPMENT AND APPLIANCES, BOTH BEFORE AND AFTER BEING SET IN PLACE TO PREVENT OBSTRUCTIONS ON THE PIPES AND THE BREAKAGE, MISUSE OR DISFIGUREMENT OF THE APPARATUS, EQUIPMENT OR APPLIANCE.
  - 3. ALL TRENCHING OR OTHER WORK UNDER THE LEAF CANOPY OF ANY AND ALL TREES SHALL BE DONE BY HAND OR BY OTHER METHODS SO THAT NO BRANCHES ARE DAMAGED IN ANY WAY. BUILDINGS, WALKS, WALLS, AND OTHER PROPERTY SHALL BE PROTECTED FROM DAMAGE. OPEN DITCHES LEFT EXPOSED SHALL BE FLAGGED AND BARRICADED BY THE CONTRACTOR BY APPROVED MEANS. THE CONTRACTOR SHALL RESTORE DISTURBED AREAS TO THEIR ORIGINAL CONDITION.
  - 4. THE CONTRACTOR SHALL BE RESPONSIBLE FOR REQUESTING THE PROPER UTILITY COMPANY TO STAKE THE EXACT LOCATION OF ANY UNDERGROUND LINES INCLUDING BUT NOT LIMITED TO ELECTRIC, GAS, TELEPHONE SERVICE, WATER, AND CABLE. THE CONTRACTOR SHALL TAKE WHATEVER PRECAUTIONS ARE NECESSARY TO PROTECT THESE UNDERGROUND LINES FROM DAMAGE. IN THE EVENT DAMAGE DOES OCCUR, ALL DAMAGE SHALL BE COMPLETELY REPAIRED TO ITS ORIGINAL CONDITION, AT NO ADDITIONAL COST TO THE OWNER.
  - 5. THE CONTRACTOR SHALL REQUEST THE OWNER, IN WRITING, TO LOCATE ANY PRIVATE UTILITIES (I.E., ELECTRICAL SERVICE TO OUTSIDE LIGHTING) BEFORE PROCEEDING WITH ANY EXCAVATION. IF, AFTER SUCH REQUESTS AND NECESSARY STAKING, PRIVATE UTILITIES WHICH WERE NOT STAKED ARE ENCOUNTERED AND DAMAGED BY THE CONTRACTOR, THEY SHALL BE REPAIRED BY THE OWNER AT NO COST TO THE CONTRACTOR. IF THE CONTRACTOR DAMAGES STAKED OR LOCATED UTILITIES, THEY SHALL BE REPAIRED AT
- F. CODES AND INSPECTIONS: THE ENTIRE INSTALLATION SHALL COMPLY FULLY WITH ALL LOCAL AND STATE LAWS AND ORDINANCES AND WITH ALL ESTABLISHED CODES ARRANGE FOR ALL NECESSARY INSPECTIONS AND SHALL PAY ALL FEES AND EXPENSES IN CONNECTION WITH SAME, AS PART OF THE WORK UNDER THIS CONTRACT. UPON COMPLETION OF THE WORK, HE SHALL FURNISH TO THE "OWNER" ALL INSPECTION CERTIFICATES CUSTOMARILY ISSUED IN CONNECTION WITH THE CLASS OF WORK INVOLVED.
- G. THE CONTRACTOR SHALL KEEP ON HIS WORK, DURING ITS PROGRESS, A COMPETENT SUPERINTENDENT AND ANY NECESSARY ASSISTANTS, ALL SATISFACTORY TO THE OWNER, OR OWNER'S REPRESENTATIVE.
- H. THE SUPERINTENDENT SHALL REPRESENT THE CONTRACTOR IN HIS ABSENCE AND ALL DIRECTIONS GIVEN TO HIM SHALL BE AS BINDING AS IF GIVEN TO THE CONTRACTOR.
- I. THE OWNER'S LANDSCAPE ARCHITECT OR DESIGNATED INDIVIDUAL SHALL HAVE FULL AUTHORITY TO APPROVE OR REJECT WORK PERFORMED BY THE CONTRACTOR. THE OWNER'S AUTHORIZED REPRESENTATIVE SHALL ALSO HAVE FULL AUTHORITY TO MAKE FIELD CHANGES THAT ARE DEEMED NECESSARY
- J. FINAL ACCEPTANCE: FINAL ACCEPTANCE OF THE WORK MAY BE OBTAINED FROM THE OWNER UPON THE SATISFACTORY COMPLETION OF ALL WORK. ACCEPTANCE BY THE LANDSCAPE ARCHITECT AND/OR OWNER IN 2.01 MATERIALS NO WAY REMOVES THE CONTRACTOR OF HIS RESPONSIBILITY TO MAKE FURTHER REPAIRS, CORRECTIONS AND ADJUSTMENTS TO ELIMINATE ANY DEFICIENCIES WHICH MAY LATER BE DISCOVERED.
- K. GUARANTEE: ALL WORK SHALL BE GUARANTEED FOR ONE YEAR FROM DATE OF FINAL ACCEPTANCE AGAINST ALL DEFECTS IN MATERIAL, EQUIPMENT AND WORKMANSHIP TO THE SATISFACTION OF THE OWNER. REPAIRS, IF REQUIRED, SHALL BE DONE PROMPTLY AT NO COST TO THE OWNER.
- 1. THE GUARANTEE SHALL ALSO COVER REPAIR OF DAMAGE TO ANY PART OF THE PREMISES RESULTING FROM LEAKS OR WORKMANSHIP, TO THE SATISFACTION OF THE OWNER. THE CONTRACTOR SHALL NOT BE RESPONSIBLE FOR WORK DAMAGED BY OTHERS. REPAIRS, IF REQUIRED, SHALL BE DONE PROMPTLY. THE GUARANTEE SHALL STATE THE NAME OF THE OWNER, PROVIDE FULL GUARANTEE TERMS, EFFECTIVE AND 2.02 PIPING TERMINATION DATE, NAME AND LICENSE NUMBER OF CONTRACTOR PROVIDING GUARANTEE, ADDRESS, AND TELEPHONE NUMBER. IT SHALL BE SIGNED BY THE CHIEF EXECUTIVE OF THE CONTRACTOR OF HIS LIABILITY UNDER THE GUARANTEE. SUCH WARRANTIES SHALL ONLY SUPPLEMENT THE GUARANTEE.
- 2. IF, WITHIN TEN (10) DAYS AFTER MAILING OF WRITTEN NOTICE BY THE OWNER TO THE CONTRACTOR REQUESTING REPAIRS OR REPLACEMENT RESULTING FROM A BREACH OF WARRANTY, THE CONTRACTOR SHALL NEGLECT TO MAKE OR UNDERTAKE WITH DUE DILIGENCE TO MAKE THE SAME, THE OWNER MAY MAKE SUCH REPAIRS AT THE CONTRACTOR'S EXPENSE; PROVIDED, HOWEVER, THAT IN THE CASE OF EMERGENCY WHERE, IN THE JUDGMENT OF THE OWNER, DELAY WOULD CAUSE SERIOUS LOSS OR DAMAGE, REPAIRS OR REPLACEMENT MAY BE MADE WITHOUT NOTICE BEING SENT TO THE CONTRACTOR, AND CONTRACTOR SHALL PAY THE COST THEREOF.
- L. THE CONTRACTOR SHALL PROVIDE FULL, 100% IRRIGATION COVERAGE IN ALL AREAS DESIGNED WITH PROPOSED PLANTINGS, IN ACCORDANCE WITH THE SITE'S GOVERNING PERMITTING REQUIREMENTS AND AS
- M. ON-SITE OBSERVATION: AT ANY TIME DURING THE INSTALLATION OF THE IRRIGATION SYSTEM BY THE CONTRACTOR, THE OWNER OR LANDSCAPE ARCHITECT MAY VISIT THE SITE TO OBSERVE WORK UNDERWAY. UPON REQUEST, THE CONTRACTOR SHALL BE REQUIRED TO UNCOVER SPECIFIED WORK AS DIRECTED BY THE OWNER OR MATERIAL, WORKMANSHIP OR METHOD OF INSTALLATION NOT MEET THE STANDARDS SPECIFIED HEREIN, THE CONTRACTOR SHALL REPLACE THE WORK AT HIS OWN EXPENSE.
- N. WORKMANSHIP: ALL WORK SHALL BE INSTALLED BY QUALIFIED, SKILLED PERSONNEL, PROFICIENT IN THE TRADES REQUIRED, IN A NEAT, ORDERLY, AND RESPONSIBLE MANNER WITH RECOGNIZED STANDARDS OF WORKMANSHIP. THE CONTRACTOR SHALL HAVE HAD CONSIDERABLE EXPERIENCE AND DEMONSTRATED ABILITY IN THE INSTALLATION OF SPRINKLER IRRIGATION SYSTEMS OF THIS TYPE.

### 1.03 SUBMITTALS

- ALL MATERIALS SHALL BE THOSE SPECIFIED AND/OR APPROVED BY THE LANDSCAPE ARCHITECT.
- A. PRODUCT DATA: AFTER THE AWARD OF THE CONTRACT AND PRIOR TO BEGINNING WORK, THE CONTRACTOR SHALL SUBMIT FOR APPROVAL BY THE OWNER AND LANDSCAPE ARCHITECT, TWO COPIES OF THE COMPLETE LIST OF MATERIALS, MANUFACTURER'S TECHNICAL DATA, AND INSTALLATION INSTRUCTIONS WHICH HE PROPOSES TO INSTALL.
- B. COMMENCE NO WORK BEFORE APPROVAL OF MATERIAL LIST AND DESCRIPTIVE MATERIAL BY THE LANDSCAPE
- RECORD DRAWINGS: THE CONTRACTOR SHALL RECORD ON REPRODUCIBLES, ALL CHANGES THAT MAY BE MADE DURING ACTUAL INSTALLATION OF THE SYSTEM. PROVIDE CONTROLLER SEQUENCING AND CONTROL
- 1. IMMEDIATELY UPON INSTALLATION OF ANY PIPING, VALVES, WIRING, SPRINKLERS, ETC., IN LOCATIONS OTHER THAN SHOWN ON THE ORIGINAL DRAWINGS OR OF SIZES OTHER THAN INDICATED, THE CONTRACTOR SHALL CLEARLY INDICATE SUCH CHANGES ON A SET OF BLUELINE PRINTS. RECORDS SHALL BE MADE ON A DAILY BASIS. ALL RECORDS SHALL BE NEAT AND SUBJECT TO THE APPROVAL OF THE OWNER.
- 2. THE CONTRACTOR SHALL ALSO INDICATE ON THE RECORD PRINTS THE LOCATION OF ALL WIRE SPLICES, ORIGINAL OR DUE TO REPAIR, THAT ARE INSTALLED UNDERGROUND IN A LOCATION OTHER THAN THE CONTROLLER PEDESTAL, REMOTE CONTROL VALVE BOX, POWER SOURCE OR CONNECTION TO A VALVE-IN-HEAD SPRINKLER.
- 3. THESE DRAWINGS SHALL ALSO SERVE AS WORK PROGRESS SHEETS. THE CONTRACTOR SHALL MAKE NEAT AND LEGIBLE NOTATIONS THEREON DAILY AS THE WORK PROCEEDS, SHOWING THE WORK AS ACTUALLY INSTALLED. THESE DRAWINGS SHALL BE AVAILABLE AT ALL TIMES FOR REVIEW AND SHALL BE KEPT IN A LOCATION DESIGNATED BY THE OWNER'S REPRESENTATIVE.
- 4. PROGRESS PAYMENT REQUEST AND RECORD DRAWING INFORMATION MUST BE APPROVED BY LANDSCAPE ARCHITECT BEFORE PAYMENT IS MADE.
- 5. IF IN THE OPINION OF THE OWNER OR HIS REPRESENTATIVE, THE RECORD DRAWING INFORMATION IS NOT BEING PROPERLY OR PROMPTLY RECORDED, CONSTRUCTION PAYMENT MAY BE STOPPED UNTIL THE PROPER INFORMATION HAS BEEN RECORDED AND SUBMITTED.
- 6. BEFORE THE DATE OF THE FINAL SITE OBSERVATION AND APPROVAL, THE CONTRACTOR SHALL DELIVER ONE 2.09 AUTOMATIC CONTROL VALVE SET (COPIES) OF REPRODUCIBLE RECORD DRAWING PLANS AND NOTES TO THE LANDSCAPE ARCHITECT. RECORD DRAWING INFORMATION SHALL BE APPROVED BY THE LANDSCAPE ARCHITECT PRIOR TO SUBMITTAL TO OWNER FOR FINAL PAYMENTS, INCLUDING RETENTIONS.
- OPERATIONS AND MAINTENANCE MANUALS: THE CONTRACTOR SHALL PREPARE AND DELIVER TO THE OWNER, OR HIS DESIGNATED REPRESENTATIVE WITHIN TEN (10) CALENDAR DAYS PRIOR TO COMPLETION OF CONSTRUCTION, A HARD COVER BINDER WITH THREE RINGS CONTAINING THE FOLLOWING INFORMATION:
- 1. INDEX SHEET STATING THE CONTRACTOR'S ADDRESS AND BUSINESS TELEPHONE NUMBER, LIST OF EQUIPMENT WITH NAME(S) AND ADDRESS(ES) OF LOCAL MANUFACTURER'S REPRESENTATIVE(S).
- 2. CATALOG AND PARTS SHEETS ON EVERY MATERIAL AND EQUIPMENT INSTALLED UNDER THIS CONTRACT. 3. COMPLETE OPERATING AND MAINTENANCE INSTRUCTION ON ALL MAJOR EQUIPMENT. INCLUDE INITIAL
- CONTROLLER SCHEDULE AND RECOMMENDED SCHEDULE AFTER ESTABLISHMENT PERIOD. 4. DEMONSTRATE TO AND PROVIDE THE OWNER'S MAINTENANCE PERSONNEL WITH INSTRUCTIONS FOR
- MAJOR EQUIPMENT AND SHOW EVIDENCE IN WRITING TO THE OWNER, OR HIS DESIGNATED REPRESENTATIVE AT THE CONCLUSION OF THE PROJECT THAT THIS SERVICE HAS BEEN RENDERED.

#### 1.04 EXPLANATION OF DRAWINGS

- A. DUE TO THE SCALE OF THE DRAWINGS, IT IS NOT POSSIBLE TO INDICATE ALL OFFSETS, FITTINGS AND SLEEVES WHICH MAY BE REQUIRED. THE CONTRACTOR SHALL CAREFULLY INVESTIGATE THE STRUCTURAL AND FINISHED CONDITIONS AFFECTING ALL OF THE WORK AND PLAN HIS WORK ACCORDINGLY, FURNISHING SUCH OFFSETS, FITTINGS AND SLEEVES AS MAY BE REQUIRED TO MEET SUCH CONDITIONS.
- THE DRAWINGS ARE GENERALLY DIAGRAMMATIC AND INDICATIVE OF THE WORK TO BE INSTALLED. THE WORK SHALL BE INSTALLED IN SUCH A MANNER AS TO AVOID CONFLICTS BETWEEN IRRIGATION SYSTEMS, PLANTING AND ARCHITECTURAL FEATURES. DEVIATIONS SHALL BE BROUGHT TO THE LANDSCAPE ARCHITECTS
- C. ALL WORK CALLED FOR A ON THE DRAWINGS BY NOTES OR DETAILS SHALL BE FURNISHED AND INSTALLED WHETHER OR NOT SPECIFICALLY MENTIONED IN THE SPECIFICATIONS.
- THE CONTRACTOR SHALL NOT WILLFULLY INSTALL THE IRRIGATION SYSTEM AS SHOWN ON THE DRAWINGS WHEN IT IS OBVIOUS IN THE FIELD THAT OBSTRUCTIONS, GRADE DIFFERENCES OR DISCREPANCIES IN AREA DIMENSIONS EXIST THAT MIGHT NOT HAVE BEEN KNOWN IN ENGINEERING. SUCH OBSTRUCTIONS OR DIFFERENCES SHOULD BE BROUGHT TO THE ATTENTION OF THE LANDSCAPE ARCHITECT. IN THE EVENT THAT NOTIFICATION IS NOT PERFORMED, THE CONTRACTOR SHALL ASSUME FULL RESPONSIBILITY FOR ANY REVISION NECESSARY.
- E. IF, IN THE OPINION OF THE LANDSCAPE ARCHITECT, THE LABOR FURNISHED BY THE CONTRACTOR IS INCOMPETENT, UNSKILLED, OR UNRELIABLE, HIS EQUIPMENT INADEQUATE, IMPROPER OR UNSAFE, OR IF THE CONTRACTOR SHALL FAIL TO CONTINUOUSLY AND DILIGENTLY EXECUTE THE CONSTRUCTION, THE LANDSCAPE ARCHITECT OR OWNER SHALL, IN WRITING, INSTRUCT THE CONTRACTOR TO REMOVE ALL SUCH CAUSES OF NONCOMPLIANCE AND THE CONTRACTOR SHALL PROMPTLY COMPLY.
- F. THE CONTRACTOR SHALL BE RESPONSIBLE FOR FULL AND COMPLETE COVERAGE OF ALL IRRIGATION AREAS. THE LANDSCAPE ARCHITECT SHALL BE NOTIFIED OF ANY NECESSARY ADJUSTMENTS AT NO ADDITIONAL COST TO THE OWNER. ANY REVISIONS TO THE IRRIGATION SYSTEM MUST BE SUBMITTED AND ANSWERED IN WRITTEN FORM, ALONG WITH ANY CHANGE IN CONTRACT PRICE. LAYOUT MAY BE MODIFIED, IF NECESSARY TO OBTAIN COVERAGE. SPACING NOT TO EXCEED 60% OF THE DIAMETER.

## PART II: PRODUCTS

A. MATERIAL AND EQUIPMENT SHALL BE SUPPLIED BY THE CONTRACTOR. NO SUBSTITUTIONS SHALL BE ALLOWED WITHOUT THE PRIOR WRITTEN APPROVAL OF THE OWNER/LANDSCAPE ARCHITECT. THE CONTRACTOR SHALL INSPECT ALL MATERIALS AND EQUIPMENT PRIOR TO INSTALLATION, AND DEFECTIVE MATERIALS SHALL BE REPLACED WITH THE PROPER MATERIALS AND EQUIPMENT. THOSE ITEMS USED IN THE INSTALLATION FOUND TO BE DEFECTIVE, IMPROPERLY INSTALLED OR NOT AS SPECIFIED, SHALL BE REMOVED AND THE PROPER MATERIALS AND EQUIPMENT INSTALLED IN THE PROPER MANNER, AS INTERPRETED BY THE OWNER/LANDSCAPE ARCHITECT. THE CONTRACTOR SHALL REMOVE ALL DAMAGED AND DEFECTIVE PIPE AND EQUIPMENT FROM THE SITE.

2.03 PVC JOINTS

- A. GENERAL PROVISIONS: ALL MATERIALS THROUGHOUT THE SYSTEM SHALL BE NEW AND IN PERFECT CONDITION UNLESS OTHERWISE DIRECTED BY THE LANDSCAPE ARCHITECT.
- B. POLYVINYL CHLORIDE PIPE (PVC): (WHERE INDICATED ON PLAN, USE NON-POTABLE PURPLE PIPING.)
- 1. LATERALS: PVC SHALL CONFORM TO THE REQUIREMENTS OF ASTM DESIGNATION D 2241, CLASS 1120 OR 1220. ALL LATERAL PIPING LESS THAN 3" IN DIAMETER SHALL BE CLASS 200 SDR-21.
- 2. MAIN LINE UNDER PRESSURE: PVC SHALL CONFORM TO THE REQUIREMENTS OF ASTM DESIGNATION D 2241, CLASS 1120 OR 1220, SCHEDULE 40 WITH BELLED END FOR SOLVENT WELD CONNECTION.
- 3. PIPE MARKINGS: ALL PVC PIPE SHALL BEAR THE FOLLOWING MARKINGS:
  - MANUFACTURER'S NAME
- NOMINAL PIPE SIZE
- c. SCHEDULE OR CLASS d. PRESSURE RATING OF PSI
- NSF (NATIONAL SANITATION FOUNDATION) APPROVAL
- DATE OF EXTRUSION

#### A. JOINTS IN PVC PIPE SMALLER THAN 3" SHALL BE SOLVENT WELDED IN ACCORDANCE WITH THE RECOMMENDATIONS OF THE PIPE MANUFACTURER; THE SOLVENT CLEANER AND WELDING COMPOUND FURNISHED WITH THE PIPE.

### 2.04 THREADED CONNECTIONS

- A. THREADED PVC CONNECTIONS SHALL BE MADE UP USING TEFLON TAPE ONLY.
  - CONNECTION BETWEEN MAINLINE PIPE FITTINGS AND AUTOMATIC OR MANUAL CONTROL VALVES SHALL BE MADE USING SCHEDULE 80 THREADED FITTINGS AND NIPPLES.

#### 2.05 SOLVENT CEMENT

- A. GENERAL: PROVIDE SOLVENT CEMENT AND PRIMER FOR PVC SOLVENT WELD PIPE AND FITTINGS RECOMMENDED BY THE MANUFACTURER. PIPE JOINTS FOR SOLVENT WELD PIPE TO BE BELLED END. PIPE JOINTS FOR GASKETED PIPE TO BE INTRICAL RING TYPE. INSERT GASKETS WILL NOT BE ACCEPTED.
- B. THRUST BLOCKS: MAIN LINE PIPING 3" OR GREATER IN DIAMETER SHALL HAVE THRUST BLOCKS SIZED AND PLACED IN ACCORDANCE WITH THE PIPE MANUFACTURER'S RECOMMENDATIONS OR. IN THE ABSENCE OF SPECIFIED RECOMMENDATIONS BY THE PIPE MANUFACTURER. 3000 PSI CONCRETE THRUSTS SHALL BE PROPERLY INSTALLED AT TEES, ELBOWS, 45'S, CROSSES, REDUCERS, PLUGS, CAPS AND VALVES.
- 2.06 PIPE AND WIRE SLEEVES
- A. SLEEVES TO BE INSTALLED:
- 1. THE CONTRACTOR SHALL INSTALL IRRIGATION SYSTEM PIPE AND WIRE SLEEVES CONFORMING TO THE
- ALL PIPE SLEEVES SHALL EXTEND A MINIMUM OF 36" BEYOND THE EDGES OF PAVEMENT.
- b. ALL PIPE SLEEVES TO BE INSTALLED BENEATH FUTURE/EXISTING ROAD SURFACES SHALL BE PVC PIPE SCHEDULE 40 OR JACK AND BORE STEEL PIPE AS PER FDOT SPECIFICATIONS, AND AS SHOWN ON
- c. ALL IRRIGATION SYSTEM WIRES SHALL BE SLEEVED SEPARATELY FROM MAIN OR LATERAL LINES. d. ALL PIPE SLEEVES SHALL BE INSTALLED AT THE MINIMUM DEPTH SPECIFIED FOR MAIN LINES, LATERAL LINES, AND ELECTRIC WIRE.
- e. CONTRACTOR SHALL COORDINATE ALL PIPE SLEEVE LOCATIONS AND DEPTHS PRIOR TO INITIATING INSTALLATION OF THE IRRIGATION SYSTEM.

- A. THE AUTOMATIC REMOTE CONTROL VALVES SHALL BE AS SPECIFIED ON THE PLANS, OR APPROVED EQUAL.
- A. GATE VALVES FOR 3/4" THROUGH 2-1/2" SHALL BE OF BRASS OR BRONZE CONSTRUCTION, SOLID WEDGE, IPS
- B. GATE VALVES FOR 3" AND LARGER: IRON BODY, BRASS OR BRONZE MOUNTED AWWA GATE VALVES, WITH A CLEAR WATERWAY EQUAL TO THE FULL NOMINAL DIAMETER OF THE VALVE, RUBBER GASKET FOR A CONTINUOUS WORKING PRESSURE OF 150P PSI. VALVE SHALL BE EQUIPPED WITH A SQUARE OPERATING NUT.

## 2.11 VALVE BOXES

- A. FOR GATE VALVES, USE AMETEK #10-181-014 BOX WITH #10-181-015 LOCKING LID, OR AS PER THE DRAWINGS.
- B. FOR CONTROL VALVES 3/4" THROUGH 2", THE DRIP VALVE ASSEMBLIES, USE AMETEK #10-181-014 BOX WITH #10-181-015 LOCKING LID, OR SIZED AS NECESSARY TO EFFECTIVELY HOUSE THE EQUIPMENT
- C. FOR CONTROL WIRING SPLICES, USE AMETEK #10-181-014 BOX WITH #10-181-015 LOCKING LID, OR AS PER THE DRAWINGS.

#### 2.12 IRRIGATION WIRING

- A. WIRING USED FOR CONNECTING THE ELECTRIC CONTROL VALVES TO THE CONTROLLERS SHALL BE TYPE UF, 600 VOLT, SINGLE STRAND, SOLID COPPER WITH PVC INSULATION 4/64" THICK. SIZE SHALL BE 14 GAUGE, RED FOR "HOT" OR LEAD WIRES, AND COMMON WIRE TO BE 14 GAUGE, WHITE IN COLOR.
- B. CONTRACTOR SHALL PERFORM AN OHM TEST ON GROUND TO ASSURE ADEQUATE PROTECTION AGAINST SURGES AND INDIRECT LIGHTNING STRIKES.

- A. DRAINAGE BACKFILL: CLEANED GRAVEL OR CRUSHED STONE, GRADED FROM 1" MAXIMUM TO 3/4" MINIMUM.
- B. METALIZED UNDERGROUND TAPE: THE DETECTABLE, UNDERGROUND UTILITY MARKING TAPE SHALL CONSIST OF A MINIMUM: 5 MIL (0.005") OVERALL THICKNESS; FIVE-PLY COMPOSITION; ULTRA-HIGH MOLECULAR WEIGHT, 100% VIRGIN POLYETHYLENE; ACID, ALKALINE AND CORROSION RESISTANT; WITH NO LESS THAN 150 POUNDS OF TENSILE BREAK STRENGTH PER 6" WIDTH; COLOR-CODE IMPREGNATED WITH COLOR STABLE, LEAD-FREE, ORGANIC PIGMENTS SUITABLE FOR DIRECT BURIAL. TAPES UTILIZING REPROCESSED PLASTICS OR RESINS SHALL NOT BE ACCEPTABLE. THE DETECTABLE, UNDERGROUND UTILITY MARKING TAPE SHALL HAVE A 35 GAUGE (0.0035") SOLID ALUMINUM FOIL, CORE ENCAPSULATED WITHIN A 2.55 MIL (0.00255") POLYETHYLENE BACKING AND A 0.6 MIL (0.006") PET COVER COATING. THE LAMINATE ON EACH SIDE SHALL CONSIST OF A 0.75 MIL (0.00075") LAYER OF HOT LPDE, POLY-FUSING THE "SANDWICH" WITHOUT USE OF ADHESIVES.
- 2.14 AUTOMATIC CONTROL SYSTEM
  - 1. AN INDEPENDENT STATION CONTROLLER: FURNISH A SOLID STATE CONTROLLER, AS SPECIFIED ON THE
    - a. EACH STATION SHALL BE CAPABLE OF TIMING FROM ZERO (0) MINUTE TO 99 MINUTES PER STATION IN ONE (1) MINUTE INCREMENTS.
    - b. EACH STATION SHALL BE CAPABLE OF OPERATING TWO (2) 7VA ELECTRIC VALVE-IN-HEAD
    - c. THE STAND-ALONE CONTROLLER SHALL HAVE TWO (2) POSSIBLE PROGRAMS.
    - d. THE STAND-ALONE CONTROLLER SHALL PROVIDE GLOBAL PERCENTAGE INCREASE/DECREASE (WATER BUDGET) FOR ALL STATIONS SIMULTANEOUSLY, FROM TEN (10) TO TWO HUNDRED (200) PERCENT, IN TEN (10) PERCENT INCREMENTS.
    - e. ALL STATIONS SHALL BE ABLE TO BE TURNED ON/OFF MANUALLY BUY OPERATING TIMING MECHANISM OR BY MANUAL SWITCH AT STATION OUTPUT.
    - f. THE STAND-ALONE CONTROLLER SHALL INCORPORATE AN INTEGRAL MOV SURGE PROTECTION INTO THE TERMINAL BLOCK FOR EACH OF ITS 24 VAC FIELD WIRE OUTPUTS. CONTROLLER POWER INPUT WIRES WILL ALSO INCORPORATE SURGE PROTECTION.
    - g. THE CONTROL PANEL SHALL PROVIDE CONTINUOUS DISPLAY TIME. IT SHALL HAVE ALPHANUMERIC DISPLAYS OF DESCRIPTIVE ENGLISH MENUS AND LEGEND IDENTIFIERS WITH CURSOR SELECTION OF FUNCTION AND PRECISION VALUE ADJUSTMENT BY ROTARY DIAL INPUT.
    - h. THE STAND-ALONE CONTROLLER SHALL BE UL LISTED AND FCC APPROVED.
  - i. THE STAND-ALONE CONTROLLER SHALL HAVE 117 VAC, 60 HZ INPUT, 26.5 VAC, 60 HZ OUTPUT FOR OPERATING 24 VAC SOLENOIDS.
  - j.THE STAND-ALONE CONTROLLER CABINET SHALL BE A LOCKABLE AND WEATHER-RESISTANT OUTDOOR CABINET. MOUNT AS NOTED ON PLANS.
  - k. THE CONTROLLER SHALL BE EQUIPPED WITH LIGHTENING PROTECTION, BY THE CONTRACTOR, ON BOTH THE PRIMARY (120V) AND EACH SECONDARY (24V) CIRCUIT. THE CONTROLLER CIRCUITS SHALL BE GROUNDED TO A COPPER CLAD GROUNDING ROD LOCATED AT EACH CONTROLLER.
  - I. THE CONTROLLER SHALL BE EQUIPPED FOR A WATER CONSERVATION DEVICE. AS SPECIFIED.

## PART III: EXECUTION

## 3.01 INSPECTION

A. THE CONTRACTOR SHALL EXAMINE THE AREAS AND CONDITIONS UNDER WHICH LANDSCAPE IRRIGATION SYSTEM IS TO BE INSTALLED AND NOTIFY THE LANDSCAPE ARCHITECT IN WRITING OF CONDITIONS DETRIMENTAL TO THE PROPER AND TIMELY COMPLETION OF THE WORK. THE CONTRACTOR SHALL PROCEED WITH THE WORK UNTIL UNSATISFACTORY CONDITIONS HAVE BEEN CORRECTED IN A MANNER ACCEPTABLE TO THE LANDSCAPE ARCHITECT.

## 3.02 PREPARATION

A. THE CONTRACTOR SHALL PROVIDE SLEEVES TO ACCOMMODATE PIPING UNDER WALKS OR PAVING. THE CONTRACTOR SHALL COORDINATE WITH OTHER TRADES AND INSTALL TO ACCURATE LEVELS PRIOR TO PAVING WORK. CUTTING AND PATCHING OF PAVING AND CONCRETE WILL NOT BE PERMITTED. THE CONTRACTOR

SHALL MAINTAIN ALL WARNING SIGNS, SHORING, BARRICADES, FLARES AND RED LANTERNS, AS REQUIRED BY ANY LOCAL CODES, ORDINANCES OR PERMITS.

#### 3.03 TRENCHING AND BACKFILLING

A. EXCAVATION: THE CONTRACTOR SHALL STAKE OUT THE LOCATION OF EACH RUN OF PIPE, SPRINKLER HEADS, SPRINKLER VALVES AND ISOLATION VALVES PRIOR TO TRENCHING. EXCAVATION SHALL BE OPEN VERTICAL CONSTRUCTION SUFFICIENTLY WIDE TO PROVIDE FREE WORKING SPACE AROUND THE WORK INSTALLED AND TO PROVIDE AMPLE SPACE OR BACKFILLING AND TAMPING. TRENCHES FOR PIPE SHALL BE CUT TO REQUIRED GRADE LINES, AND COMPACTED TO PROVIDE ACCURATE GRADE AND UNIFORM BEARING FOR THE FULL LENGTH OF THE LINE. THE BOTTOM OF THE TRENCHES SHALL BE FREE OF ROCK OR OTHER SHARP EDGED OBJECTS. MINIMUM COVER SHALL BE AS FOLLOWS:

#### PIPE AND WIRE DEPTH

18" AT TOP OF PIPE FROM FINISH GRADE PRESSURE MAINLINE 12" AT TOP OF PIPE FROM FINISH GRADE LATERAL PIPING (ROTOR) LATERAL PIPING (POP-UP) 12" AT TOP OF PIPE FROM FINISH GRADE CONTROL WIRING SIDE OF MAIN LINE

B. MINIMUM CLEARANCES: ALL PIPELINES SHALL HAVE A MINIMUM CLEARANCE OF SIX INCHES FROM EACH OTHER AND FROM LINES OF OTHER CRAFTS. PARALLEL LINES SHALL NOT BE INSTALLED DIRECTLY OVER ONE ANOTHER. NO LATERAL LINE SHALL BE INSTALLED IN THE MAIN-LINE TRENCH

#### 3.04 INSTALLATION OF PIPING

- A. PVC PIPE AND JOINTS: THE CONTRACTOR SHALL NOT INSTALL SOLVENT WILD PIPE WHEN AIR TEMPERATURE IS BELOW 40Ø F. INSTALLATION SHALL BE IN ACCORDANCE WITH THE MANUFACTURER'S INSTRUCTIONS.
  - 1. ONLY THE SOLVENT RECOMMENDED BY THE PIPE MANUFACTURER SHALL BE USED. ALL PVC PIPE AND FITTINGS SHALL BE INSTALLED AS OUTLINED AND INSTRUCTED BY THE PIPE MANUFACTURER, AND IT SHALL BE THE CONTRACTOR'S FULL RESPONSIBILITY TO MAKE ARRANGEMENTS WITH THE PIPE MANUFACTURER FOR ANY FIELD ASSISTANCE THAT MAY BE NECESSARY. THE CONTRACTOR SHALL ASSUME FULL RESPONSIBILITY FOR THE CORRECT INSTALLATION.

#### 3.05 BACKFILLING PROCEDURES

INITIAL BACKFILL ON PVC LINES SHALL BE PULVERIZED NATIVE SOIL, FREE OF FOREIGN MATTER. WITHIN RADIUS OF 4" OF THE PIPE SHALL BE CLEAN SOIL OR SAND. PLANT LOCATIONS SHALL TAKE PRECEDENCE OVER SPRINKLER AND PIPE THREADS, NON-RISING STEM WITH WHEEL OPERATING HANDLE, FOR A CONTINUOUS WORKING PRESSURE OF LOCATIONS. THE CONTRACTOR SHALL COORDINATE THE LOCATION OF TREES AND SHRUBS WITH THE ROUTING OF LINES AND FINAL HEAD LOCATIONS.

- A. BACKFILL AND COMPACTION: THE CONTRACTOR SHALL LEAVE TRENCHES SLIGHTLY MOUNDED TO ALLOW FOR SETTLEMENT AFTER THE BACKFILLING IS COMPLETED. THE CONTRACTOR SHALL CLEAN THE SITE OF THE WORK CONTINUOUSLY OF EXCESS WASTE MATERIALS AS THE BACKFILLING PROGRESSES, AND LEAVE IN A NEAT CONDITION. NO TRENCHES SHALL BE LEFT OPEN FOR A PERIOD OF MORE THAN 48 HOURS. PROTECT OPEN TRENCHES AS REQUIRED.
  - 1. THE CONTRACTOR SHALL CAREFULLY BACKFILL EXCAVATED MATERIALS APPROVED FOR BACKFILLING, CONSISTING OF EARTH, LOAM, SAND, AND OTHER APPROVED MATERIALS, FREE OF ROCK AND DEBRIS OVER 1" IN SIZE. BACKFILL SHALL BE COMPACTED TO ORIGINAL DENSITY OF SURROUNDING SOIL WITHOUT DIPS, SUNKEN AREAS, OR IRREGULARITIES.
  - PERCENTAGES, FOR ROADS AND PAVING. 3. THE CONTRACTOR SHALL HAND PLACE THE FIRST 6" OF BACKFILL (OR TO TOP OF PIPE) AND HAVE IT WALKED

2. THE CONTRACTOR SHALL CONFORM TO DOT REQUIREMENTS FOR METHODS AND REQUIRED COMPACTION

- ON SO AS TO SECURE THE POSITION OF THE PIPE AND WIRE. 4. NO WHEEL ROLLING WILL BE ALLOWED. THE CONTRACTOR SHALL REMOVE ROCK OR DEBRIS EXTRACTED FROM BACKFILL MATERIALS AND DISPOSE OF OFFSITE. THE CONTRACTOR SHALL FILL ANY VOIDS LEFT IN BACKFILL WITH APPROVED BACKFILL MATERIALS.
- B. EXISTING LAWNS: WHERE TRENCHING IS REQUIRED ACROSS EXISTING LAWNS, UNIFORMLY CUT STRIPS OF SOD 6" WIDER THAN TRENCH. THE CONTRACTOR SHALL REMOVE SOD IN ROLLS OF SUITABLE SIZE FOR HANDLING AND KEEP MOISTENED UNTIL REPLANTED. THE CONTRACTOR SHALL REPLANT SOD WITHIN 48 HOURS AFTER REMOVAL, ROLL AND WATER GENEROUSLY. THE CONTRACTOR SHALL RESOD ANY AREAS NOT IN HEALTHY CONDITION EQUAL TO ADJOINING LAWNS 10 DAYS AFTER REPLANTING.
- SEEDED AREA: TRENCHING WILL BE REQUIRED ACROSS EXISTING SEEDED AREAS, PRIMARILY ROADWAY EDGING. THE CONTRACTOR SHALL CONFORM TO THE REQUIREMENTS OF SEEDING, SECTION 02930 FOR THE
- RESEEDING OF THE DISTURBED TRENCH AREA. PAVEMENTS: JACK AND BORE OR DIRECTIONAL BORE PIPING UNDER PAVING MATERIALS AS PER LOCAL

#### REGULATORY CODES. NO CUTTING AND PATCHING OF PAVEMENT WILL BE PERMITTED. 3.06 VALVES

- A. ISOLATION VALVES: SHALL BE SIZED CORRESPONDING TO ADJACENT PIPE SIZE. SPECIFIED VALVE BOXES SHALL BE INSTALLED FLUSH WITH FINISH GRADE IN SUCH A MANNER THAT SURFACE FORCES APPLIED TO THEIR EXPOSED AREA WILL NOT BE TRANSMITTED TO THE PIPING IN WHICH THE VALVE IS INSTALLED NOR ANY OTHER PIPING, WIRING OR OTHER LINES IN THE VICINITY OF SAID VALVES.

SLEEVING WITH THE GENERAL SITE CONTRACTOR.

ZONES WILL BE LABELED ON THE CONTROLLER.

TECHDEL GT-3-GEL - TITE CONNECTORS OR EQUAL.

B. GATE VALVES: INSTALL WHERE SHOWN, IN VALVE BOXES. C. ELECTRIC CONTROL VALVES: SHALL BE INSTALLED IN SPECIFIED VALVE BOXES. THE VALVE SHALL HAVE 6" OF 3/4" PEA GRAVEL INSTALLED BELOW THE BOTTOM OF THE VALVE. IF THE VALVE BOX DOES NOT EXTEND TO THE BASE OF THE VALVE, A VALVE BOX EXTENSION SHALL BE INSTALLED. ELECTRIC CONTROL VALVES SHALL BE INSTALLED WHERE SHOWN AND GROUPED TOGETHER WHERE PRACTICAL. THE CONTRACTOR SHALL PLACE NO CLOSER THAN 24" TO WALK EDGES, BIKEWAY EDGES, BUILDINGS AND WALLS. THE CONTRACTOR SHALL ADJUST THE VALVE TO PROVIDE FLOW RATE OR RATED OPERATING PRESSURE REQUIRED FOR EACH SPRINKLER

# 3.07 CONDUIT AND SLEEVES

- A. CONDUIT AND SLEEVES FOR CONTROL WIRING AND MAIN/LATERAL PIPE: THE CONTRACTOR SHALL PROVIDE AND INSTALL WHERE NECESSARY. CONTRACTOR SHALL COORDINATE LOCATIONS OF PREVIOUSLY INSTALLED
- 1. THE CONTRACTOR SHALL COORDINATE INSTALLATION OF SLEEVES WITH WORK OF OTHER DISCIPLINES.
- 3.08 CONTROLS A. THE CONTRACTOR SHALL CONNECT ELECTRIC CONTROL VALVES TO CONTROLLERS IN A CLOCKWISE SEQUENCE TO CORRESPOND WITH STATION SETTINGS BEGINNING WITH STATIONS 1, 2, 3, ETC. AUTOMATIC CONTROLLERS SHALL BE PROVIDED AND INSTALLED BY THE CONTRACTOR AS NOTED ON THE DRAWINGS. ALL
- B. CONTROLLERS SHALL BE EQUIPPED WITH LIGHTNING PROTECTION AND GROUNDED TO A STANDARD 5/8" COPPER CLAD STEEL GROUND ROD DRIVEN A MINIMUM OF 8' INTO THE GROUND AND CLAMPED.
- C. THE ELECTRICAL SERVICE TO THE CONTROLLERS SHALL BE PERFORMED BY AN ELECTRICAL SUBCONTRACTOR IN COMPLIANCE WITH NEC REQUIREMENTS.

# 3.09 CONTROL WIRE

- CONTROL WIRING BETWEEN THE CONTROLLER AND ELECTRIC VALVES SHALL BE BURIED IN MAIN LINE TRENCHES OR IN SEPARATE TRENCHES. ELECTRICAL CONNECTION AT VALVE WILL ALLOW FOR PIGTAIL SO SOLENOID CAN BE REMOVED FROM VALVE WITH SUFFICIENT SLACK TO ALLOW ENDS TO BE PULLED 12" ABOVE GROUND FOR EXAMINATION AND CLEANING.
- B. AN EXPANSION LOOP SHALL BE PROVIDED AT EVERY VALVE AT 100' O.C. EXPANSION LOOP SHALL BE FORMED BY WRAPPING WIRE AT LEAST EIGHT TIMES AROUND A 3/4" PIPE AND WITHDRAWING PIPE.
- C. THE WIRE SHALL BE BUNDLED AND TAPED EVERY TEN FEET. THE WIRE SHALL BE LAID IN THE TRENCH PRIOR TO INSTALLING THE PIPE BEING CAREFUL TO INSTALL WIRE BENEATH AND 6" TO THE SIDE OF THE MAIN PIPE LINE. D. ELECTRICAL CONNECTIONS TO ELECTRIC CONTROL VALVES SHALL BE MADE WITH RAINBIRD PEN-TITE OR
  - a. POWER CONNECTIONS: ELECTRICAL CONNECTIONS TO POWER AND SIGNAL WIRES SHALL BE MADE USING 3M 82-A2 POWER CABLE SPLICE KITS

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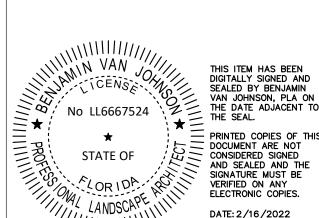
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### GENERAL IRRIGATION SPECIFICATIONS AND NOTES CONTINUED

#### UNDERGROUND IRRIGATION SYSTEM

PART III: EXECUTION

#### 3.10 SPRINKLER HEADS

- A. GENERAL PROVISIONS:
- 1. SPRINKLER HEADS SHALL BE INSTALLED AS DESIGNATED ON THE SHOP DRAWINGS. HEADS SHALL BE INSTALLED ON FLEXIBLE PVC. TOP TO BE FLUSH WITH FINISH GRADE OR TOP OF CURB.
- 2. SPACING OF HEADS SHALL NOT EXCEED THE MAXIMUM INDICATED ON THE SHOP DRAWINGS (UNLESS DIRECTED BY THE LANDSCAPE ARCHITECT). IN NO CASE SHALL THE SPACING EXCEED THE MAXIMUM RECOMMENDED BY THE MANUFACTURER.
- B. HEAD TYPES:
- 1. POP-UP- ROTARY SPRINKLER HEADS: SHALL BE INSTALLED ON FLEX JOINT AND BE SET WITH TOP OF HEAD FLUSH WITH FINISH GRADE. HEADS INSTALLED AT CURB SHALL HAVE 6" TO 10" BETWEEN PERIMETER OF HEAD AND CONCRETE. HEADS PLACED AT EDGE OF PAVEMENT HAVING NO CURB SHALL BE INSTALLED 24" FROM EDGE OF PAVEMENT.
- 2. SPRAY POP-UP SPRINKLER HEADS: SHALL BE INSTALLED ON FLEXIBLE PVC AND BE SET WITH TOP OF HEAD FLUSH WITH FINISHED GRADE. SPRINKLER HEADS PLACED ADJACENT TO CURBS WILL BE INSTALLED 9" FROM CONCRETE. SPRINKLER HEADS PLACED ADJACENT TO PAVEMENT HAVING NO CURB SHALL BE INSTALLED 24" FROM THE EDGE OF PAVEMENT.

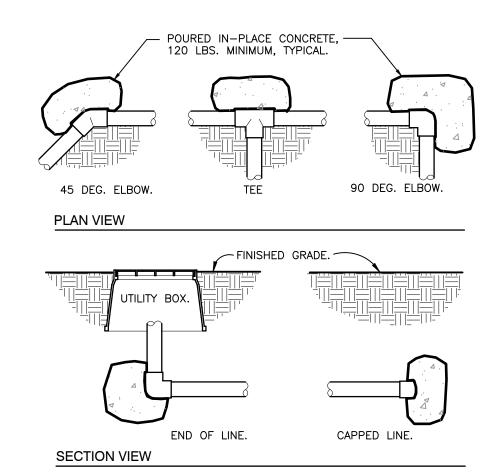
#### 3.11 COMPLETION

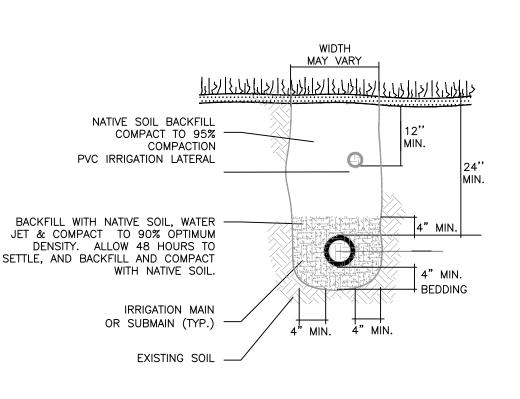
- A. FLUSHING: BEFORE SPRINKLER HEADS ARE SET, THE CONTRACTOR SHALL FLUSH THE LINES THOROUGHLY TO MAKE SURE THERE IS NO FOREIGN MATTER IN THE LINES.
- 1. THE CONTRACTOR SHALL FLUSH THE MAIN LINES FROM DEAD END FITTINGS FOR A MINIMUM OF FIVE MINUTES UNDER A FULL HEAD OF PRESSURE.
- B. TESTING: THE CONTRACTOR SHALL NOTIFY LANDSCAPE ARCHITECT AND OWNER FORTY-EIGHT (48) HOURS IN ADVANCE OF TESTING.
- 1. PRIOR TO BACKFILLING OF MAIN LINE FITTINGS, CONTRACTOR SHALL FILL THE MAIN LINE PIPING WITH WATER, IN THE PRESENCE OF THE OWNER/LANDSCAPE ARCHITECT, TAKING CARE TO PURGE THE AIR FROM IT BY OPERATING ALL THE SPRINKLER CONTROL VALVES ONE OR MORE TIMES AND/OR SUCH OTHER MEANS AS MAY BE NECESSARY. A SMALL, HIGH PRESSURE PUMP OR OTHER MEANS OF MAINTAINING A CONTINUOUS WATER SUPPLY SHALL BE CONNECTED TO THE MAIN LINE AND SET SO AS TO MAINTAIN 100 PSI IN THE MAIN LINE SYSTEM FOR TWO (2) HOURS WITHOUT INTERRUPTION. WHEN THIS HAS BEEN ACCOMPLISHED AND WHILE THE PRESSURE IN THE SYSTEM IS STILL 100 PSI, LEAKAGE TESTING SHALL BE PERFORMED IN ACCORDANCE WITH AWWA STANDARD C-600. PRESSURE READINGS SHALL BE NOTED AND MAKE UP WATER USAGE SHALL BE RECORDED. SHOULD THE RATE OF MAKE UP WATER USAGE INDICATE SIGNIFICANT LEAKAGE, THE SOURCE OF SUCH LEAKAGE SHALL BE FOUND AND CORRECTED AND THE SYSTEM THEN RETESTED UNTIL THE OWNER/LANDSCAPE ARCHITECT IS SATISFIED THAT THE SYSTEM IS REASONABLY SOUND. LATERAL LINE TESTING SHALL BE CONDUCTED DURING THE OPERATING TESTING OF THE SYSTEM BY CHECKING VISUALLY THE GROUND SURFACE UNTIL NO LEAKS IN THIS PORTION OF THE SYSTEM ARE EVIDENT. LEAKS SHALL BE REPAIRED OR PAID FOR BY THE CONTRACTOR AT ANY TIME THEY APPEAR DURING THE WARRANTY PERIOD.
- 2. ADJUSTMENT AND COVERAGE OF SYSTEM: COORDINATE PRESSURE TESTING WITH ADJUSTMENTS AND COVERAGE TEST OF SYSTEM SO BOTH MAY OCCUR AT THE SAME TIME. THE CONTRACTOR SHALL BALANCE AND ADJUST THE VARIOUS COMPONENTS OF THE SYSTEM SO THAT THE OVERALL OPERATION OF THE SYSTEM IS MOST EFFICIENT. THIS INCLUDES A SYNCHRONIZATION OF THE CONTROLLERS, ADJUSTMENTS TO PRESSURE REGULATORS, PRESSURE RELIEF VALVES, PART CIRCLE SPRINKLER HEADS, AND INDIVIDUAL STATION ADJUSTMENTS ON THE CONTROLLERS.

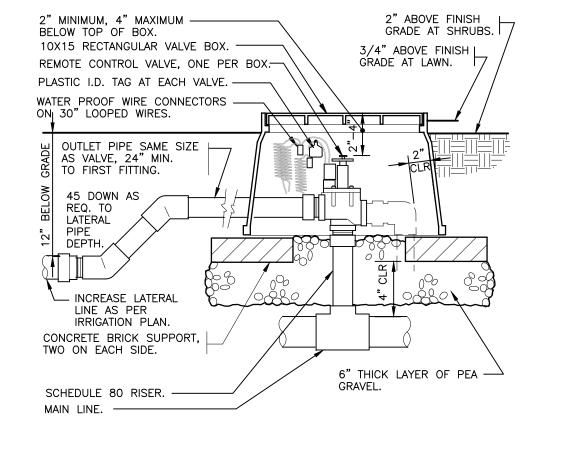
### 3.12 WARRANTY

LANDSCAPE ARCHITECT.

- A. THE CONTRACTOR SHALL FULLY WARRANT THE LANDSCAPE IRRIGATION SYSTEM FOR A PERIOD OF ONE (1) YEAR AFTER THE WRITTEN FINAL ACCEPTANCE AND WILL RECEIVE A WRITTEN CONFIRMATION FROM THE LANDSCAPE ARCHITECT THAT THE WARRANTY PERIOD IS IN EFFECT.
- B. DURING THE WARRANTY PERIOD, THE CONTRACTOR WILL ENFORCE ALL MANUFACTURER'S AND SUPPLIER'S WARRANTIES AS IF MADE BY THE CONTRACTOR HIMSELF. ANY MALFUNCTIONS, DEFICIENCIES, BREAKS, DAMAGES, DISREPAIR, OR OTHER DISORDER DUE TO MATERIALS, WORKMANSHIP, OR INSTALLATION BY THE CONTRACTOR AND HIS SUPPLIERS SHALL BE IMMEDIATELY AND PROPERLY CORRECTED TO THE PROPER ORDER AS DIRECTED BY THE OWNER AND/OR
- C. ANY DAMAGES CAUSED BY SYSTEM MALFUNCTION SHALL BE THE RESPONSIBILITY OF THE CONTRACTOR WHO SHALL MAKE FULL AND IMMEDIATE RESTORATION FOR SAID DAMAGES.












ELECTRIC REMOTE CONTROL VALVE

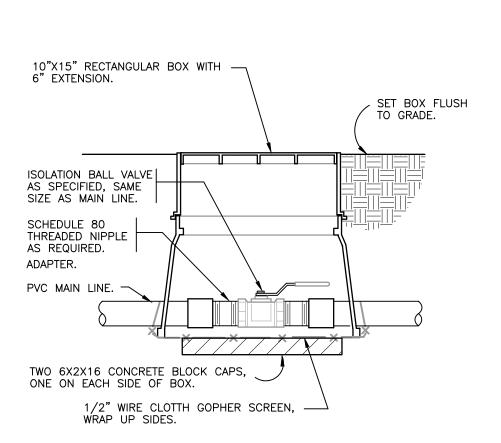


TO CURB OR

WALK.

1/2" POLYETHYLENE FLEXIBLE

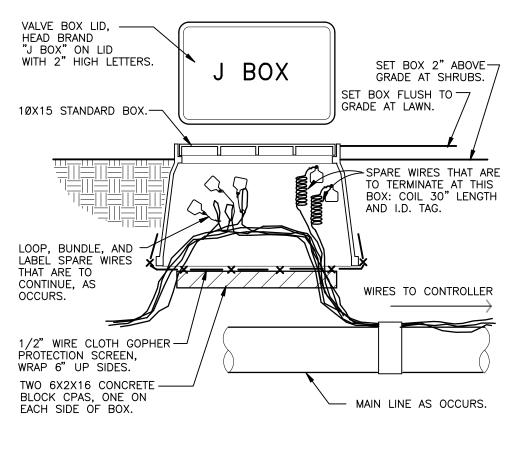TÚBING, LENGTH AS REQUIRED.



FENCE OR WALL.

WALK.

- PVC THREAD THREAD

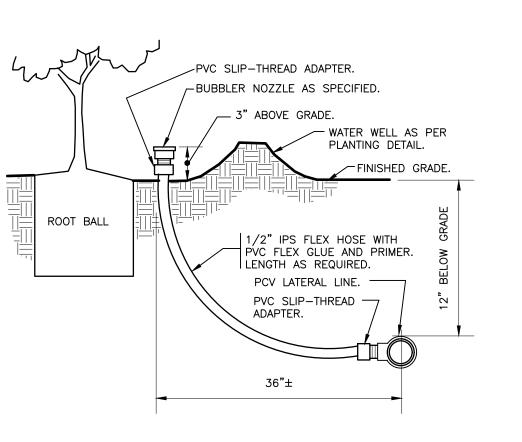
PVC SLIP THREAD ELL.

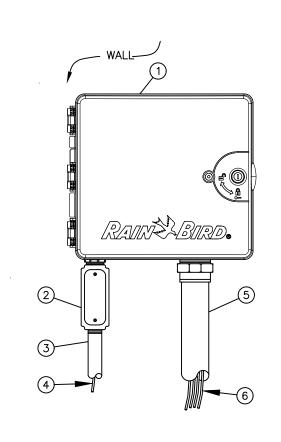
COUPLER.

- KBI FR-500-4

4" FLEX RISER.

NIPPLE AS REQUIRED.





- (1) IRRIGATION CONTROLLER: RAIN BIRD ESP-LXME CONTROLLER IN PLASTIC CABINET WITH WALL MOUNT. INSTALL CONTROLLER AND CABINET ON WALL PER MANUFACTURER'S RECOMMENDATIONS.
- (3) JUNCTION BOX
- (4) 1-INCH CONDUIT AND FITTINGS TO POWER SUPPLY
- (5) POWER SUPPLY WIRE
- (6) 2-INCH CONDUIT AND FITTINGS FOR STATION WIRES WIRES TO REMOTE CONTROL VALVES
- 1. ESP-LXMEF CONTROLLER IS AVAILABLE IN 8- OR 12-STATION BASE MODELS. ADDITIONAL MODULES IN 4-, 8- AND 12-STATION VERSIONS MAY BE ADDED TO BRING THE CONTROLLER UP TO 48 STATIONS
- MAXIMUM. 2. FOR EASE OF INSTALLATION INTO A CONTROLLER WITH MORE THAN 24 STATIONS, INSTALL A JUNCTION BOX AT THE BASE OF CONTROLLER AND TRANSITION LARGER VALVE AND COMMON WIRES FROM FIELD TO 18 AWG MULTI CONDUCTOR WIRE TO BE USED IN CONTROLLER.
- 3. USE STEEL CONDUIT FOR ABOVE GRADE AND SCH 40 PVC CONDUIT FOR BELOW GRADE CONDITIONS. 3. PROVIDE PROPER GROUNDING COMPONENTS TO ACHIEVE GROUND RESISTANCE OF 10 OHMS OR LESS.





SHRUB NOZZLE .-

PVC SCH 80 -RISER. PAINT FLAT BLACK.

RISER STRAIGHT

LINE.

OFF OF LATERAL

WHERE OCCURS.



-FINISH GRADE

- PVC SCH 40 ELL

- ROTOR POP-UP SPRINKLER: RAIN BIRD FALCON 6504 F4-FC/PC

PVC SCH 80 NIPPLE (LENGTH AS REQUIRED)

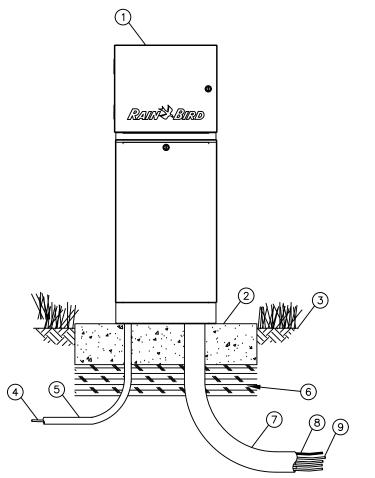
- PVC SCH 40 STREET ELL

RVC SCH 40 STREET ELL

- PVC SCH 40 TEE OR ELL

- PVC LATERAL PIPE





- (1) IRRIGATION CONTROLLER: RAIN BIRD ESP-LXMEF CONTROLLER WITH FLOW SMART MODULE IN LXMM METAL CABINET AND LXMMPED METAL PEDESTAL. INSTALL CONTROLLER, CABINET AND PEDESTAL PER MANUFACTURER'S RECOMMENDATIONS.
- 2 CONCRETE PAD: 6-INCH MINIMUM THICKNESS
- (3) FINISH GRADE
- (4) POWER SUPPLY WIRE
- (5) 1-INCH SCH 40 PVC CONDUIT, FITTINGS AND SWEEP ELL FOR POWER SUPPLY
- (6) COMPACTED SUBGRADE
- (7) 3-INCH SCH 40 PVC CONDUIT, FITTINGS AND SWEEP ELL FOR STATION WIRES
- (8) FLOW SENSOR WIRE (PE 39, 89 OR 54) TO FLOW SENSOR (9) MASTER VALVE AND REMOTE CONTROL VALVE WIRES

1. ESP-LXMEF CONTROLLER IS AVAILABLE IN 8- OR 12-STATION BASE MODELS. ADDITIONAL MODULES IN 4-, 8- AND 12-STATION VERSIONS MAY BE ADDED TO BRING THE CONTROLLER UP TO 48 STATIONS MAXIMUM 2. FOR EASE OF INSTALLATION INTO A CONTROLLER WITH MORE THAN 24 STATIONS, INSTALL A JUNCTION BOX AT THE BASE OF CONTROLLER AND TRANSITION LARGER VALVE AND COMMON WIRES FROM FIELD TO 18 AWG MULTI CONDUCTOR WIRE TO BE USED IN CONTROLLER 3. PROVIDE PROPER GROUNDING COMPONENTS TO ACHIEVE

GROUND RESISTANCE OF 10 OHMS OR LESS.

POP-UP SPRAY FLEX ASSEMBLY

- PVC TEE (SXSXT)

POP UP HEAD.

BARB ELL X MIPT.

1/2" MARLEX

STREET ELL.

- LATERAL LINE.

1/2" MARLEX STREET ELL. -

SHRUB SPRAY FIXED RISER

ROTOR POP UP SPRINKLER

ESP-LXMEF CONTROLLER IN STAINLESS STEEL PEDESTAL - LXMMS SPED

Raising Cane's Restaurant #0855 8070 NW 36th Street Doral, FL 33166 CUSTOM [A]

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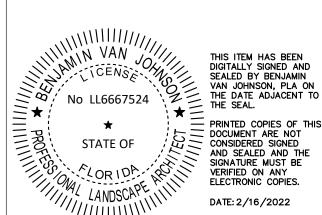
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MRF CSRS Project Manager:

11-19-2021

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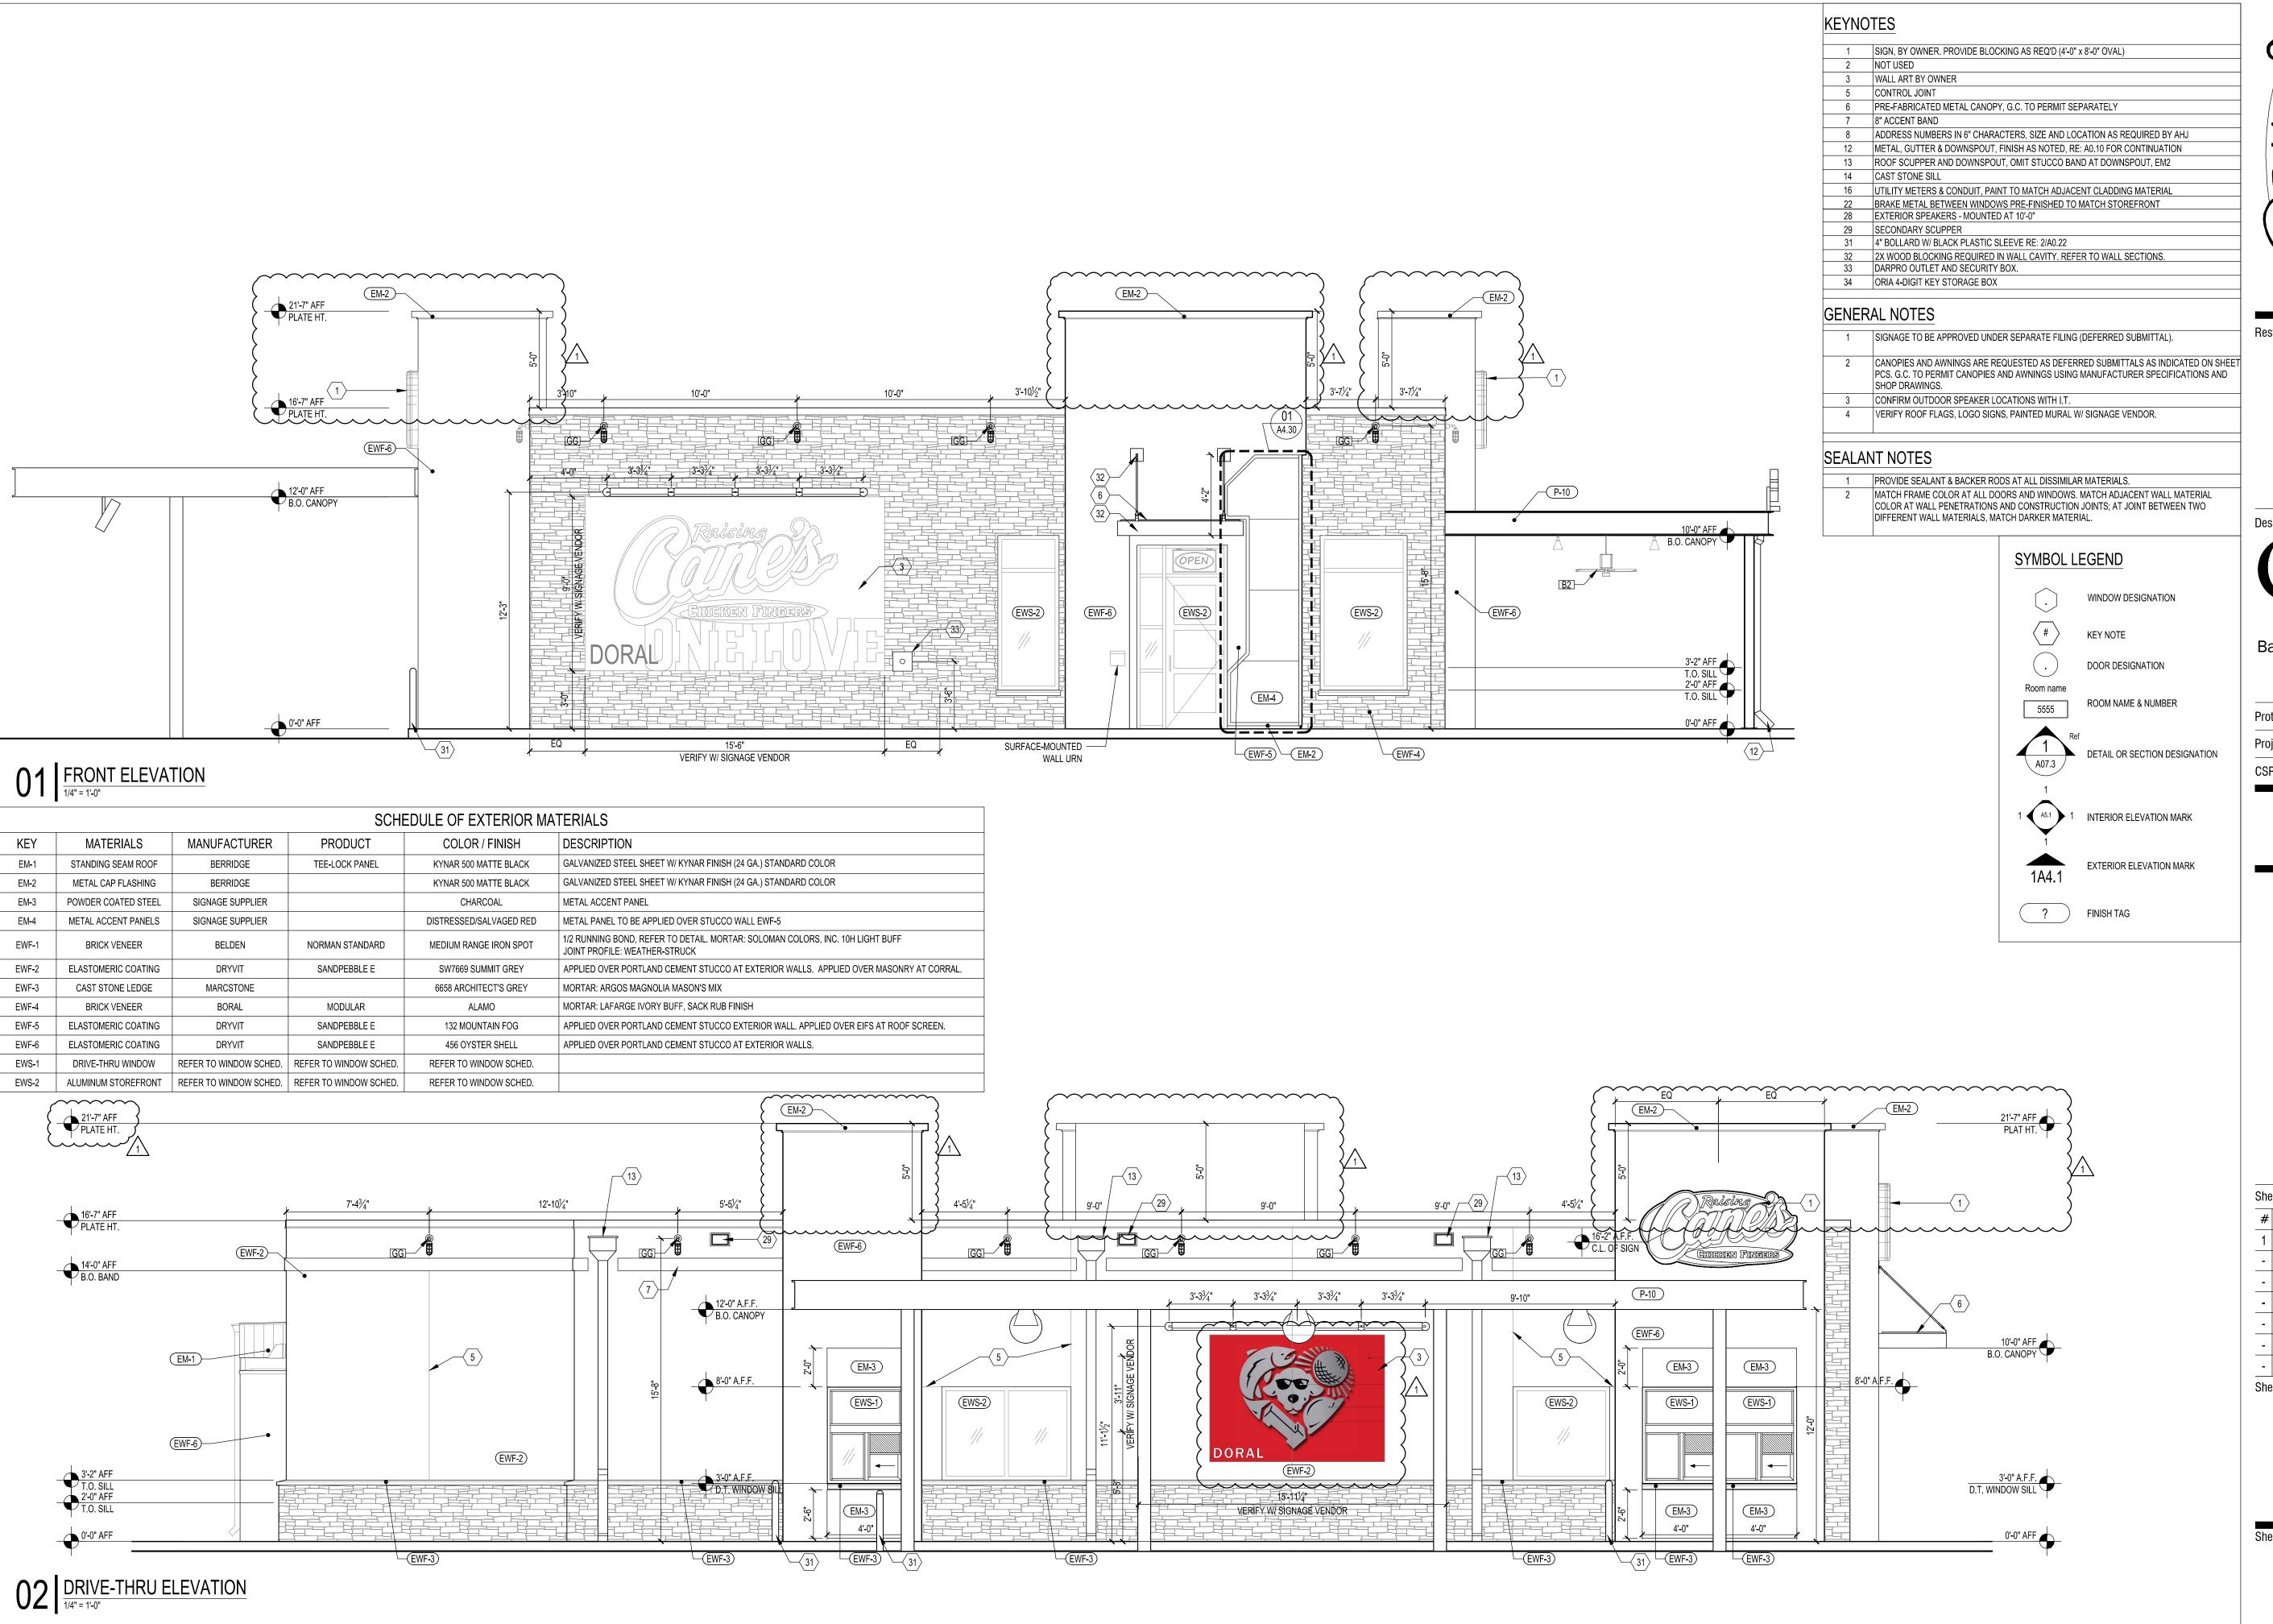


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**IRRIGATION NOTES** AND DETAILS

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CHICKEN FINGERS

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6800 Bishop Road, Plano, TX 75024

Tele: 972-769-3101

Restaurant:

Raising Cane's
Restaurant #0855
8070 NW 36th Street
Doral, FL 33166
CUSTOM [A]

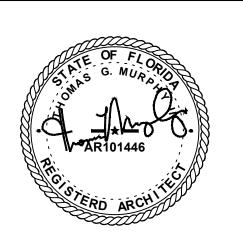
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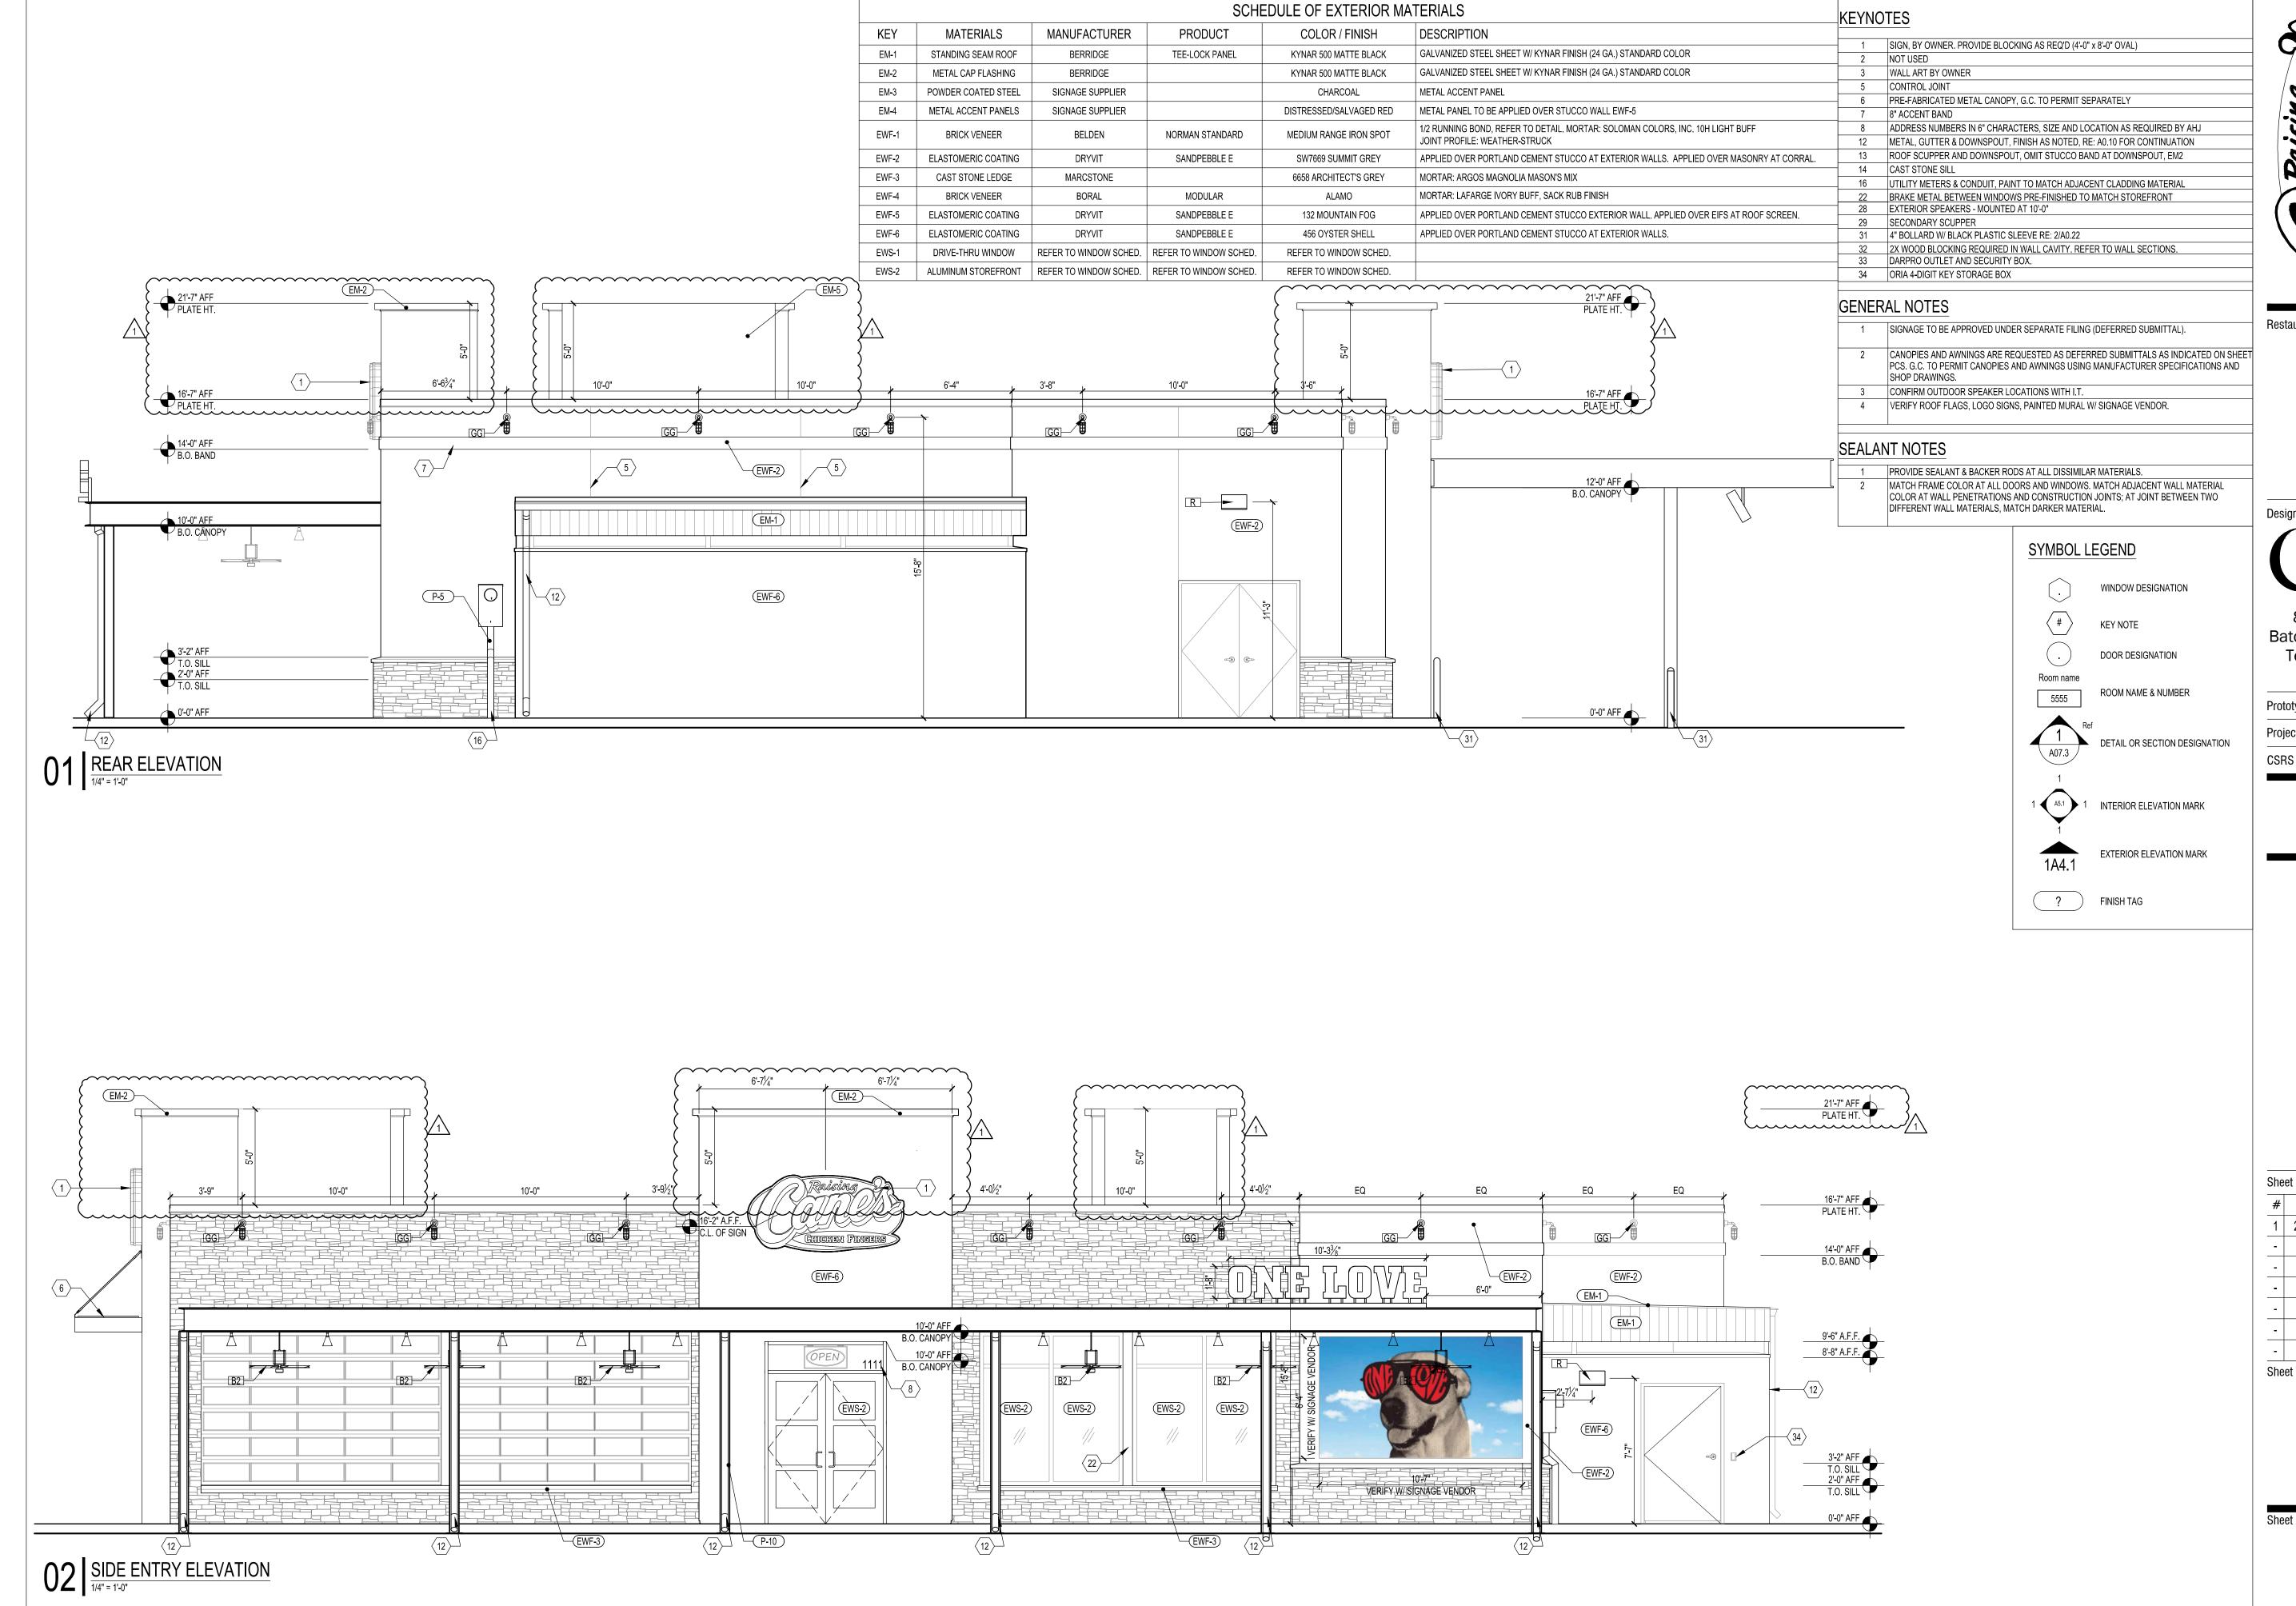


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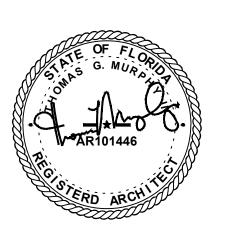
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