#### **RESOLUTION No. 23-40**

A RESOLUTION OF THE MAYOR AND THE CITY COUNCIL OF THE CITY OF DORAL, FLORIDA, APPROVING THE SITE PLAN MODIFICATION FOR EWE WAREHOUSE INVESTMENTS XXXII, LTD. FOR THE PROPERTY LOCATED AT 2525 NW 82 AVENUE, PURSUANT TO SECTION 53-184(F) OF THE CITY'S LAND DEVELOPMENT CODE; AND PROVIDING FOR AN EFFECTIVE DATE

WHEREAS, Article III of Chapter 53 of the Land Development Code of the City of Doral ("City") establishes procedures for Mayor and City Council site plan review and approval; and

WHEREAS, EWE Warehouse Investments XXXII, Ltd. (the "Applicant") is seeking approval to modify a previously approved administrative site plan dated September 2, 2015, subsequently amended by several minor administrative site plan modifications on December 24, 2015, May 25, 2016, August 25, 2016, March 15, 2017, and October 17, 2017 ("Application"), for Legacy at Doral, located at 2525 NW 82 Avenue, further identified by folio number 35-3027-024-0010, as legally described in "Exhibit A" (the "Project"); and

WHEREAS, a zoning workshop was held on September 8, 2022, during which the public was afforded an opportunity to examine the Project and provide feedback; and

WHEREAS, City staff finds that the proposed site plan modification, attached hereto as "Exhibit B," complies with the requirements and standards of the City's Land Development Code and Comprehensive Plan; and

WHEREAS, after notice of public hearing duly published and notifications of all property owners of record within 500-foot radius, a public hearing was held before the Mayor and City Council on March 22, 2023, during which all interested persons were afforded the

opportunity to be heard, and due and proper consideration was given to the matter, including the recommendations contained in the City's Planning and Zoning Staff Report; and

WHEREAS, the City Council reviewed the application for site plan modification, the written and oral recommendations of the Planning and Zoning Department, including the recommended conditions, and hereby finds competent substantial evidence to support a showing by the Applicant that the request for an approval for a site plan modification is in compliance with the City's Land Development Regulations and the Comprehensive Plan, and maintains the basic intent and purpose of the zoning, subdivision or other land use regulations, which is to protect the general welfare of the public, and further finds that the site plan modification application should be granted, subject to the conditions described herein.

NOW, THEREFORE, BE IT RESOLVED BY THE MAYOR AND THE CITY COUNCIL OF THE CITY OF DORAL, FLORIDA, AS FOLLOWS:

<u>Section 1.</u> Recitals. The foregoing recitals are confirmed, adopted, and incorporated herein and made as part hereof by this reference.

Section 2. Findings and Conclusions. Based upon an analysis of the site plan modification application and the standards for approval of a site plan modification under the City's Land Development Regulations, the City Council hereby finds and concludes that the Applicant's request for a site plan modification of the previously approved administrative site plan dated September 2, 2015, subsequently amended by several minor administrative site plan modifications on December 24, 2015, May 25, 2016, August 25, 2016, March 15, 2017, and October 17, 2017, as more particularly set forth in "Exhibit B," is in compliance with the Comprehensive Plan and the Land Development

Regulations of the City, and there is substantial competent evidence to support approval of the Application.

Section 3. Approval. The Mayor and City Council hereby approve the site plan modification for Legacy at Doral for the property located at 2525 NW 82 Avenue, further identified by folio number 35-3027-024-0010, as legally described in "Exhibit A," and as more specifically detailed in "Exhibit B." The site plan modification consists of a six (6) story residential building consisting of 185 dwelling units and parking structure. A copy of the site plan is provided in "Exhibit B." The approval of the site plan modification is subject to the following conditions:

- 1. The Project shall be built in substantial compliance with the plans entitled "Legacy at Doral," prepared by Corwil Architects, dated stamped received March 6, 2023.
- 2. The Project shall be landscaped in accordance with the landscape plan, prepared by Witkin Hults + Partners, dated stamped received March 6, 2023 as amended, and included with the site plan submittal.
- 3. All conditions and approvals enumerated under the original administrative site plan approval dated September 2, 2015, subsequently amended by the minor administrative site plan modifications dated December 24, 2015, May 25, 2016, August 25, 2016, March 15, 2017, October 17, 2017, shall remain in effect, unless modified or deleted as part of the Application and set forth herein.
- 4. That the Applicant shall provide a perpetual public access easement in recordable form acceptable to the Planning and Zoning Director and acceptable to the City Attorney within 90 days of the approval of the Application, which proffers a 1.5 foot non-exclusive public access easement located within the Property's west property line, immediately east of the City's right of way, along NW 82 Avenue, that shall be fully accessible to the public on a 24 hour basis ("Easement"). The maintenance of the Easement shall be the responsibility of the City. The Easement shall provide that subject to the limitations set forth in Chapter 768, Florida Statutes, the City shall indemnify and hold the Applicant harmless from any and all liability which may arise from the general public's use of the Easement, except to the extent arising from negligence or willful misconduct by the Applicant.

Res. No. 23-40 Page **4** of **7** 

Applicant shall ensure that the easement is open and accessible to the public at all times.

- No later than one (1) year after the issuance of the certificate of occupancy 5. for the residential building, the Applicant shall install/construct high-visibility crosswalk markings along the north, east-west leg, and on the west, northsouth leg of the intersection of NW 82 Avenue and NW 25 Street, and install corresponding pedestrian signals (collectively the "Improvements"), pursuant to section 77-47, "Intersection Improvements" of the City's Land Development Code. The obligation to install/construct the Improvements shall be subject to review and approval by i) the City of Doral Public Works Department, ii) Miami-Dade County Department of Transportation & Public Works (DTPW), (iii) Florida Department of Transportation (FDOT) and iv) other applicable regulatory agency. The Applicant may request no more than two (2) six (6) month extensions to be approved by the City Manager or designee. The Applicant shall have no obligation to perform the improvements if (i) DTPW, FDOT or other applicable regulatory agency does not approve the Improvements, (ii) the Improvements exceed the amount of the Road Impact Fees assessed against the Project, or (iii) the City and/or Miami-Dade County fail to approve a contribution in lieu of credit in the amount of the cost of the Improvements
- 6. That the Applicant submits for review and approval to Miami-Dade County Department of Transportation and Public Works and City of Doral Public Works Department offsite improvement design plans incorporating a raised median with pavement markings along NW 82 Avenue on NW 27 Street, adjacent to the driveway of the proposed development to avoid vehicles from attempting to make a left turn in the southbound direction towards NW 25 Street. Also, install a right turn only or no left turn sign on the median. Truck turning radius must be maintained. Construction and final inspection must be completed prior to issuance of Temporary Certificate of Occupancy or Certificate of Occupancy.
- 7. The Public Works Department recommends conditional approval of the Shared Parking Study subject to satisfactorily addressing the comments below:
  - I. Ensure that a new crosswalk is provided that connects the proposed garage with the existing building to provide a safe area for pedestrians to cross (See Condition 10, herein).
  - II. Ensure that delivery trucks have adequate sight distance through the parking lot.
- 8. That the Applicant comply with the following condition set forth by Miami-Dade County Traffic Engineering Division.
  - I. This application is approved conditionally to the Applicant installing a 6' sidewalk on NW 82 Avenue within the property limits. For the

Res. No. 23-40 Page **5** of **7** 

widening of the northbound receiving lanes on NW 82 Avenue between NW 25 Street and NW 27 Street from one to two lanes, an operational study must be submitted for review and approval.

- 9. That the Applicant provide details of signage and/or parking space markings to identify the visitor parking visitors (46 spaces) inside the parking structure at time of building permit.
- 10. That the Applicant provide pedestrian walkway connection from the parking spaces on the west side of "Existing Building (Phase 2)" to connect with the proposed pedestrian connection path of "Phase 3." Pedestrian walkway connections must be stamped asphalt or concrete, or pavers as they cross the drive aisle.
- 11. That the Applicant comply with Chapter 63, "Green Building Incentives," of the City's Land Development Code at the time of building permit.
- 12. That the Applicant comply with Chapter 75, "Public Arts Program," of the City's Land Development Code at the time of building permit.
- 13. That the Applicant comply with the City's Floodplain Management regulations (Chapter 23, Article II, Floodplain Management) of the City's Code.
- 14. That the Applicant provide the City a certified drainage inspection report prior to the issuance of a certificate of occupancy.
- 15. That the property owner shall maintain the landscaping in the adjacent public rights-of-way to the Property in accordance with Ordinance No. 2021-09, including the "Addapave" material within the 8'x8' tree planter. In the event that the Addapave is replaced with other landscape material, the Applicant shall be required to maintain such material.
- 16. A Stormwater Pollution Prevention Plan (SWPPP) must be submitted by the Applicant at time of building permit. The Plan should provide guidelines for implementing an erosion and sedimentation control program before the site is cleared or graded, including areas where topsoil will be removed and contours of slopes will be cleared. The Plan shall also include location and type of erosion control measures, stormwater and sediment management systems, and a vegetative plan for temporary and permanent stabilization. The Plan shall remain on-site for the duration of the construction activity.
- 17. If more than one (1) acre of land is disturbed during construction the Contractor/Developer is responsible to obtain NPDES Stormwater permit coverage through the Florida Department of Environmental Protection (FDEP), Construction Generic Permit (CGP). If the project is less than one

Res. No. 23-40 Page **6** of **7** 

- (1) acre, but part of a larger common plan of development or sale that will ultimately disturb one or more acres, permit coverage is also required. Instruction to request and obtain a CGP can be found at: http://www.dep.state.fl.us/water/stormwater/npdes/docs/cgp.pdf.
  Contractor/Developer should submit the Notice of Intent (NOI) with the appropriate processing fees to the NPDES Stormwater Notices Center. Contractor/Developer must apply for permit coverage at least two (2) days before construction begins.
- 18. Construction shall be permitted only during the hours set forth in Ordinance No. 2011-01 "Noise Ordinance."
- That the Applicant comply with all applicable conditions and requirements of the Miami-Dade County Department of Regulatory and Economic Resources.
- 20. That the Applicant comply with all applicable conditions and requirements of the Miami-Dade County Fire Rescue Department.
- 21. All applicable local, state and federal permits must be obtained before commencement of the development.
- 22. Issuance of this development permit by the City of Doral does not in any way create any right on the part of an Applicant to obtain a permit from a state or federal agency and does not create any liability on the part of the City of Doral for issuance of the permit if the applicant fails to obtain requisite approvals or fulfill the obligations imposed by a state or federal agency or undertakes actions that result in a violation of state or federal law.
- 23. That the Applicant obtains a Certificate of Occupancy and a Certificate of Use from the City upon compliance with all terms and conditions. The Certificate of Occupancy and Certificate of Use shall be subject to cancellation upon violation of any of the conditions.

FAILURE BY THE CITY TO TIMELY ENFORCE ANY OF THE ABOVE CONDITIONS DOES NOT CONSTITUTE A WAIVER OF THE SAME AND IF THE APPLICANT, ITS SUCCESSORS, OR, ASSIGNS, DOES NOT PERFORM SUCH CONDITIONS WITHIN FIVE (5) DAYS AFTER WRITTEN NOTICE, THE CITY RETAINS THE RIGHT TO STOP CONSTRUCTION, IF NECESSARY, UNTIL THAT CONDITION IS MET. THE CITY RESERVES THE RIGHT TO ENFORCE THESE CONDITIONS BY ISSUING A CODE COMPLIANCE CITATION, REVOKING THIS RESOLUTION, AND/OR AVAILING ITSELF OF ANY AND ALL REMEDIES AVAILABLE AT LAW OR IN EQUITY. BY ACTING UNDER THIS APPROVAL, APPLICANT HEREBY CONSENTS TO ALL THESE TERMS AND CONDITIONS.

Section 3. Effective Date. This Resolution shall become effective immediately upon its adoption.

The foregoing Resolution was offered by Councilmember Cabral who moved its adoption.

The motion was seconded by Councilmember Porras and upon being put to a vote, the vote was as follows:

Mayor Christi Fraga Yes
Vice Mayor Rafael Pineyro Yes
Councilwoman Digna Cabral Yes
Councilwoman Maureen Porras Yes

Councilman Oscar Puig-Corve Absent / Excused

PASSED AND ADOPTED this 22 day of March, 2023.

CHRISTI FRAGA, MAYOR

ATTEST:

CONNIE DIAZ, MMC

CITY CLERK

APPROVED AS TO FORM AND LEGAL SUFFICIENCY FOR THE USE AND RELIANCE OF THE CITY OF DORAL ONLY:

EDWARD DION, ESQ. for

NABORS, GIBLIN & NICKERSON, P.A.

INTERIM CITY ATTORNEY

# **EXHIBITS**

### Exhibit "A" Legal Description

Tract "A" of "NORTON TIRE COMPANY", according to the Plat thereof recorded in Plat Book 127, at Page 90, of the Public Records of Dade County, Florida

LESS:

The Westerly 2.00 feet thereof;

AND LESS:

The external area of a circular curve lying within said Tract "A', being concave to the Northeast, having a radius of 25 feet and tangent to a line 2.00 feet East of and parallel to the West Line of said Tract "A", and tangent to the South Line of said Tract "A".



	ARCHITECTURE
SHEET NO.	SHEET NAME
A-0.00	COVER SHEET
A-0.01	AERIAL CONTEXT PLAN
A-0.02	ADJOINING AREA CONTEXT
A-0.03	PHASING DIAGRAM
A-0.04	OPEN SPACE DIAGRAM
A-0.05	BUILDING COVERAGE DIAGRAM
A-0.06	FAR DIAGRAMS
A-0.07	PARKS AND RECREATION AREA DIAGRAM
A-0.08	STREET SECTION
A-1.00	SITE PLAN
A-1.01	SITE DETAILS
A-2.01	GROUND LEVEL FLOOR PLAN
A-2.02	2ND LEVEL FLOOR PLAN
A-2.03	TYP. 3RD TO 4TH FLOOR PLAN
A-2.04	5TH LEVEL FLOOR PLAN
A-2.05	6TH LEVEL FLOOR PLAN
A-2.06	ROOF LEVEL FLOOR PLAN
A-4.00	BUILDING ELEVATIONS
A-4.01	BUILDING ELEVATIONS
A-4.02	COURTYARD ELEVATIONS
A-5.00	RENDERING VIEWS
A-5.01	RENDERING VIEWS
A-5.02	RENDERING VIEWS
A-5.03	RENDERING VIEWS
A-5.04	RENDERING VIEWS
A-5.05	RENDERING VIEWS
A-5.06	RENDERING VIEWS
A-5.07	RENDERING VIEWS
A-5.08	RENDERING VIEWS
A-5.09	RENDERING VIEWS
A-5.10	RENDERING VIEWS
A-5.11	RESIDENTIAL UNIT STOOP

	CIVIL
SHEET NO.	SHEET NAME
C-1.01	GENERAL NOTES
C-2.01	STORM WATER POLLUTION PREVENTION NOTES & DETAILS
C-2.02	STORM WATER POLLUTION PREVENTION
C-3.01	EXISTING CONIDITONS AND DEMOLITION
C-4.01	OVERALL SITE PLAN
C-4.02	SITE PLAN
C-5.01	PAVING, GRADING AND DRAINAGE PLAN
C-5.02	PAVING, GRADING AND DRAINAGE DETAILS

LANDSCAPE	
SHEET NO.	SHEET NAME
TD-1	TREE DISPOSITION PLAN
L-1	INDEX
L-2	GROUND FLOOR LANDSCAPE PLAN
L-3	GROUND FLOOR LANDSCAPE PLAN
L-4	INDUSTRIAL SITE LANDSCAPE PLAN BY CABRERA RAMOS ARCHITECTS,
L-5	INDUSTRIAL SITE LANDSCAPE PLAN BY CABRERA RAMOS ARCHITECTS,

	PHOTOMETRICS
SHEET NO.	SHEET NAME
L-1.01	LIGHTING PHOTOMETRIC PLAN
L-1.02	LIGHTING PHOTOMETRIC DETAIL (1 OF 4)
L-1.03	LIGHTING PHOTOMETRIC DETAIL (2 OF 4)

# <u>DEVELOPER</u>

**EWE WAREHOUSE** INVESTMENT XXXII, LTD

SITE PLAN SUBMITTAL FEBRUARY 22nd, 2023

# LEGACY AT DORAL

2525 NW 82ND AVENUE, DORAL, FL. 33122



3 BENTWOOD ROAD PALM BEACH GARDENS, FL. 33418



201 ALHAMBRA CIR. STE. 800 CORAL GABLES, FL. 33134





307 S. 21ST. AVENUE HOLLYWOOD, FL. 33020








2525 NW 82ND AVENUE, DORAL, FL. 33122

OWNER:

**EWE WAREHOUSE** INVESTMENT XXXII, LTD

**SITE PLAN** SUBMITTAL

RI	EVISIONS	
Revision #	Revision Description	Date

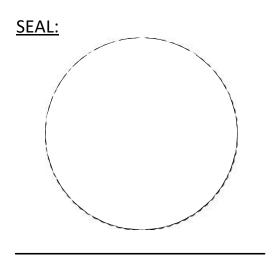

THESE DRAWINGS ARE THE PROPERTY OF CORWIL ARCHITECTS INC. UNLESS OTHERWISE PROVIDED FOR BY CONTRACT, THE CONTENTS OF THES DRAWINGS ARE CONFIDENTIAL AND SHALL NOT BE TRANSMITTED TO ANY OTHER PARTY EXCEPT AS AGREED TO BY THE ARCHITECT/ENGINEERS.

SCALE: N.T.S

<u>DATE:</u> JOB No.: 05/27/2022 2021-21 DRAWN BY: SR/DA PRINTED:

2/22/2023 7:42:43 PM


SHEET NUMBER:





VIEW 2

SCALE: N.T.S

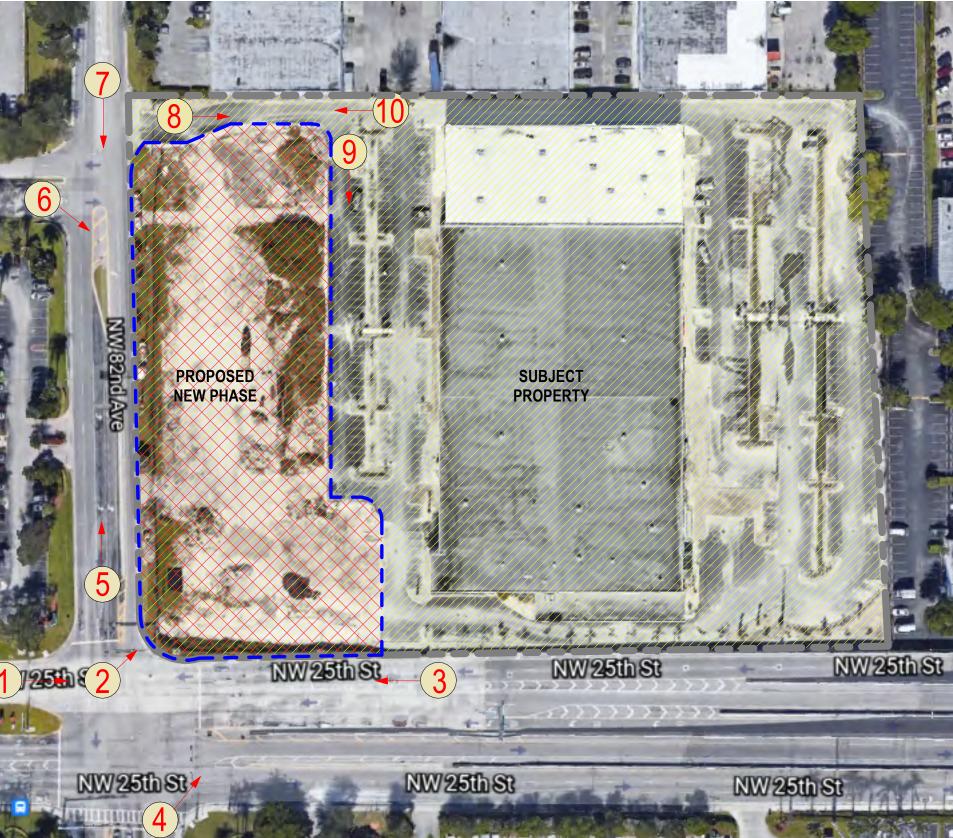

**ADJOINING AREA CONTEXT** 




VIEW 3







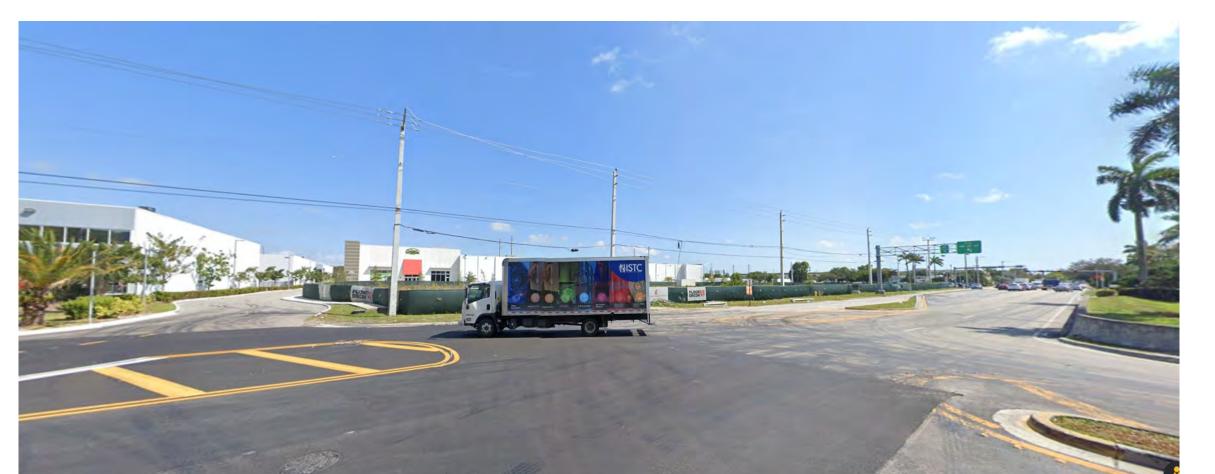



VIEW 6 VIEW 9








VIEW 8 VIEW 10 PROJECT: **LEGACY AT DORAL** 2525 NW 82ND AVENUE, DORAL, FL. 33122

**EWE WAREHOUSE** INVESTMENT XXXII, LTD

**SITE PLAN SUBMITTAL** 

**REVISIONS** 

Revision Bescription Date

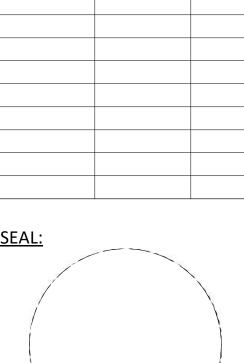

THESE DRAWINGS ARE THE PROPERTY OF CORWIL ARCHITECTS INC.
UNLESS OTHERWISE PROVIDED FOR BY CONTRACT, THE CONTENTS OF THES DRAWINGS ARE CONFIDENTIAL AND

SHALL NOT BE TRANSMITTED TO ANY OTHER PARTY EXCEPT AS AGREED TO BY THE ARCHITECT/ENGINEERS.

DATE:
JOB No.:
DRAWN BY:
APPR BY:
PRINTED:

05/27/2022 2021-21 SR/DA AMC 2/22/2023 7:42:49 PM

SHEET NUMBER:
A-0.02



**LEGACY AT DORAL** 


2525 NW 82ND AVENUE, DORAL, FL. 33122


OWNER:

**EWE WAREHOUSE INVESTMENT XXXII, LTD** 

PHASE:

**SITE PLAN SUBMITTAL** 

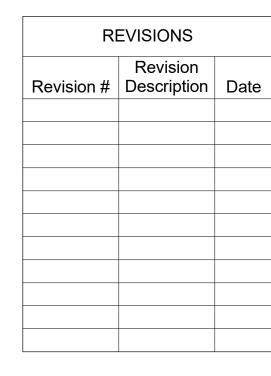

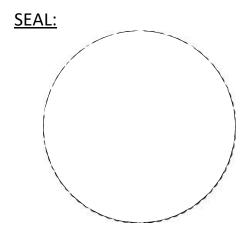


THESE DRAWINGS ARE THE PROPERTY OF CORWIL ARCHITECTS INC. UNLESS OTHERWISE PROVIDED FOR BY CONTRACT, THE CONTENTS OF THES DRAWINGS ARE CONFIDENTIAL AND SHALL NOT BE TRANSMITTED TO ANY OTHER PARTY EXCEPT AS AGREED TO BY THE ARCHITECT/ENGINEERS.

DATE:
JOB No.:
DRAWN BY:
APPR BY:
PRINTED: 05/27/2022 2021-21 SR/DA

2/22/2023 7:43:08 PM

SHEET NUMBER:

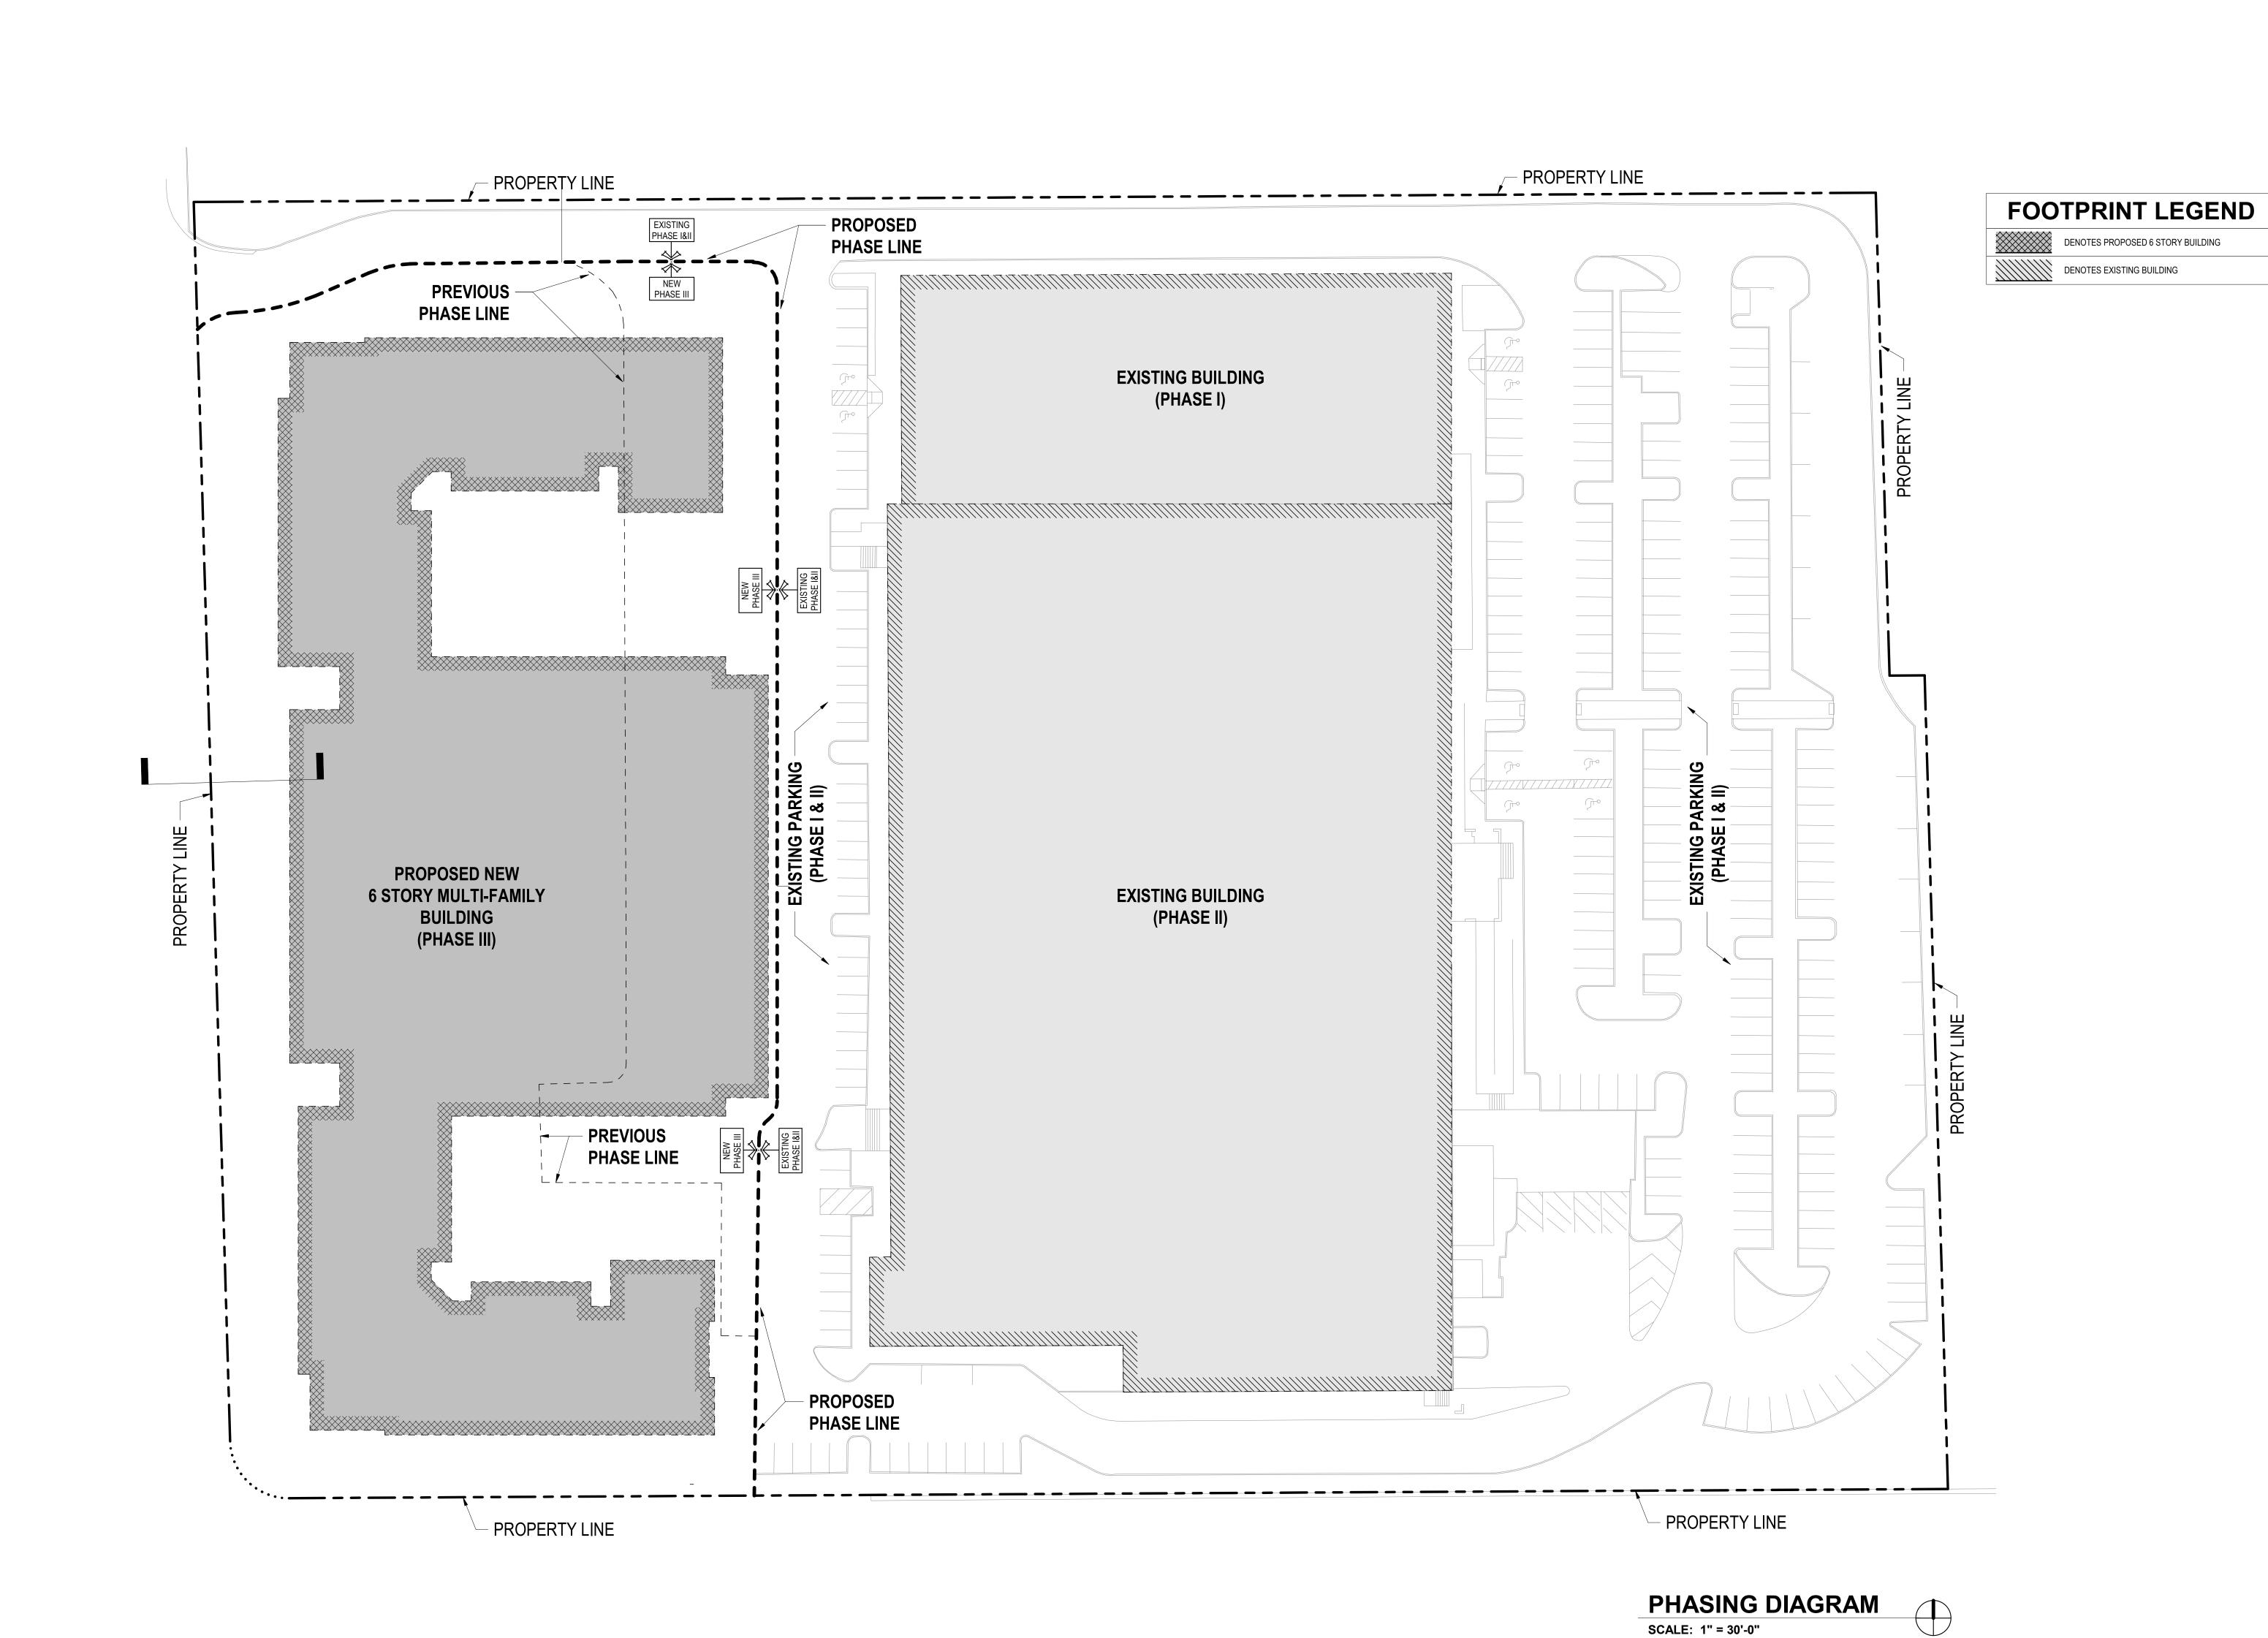

**LEGACY AT DORAL** 

2525 NW 82ND AVENUE, DORAL, FL. 33122

OWNER:

NEW PROPOSED PHASE

49,740 SF


101,390 SF (25%)


40,416 SF (10%)

**EWE WAREHOUSE** INVESTMENT XXXII, LTD

PHASE:

**SITE PLAN SUBMITTAL** 

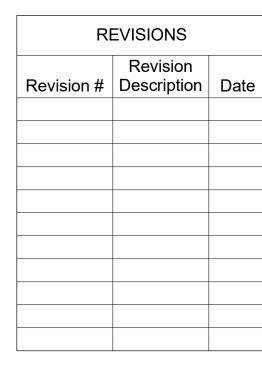

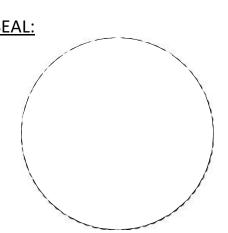


THESE DRAWINGS ARE THE PROPERTY OF CORWIL ARCHITECTS INC. UNLESS OTHERWISE PROVIDED FOR BY CONTRACT, THE CONTENTS OF THES DRAWINGS ARE CONFIDENTIAL AND SHALL NOT BE TRANSMITTED TO ANY OTHER PARTY EXCEPT AS AGREED TO BY THE ARCHITECT/ENGINEERS.

DATE:
JOB No.:
DRAWN BY:
APPR BY:
PRINTED:

05/27/2022 2021-21 SR/DA 2/22/2023 7:43:14 PM

SHEET NUMBER:

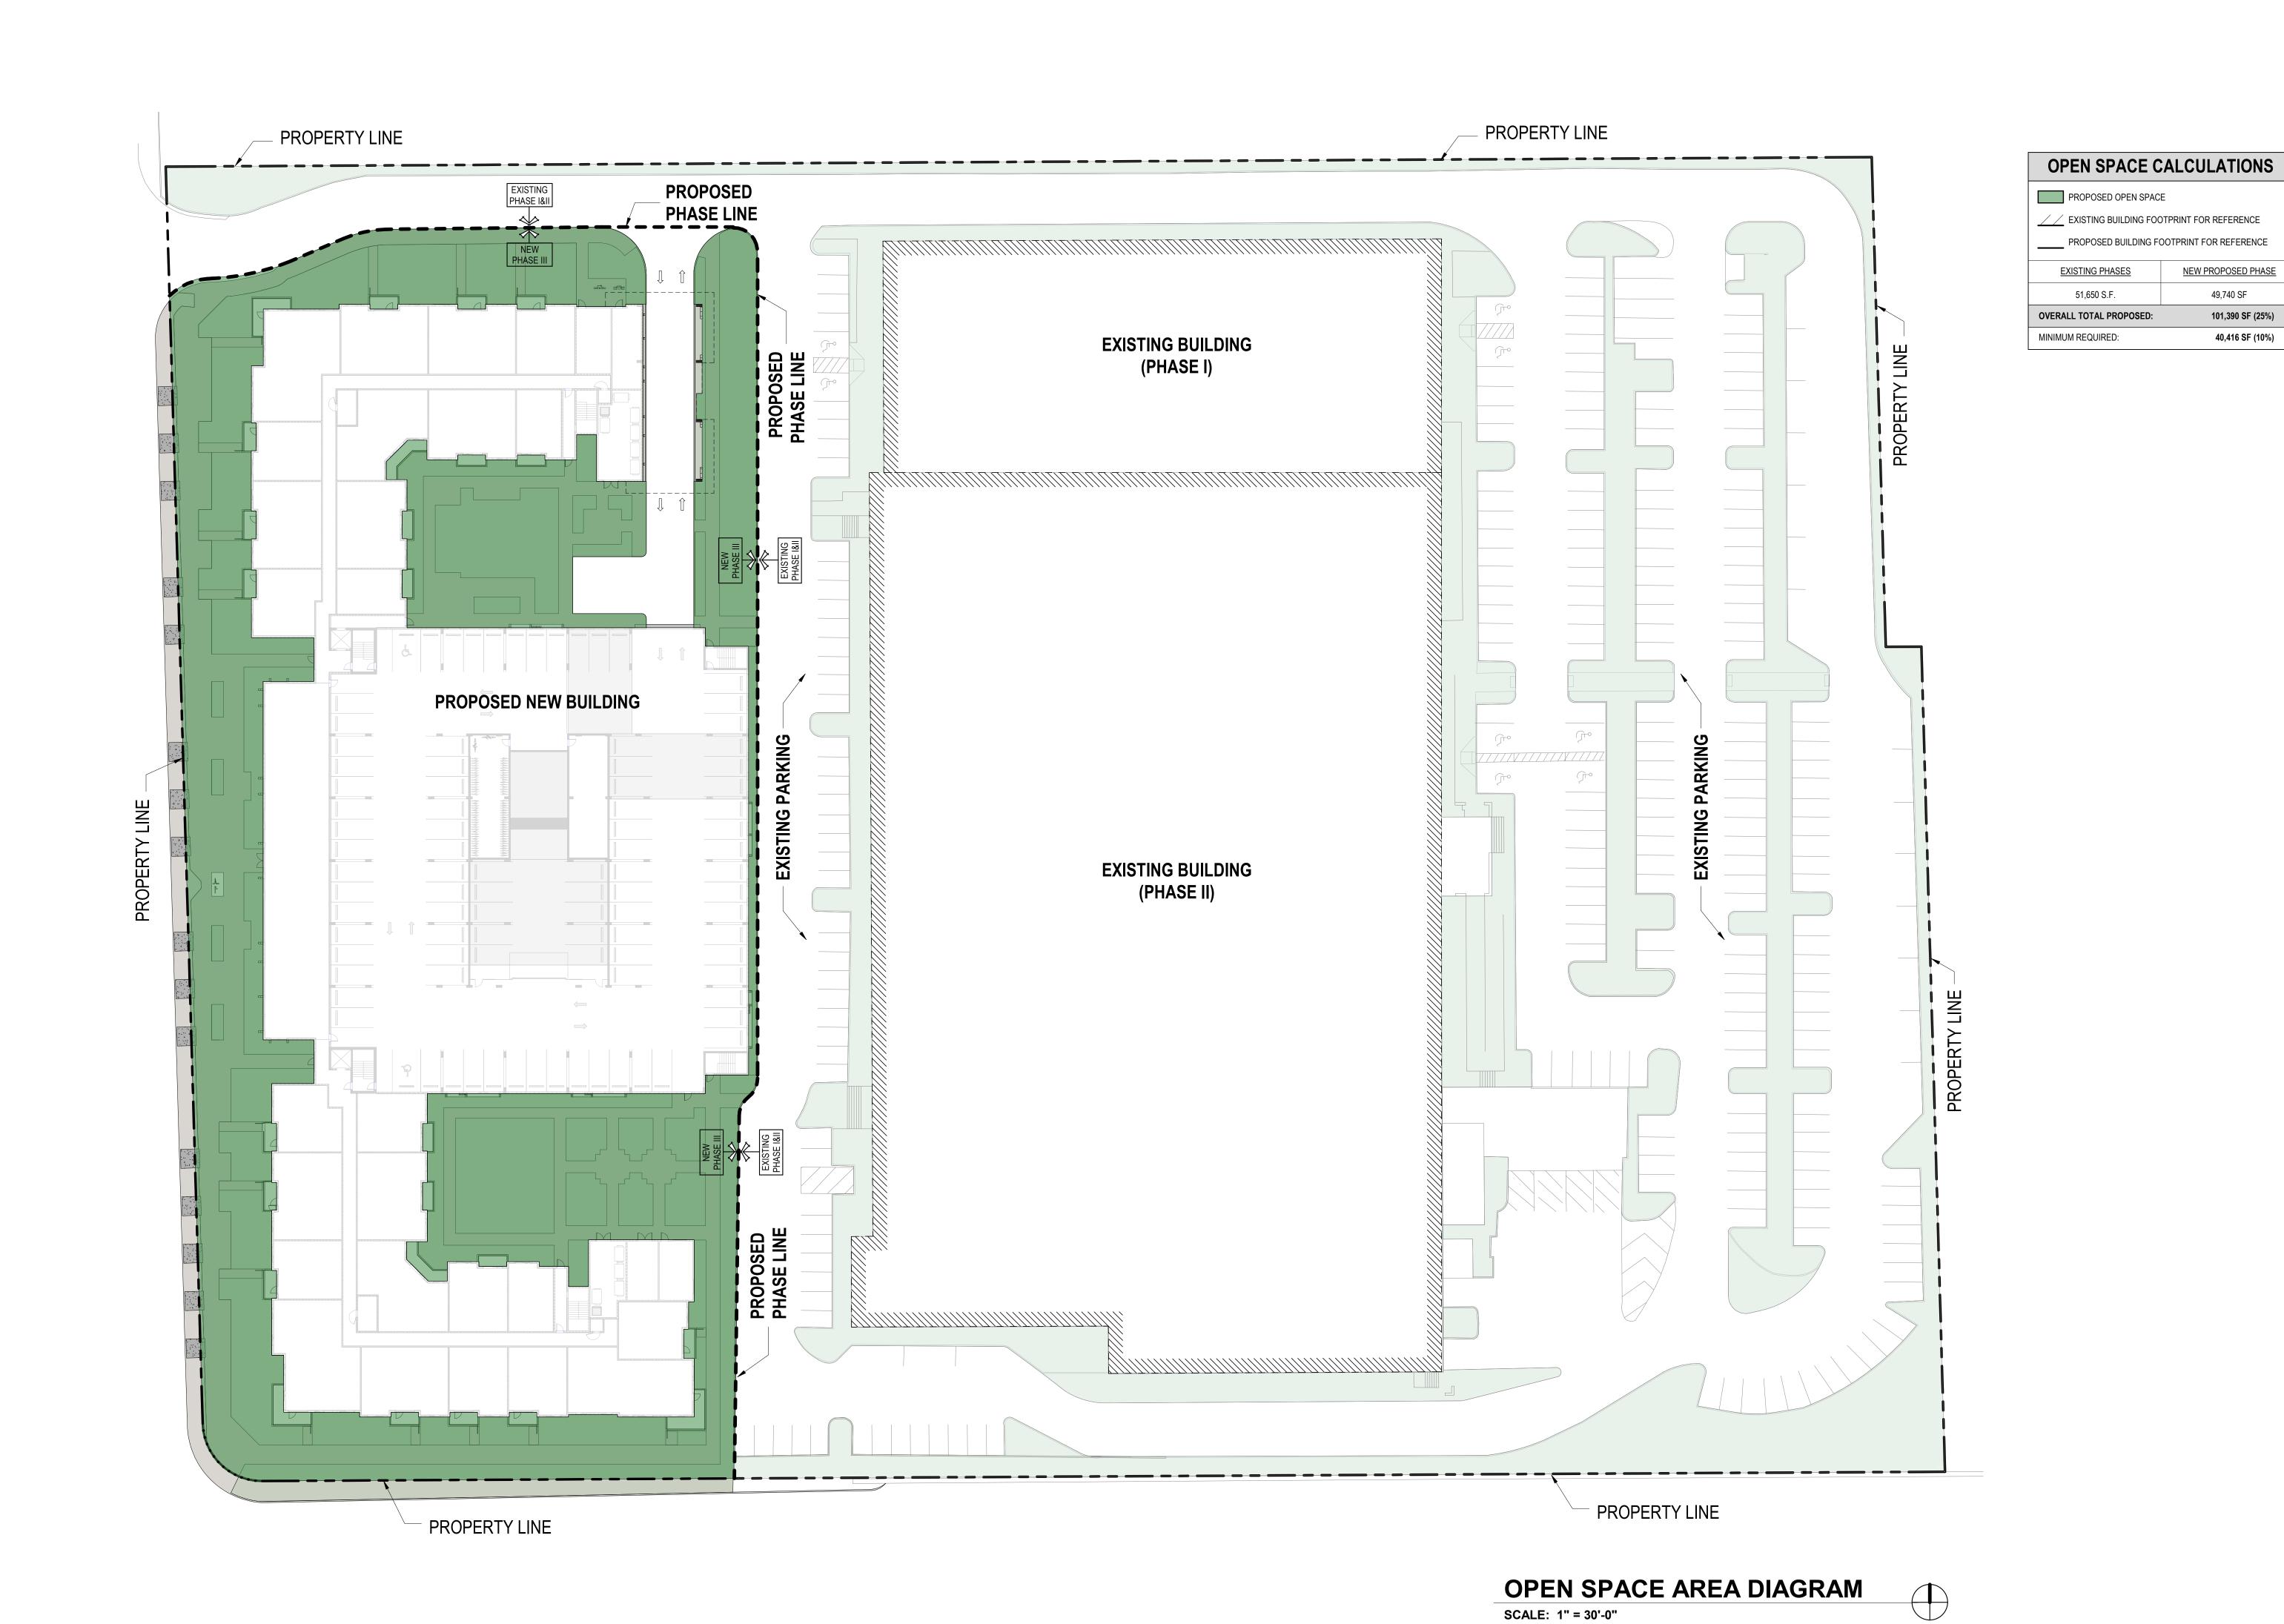

**LEGACY AT DORAL** 

2525 NW 82ND AVENUE, DORAL, FL. 33122

OWNER:


**EWE WAREHOUSE** INVESTMENT XXXII, LTD

EXISTING BUILDING COVERAGE FOR REFERENCE  NEW PROPOSED BUILDING COVERAGE		
EXISTING BUILDING	NEW PROPOSED BUILDING	
112,085 S.F.	39,551 SF	
OVERALL TOTAL:	151,636 SF (37.5%)	
MAXIMUM ALLOWED:	343,535 SF (85.0%)	

PHASE:

SITE PLAN **SUBMITTAL** 


RI	EVISIONS	
Revision #	Revision Description	Date

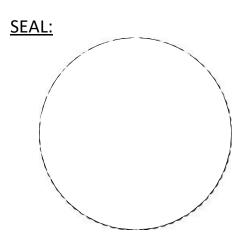

THESE DRAWINGS ARE THE PROPERTY OF CORWIL ARCHITECTS INC. UNLESS OTHERWISE PROVIDED FOR BY CONTRACT, THE CONTENTS OF THES DRAWINGS ARE CONFIDENTIAL AND SHALL NOT BE TRANSMITTED TO ANY OTHER PARTY EXCEPT AS AGREED TO BY THE ARCHITECT/ENGINEERS.

DATE:
JOB No.:
DRAWN BY:
APPR BY:
PRINTED: 05/27/2022 2021-21 SR/DA 2/22/2023 7:43:21 PM

SHEET NUMBER:

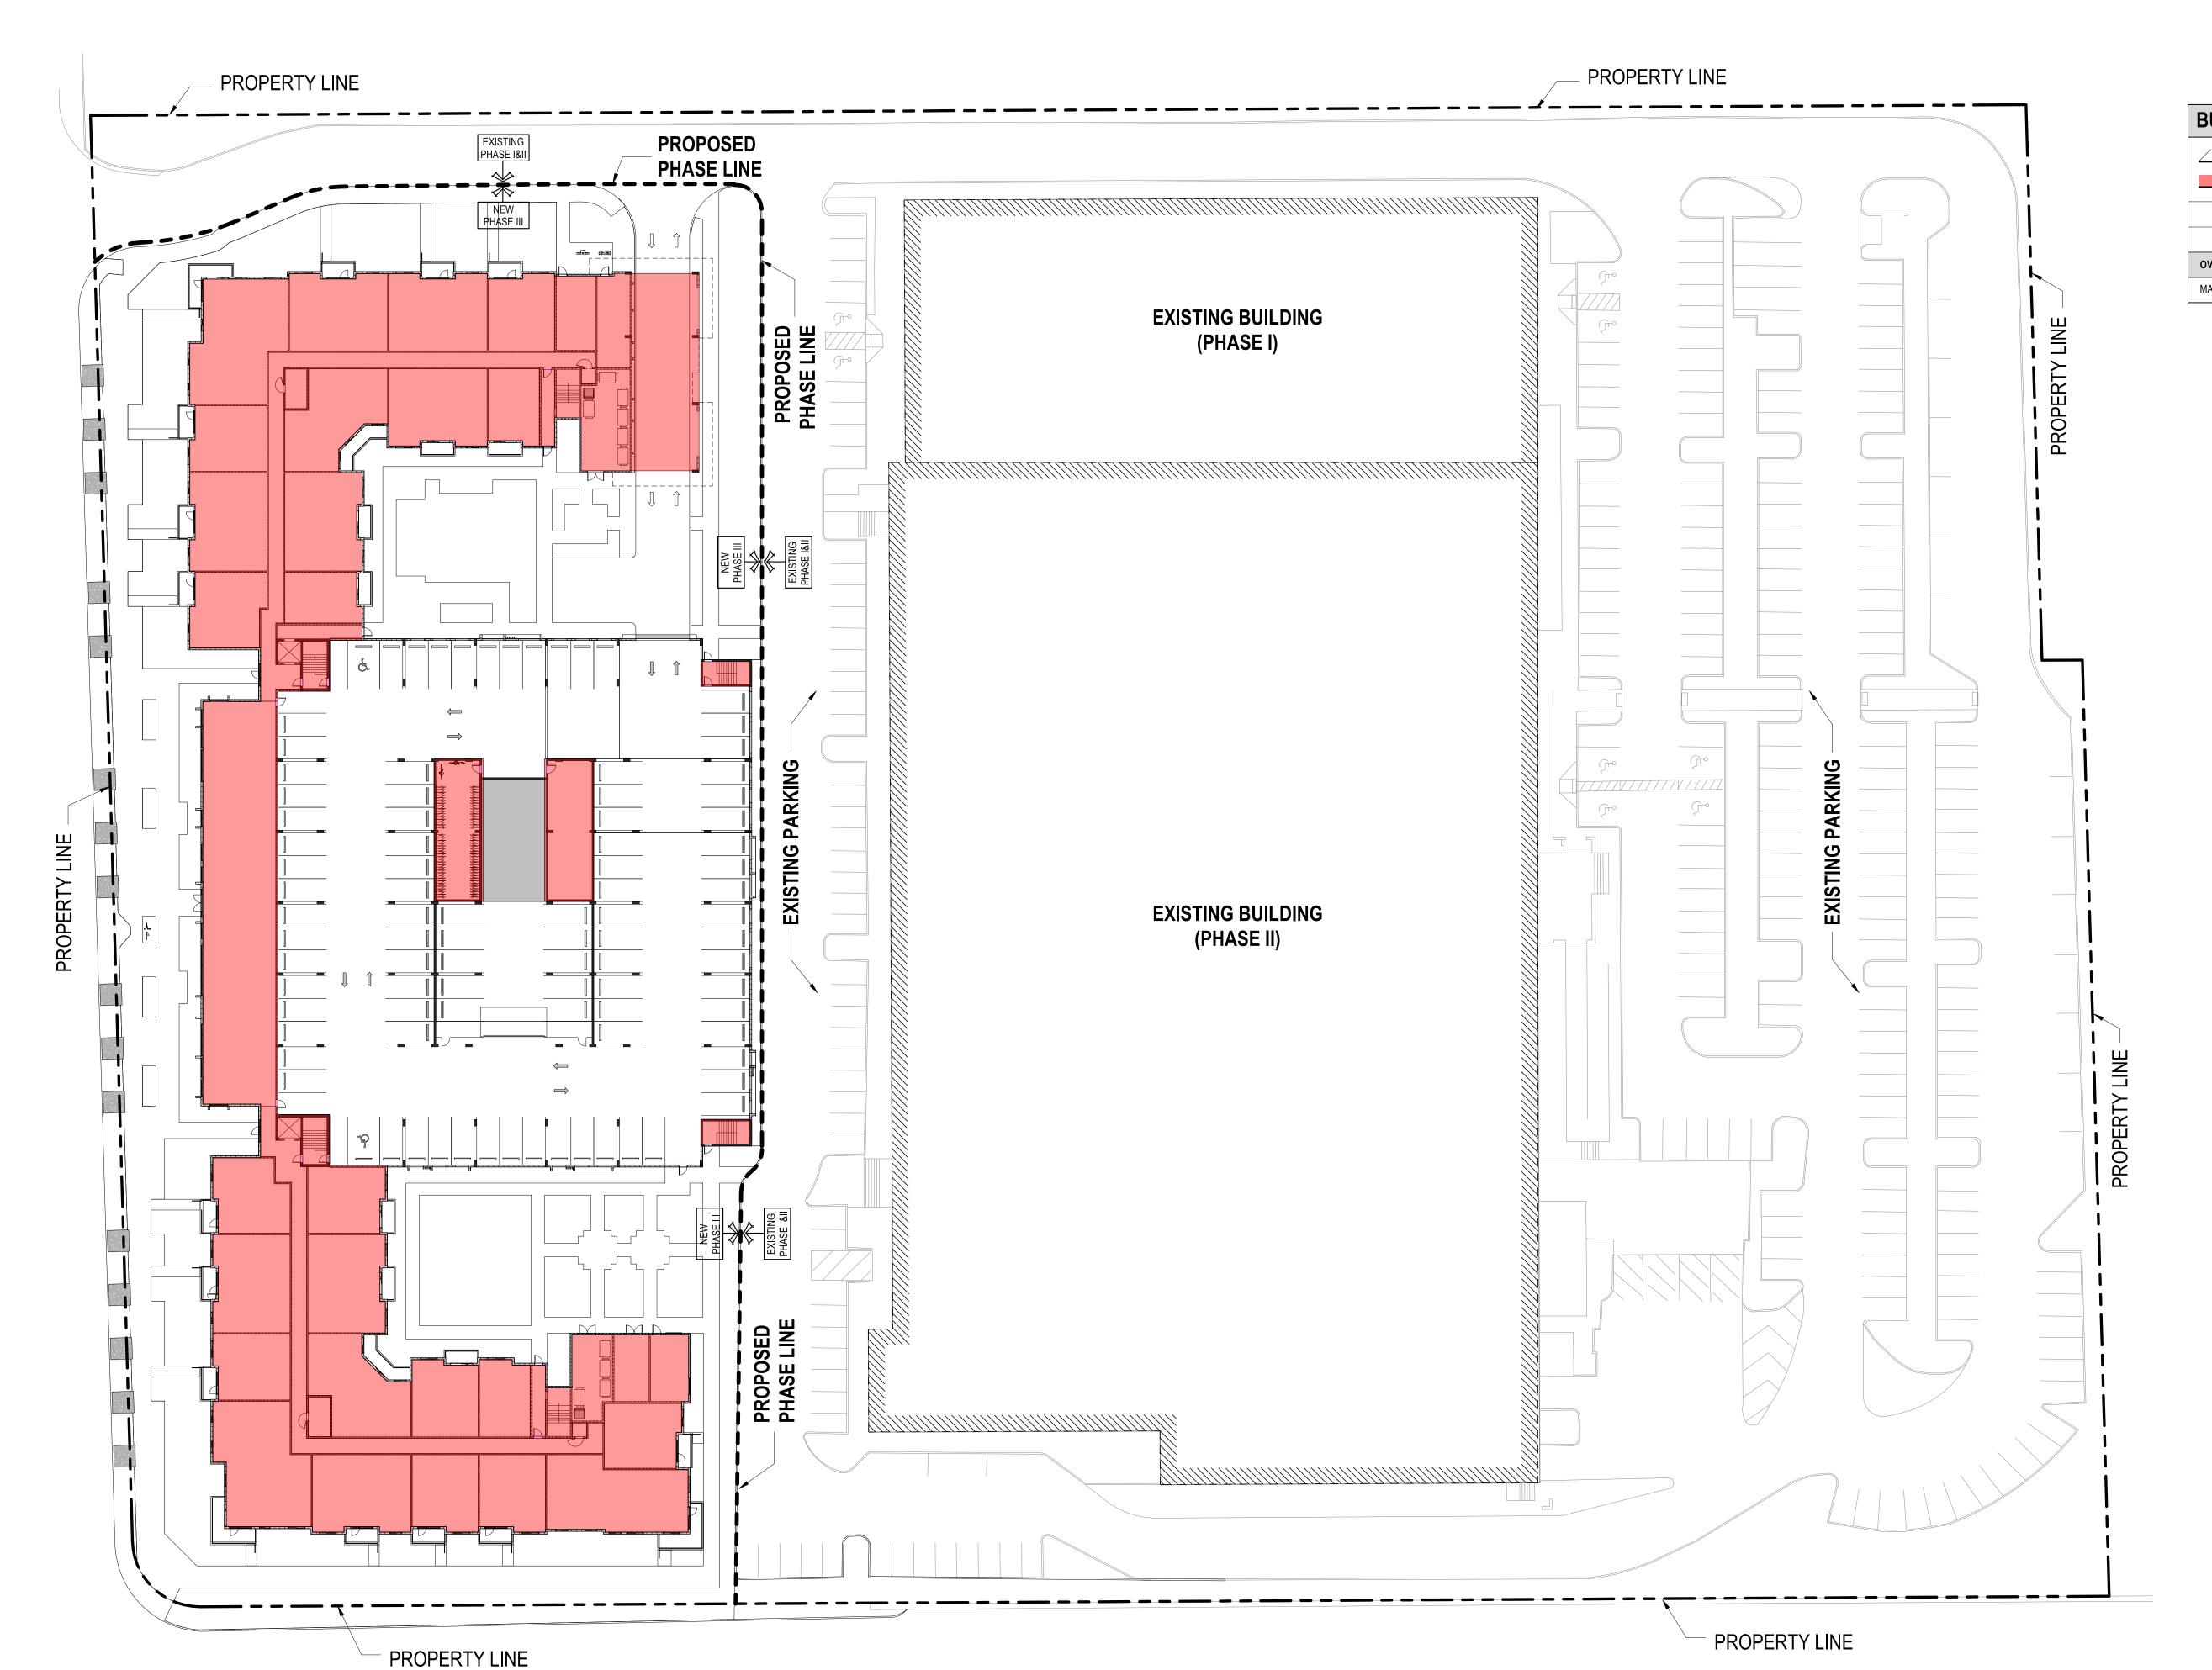

BUILDING COVERAGE AREA DIAGRAM


SCALE: 1" = 30'-0"


FAR CACULATIONS			FAR (	CACULATIO	NS
EXISTING PHASES	NEW PROP	<u>OSED</u>	EXISTING PHASES	NEW PRO	POSED
112,085 S.F.	GROUND FLOOR	26,990 SF	N/A	2ND FLOOR	29,545 SF
				3RD FLOOR	36,005 SF
				4TH FLOOR	36,005 SF
				5TH FLOOR	36,005 SF
				6TH FLOOR	42,142 SF
OVERALL TOTAL:		139,075 SF	OVERALL TOTAL:		179,702 SF

MAX FAR ALLOWED AT GROUND LEVEL (0.85) 343,535 SF


MAX FAR ALLOWED ABOVE GROUND LEVEL (0.65) 343,535 SF

SCALE: 1" = 40'-0"

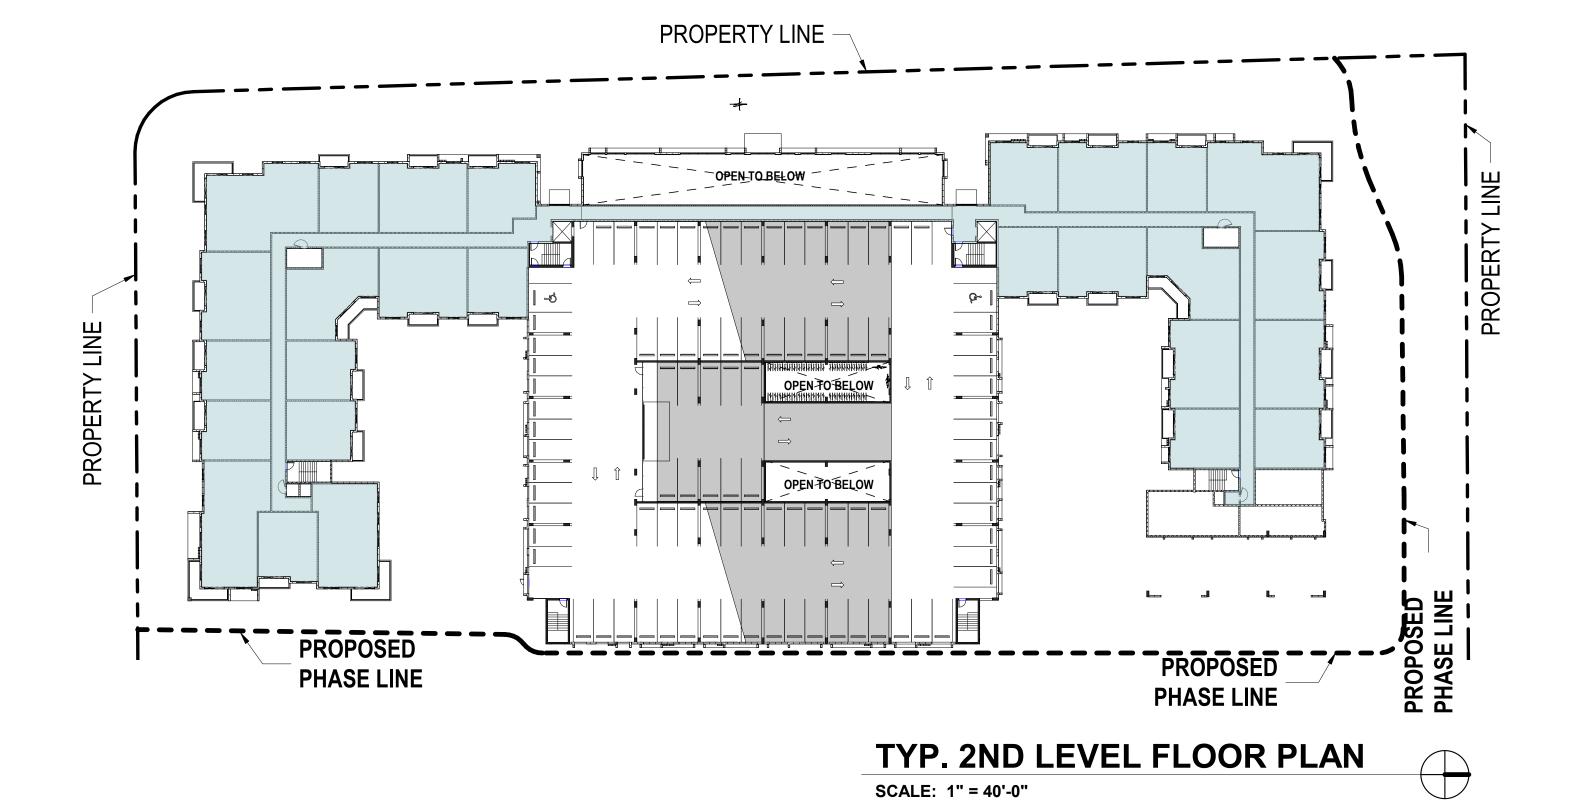

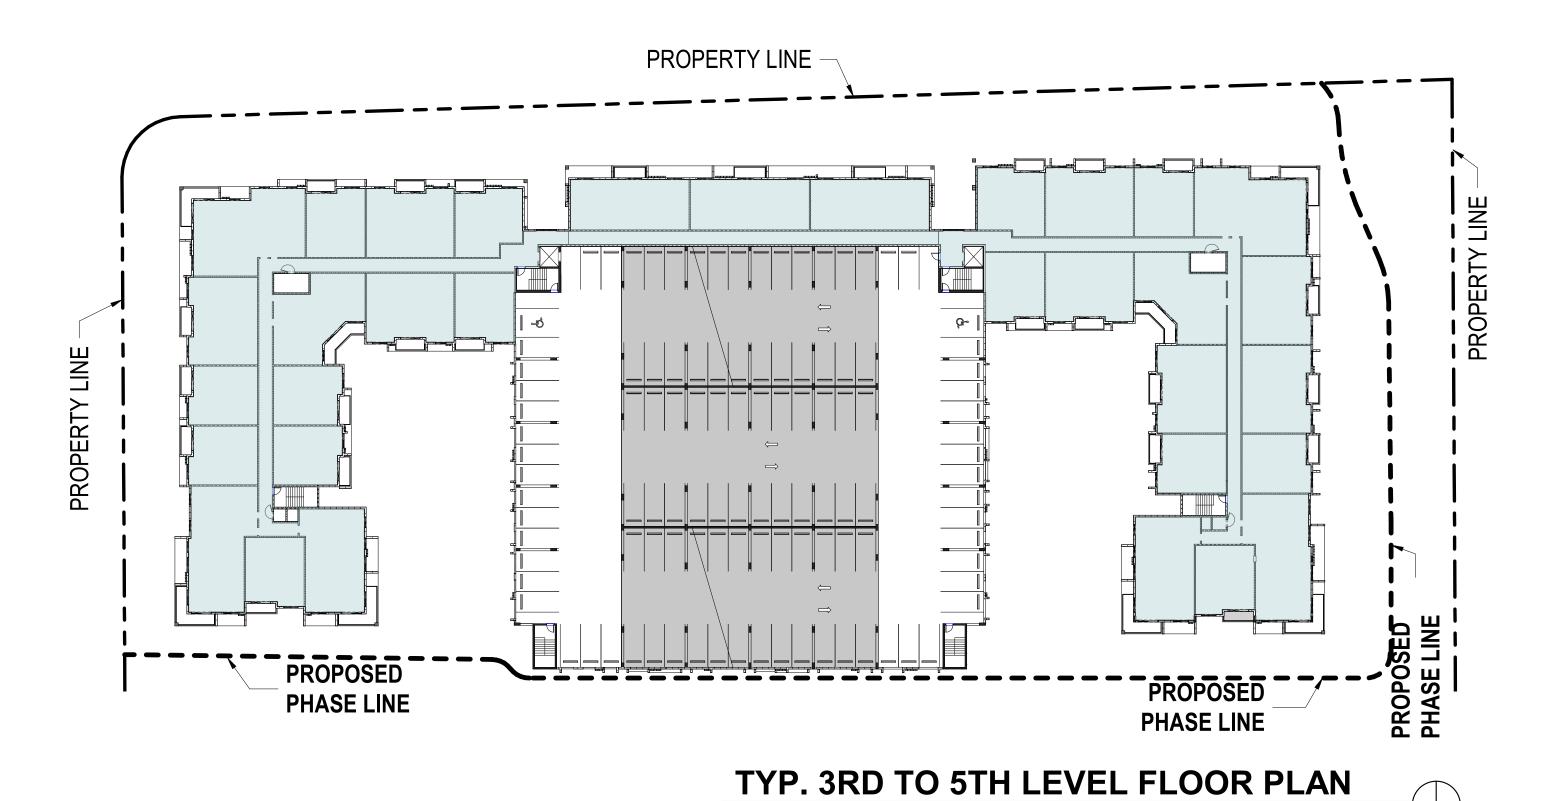

SCALE: 1" = 40'-0"

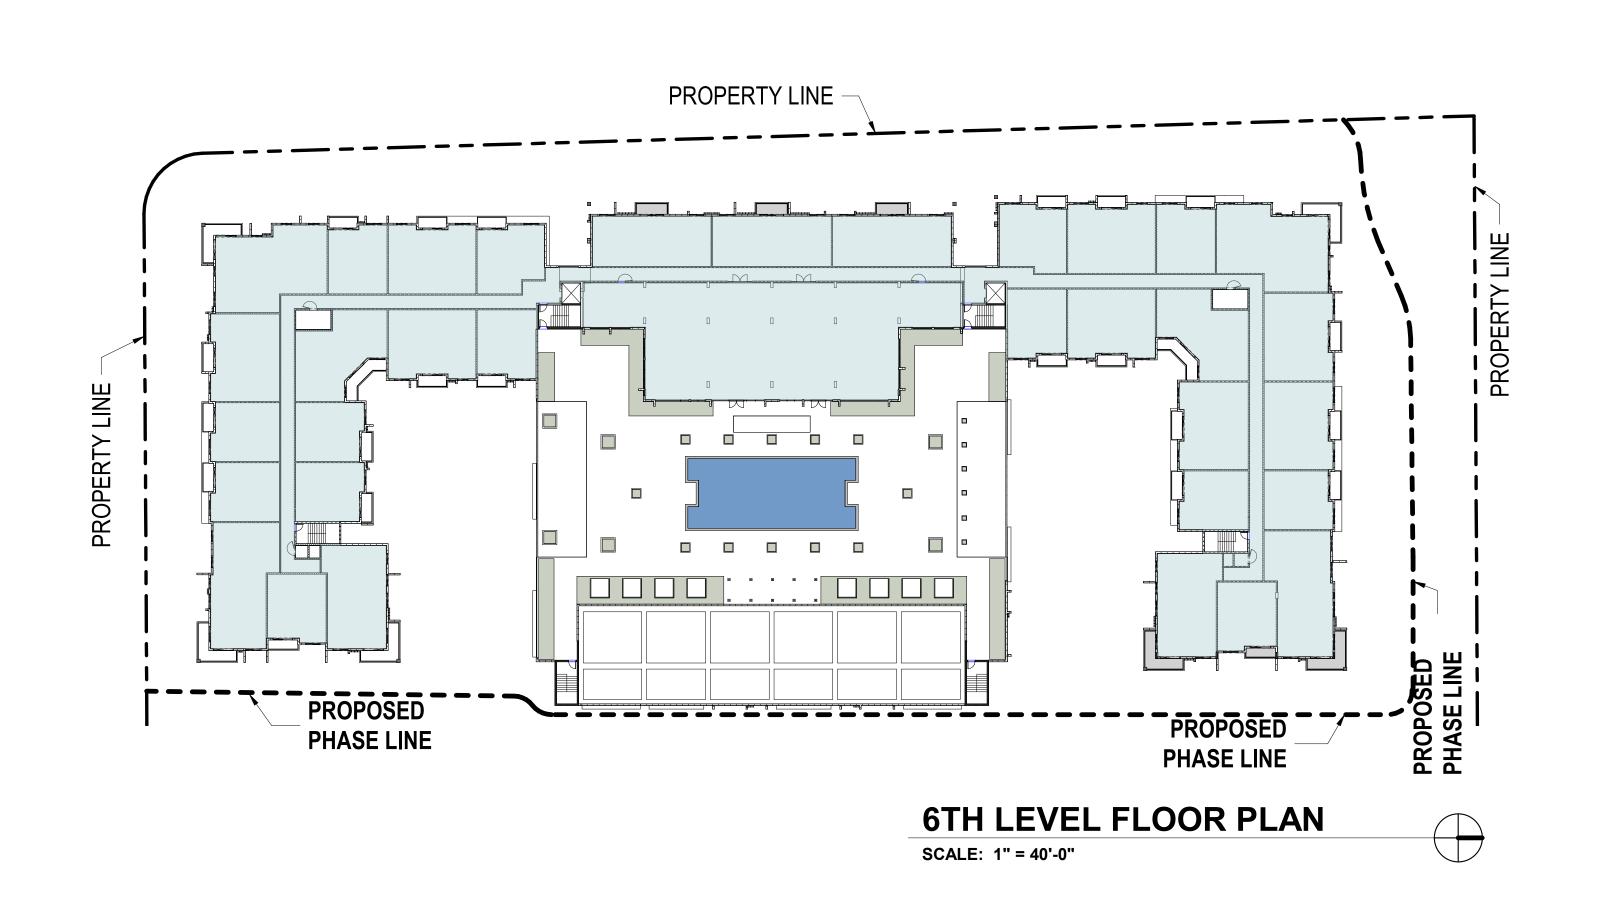



PROJECT:

LEGACY AT DORAL

2525 NW 82ND AVENUE, DORAL, FL. 33122


OWNER:


EWE WAREHOUSE INVESTMENT XXXII, LTD

AR DIAGRAM

PHASE:

SITE PLAN SUBMITTAL

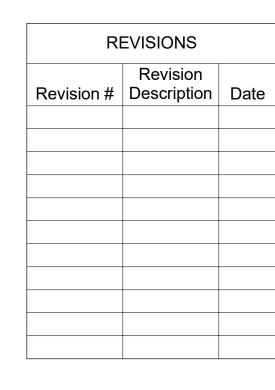

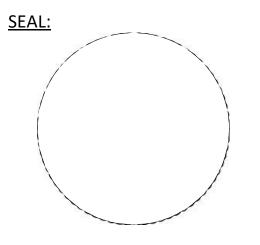

THESE DRAWINGS ARE THE PROPERTY OF CORWIL ARCHITECTS INC.

UNLESS OTHERWISE PROVIDED FOR BY CONTRACT, THE

CONTENTS OF THES DRAWINGS ARE CONFIDENTIAL AND

SHALL NOT BE TRANSMITTED TO ANY OTHER PARTY

EXCEPT AS AGREED TO BY THE ARCHITECT/ENGINEERS.

 DATE:
 05/27/2022

 JOB No.:
 2021-21


 DRAWN BY:
 SR/DA

 APPR BY:
 AMC

 PRINTED:
 2/22/2023 7:43:28 PM

SHEET NUMBER:

A-0.06

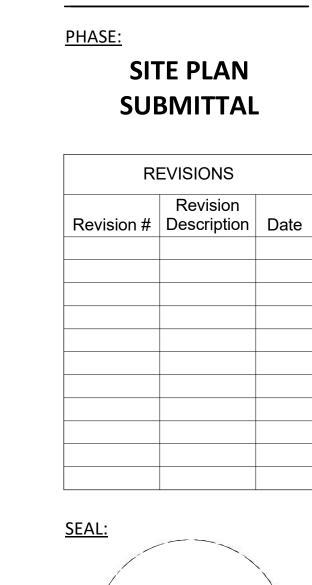


DORAL, FL. 33122


THESE DRAWINGS ARE THE PROPERTY OF CORWIL ARCHITECTS INC. UNLESS OTHERWISE PROVIDED FOR BY CONTRACT, THE CONTENTS OF THES DRAWINGS ARE CONFIDENTIAL AND SHALL NOT BE TRANSMITTED TO ANY OTHER PARTY EXCEPT AS AGREED TO BY THE ARCHITECT/ENGINEERS.

DATE:
JOB No.:
DRAWN BY:
APPR BY:
PRINTED: 05/27/2022 2021-21 SR/DA 2/22/2023 7:43:37 PM

SHEET NUMBER:

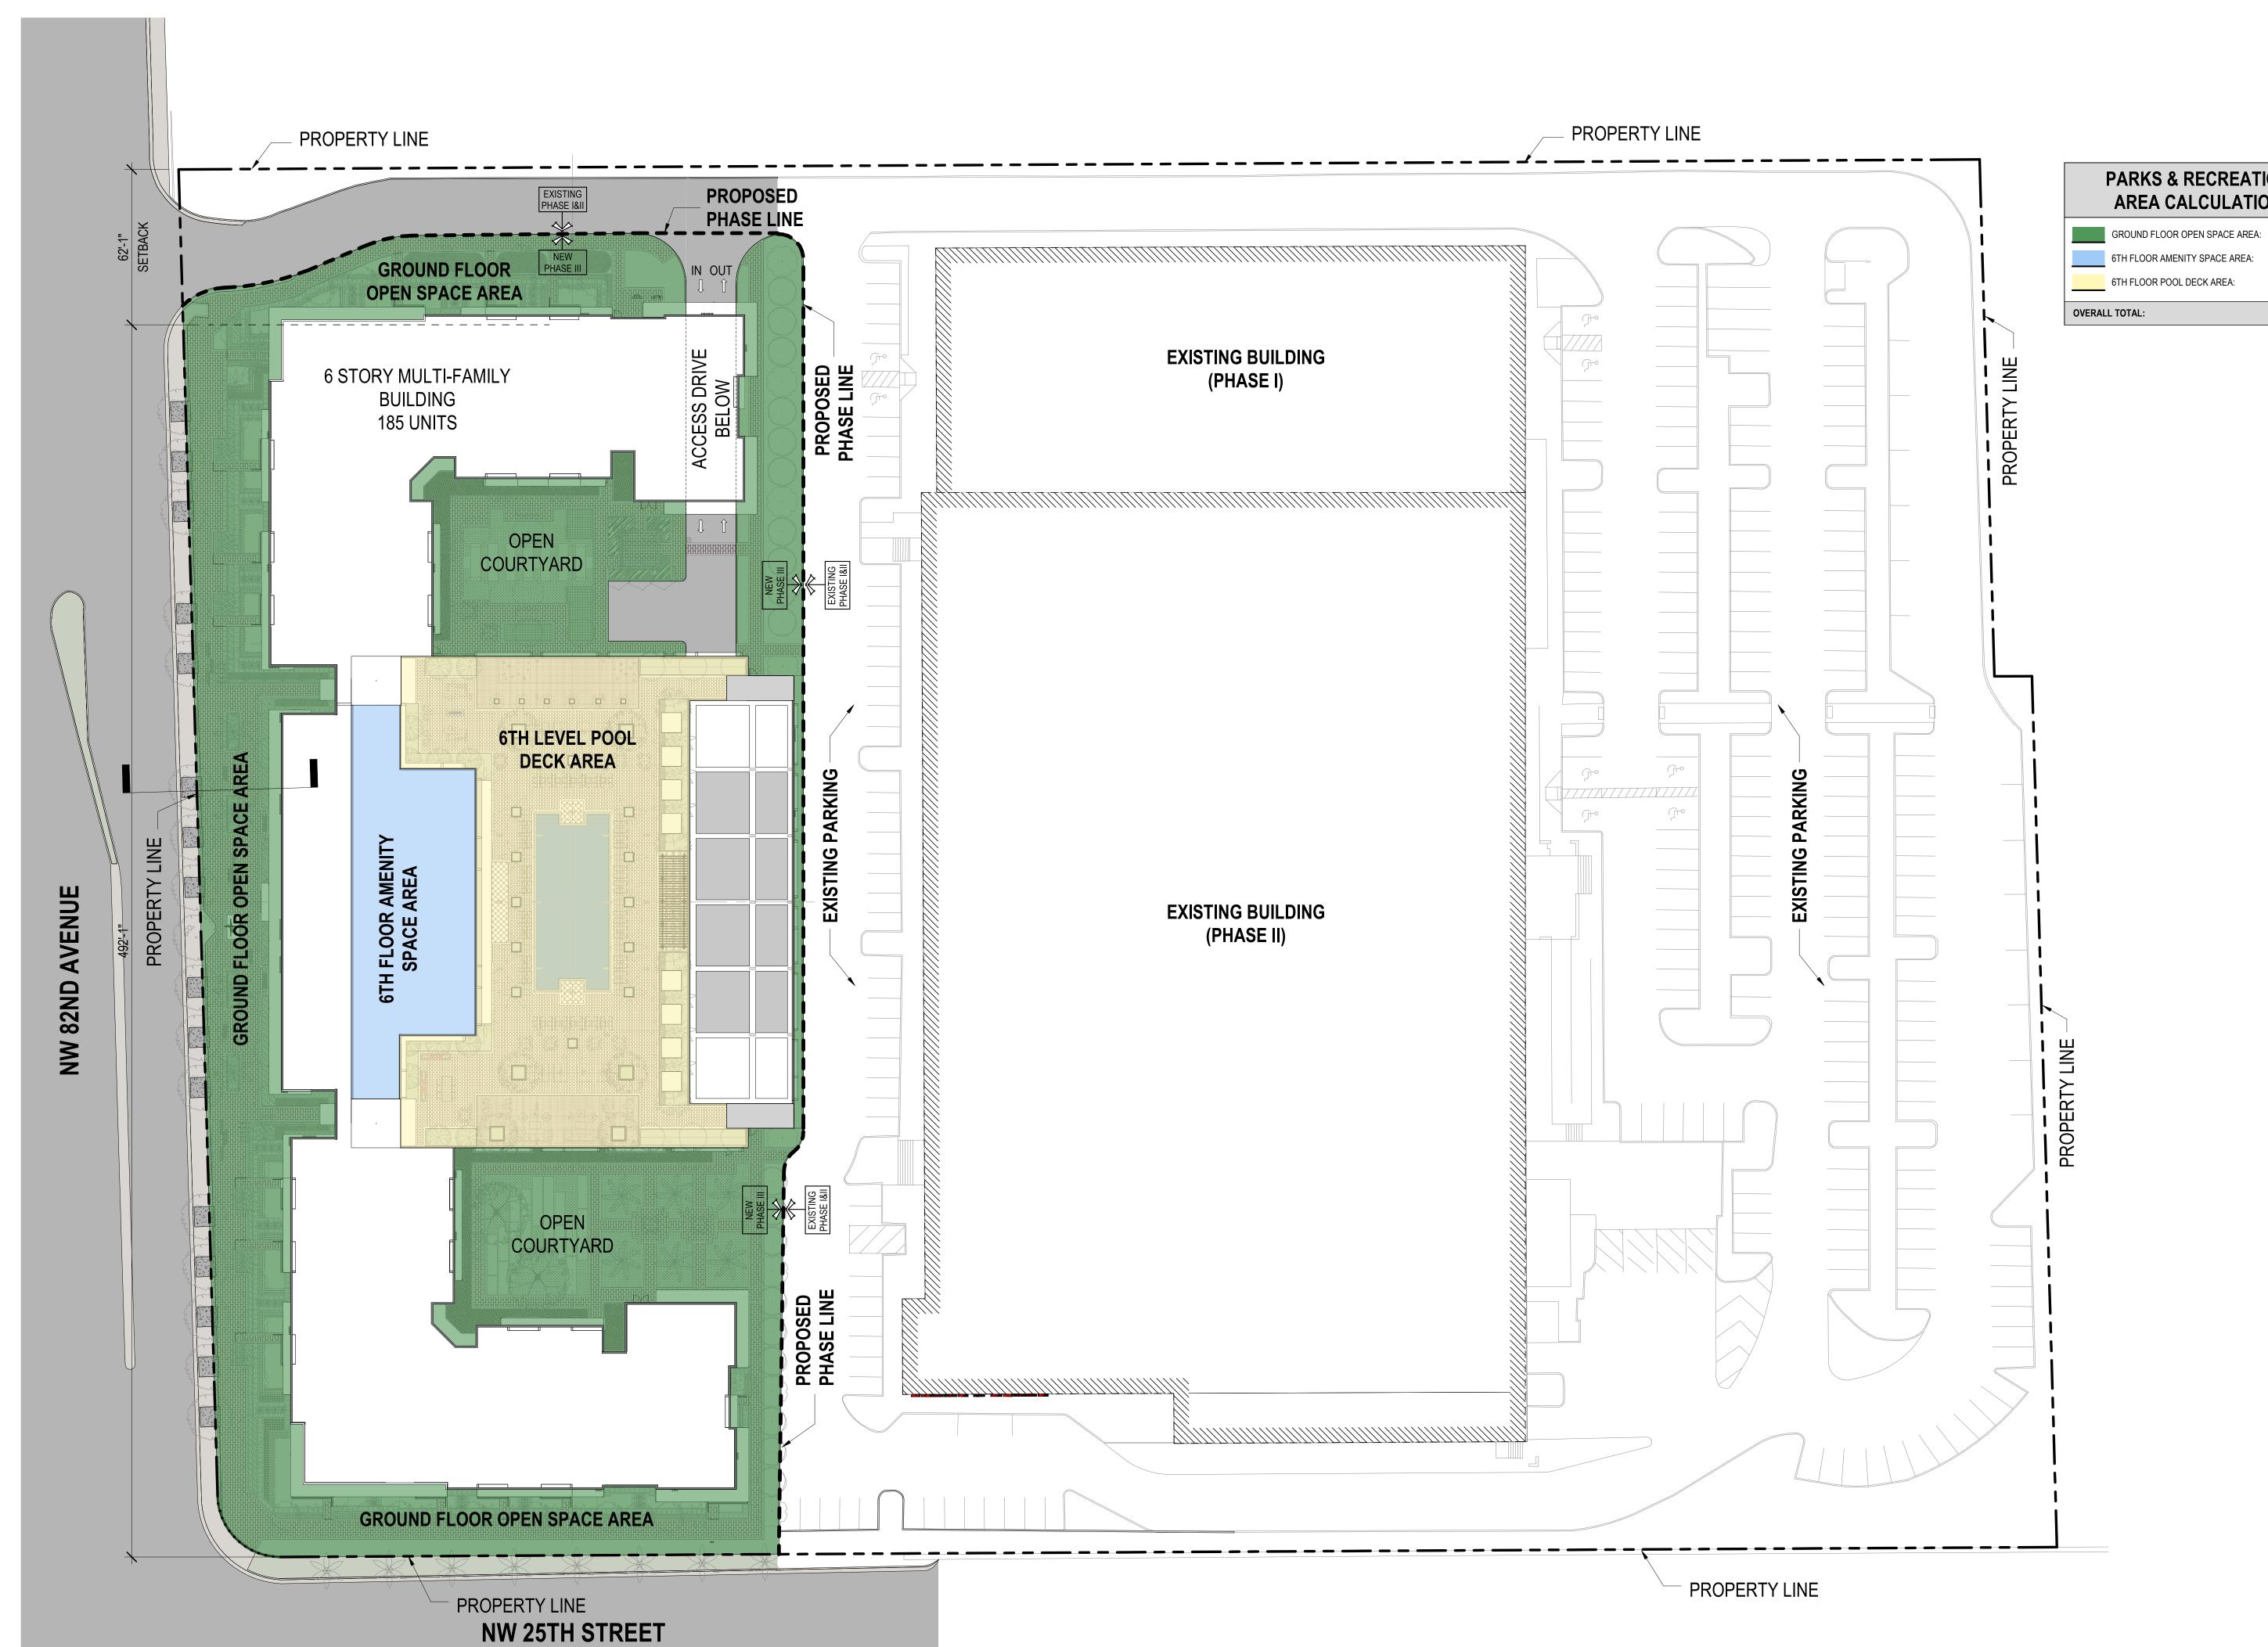

PARKS AND RECREATION AREA DIAGRAM SCALE: 1" = 30'-0"

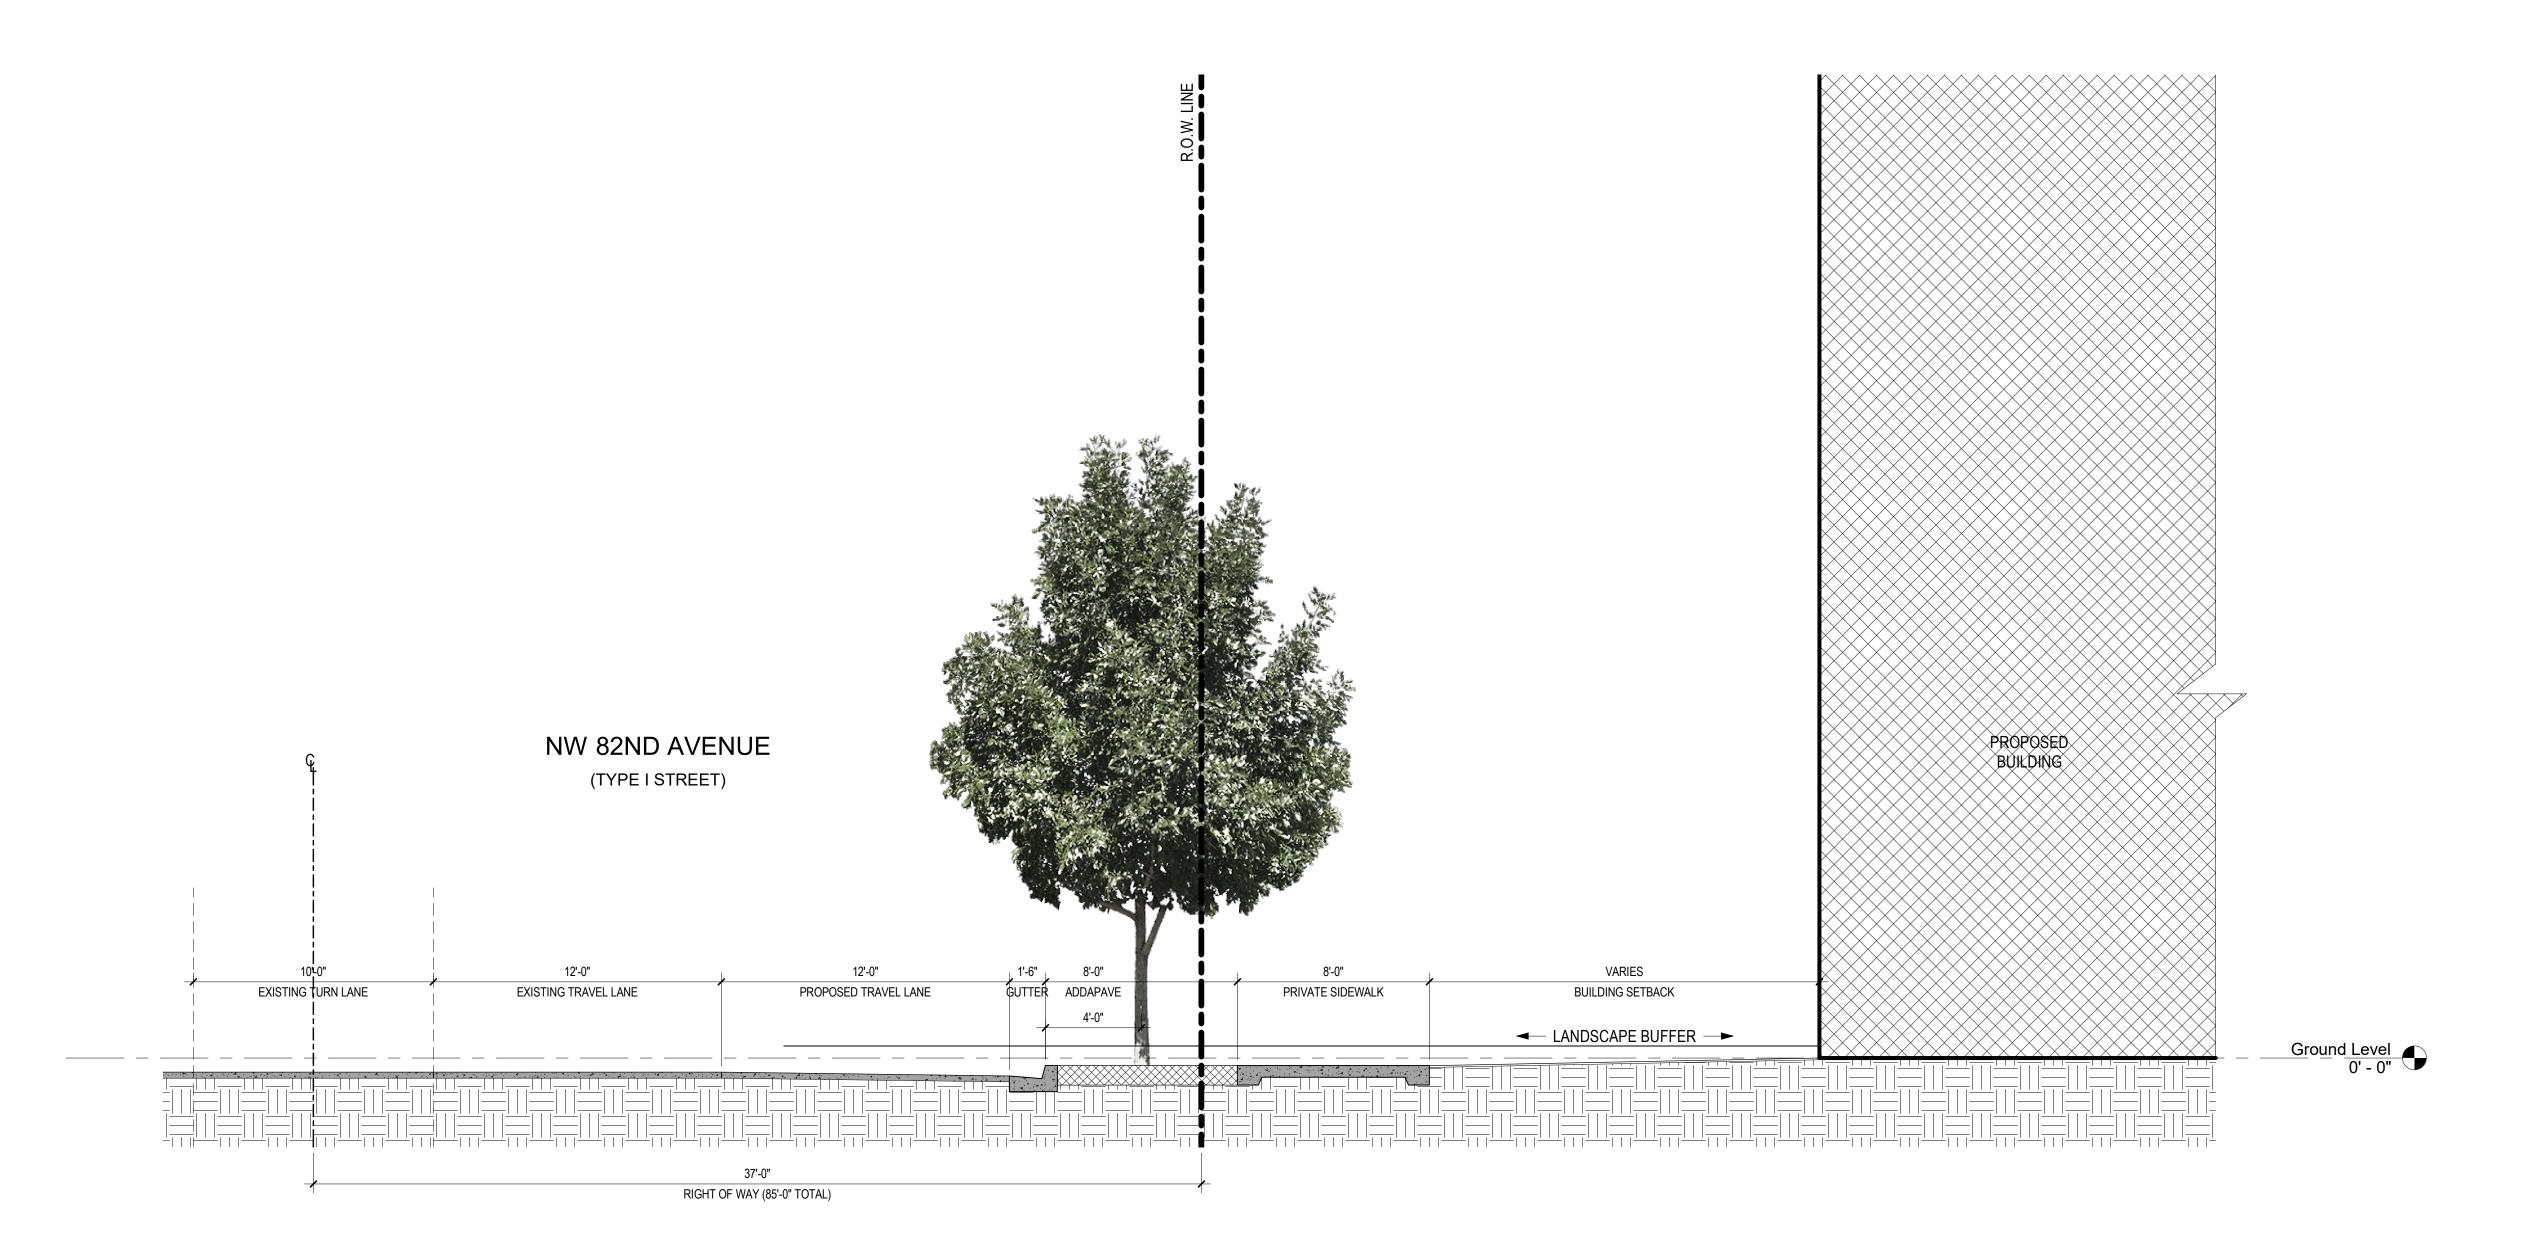

DISTRICT TYPE-I STREET SECTION

SCALE: 1/4" = 1'-0"

CORWILARCHITECTS
4210 LAGUNA ST. CORAL GABLES FL, 33146
QUALIFIER LIC. NO. AR0016003 T:305.448.7383

PROJECT:


**LEGACY AT DORAL** 


2525 NW 82ND AVENUE, DORAL, FL. 33122

OWNER:

**EWE WAREHOUSE INVESTMENT XXXII, LTD** 

### **SITE PLAN SUBMITTAL**

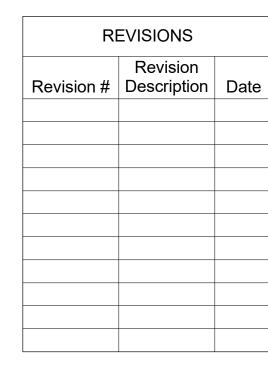

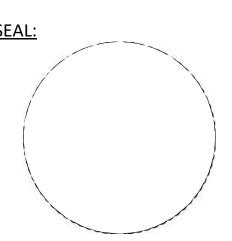

THESE DRAWINGS ARE THE PROPERTY OF CORWIL ARCHITECTS INC. UNLESS OTHERWISE PROVIDED FOR BY CONTRACT, THE CONTENTS OF THES DRAWINGS ARE CONFIDENTIAL AND SHALL NOT BE TRANSMITTED TO ANY OTHER PARTY EXCEPT AS AGREED TO BY THE ARCHITECT/ENGINEERS.

DATE:
JOB No.:
DRAWN BY:
APPR BY:
PRINTED: 05/27/2022 2021-21 SR/DA AMC

SHEET NUMBER:

2/22/2023 7:43:47 PM

QUALIFIER LIC. NO. AR0016003 T:305.448.7383

PROJECT:

OWNER:

**PROPOSED** 

404,159 sf. (9.28 acres)

733'-7"

Total Coverage = 151,636 sf. (37.5%)

Total Open Space: 101,390 sf. (25%)

Existing = 112,085 sf.

Existing: 51,650 sf

Existing = 112,085 sf.

Existing = N/A

New Proposed = 39,551 sf.

New Proposed: 49,740 sf.

New Proposed = 26,990 sf. Total Floor Area = 139,075 sf.

New Proposed = 179,702 sf.Total Floor Area = 179,702 sf.

185 d.u.

26'-0" min.

29'-2" min.

473'-6" min.

58'-1" min.

(New Proposed) 62'-4"

Existing Parking = 338 ps.

Existing to Remain = 256 ps.

(82 ps. relocated inside

new proposed parking garage)

Proposed Parking = 398 ps.

(Including 82 ps. relocated)

(Including 8 Accessible Spaces)

Total Parking Proposed = 654 ps.

14 ps. (included in total)

Existing to Remain = 34 b.r.

New Proposed = 31 b.r.

Total Bicycle Spaces Proposed = 65 b.r.

Existing to Remain = 10 spaces

2 Loading Spaces (12' x 25' x 15')

**Total Loading Proposed = 12 Spaces** 

18 Parking Spaces Reduction

**ZONING DATA SHEET** 

CITY OF DORAL

INDUSTRIAL WITHIN DISTRICT CORE OF THE CITY OF DORAL DESIGN DISTRICT (EDGE SUB-DISTRICT)

**MULTI-FAMILY RESIDENTIAL** 

FOLIO # 35-3027-024-0010

REQUIRED

7,500 sf. min.

75'-0" min.

85% max. ( 343,535 sf.)

10% min. (40,416 sf.)

FAR at Ground Level: 0.85 (343,535 sf.)

FAR above Ground Level: 0.65 (262,703 sf.)

20 d.u./acre max. (185 d.u. max)

10 ft. min.

10 ft. min.

10 ft. min.

10 ft. min.

R.O.W. Width (85'-0")

Launch Trampoline Park (Amusement Cntr.): 22,326 sf./250 sf.= 89.3 ps. (Party Rooms): 1,863 sf./100 sf.= 18.63 ps. (Cafe): 707 sf./45 sf.= 15.71 ps. (Office): 517 sf./300 sf.= 1.72 ps.

(Storage): 432 sf./1,000 sf.= 0.43 ps.

Subtotal Parking Required = 88 ps.

Floor and Decor (Retail): 89,240 sf./250 sf.= 356.96 ps. (Per Zoning Code 77-139: must only meet 70%) Subtotal Parking Required = 250 ps.

> (1 Bed) 82 d.u. X 1 = 82 ps. (2 Bed) 81 d.u. X 2 = 162 ps.

(3 Bed) 22 d.u. X 2 = 44 ps.

(Visitor) 0.25 ps./1 d.u. = 46 ps.

Total Parking Required = 672 ps.

2% ESVE-Ready or ESVE-Installed = 14 ps.

10% of Parking Spaces = 34 b.r.

10% of Parking Spaces = 31 b.r.

Total Bicycle Spaces Required = 65 b.r.

Required = 9 Spaces

Over 50,000 s.f. (1 / building) = 2 Spaces

Total Loading Required = 11 Spaces

TRACT "A" OF "NORTON TIRE COMPANY", ACCORDING TO THE PLAT THEREOF RECORDED IN PLAT BOOK 127, AT PAGE 90, OF THE PUBLIC RECORDS OF DADE COUNTY, FLORIDA LESS:

TANGENT TO A LINE 2.00 FEET EAST OF AND PARALLEL TO THE WEST LINE OF SAID TRACT "A", AND TANGENT TO THE SOUTH LINE OF SAID TRACT "A".

LEGAL DESCRIPTION

Subtotal Parking Required = 334 ps.

(Per Zoning Code 77-139: must only meet 70%)

**BUILDING DISPOSITION LOT OCCUPATION** 

Lot Area (GROSS AREA)

Building Coverage Allowed

Open Space Required

Floor Area Ratio (FAR)

**BUILDING SETBACK** 

Interior Side (East)

Interior Side (North)

**BUILDING HEIGHT** 

Max. Height

PARKING

Front (NW 25th Street)

Side Street (NW 82nd Avenue)

Existing Phases

New Proposed (Multi-Family)

**ELECTRIC VEHICLE CHARGING** 

New Proposed (Multi-Family)

New Proposed (Multi-Family)

New Proposed (Multi-Family)

THE WESTERLY 2.00 FEET THEREOF; AND LESS:

**Total Bicycle Spaces** 

**Total Loading Spaces** 

VARIANCES

Parking Variance

**Total Parking** 

BICYCLE


Lot Width

**LEGACY AT DORAL** 

2525 NW 82ND AVENUE, DORAL, FL. 33122

**EWE WAREHOUSE INVESTMENT XXXII, LTD** 

SITE PLAN **SUBMITTAL** 

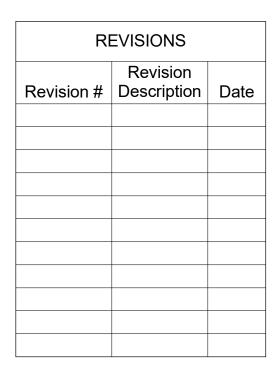


THESE DRAWINGS ARE THE PROPERTY OF CORWIL ARCHITECTS INC. UNLESS OTHERWISE PROVIDED FOR BY CONTRACT, THE CONTENTS OF THES DRAWINGS ARE CONFIDENTIAL AND SHALL NOT BE TRANSMITTED TO ANY OTHER PARTY EXCEPT AS AGREED TO BY THE ARCHITECT/ENGINEERS.

05/27/2022 2021-21 JOB No.: DRAWN BY: SR/DA APPR BY: **AMC** PRINTED:

3/2/2023 3:33:05 PM

SHEET NUMBER:

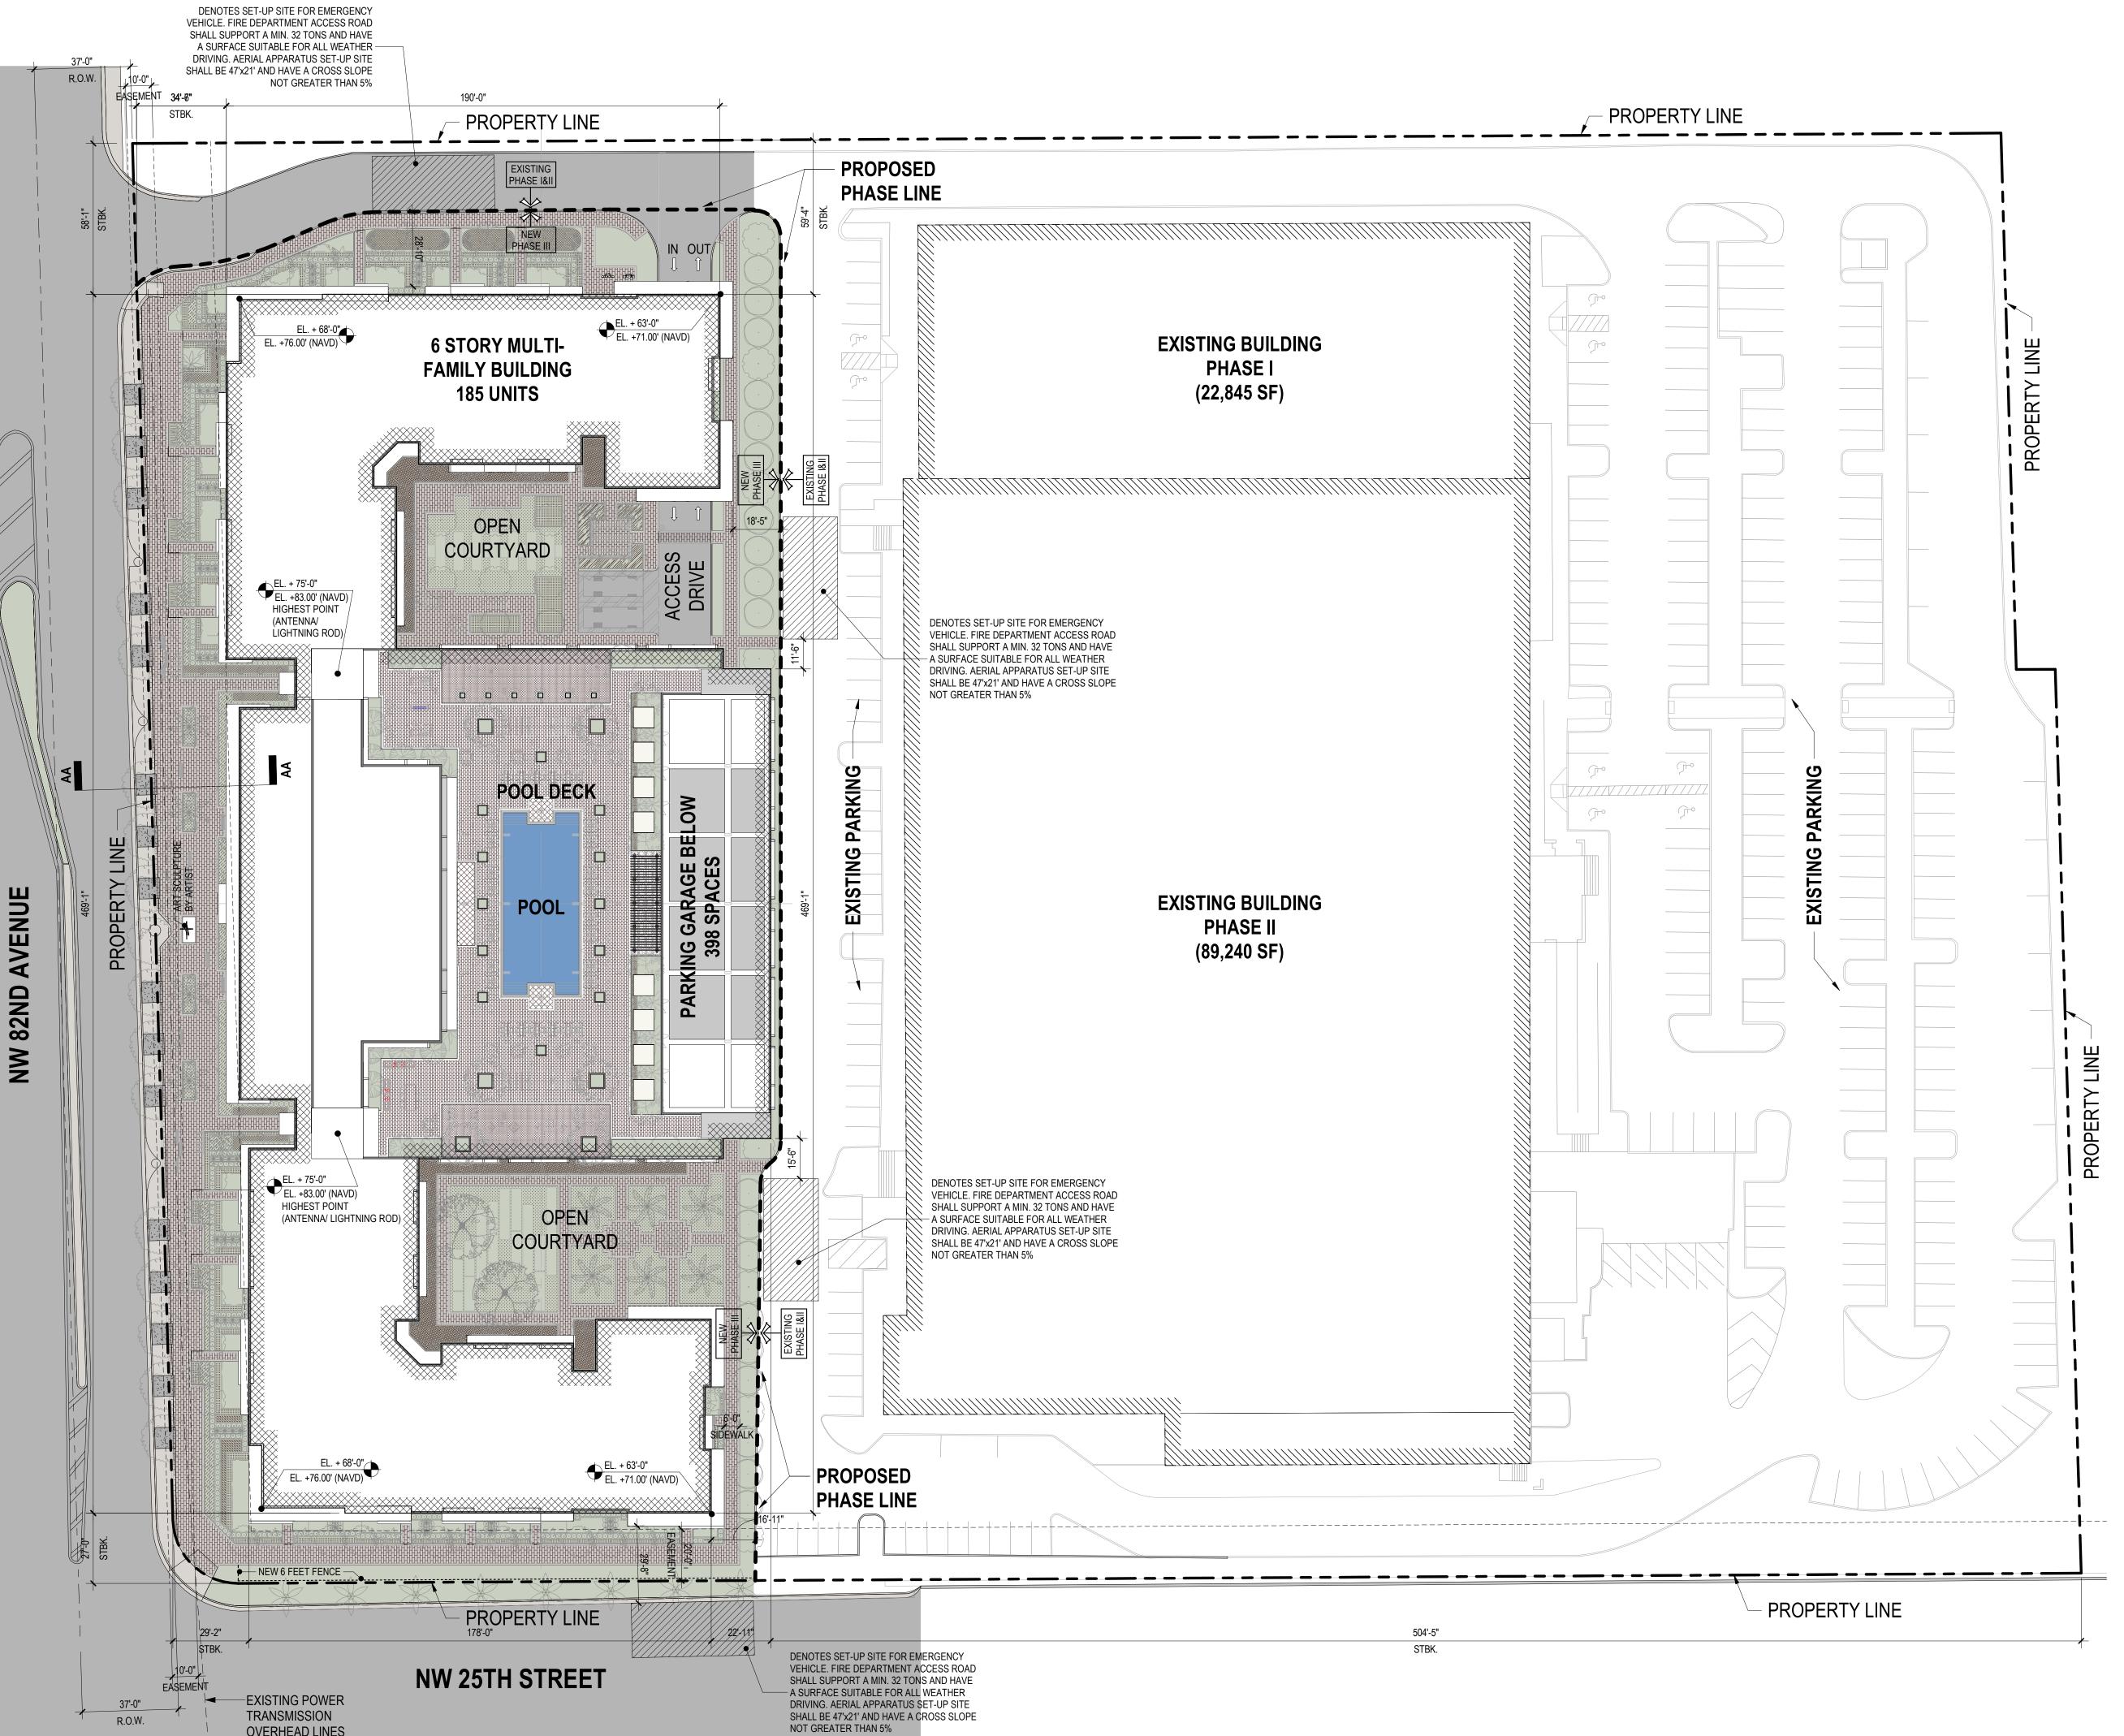

PROPOSED FLOOR AREA BREAKDOWN		
LEVEL	AREA (SF)	
GROUND LEVEL	69,915	
2ND LEVEL	63,402	
3RD LEVEL	71,700	
4TH LEVEL	65,532	
5TH LEVEL	38,568	
6TH LEVEL	44,821	
TOTAL	353,938	

**OVERHEAD LINES** 

EXISTING FLOOR AREA BREAKDOWN	
PHASE I (SF)	PHASE II (SF)
22,845	89,240
TOTAL:	112,085


SITE PLAN SCALE: 1" = 30'-0"

# **FOOTPRINT LEGEND** DENOTES PROPOSED 6 STORY BUILDING DENOTES EXISTING BUILDING

# SITE LEGEND STREET PAVEMENT CONCRETE SIDEWALKS GREEN AREAS

# **SUSTAINABILITY STANDARD**

NEW BUILDINGS MUST BE DESIGNED TO MEET THE NATIONALLY RECOGNIZED GREEN CERTIFICATION PROGRAMS SUCH AS GREEN CERTIFICATION STANDARDS OF THE FLORIDA GREEN BUILDING COALITION (FGBC), THE LEADERSHIP IN ENERGY AND ENVIRONMENTAL DESIGN (LEED), NATIONAL ASSOCIATION OF HOME BUILDER'S, NATIONAL GREEN BUILDING STANDARD, OR GREEN GLOBES SYSTEM. ALL BUILDINGS AND PROJECTS INCORPORATING THE GREEN STANDARDS AND CERTIFICATIONS REFERENCED HEREIN TO WILL BE ELIGIBLE FOR THE INCENTIVES SPECIFIED IN THIS CHAPTER REGARDLESS OF SIZE.

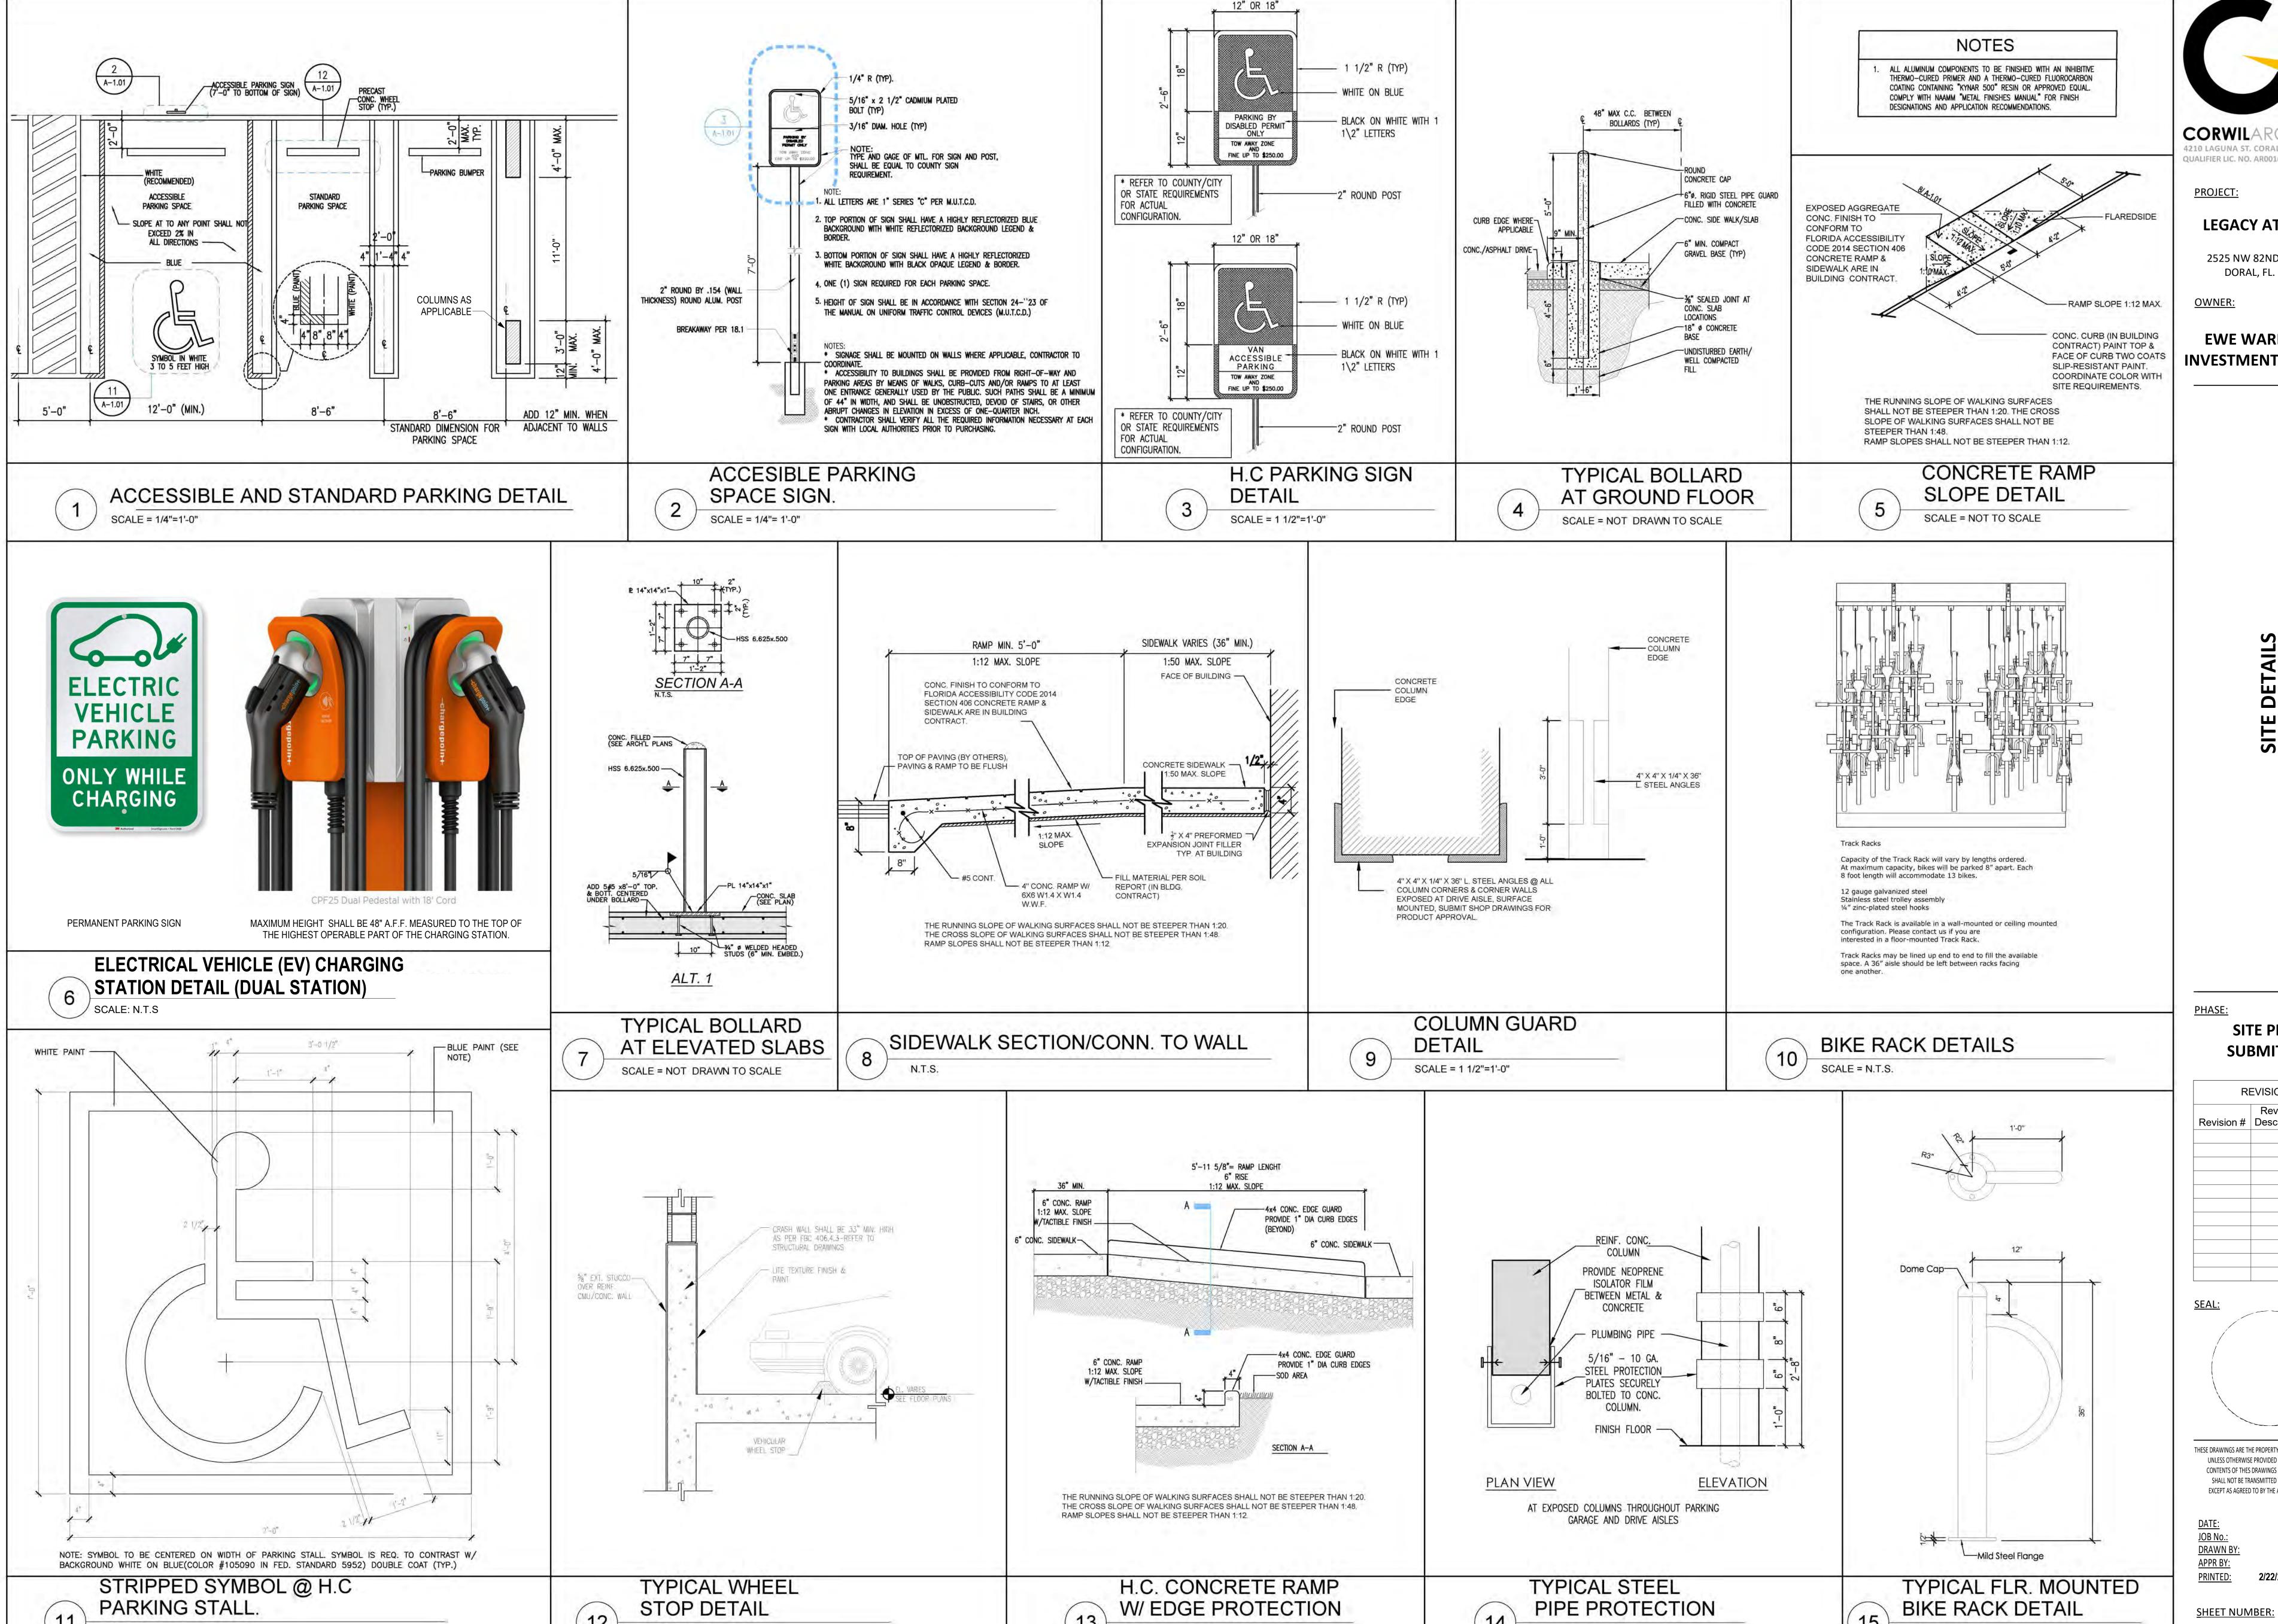

SCALE = 3/4" = 1'-0"

SCALE = 1" = 1'-0"

SCALE = 1/2"=1'-0"

SCALE = 3/4"= 1'-0"

QUALIFIER LIC. NO. AR0016003 T:305.448.7383

**LEGACY AT DORAL** 

2525 NW 82ND AVENUE, DORAL, FL. 33122

**EWE WAREHOUSE INVESTMENT XXXII, LTD** 

**SITE PLAN SUBMITTAL** 



THESE DRAWINGS ARE THE PROPERTY OF CORWIL ARCHITECTS INC UNLESS OTHERWISE PROVIDED FOR BY CONTRACT, THE CONTENTS OF THES DRAWINGS ARE CONFIDENTIAL AND SHALL NOT BE TRANSMITTED TO ANY OTHER PARTY EXCEPT AS AGREED TO BY THE ARCHITECT/ENGINEER

05/27/2022 2021-21 SR/DA 2/22/2023 7:44:09 PM


SCALE = NTS


A-1.01

QUALIFIER LIC. NO. AR0016003 T:305.448.7383

PROJECT:



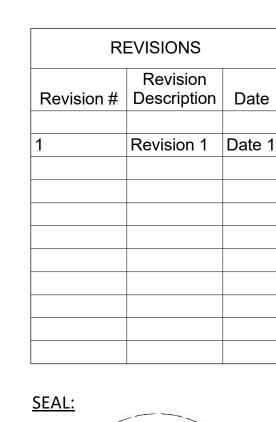

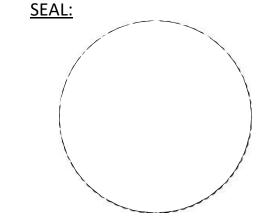

THESE DRAWINGS ARE THE PROPERTY OF CORWIL ARCHITECTS INC. UNLESS OTHERWISE PROVIDED FOR BY CONTRACT, THE CONTENTS OF THES DRAWINGS ARE CONFIDENTIAL AND SHALL NOT BE TRANSMITTED TO ANY OTHER PARTY EXCEPT AS AGREED TO BY THE ARCHITECT/ENGINEERS.

DATE:

JOB No.:


DRAWN BY:

APPR BY:

PRINTED: 05/27/2022 2021-21 3/2/2023 2:37:48 PM


SR/DA

SHEET NUMBER:

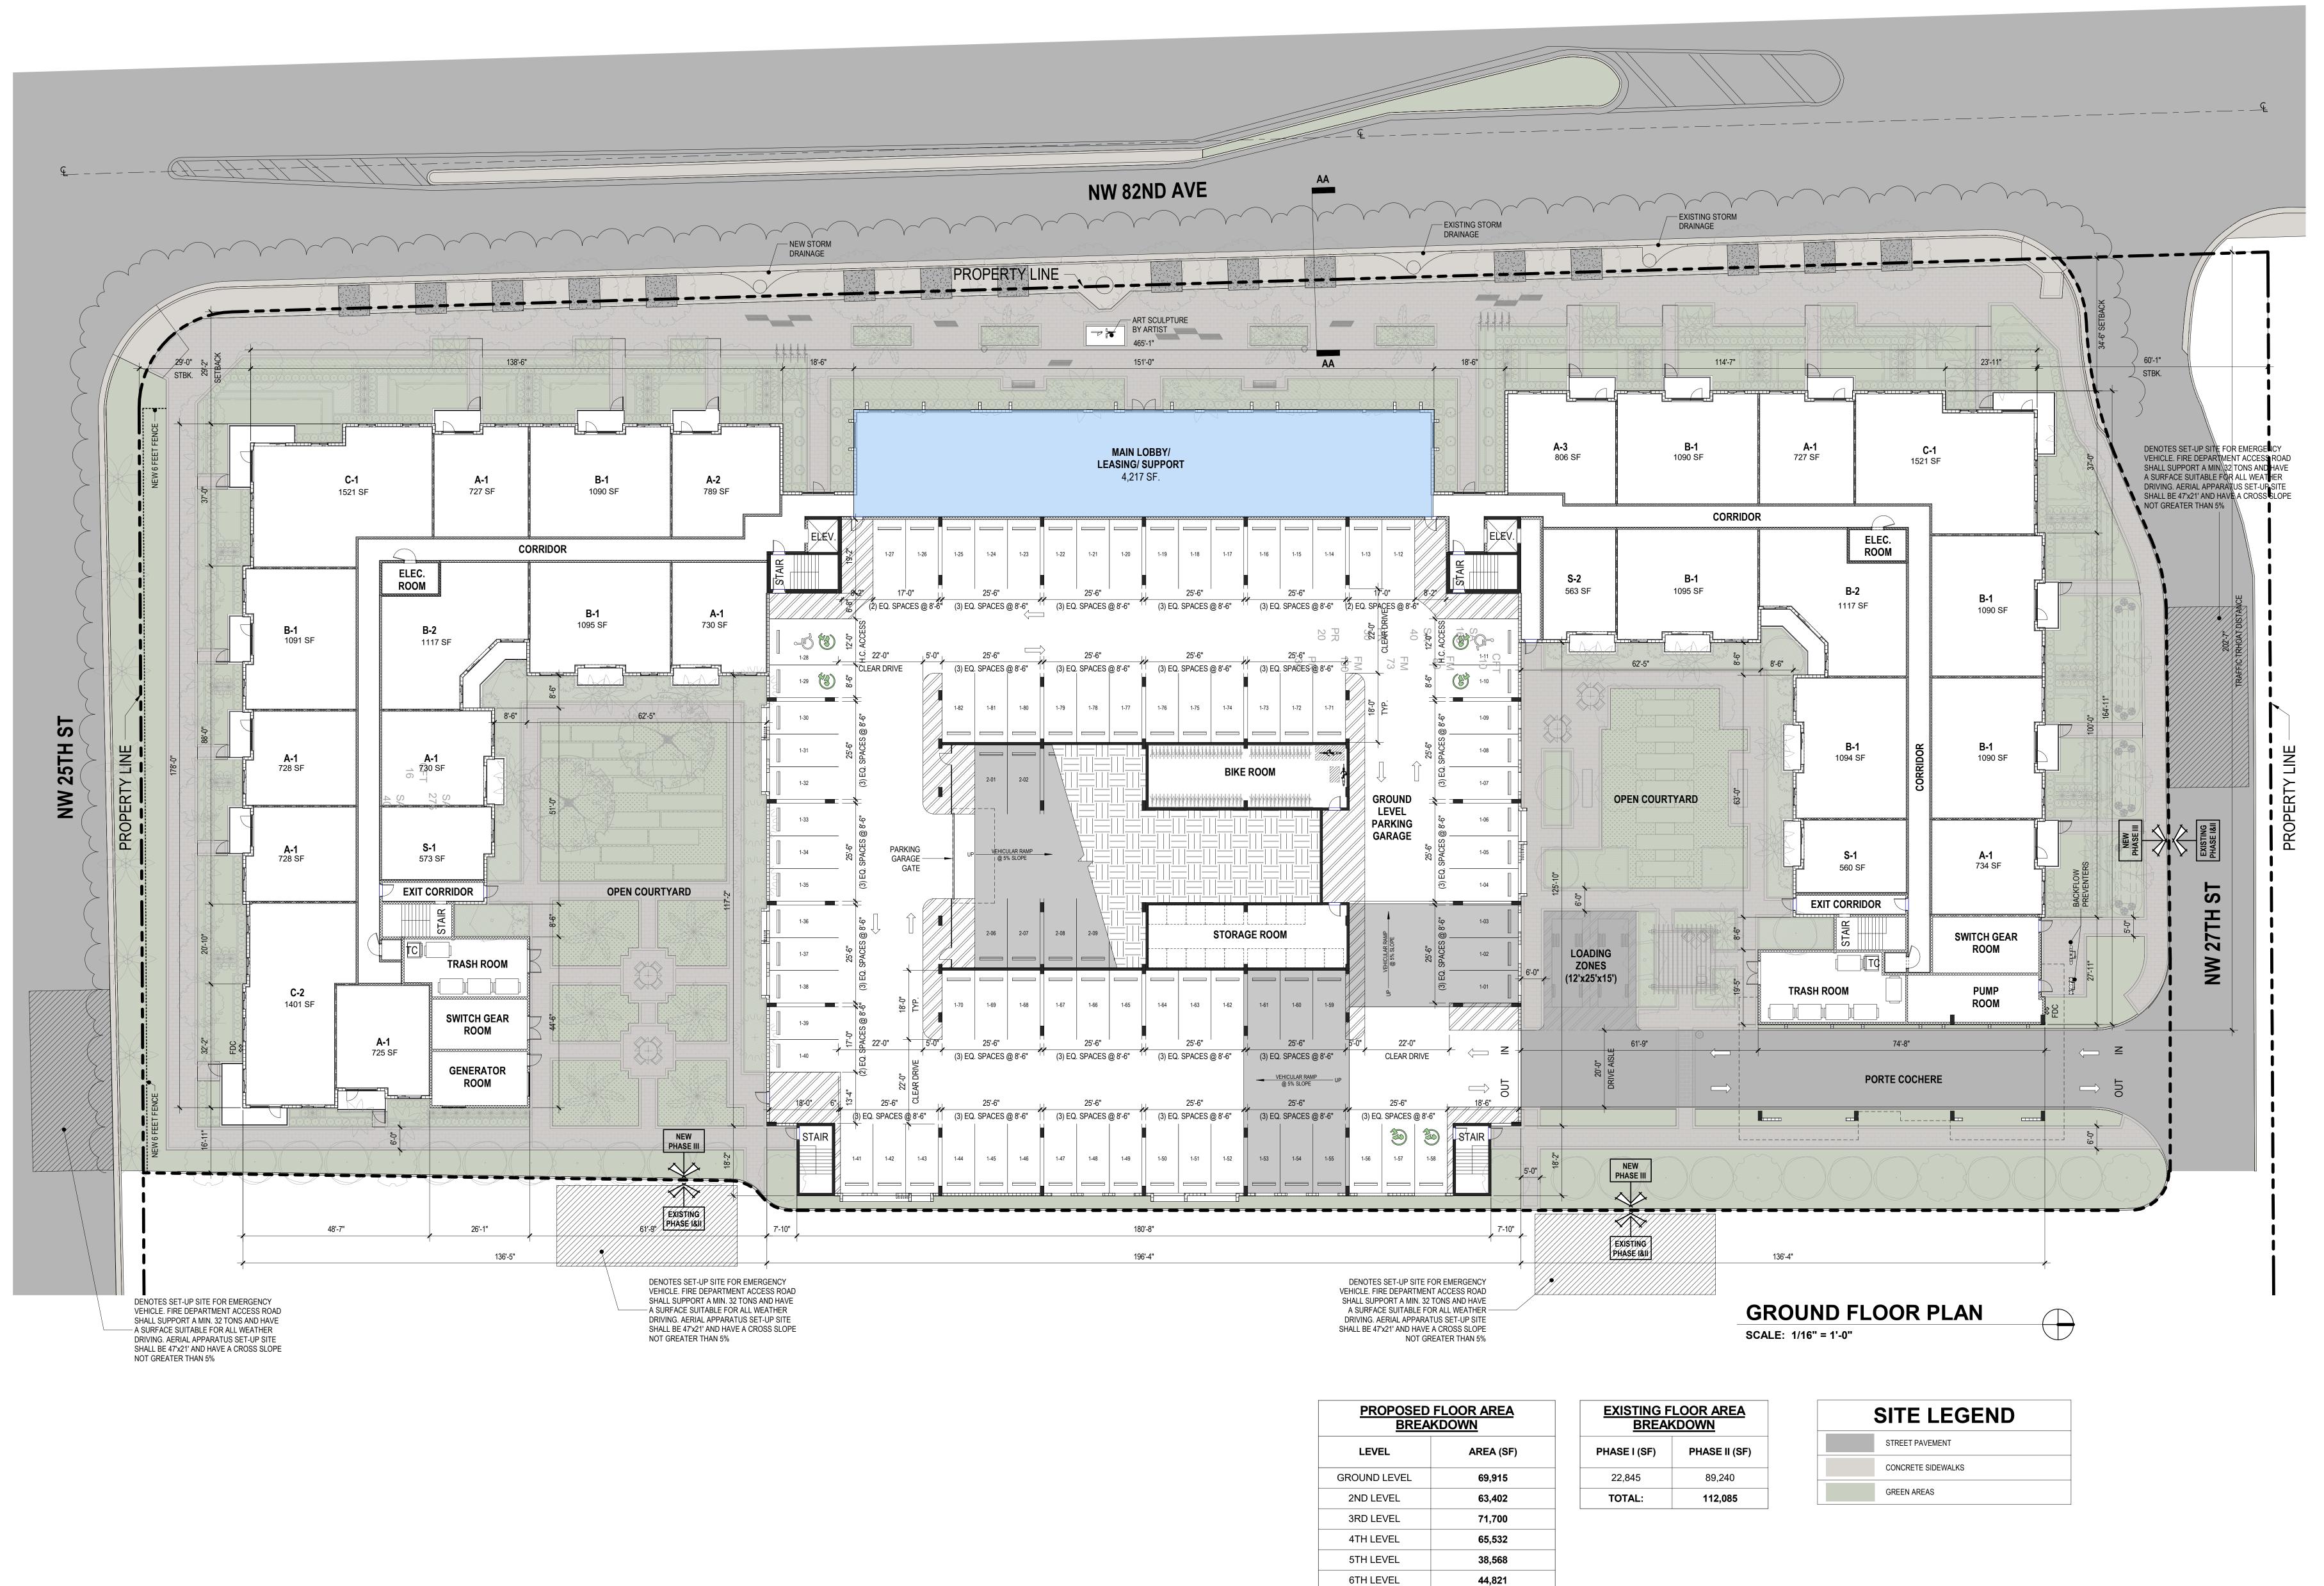

**TOTAL** 

353,938

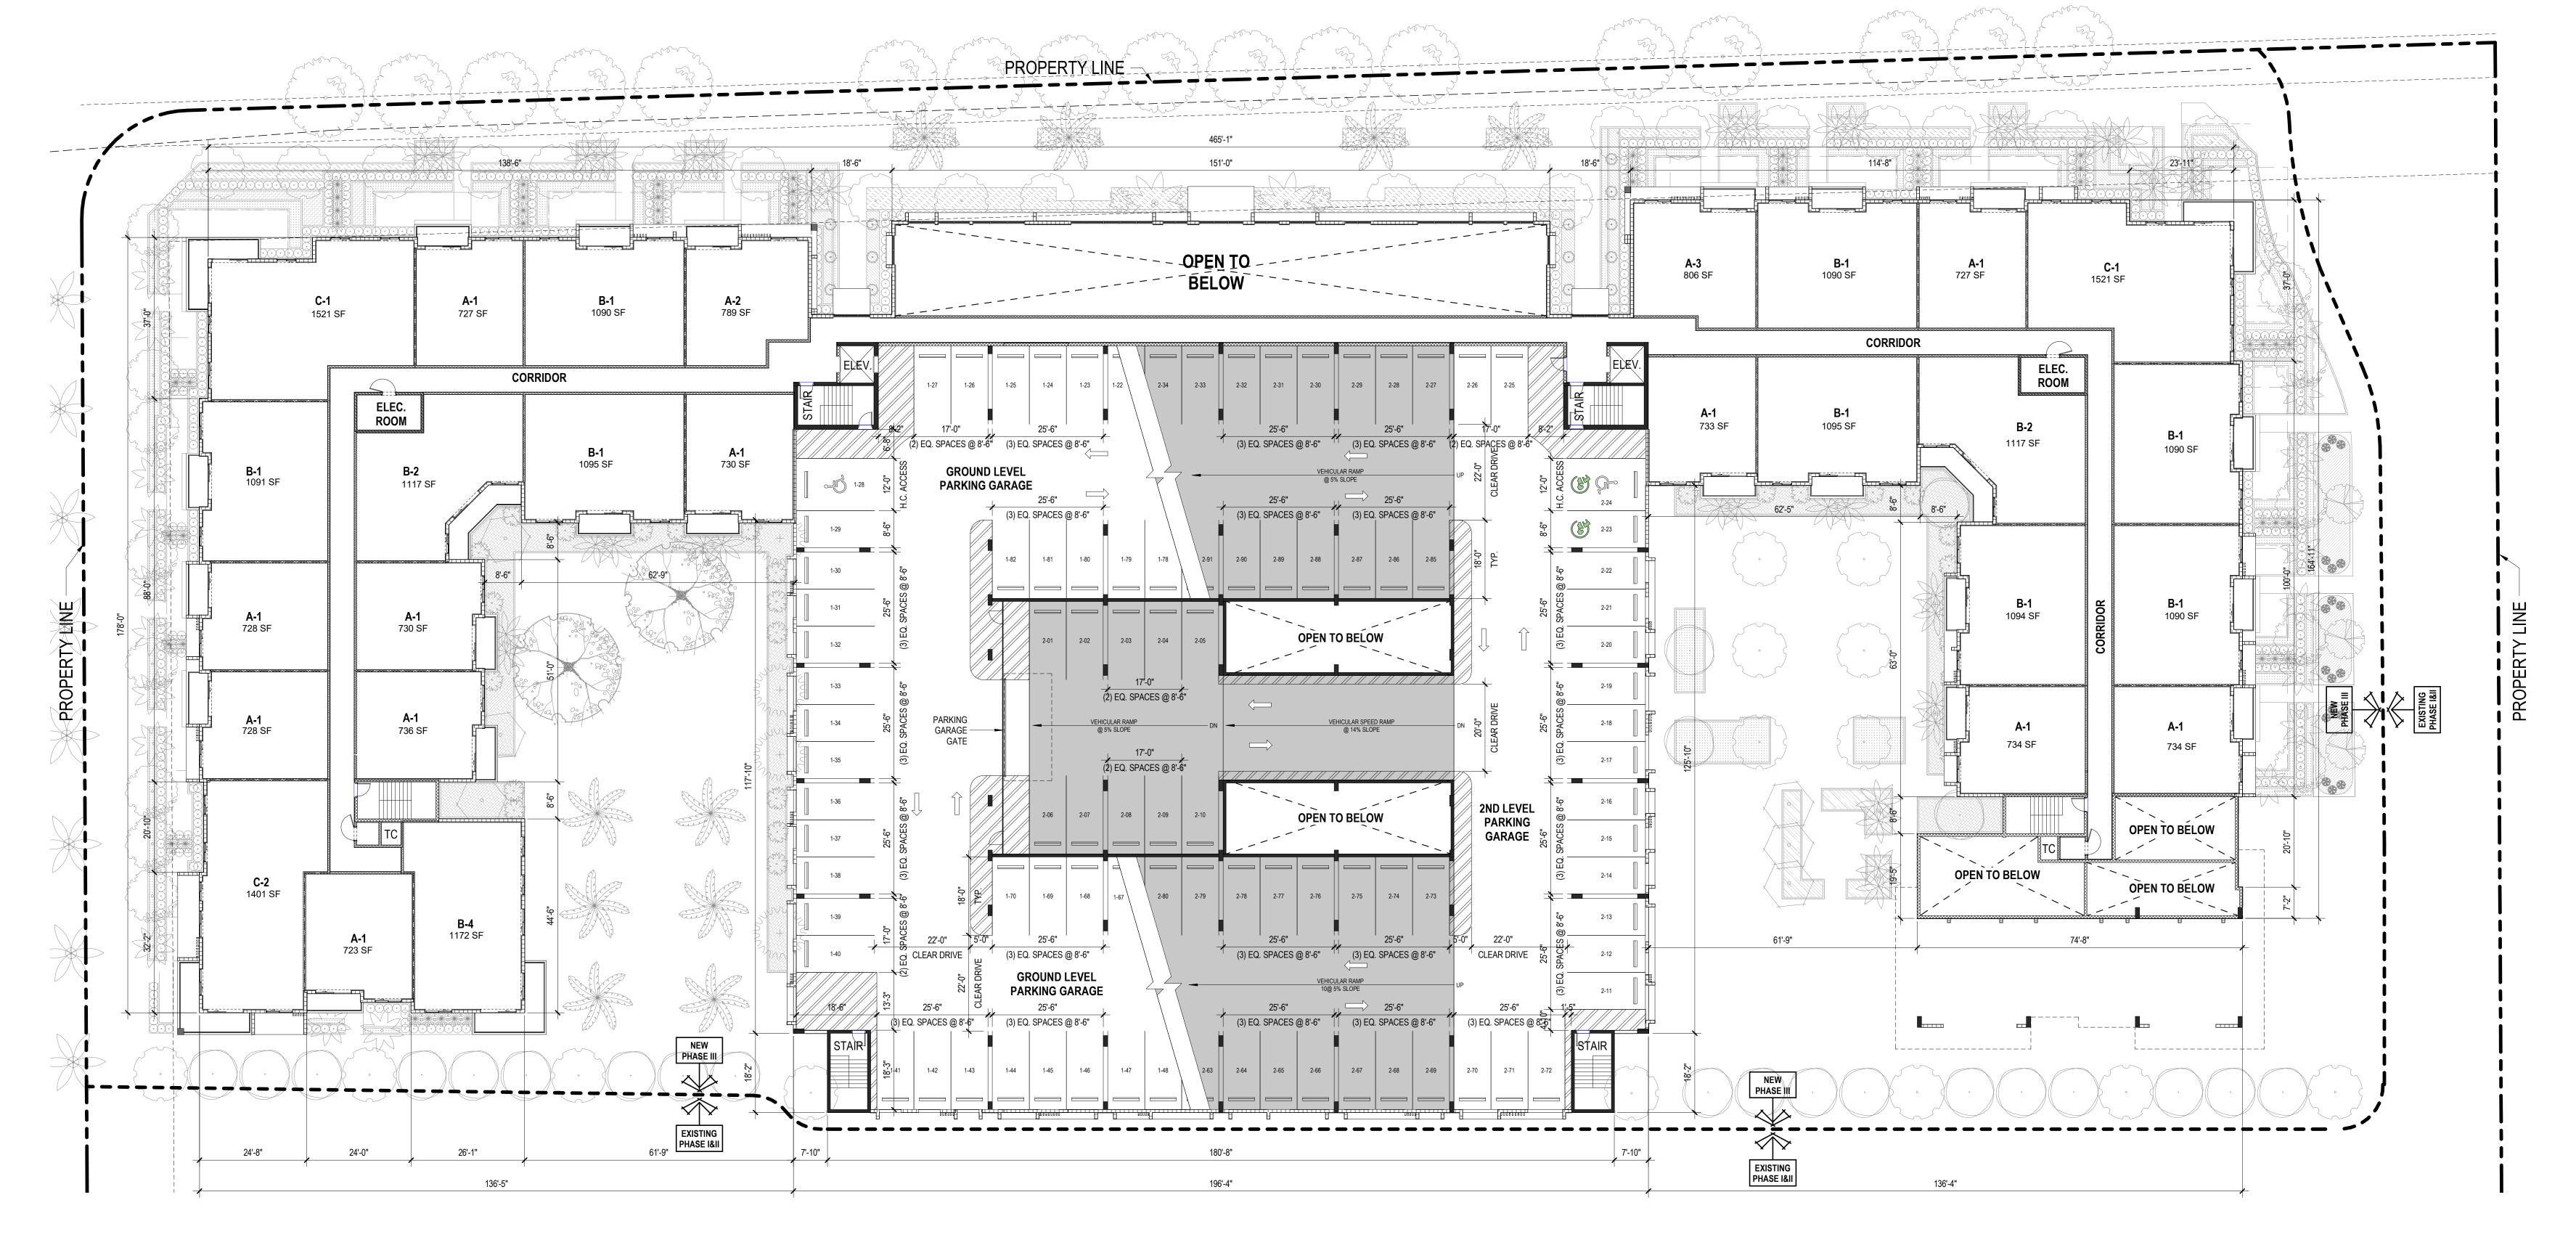



PROPOSED FLOOR AREA BREAKDOWN		
LEVEL	AREA (SF)	
GROUND LEVEL	69,915	
2ND LEVEL	63,402	
3RD LEVEL	71,700	
4TH LEVEL	65,532	
5TH LEVEL	38,568	
6TH LEVEL	44,821	
TOTAL	353,938	



**LEGACY AT DORAL** 

2525 NW 82ND AVENUE, DORAL, FL. 33122


OWNER:

EWE WAREHOUSE INVESTMENT XXXII, LTD

PHASE:

SITE PLAN
SUBMITTAL

RI	EVISIONS	
Revision #	Revision Description	Date

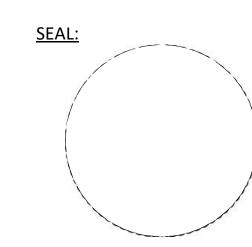

THESE DRAWINGS ARE THE PROPERTY OF CORWIL ARCHITECTS INC.
UNLESS OTHERWISE PROVIDED FOR BY CONTRACT, THE
CONTENTS OF THES DRAWINGS ARE CONFIDENTIAL AND
SHALL NOT BE TRANSMITTED TO ANY OTHER PARTY
EXCEPT AS AGREED TO BY THE ARCHITECT/ENGINEERS.

 DATE:
 05/27/2022

 JOB No.:
 2021-21


 DRAWN BY:
 SR/DA

 APPR BY:
 AMC

 PRINTED:
 2/22/2023 7:44:47 PM

SHEET NUMBER:

A-2.02

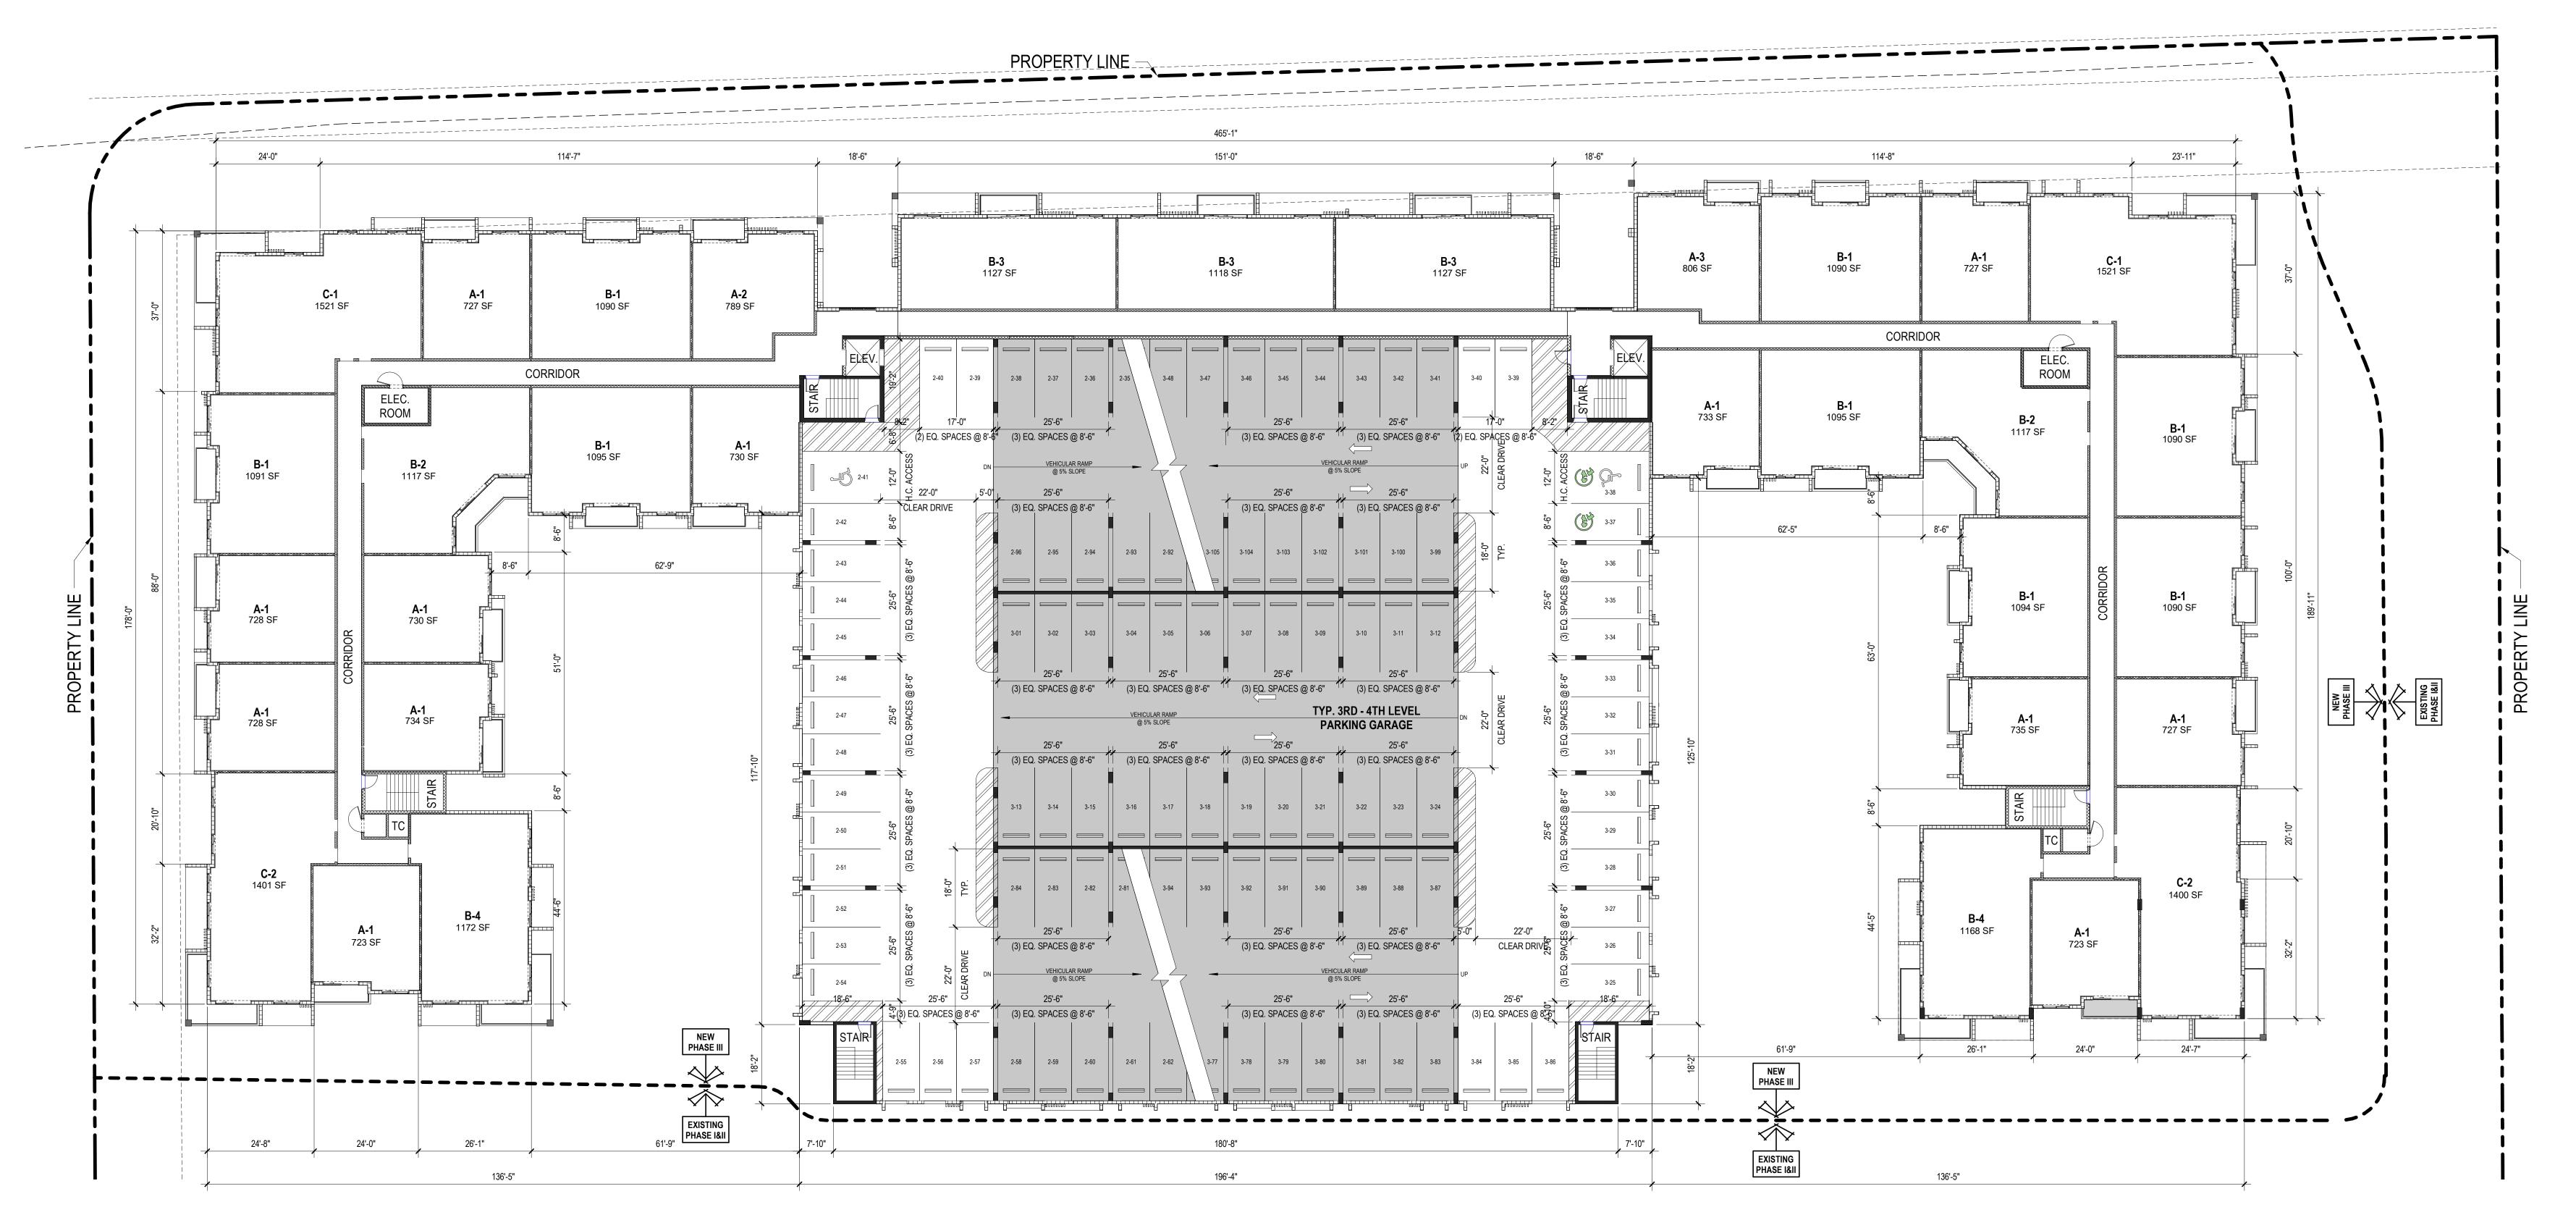



PROPOSED FLOOR AREA BREAKDOWN		
GROUND LEVEL	69,915	
2ND LEVEL	63,402	
3RD LEVEL	71,700	
4TH LEVEL	65,532	
5TH LEVEL	38,568	
6TH LEVEL	44,821	
TOTAL	353,938	



**LEGACY AT DORAL** 


2525 NW 82ND AVENUE, DORAL, FL. 33122

OWNER:

**EWE WAREHOUSE** INVESTMENT XXXII, LTD


**SITE PLAN SUBMITTAL** 


REVISIONS		
Revision #	Revision Description	Date

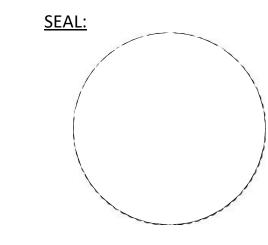

THESE DRAWINGS ARE THE PROPERTY OF CORWIL ARCHITECTS INC. UNLESS OTHERWISE PROVIDED FOR BY CONTRACT, THE CONTENTS OF THES DRAWINGS ARE CONFIDENTIAL AND SHALL NOT BE TRANSMITTED TO ANY OTHER PARTY EXCEPT AS AGREED TO BY THE ARCHITECT/ENGINEERS.

2021-21 DRAWN BY: 2/22/2023 7:44:58 PM

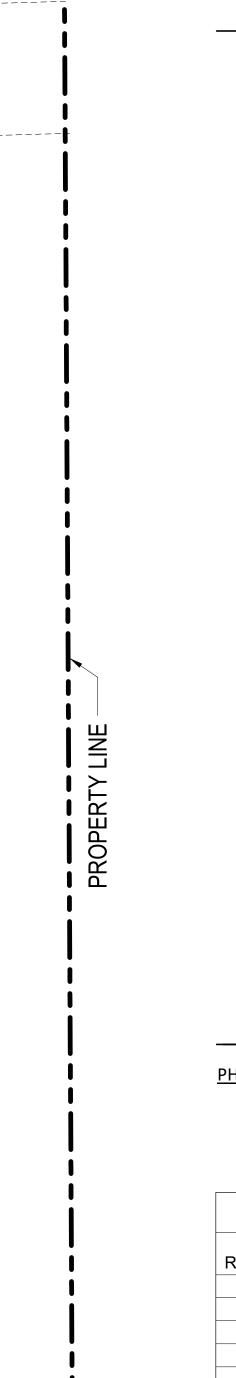

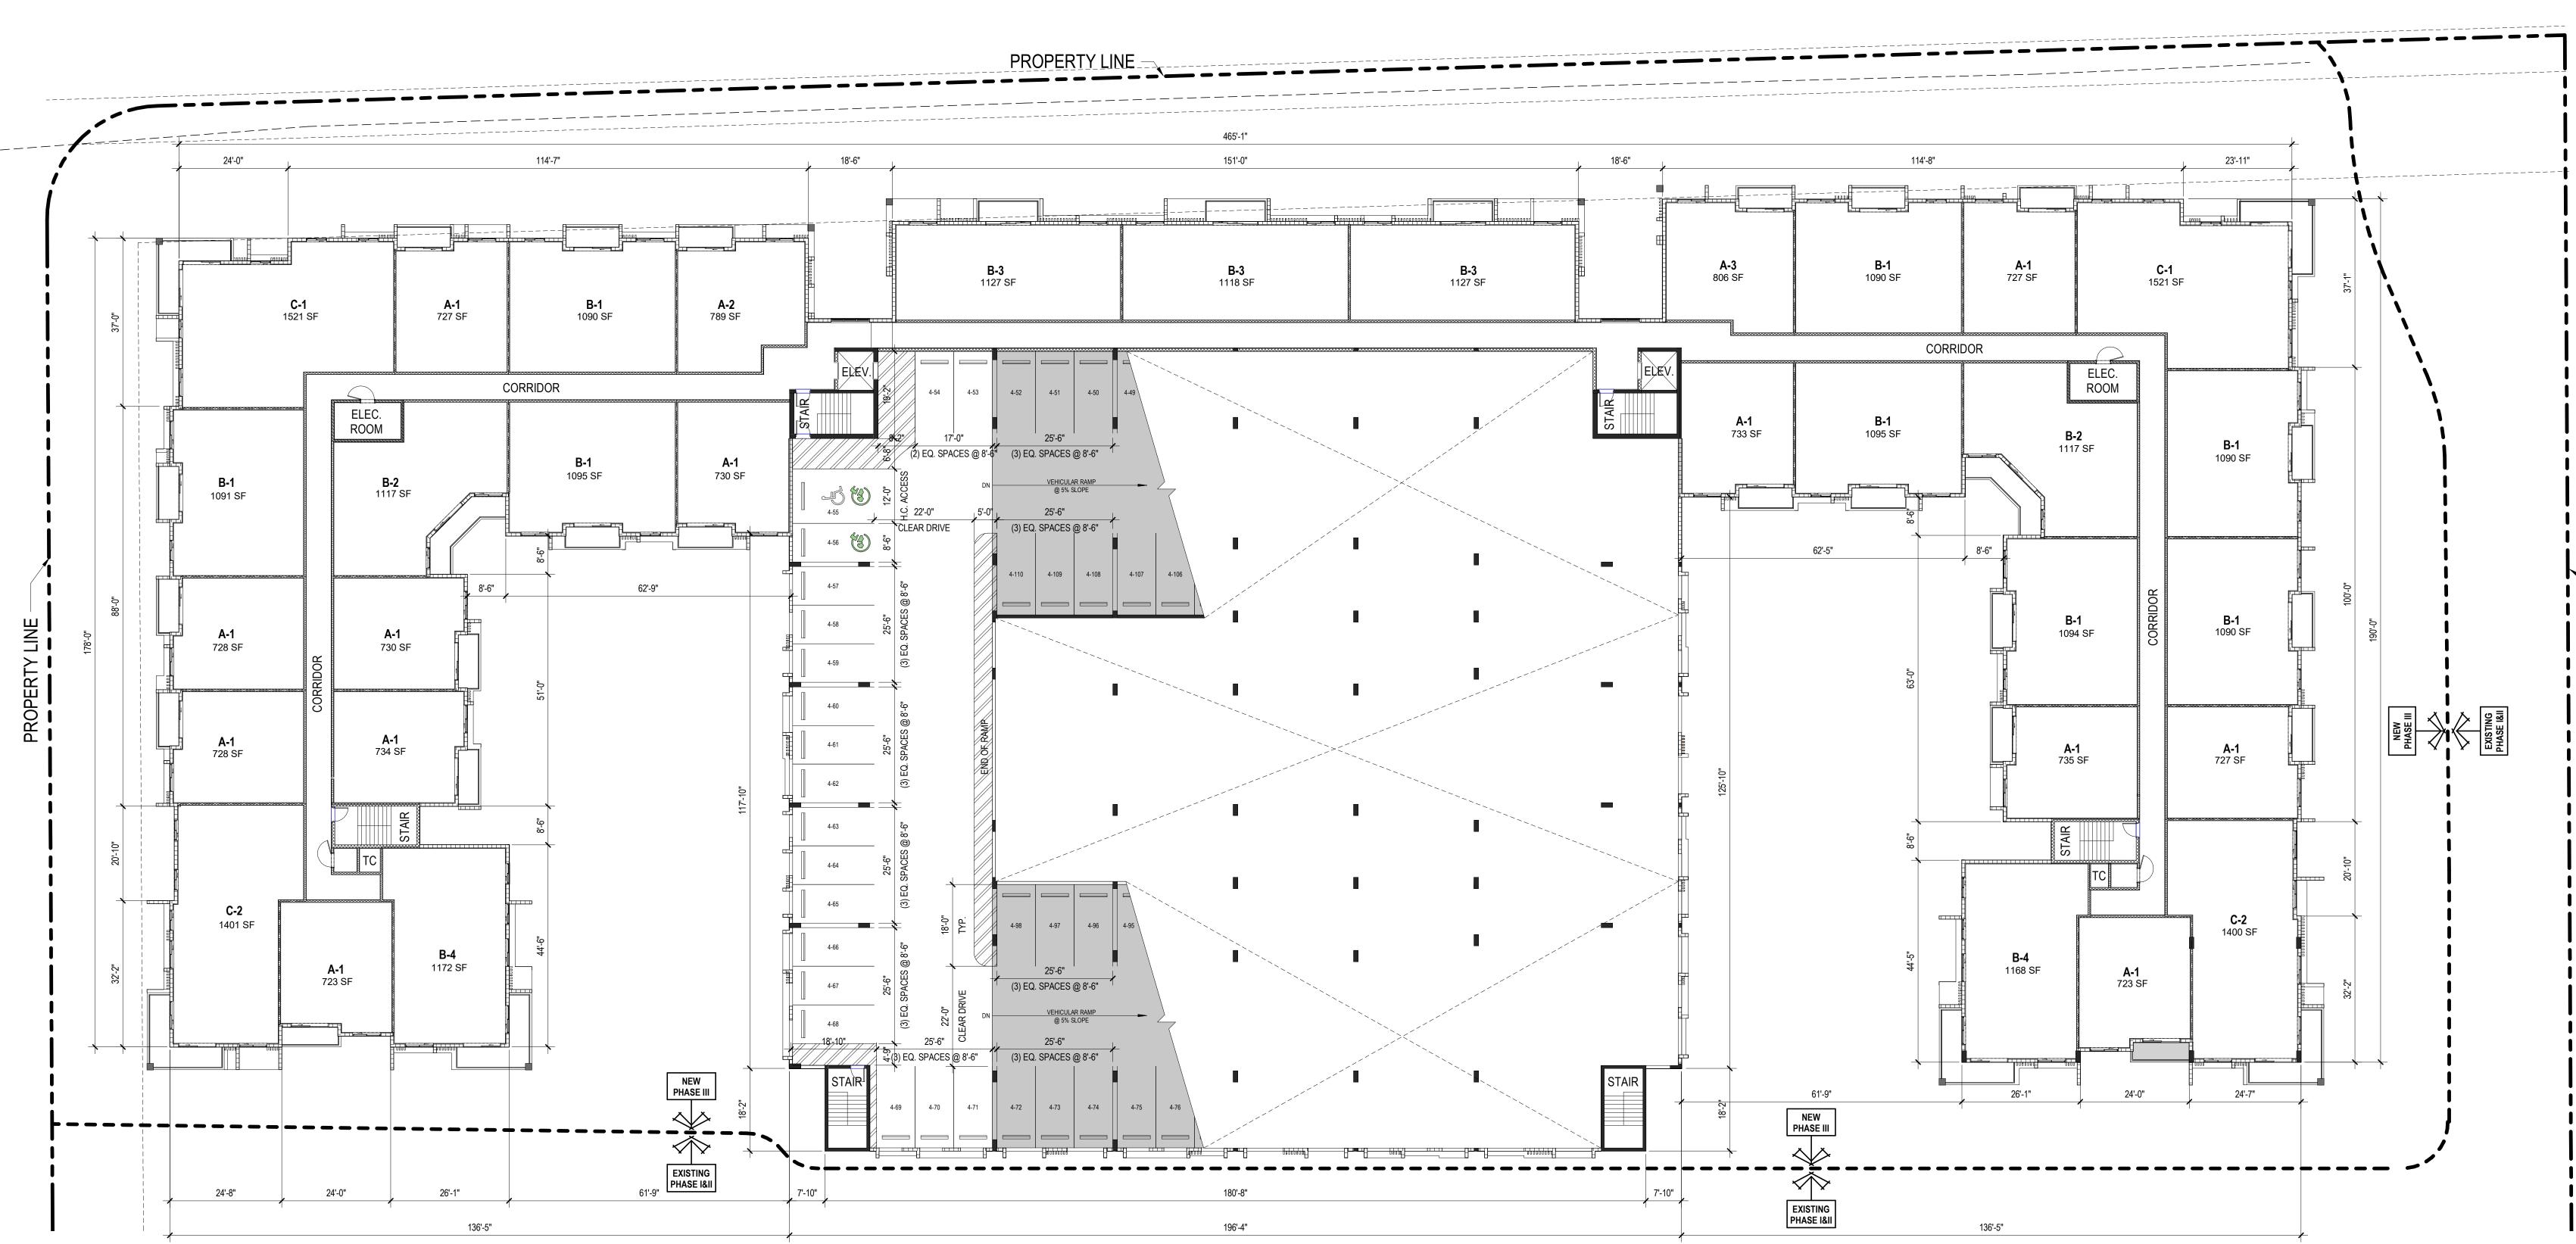

# 5TH LEVEL FLOOR PLAN SCALE: 1/16" = 1'-0"

PROPOSED FLOOR AREA BREAKDOWN		
LEVEL	AREA (SF)	
GROUND LEVEL	69,915	
2ND LEVEL	63,402	
3RD LEVEL	71,700	
4TH LEVEL	65,532	
5TH LEVEL	38,568	
6TH LEVEL	44,821	
TOTAL	353,938	

PROJECT:

**LEGACY AT DORAL** 

CORWILARCHITECTS

QUALIFIER LIC. NO. AR0016003 T:305.448.7383

2525 NW 82ND AVENUE, DORAL, FL. 33122


OWNER:

EWE WAREHOUSE INVESTMENT XXXII, LTD

DHVCE

SITE PLAN SUBMITTAL

	D i - i	
Revision #	Revision Description	Date
	•	

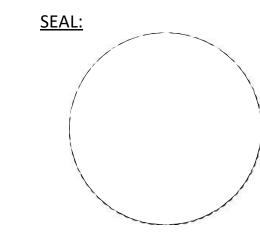

THESE DRAWINGS ARE THE PROPERTY OF CORWIL ARCHITECTS INC.

UNLESS OTHERWISE PROVIDED FOR BY CONTRACT, THE

CONTENTS OF THES DRAWINGS ARE CONFIDENTIAL AND

SHALL NOT BE TRANSMITTED TO ANY OTHER PARTY

EXCEPT AS AGREED TO BY THE ARCHITECT/ENGINEERS.

 DATE:
 05/27/2022

 JOB No.:
 2021-21


 DRAWN BY:
 SR/DA

 APPR BY:
 AMC

 PRINTED:
 2/22/2023 7:45:07 PM

SHEET NUMBER:

A-2.04

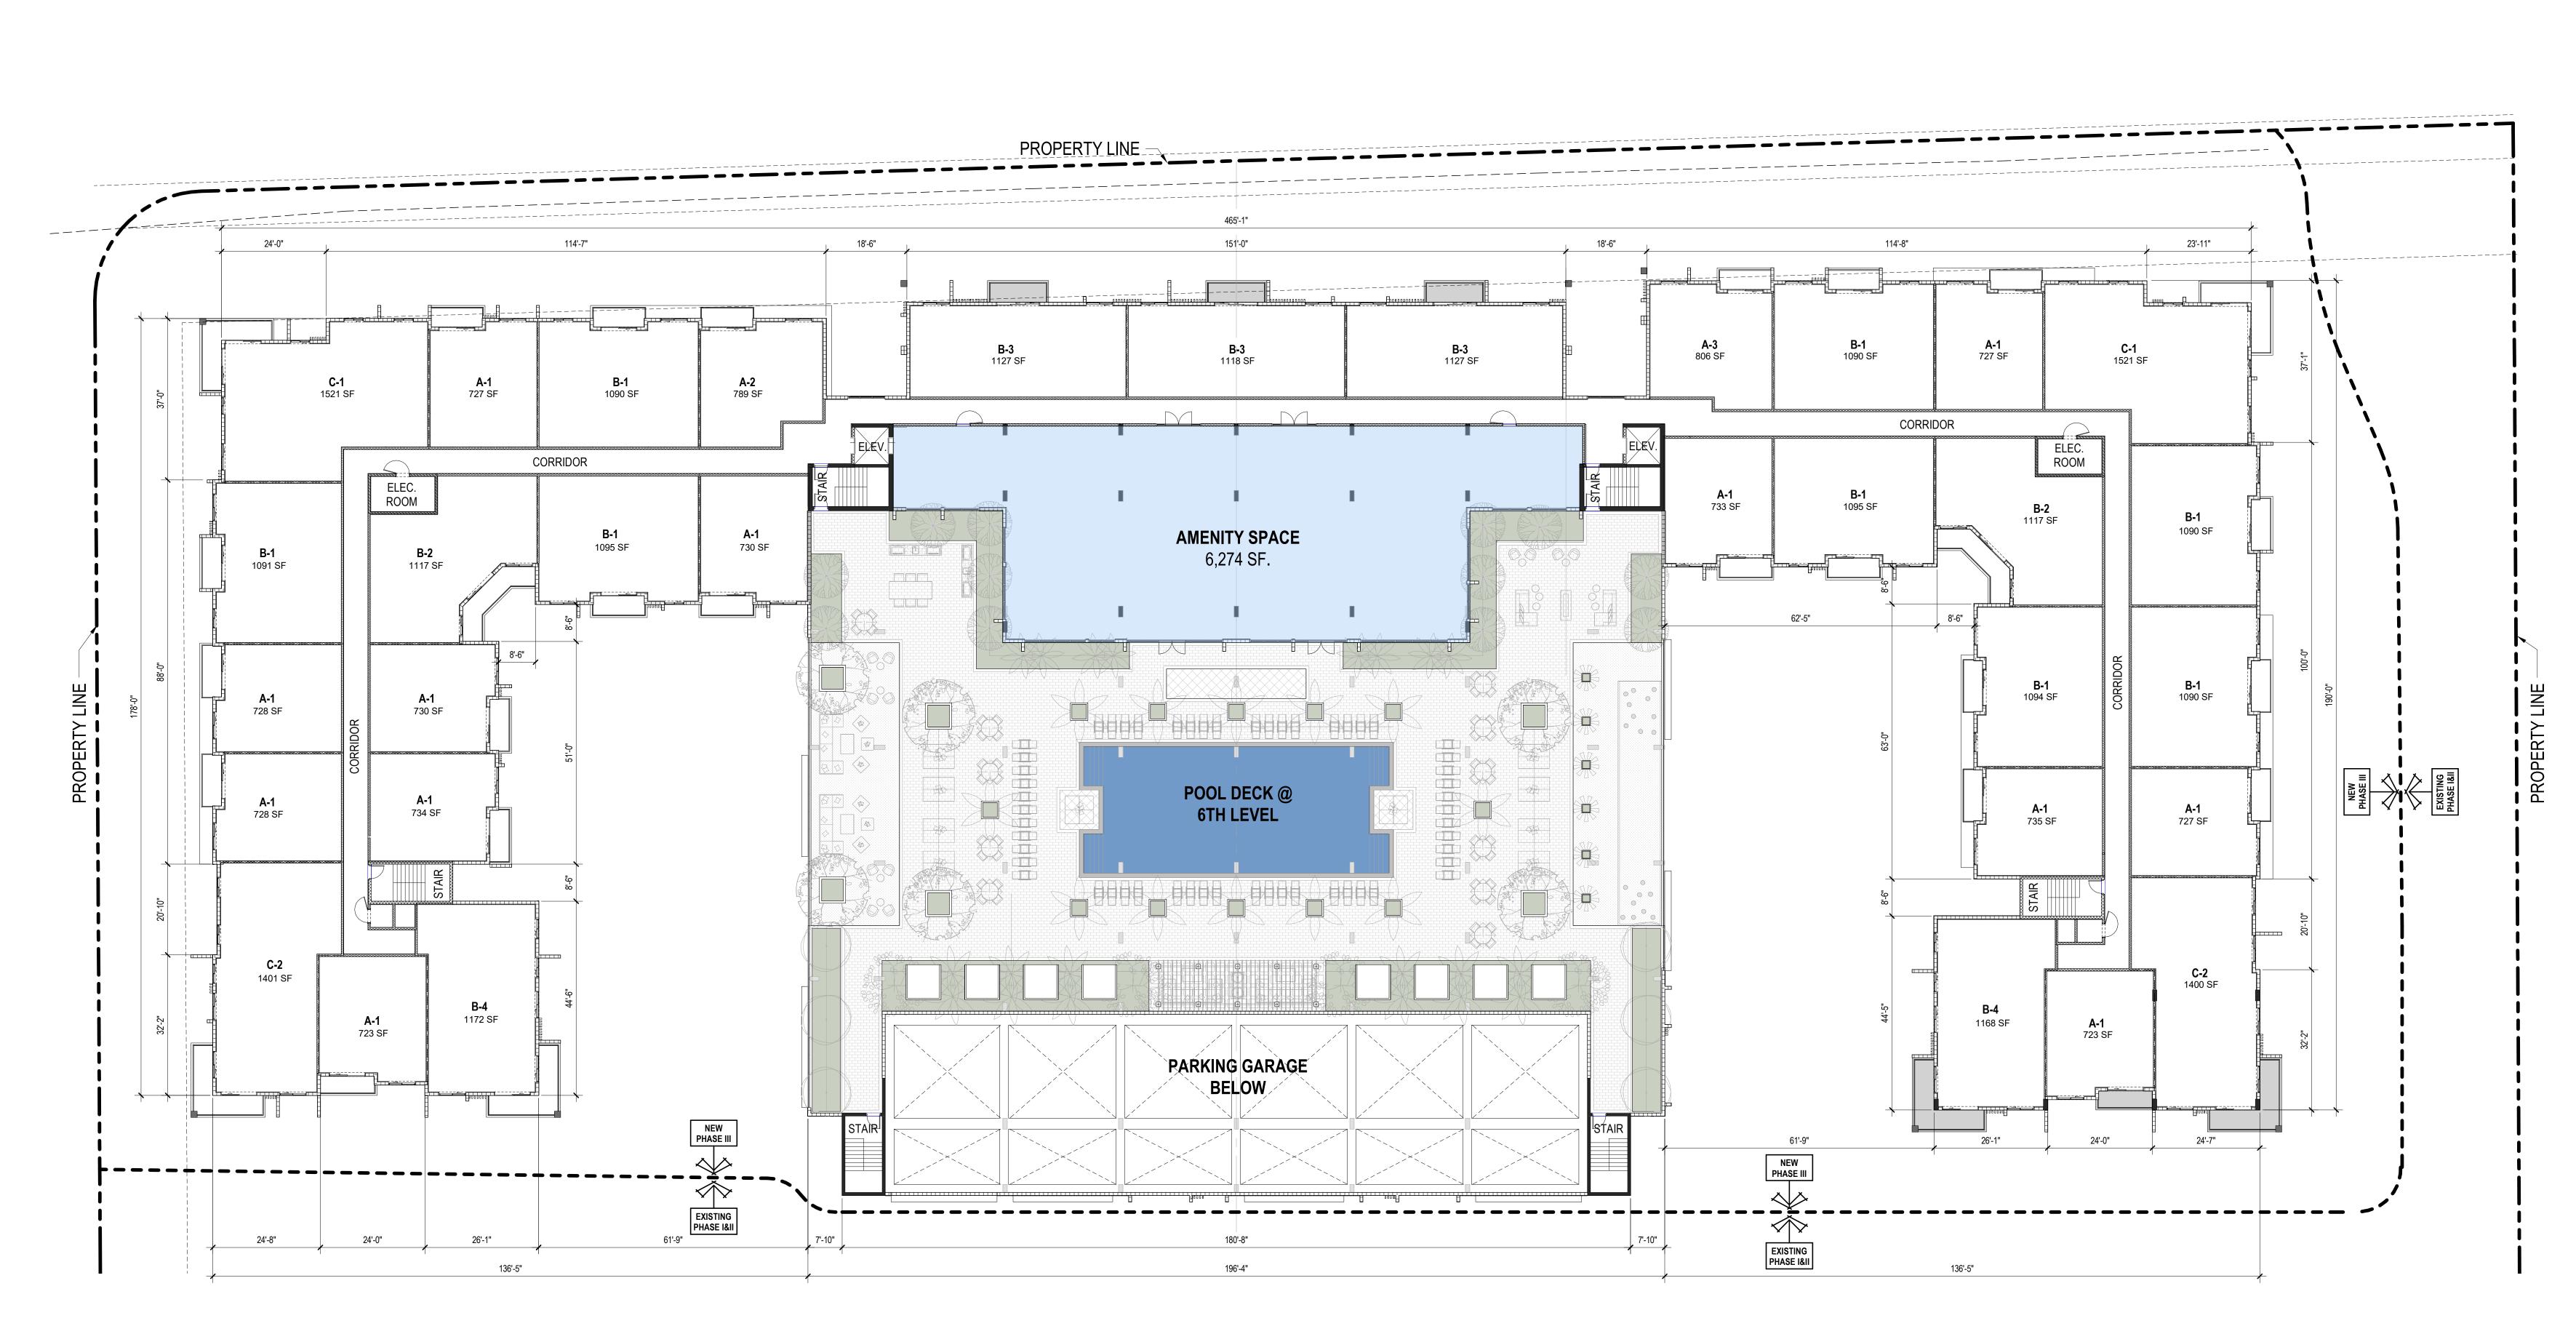



PROPOSED FLOOR AREA BREAKDOWN		
LEVEL	AREA (SF)	
GROUND LEVEL	69,915	
2ND LEVEL	63,402	
3RD LEVEL	71,700	
4TH LEVEL	65,532	
5TH LEVEL	38,568	
6TH LEVEL	44,821	
TOTAL	353,938	



**LEGACY AT DORAL** 


2525 NW 82ND AVENUE, DORAL, FL. 33122

OWNER:

EWE WAREHOUSE INVESTMENT XXXII, LTD

SITE PLAN
SUBMITTAL

REVISIONS		
Revision #	Revision Description	Date

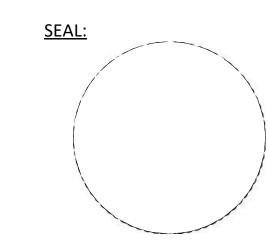

THESE DRAWINGS ARE THE PROPERTY OF CORWIL ARCHITECTS INC.
UNLESS OTHERWISE PROVIDED FOR BY CONTRACT, THE
CONTENTS OF THES DRAWINGS ARE CONFIDENTIAL AND
SHALL NOT BE TRANSMITTED TO ANY OTHER PARTY
EXCEPT AS AGREED TO BY THE ARCHITECT/ENGINEERS.

 DATE:
 05/27/2022

 JOB No.:
 2021-21


 DRAWN BY:
 SR/DA


 APPR BY:
 AMC

 PRINTED:
 2/22/2023 7:45:18 PM

SHEET NUMBE

A-2.05

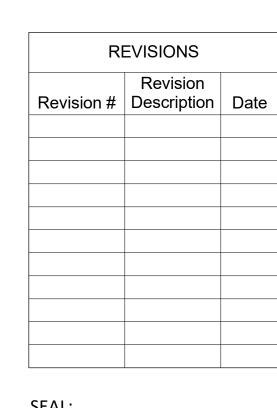

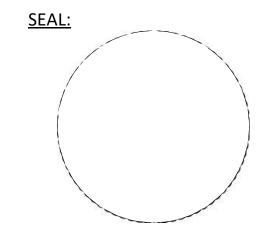


THESE DRAWINGS ARE THE PROPERTY OF CORWIL ARCHITECTS INC. UNLESS OTHERWISE PROVIDED FOR BY CONTRACT, THE CONTENTS OF THES DRAWINGS ARE CONFIDENTIAL AND SHALL NOT BE TRANSMITTED TO ANY OTHER PARTY EXCEPT AS AGREED TO BY THE ARCHITECT/ENGINEERS.

<u>DATE:</u> JOB No.: 05/27/2022 DRAWN BY: PRINTED:

2021-21 SR/DA 2/22/2023 7:45:27 PM

SHEET NUMBER:

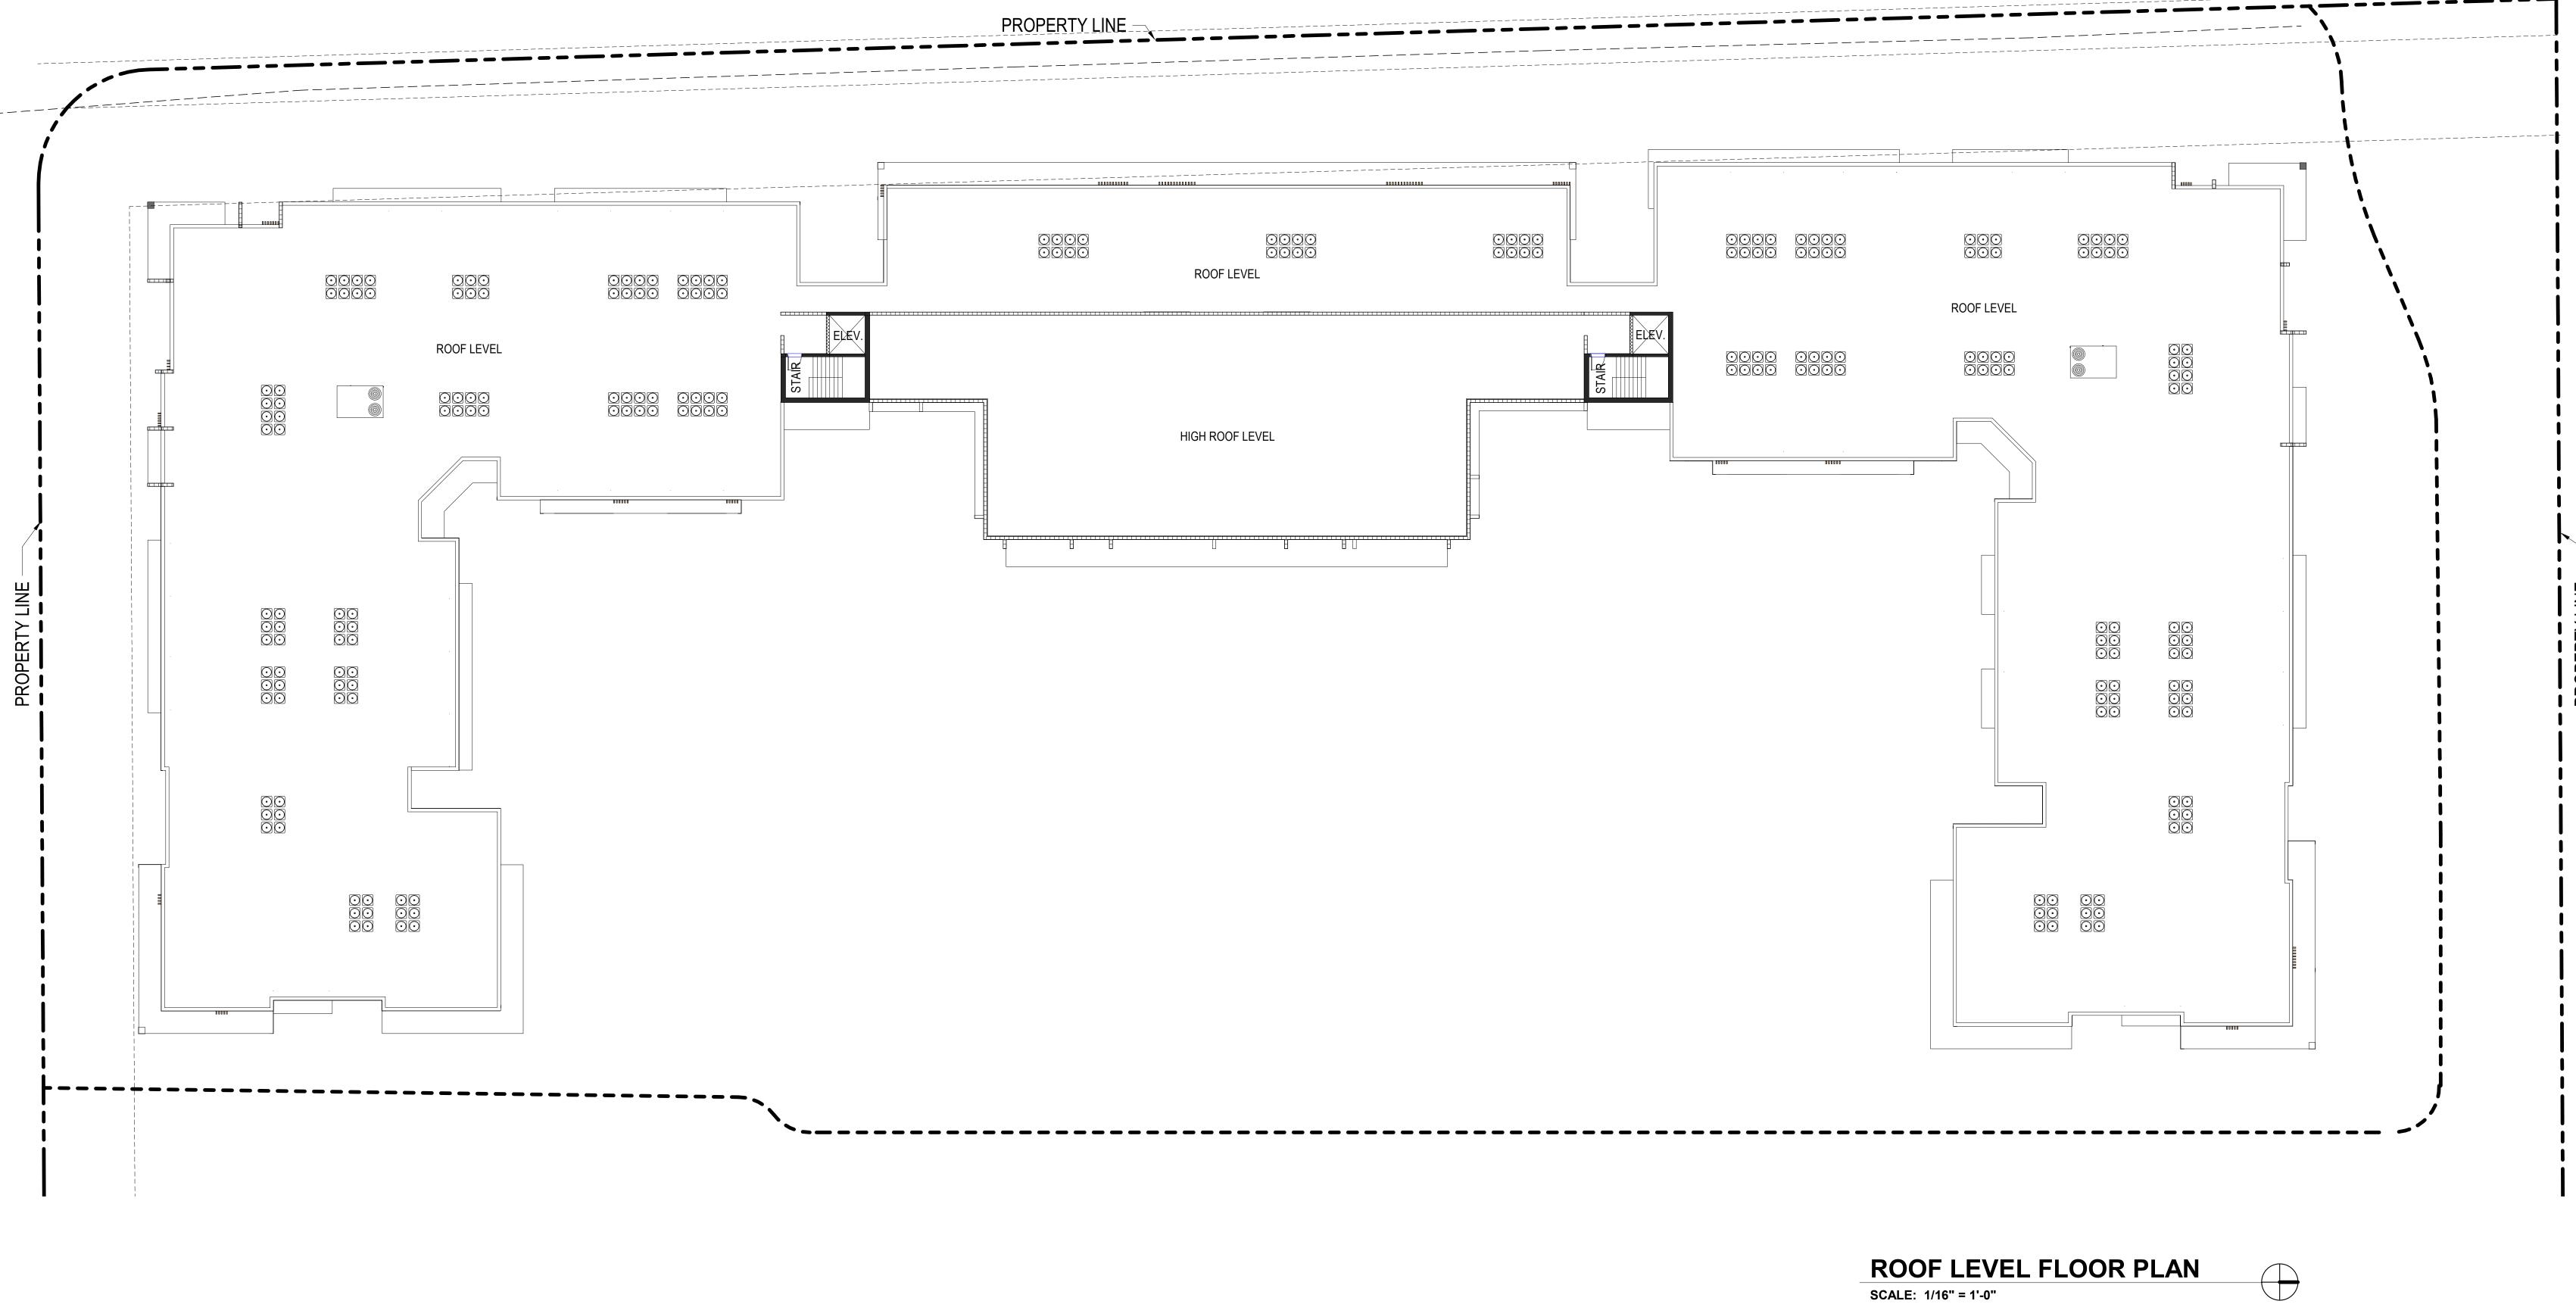

**LEGACY AT DORAL** 2525 NW 82ND AVENUE,

CORWILARCHITECTS

DORAL, FL. 33122

**EWE WAREHOUSE** 

INVESTMENT XXXII, LTD

PROJECT:

OWNER:

4210 LAGUNA ST, CORAL GABLES FL, 33146 QUALIFIER LIC. NO. AR0016003 T:305.448.7383

**SUBMITTAL** 

CORWILARCHITECTS

QUALIFIER LIC. NO. AR0016003 T:305.448.7383

**LEGACY AT DORAL** 


2525 NW 82ND AVENUE, DORAL, FL. 33122

**EWE WAREHOUSE** 

**INVESTMENT XXXII, LTD** 

PROJECT:

OWNER:

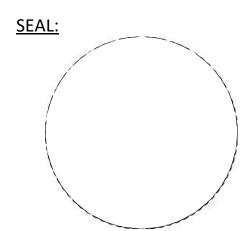

THESE DRAWINGS ARE THE PROPERTY OF CORWIL ARCHITECTS INC. UNLESS OTHERWISE PROVIDED FOR BY CONTRACT, THE CONTENTS OF THES DRAWINGS ARE CONFIDENTIAL AND SHALL NOT BE TRANSMITTED TO ANY OTHER PARTY

EXCEPT AS AGREED TO BY THE ARCHITECT/ENGINEERS.

JOB No.: DRAWN BY: APPR BY:

05/27/2022 2021-21 SR/DA 2/22/2023 7:45:38 PM

**SHEET NUMBER:** 

PRINTED:

Level 3 19' - 4" Level 2 9' - 8" Ground Level
EL. +8.00' (NAVD) 0' - 0"

# **SOUTH ELEVATION**

SCALE: 1/16" = 1'-0"



# NORTH ELEVATION

SCALE: 1/16" = 1'-0"

#### BUILDING ARCHITECTURE REGULATIONS

#### **SECTION 86-25.**

AT LEAST TWO OF THE FOLLOWING METHODS SHALL BE USED ON ALL FACADES OF A BUILDING:

- ( ) A MINIMUM STEP BACK (RECESS) OR PROJECTION OF THE FACADE THREE FEET OR MORE FOR AT LEAST 25 PERCENT OF THE FACADE AREA.
- (x) ARCHITECTURAL DESIGN ELEMENTS, SUCH AS PORCHES, CANOPIES, TOWERS, DORMERS, BAY WINDOWS, BALCONIES, AND DISTINCTIVE ENTRY FEATURES THAT PROVIDE DEPTH TO THE FACADE BY BREAKING UP A MINIMUM OF 25 PERCENT OF THE FACADE AREA.
- (x) VARIATION OF ROOF AND/OR ROOF WALL HEIGHT TO VISUALLY BREAK UP AT LEAST 25 PERCENT OF THE FACADE, SUCH AS BY USE OF MULTIPLE ROOF, ROOF PITCHES, DORMERS, AND/OR PARAPET HEIGHTS.
- (x) HORIZONTAL AND/OR VERTICAL VARIATION IN TEXTURE, OR MATERIALS AND ARCHITECTURAL DETAILING WITH ELEMENTS, SUCH AS CORNICES, FRIEZES, RELIEFS, DENTILS, ARCHITRAVES, PEDIMENTS, PILASTERS, FREST, QUOINS, CORBELS, TO DISTINGUISH FLOORS AND ADJOINING UNITS OR TO SIGNIFY VARIOUS ELEMENTS OF THE BUILDING.

#### **SECTION 86-26.**

(x) BUILDING FACADES FACING MAJOR ROADWAYS AND PEDESTRIAN CORRIDORS SHALL INCORPORATE APPROPRIATE ARCHITECTURAL FEATURES TO ENHANCE THE AESTHETIC ENVIRONMENT.

(x) THESE FEATURES MUST CONFORM TO THE CHOSEN STYLE OF THE BUILDING, AND MUST INCLUDE CORNICE DETAILING, ORNAMENTATION, MOLDINGS, CHANGES IN MATERIALS AND TEXTURES, COLOR VARIATIONS, AND OTHER ARCHITECTURAL SCULPTING THAT ENHANCES THE GROUND LEVEL AND ADDS INTEREST AND APPEAL TO THE BUILDING'S EXTERIOR.

(x) ARCHITECTURAL DETAILING IS HIGHLY DESIRED AND RECOMMENDED.

#### **SECTION 86-27.**

(X) BUILDING FACADES SHALL INCORPORATE ARCHITECTURAL FEATURES THAT ENHANCE THE AESTHETIC QUALITY OF THE BUILT ENVIRONMENT.

- (x) MATERIALS USED SHALL COMPLEMENT THE ARCHITECTURAL STYLE OF THE BUILDING.
- (X) CITY HIGHLY ENCOURAGES FACADE MATERIALS THAT VARY IN TEXTURE AND TYPE TO ACCENTUATE ENTRANCES, EXITS, WINDOWS, CORNERS, LEVEL CHANGES, AND OTHER ARCHITECTURAL FEATURES.

#### **SECTION 86-28.**

(x) BUILDING ENTRANCES OR ENTRY FEATURES SHALL BE EASILY IDENTIFIED/VISIBLE FROM THE MAJOR STREET AND PROPORTIONATE TO THE SCALE OF THE BUILDING DESIGN THROUGH THE USE OF BUILDING ELEMENTS SUCH AS:

- (x) RECESSED OR PROJECTED ENTRYWAYS, CANOPIES, PORCHES, OR PORTICOS. (x) VARYING ROOFLINES. (x) CHANGES IN MATERIAL AND/OR COLOR.
- (x) BUILDING ENTRANCES SHALL PROVIDE A PEDESTRIAN CONNECTION (SIDEWALK, PAVED CROSSWALKS) TO THE ADJOINING PUBLIC SIDEWALK OR STREET AND THE PRIVATE PARKING AREA.
- (x) ALL BUILDINGS SHALL BE ORIENTED AND/OR DESIGNED IN SUCH A WAY THAT REAR YARD OF THE BUILDING SHALL NOT FACE THE PUBLIC LOCAL AND QUARTER-SECTION LINE ROADWAYS.

#### **SECTION 86-29.**

(x) WINDOWS AND DOORS SHALL BE DEFINED WITH DECORATIVE DETAILS SUCH AS FRAMES, SILLS, LINTELS, SHUTTERS, PLANTERS, RELIEF TRIMS, OR MOLDINGS. TRIM OR MOLDING SHALL BE AT LEAST FOUR INCHES OF NOMINAL WIDTH TO QUALIFY AS A SPECIAL ELEMENT.

# **ELEVATION LEGEND**

- 1 LIGHT TEXTURE CEMENT PLASTER FINISH (TYP. THROUGHOUT UNLESS OTHERWISE NOTED)
- 2 LIGHT TEXTURE CEMENT PLASTER SIDDING AT 8" O.C.
- 3 DECORATIVE ALUMINUM SLATS (WOOD LOOK)
- 4 BALCONY/ TERRACE CONCRETE SLAB PROPERLY SLOPED TO EXTERIOR W/ APPLIED WATERPROOFING AT ALL ELEVATED
- 5 CONCRETE PROJECTION SLOPED TO EXTERIOR W/ APPLIED WATERPROOFING AT ALL ELEVATED SLABS OR AS OTHERWISE
- 6 CMU/CONCRETE VERTICAL PROJECTION WALL WITH LIGHT
- 7 CMU/CONCRETE PARAPET WALL. 60" HIGH TYP.
- SHALL REJECT 4" DIA. SPHERE
- 9 42" HT. A.F.F. CAT II IMPACT GLASS GUARDRAIL SYSTEM SHALL REJECT 4" DIA. SPHERE

- 1" WIDE X1/4" DEEP CONTINUOUS LINE.
- SLABS OR AS OTHERWISE INDICATED BY DWGS.
- INDICATED BY DWGS.
- TEXTURE CEMENT PLASTER FINISH TYP.


- 8 42" HT. A.F.F. BALCONY MESH GUARDRAIL SYSTEM


- HORIZONTAL SLIDING WINDOW W/ BOTTOM FIXED GLASS PANEL ALUMINUM FRAME & IMPACT RESISTANT GLASS GRAY-TINTED GLASS (TYP.)
- 11 SLIDING GLASS DOORS. ALUMINUM FRAME & IMPACT RESISTANT GLASS. GRAY-TINTED GLASS (TYP.)
- 12 IMPACT RESISTANT ALUMINUM STOREFRONT SYSTEM (TYP.)
- 13 IMPACT RESISTANT GLASS/ALUMINUM DOOR
- 14 IMPACT RESISTANT METAL DOOR
- 15 IMPACT RESISTANT MECHANICAL LOUVER
- 16 GARAGE WALL OPENINGS. MIN. 42" HT. A.F.F.
- 17 GARAGE ENTRANCE
- 18 STAIR/ELEVATORS BULKHEAD
- 19 POTENTIAL LOCATION FOR BACKFLOW PREVENTORS
- 20 CONRETE COLUMN W/ LIGHT TEXTURE CEMENT PLASTER FINISH (TYP. THROUGHOUT UNLESS OTHERWISE NOTED)

## SITE PLAN **SUBMITTAL**

**REVISIONS** 

Revision

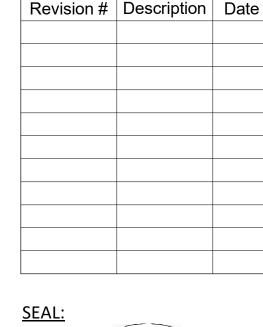

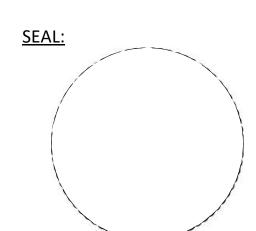

THESE DRAWINGS ARE THE PROPERTY OF CORWIL ARCHITECTS INC. UNLESS OTHERWISE PROVIDED FOR BY CONTRACT, THE CONTENTS OF THES DRAWINGS ARE CONFIDENTIAL AND SHALL NOT BE TRANSMITTED TO ANY OTHER PARTY

EXCEPT AS AGREED TO BY THE ARCHITECT/ENGINEERS. 05/27/2022

DATE: JOB No.: <u>DRAWN BY:</u> APPR BY: PRINTED:

2021-21 SR/DA 2/22/2023 7:46:03 PM

**SHEET NUMBER:** 

Level 5 38' - 8" Level 4 29' - 0" Level 3 19' - 4" Level 2 9' - 8" Ground Level 0' - 0" 18 16 14 18 6 5 1 16 3 2

# **EAST ELEVATION**

SCALE: 1/16" = 1'-0"



#### **WEST ELEVATION** SCALE: 1/16" = 1'-0"

#### **SECTION 86-25.**

AT LEAST TWO OF THE FOLLOWING METHODS SHALL BE USED ON ALL FACADES OF A BUILDING:

- ( ) A MINIMUM STEP BACK (RECESS) OR PROJECTION OF THE FACADE THREE FEET OR MORE FOR AT LEAST 25 PERCENT OF THE FACADE AREA.
- (x) ARCHITECTURAL DESIGN ELEMENTS, SUCH AS PORCHES, CANOPIES, TOWERS, DORMERS, BAY WINDOWS, BALCONIES, AND DISTINCTIVE ENTRY FEATURES THAT PROVIDE DEPTH TO THE FACADE BY BREAKING UP A MINIMUM OF 25 PERCENT OF THE FACADE AREA.
- (x) VARIATION OF ROOF AND/OR ROOF WALL HEIGHT TO VISUALLY BREAK UP AT LEAST 25 PERCENT OF THE FACADE, SUCH AS BY USE OF MULTIPLE ROOF, ROOF PITCHES, DORMERS, AND/OR PARAPET HEIGHTS.
- (x) HORIZONTAL AND/OR VERTICAL VARIATION IN TEXTURE, OR MATERIALS AND ARCHITECTURAL DETAILING WITH ELEMENTS, SUCH AS CORNICES, FRIEZES, RELIEFS, DENTILS, ARCHITRAVES, PEDIMENTS, PILASTERS, FREST, QUOINS, CORBELS, TO DISTINGUISH FLOORS AND ADJOINING UNITS OR TO SIGNIFY VARIOUS ELEMENTS OF THE BUILDING.

#### **SECTION 86-26.**

- BUILDING FACADES FACING MAJOR ROADWAYS AND PEDESTRIAN CORRIDORS SHALL INCORPORATE APPROPRIATE ARCHITECTURAL FEATURES TO ENHANCE THE AESTHETIC ENVIRONMENT.
- (x) THESE FEATURES MUST CONFORM TO THE CHOSEN STYLE OF THE BUILDING, AND MUST INCLUDE CORNICE DETAILING, ORNAMENTATION, MOLDINGS, CHANGES IN MATERIALS AND TEXTURES, COLOR VARIATIONS, AND OTHER ARCHITECTURAL SCULPTING THAT ENHANCES THE GROUND LEVEL AND ADDS INTEREST AND APPEAL TO THE BUILDING'S EXTERIOR.

**BUILDING ARCHITECTURE REGULATIONS** 

(x) ARCHITECTURAL DETAILING IS HIGHLY DESIRED AND RECOMMENDED.

#### **SECTION 86-27.**

- (X) BUILDING FACADES SHALL INCORPORATE ARCHITECTURAL FEATURES THAT ENHANCE THE AESTHETIC QUALITY OF THE BUILT ENVIRONMENT.
- (x) MATERIALS USED SHALL COMPLEMENT THE ARCHITECTURAL STYLE OF THE
- (X) CITY HIGHLY ENCOURAGES FACADE MATERIALS THAT VARY IN TEXTURE AND TYPE TO ACCENTUATE ENTRANCES, EXITS, WINDOWS, CORNERS, LEVEL CHANGES, AND OTHER ARCHITECTURAL FEATURES.

#### **SECTION 86-28.**

- (x) BUILDING ENTRANCES OR ENTRY FEATURES SHALL BE EASILY IDENTIFIED/VISIBLE FROM THE MAJOR STREET AND PROPORTIONATE TO THE SCALE OF THE BUILDING DESIGN THROUGH THE USE OF BUILDING ELEMENTS SUCH AS:
- (x) RECESSED OR PROJECTED ENTRYWAYS, CANOPIES, PORCHES, OR PORTICOS. (x) VARYING ROOFLINES. (x) CHANGES IN MATERIAL AND/OR COLOR.
- (x) BUILDING ENTRANCES SHALL PROVIDE A PEDESTRIAN CONNECTION (SIDEWALK, PAVED CROSSWALKS) TO THE ADJOINING PUBLIC SIDEWALK OR STREET AND THE PRIVATE PARKING AREA.
- (x) ALL BUILDINGS SHALL BE ORIENTED AND/OR DESIGNED IN SUCH A WAY THAT REAR YARD OF THE BUILDING SHALL NOT FACE THE PUBLIC LOCAL AND QUARTER-SECTION LINE ROADWAYS.

#### **SECTION 86-29.**

(x) WINDOWS AND DOORS SHALL BE DEFINED WITH DECORATIVE DETAILS SUCH AS FRAMES, SILLS, LINTELS, SHUTTERS, PLANTERS, RELIEF TRIMS, OR MOLDINGS. TRIM OR MOLDING SHALL BE AT LEAST FOUR INCHES OF NOMINAL WIDTH TO QUALIFY AS A SPECIAL ELEMENT.

#### **ELEVATION LEGEND**

- 1 LIGHT TEXTURE CEMENT PLASTER FINISH (TYP. THROUGHOUT UNLESS OTHERWISE NOTED)
- 2 LIGHT TEXTURE CEMENT PLASTER SIDDING AT 8" O.C.
- 1" WIDE X1/4" DEEP CONTINUOUS LINE.
- 3 DECORATIVE ALUMINUM SLATS (WOOD LOOK)
- 4 BALCONY/ TERRACE CONCRETE SLAB PROPERLY SLOPED TO EXTERIOR W/ APPLIED WATERPROOFING AT ALL ELEVATED SLABS OR AS OTHERWISE INDICATED BY DWGS.
- 5 CONCRETE PROJECTION SLOPED TO EXTERIOR W/ APPLIED WATERPROOFING AT ALL ELEVATED SLABS OR AS OTHERWISE INDICATED BY DWGS.
- 6 CMU/CONCRETE VERTICAL PROJECTION WALL WITH LIGHT TEXTURE CEMENT PLASTER FINISH TYP.
- 7 CMU/CONCRETE PARAPET WALL. 60" HIGH TYP.
- 8 42" HT. A.F.F. BALCONY MESH GUARDRAIL SYSTEM SHALL REJECT 4" DIA. SPHERE
- 9 42" HT. A.F.F. CAT II IMPACT GLASS GUARDRAIL SYSTEM SHALL REJECT 4" DIA. SPHERE

- 10 HORIZONTAL SLIDING WINDOW W/ BOTTOM FIXED GLASS PANEL ALUMINUM FRAME & IMPACT RESISTANT GLASS GRAY-TINTED GLASS (TYP.)
- 11 SLIDING GLASS DOORS. ALUMINUM FRAME & IMPACT RESISTANT GLASS. GRAY-TINTED GLASS (TYP.)
- 12 IMPACT RESISTANT ALUMINUM STOREFRONT SYSTEM (TYP.)
- 13 IMPACT RESISTANT GLASS/ALUMINUM DOOR
- 14 IMPACT RESISTANT METAL DOOR
- 15 IMPACT RESISTANT MECHANICAL LOUVER
- 16 GARAGE WALL OPENINGS. MIN. 42" HT. A.F.F.
- 17 GARAGE ENTRANCE
- 18 STAIR/ELEVATORS BULKHEAD
- 19 POTENTIAL LOCATION FOR BACKFLOW PREVENTORS
- 20 CONRETE COLUMN W/ LIGHT TEXTURE CEMENT PLASTER FINISH (TYP. THROUGHOUT UNLESS OTHERWISE NOTED)

Level 5 38' - 8"

Level 3 19' - 4"

Level 2 9' - 8"

Ground Level
EL. +8.00' (NAVD) 0' - 0"

High Roof Level

63' - 0"

Level 4 29' - 0"


Level 2 9' - 8"


Ground Level
(L. +8.00' (NAVD) 0' - 0"

PHASE: **SITE PLAN SUBMITTAL** 

**REVISIONS** 

Revision Revision # | Description | Date

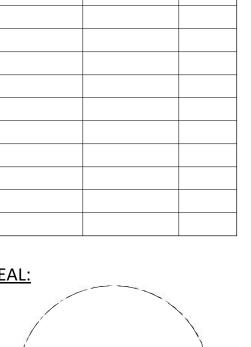

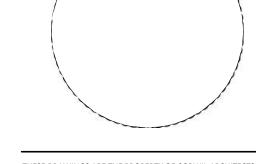

THESE DRAWINGS ARE THE PROPERTY OF CORWIL ARCHITECTS INC. UNLESS OTHERWISE PROVIDED FOR BY CONTRACT, THE CONTENTS OF THES DRAWINGS ARE CONFIDENTIAL AND SHALL NOT BE TRANSMITTED TO ANY OTHER PARTY EXCEPT AS AGREED TO BY THE ARCHITECT/ENGINEERS.

05/27/2022 2021-21

JOB No.: <u>DRAWN BY:</u> APPR BY: PRINTED:


SR/DA 2/22/2023 7:46:33 PM

**SHEET NUMBER:** 

High Roof Level 63' - 0" 5 2 7 6 3 10 Level 5 38' - 8" BUILDING Level 2 9' - 8" EL. +8.00' (NAVD) 0' - 0"

# NORTH COURTYARD ELEVATION

SCALE: 1/16" = 1'-0"

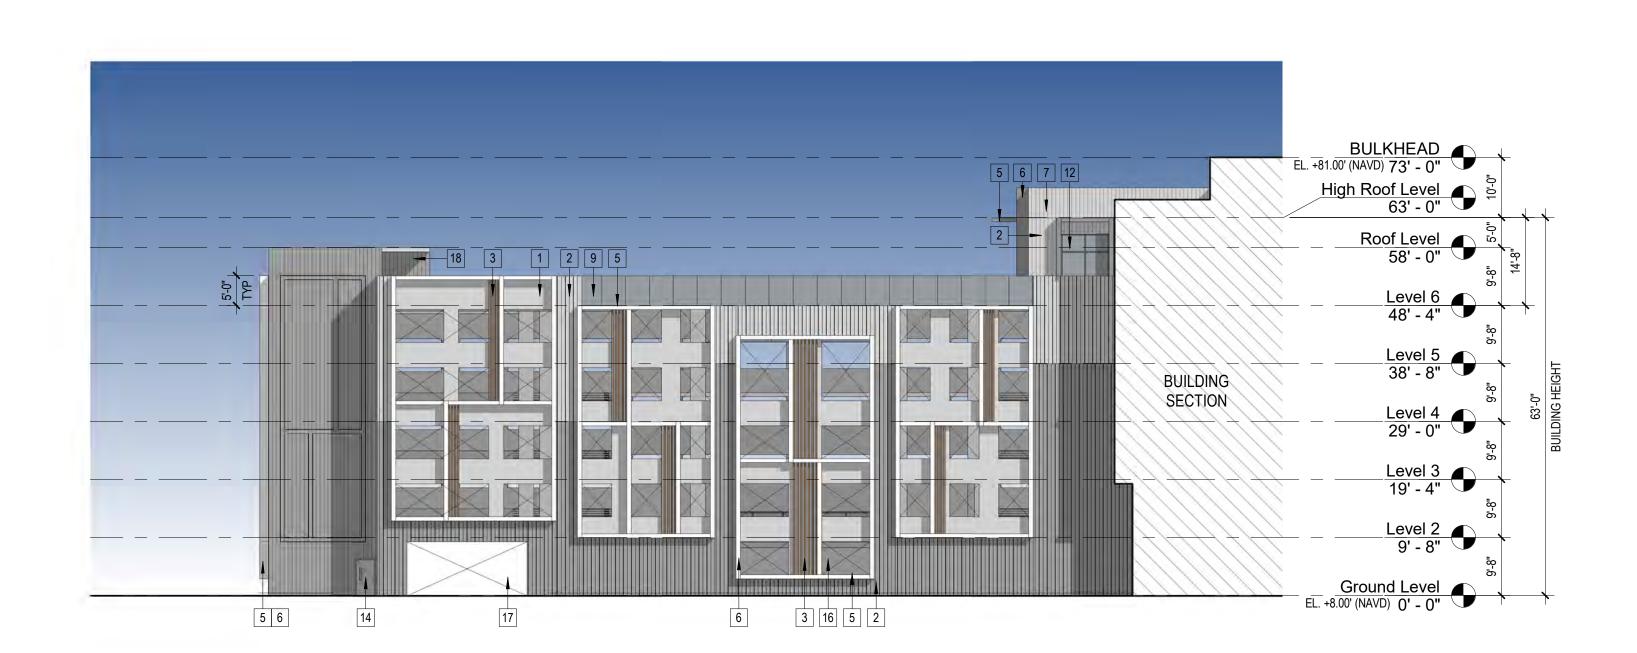

# NORTH GARAGE ELEVATION

SCALE: 1/16" = 1'-0"

#### BUILDING ARCHITECTURE REGULATIONS

#### **SECTION 86-25.**

AT LEAST TWO OF THE FOLLOWING METHODS SHALL BE USED ON ALL FACADES OF A BUILDING:

- ( ) A MINIMUM STEP BACK (RECESS) OR PROJECTION OF THE FACADE THREE FEET OR MORE FOR AT LEAST 25 PERCENT OF THE FACADE AREA.
- (x) ARCHITECTURAL DESIGN ELEMENTS, SUCH AS PORCHES, CANOPIES, TOWERS, DORMERS, BAY WINDOWS, BALCONIES, AND DISTINCTIVE ENTRY FEATURES THAT PROVIDE DEPTH TO THE FACADE BY BREAKING UP A MINIMUM OF 25 PERCENT OF THE FACADE AREA.
- (x) VARIATION OF ROOF AND/OR ROOF WALL HEIGHT TO VISUALLY BREAK UP AT LEAST 25 PERCENT OF THE FACADE, SUCH AS BY USE OF MULTIPLE ROOF, ROOF PITCHES, DORMERS, AND/OR PARAPET HEIGHTS.
- (x) HORIZONTAL AND/OR VERTICAL VARIATION IN TEXTURE, OR MATERIALS AND ARCHITECTURAL DETAILING WITH ELEMENTS, SUCH AS CORNICES, FRIEZES, RELIEFS. DENTILS. ARCHITRAVES. PEDIMENTS. PILASTERS. FREST. QUOINS. CORBELS, TO DISTINGUISH FLOORS AND ADJOINING UNITS OR TO SIGNIFY VARIOUS ELEMENTS OF THE BUILDING.

#### **SECTION 86-26.**

BUILDING FACADES FACING MAJOR ROADWAYS AND PEDESTRIAN CORRIDORS SHALL INCORPORATE APPROPRIATE ARCHITECTURAL FEATURES TO ENHANCE THE AESTHETIC ENVIRONMENT.

- (x) THESE FEATURES MUST CONFORM TO THE CHOSEN STYLE OF THE BUILDING, AND MUST INCLUDE CORNICE DETAILING, ORNAMENTATION, MOLDINGS, CHANGES IN MATERIALS AND TEXTURES, COLOR VARIATIONS, AND OTHER ARCHITECTURAL SCULPTING THAT ENHANCES THE GROUND LEVEL AND ADDS INTEREST AND APPEAL TO THE BUILDING'S EXTERIOR.
- (x) ARCHITECTURAL DETAILING IS HIGHLY DESIRED AND RECOMMENDED.

#### **SECTION 86-27.**

- (X) BUILDING FACADES SHALL INCORPORATE ARCHITECTURAL FEATURES THAT ENHANCE THE AESTHETIC QUALITY OF THE BUILT ENVIRONMENT.
- (X) MATERIALS USED SHALL COMPLEMENT THE ARCHITECTURAL STYLE OF THE BUILDING.
- (X) CITY HIGHLY ENCOURAGES FACADE MATERIALS THAT VARY IN TEXTURE AND TYPE TO ACCENTUATE ENTRANCES, EXITS, WINDOWS, CORNERS, LEVEL CHANGES, AND OTHER ARCHITECTURAL FEATURES.

## **SECTION 86-28.**

(x) BUILDING ENTRANCES OR ENTRY FEATURES SHALL BE EASILY IDENTIFIED/VISIBLE FROM THE MAJOR STREET AND PROPORTIONATE TO THE SCALE OF THE BUILDING DESIGN THROUGH THE USE OF BUILDING ELEMENTS SUCH AS:

- (x) RECESSED OR PROJECTED ENTRYWAYS, CANOPIES, PORCHES, OR PORTICOS. (x) VARYING ROOFLINES. (x) CHANGES IN MATERIAL AND/OR COLOR.
- (x) BUILDING ENTRANCES SHALL PROVIDE A PEDESTRIAN CONNECTION (SIDEWALK, PAVED CROSSWALKS) TO THE ADJOINING PUBLIC SIDEWALK OR STREET AND THE PRIVATE PARKING AREA.
- (x) ALL BUILDINGS SHALL BE ORIENTED AND/OR DESIGNED IN SUCH A WAY THAT REAR YARD OF THE BUILDING SHALL NOT FACE THE PUBLIC LOCAL AND QUARTER-SECTION LINE ROADWAYS.

#### **SECTION 86-29.**

(x) WINDOWS AND DOORS SHALL BE DEFINED WITH DECORATIVE DETAILS SUCH AS FRAMES, SILLS, LINTELS, SHUTTERS, PLANTERS, RELIEF TRIMS, OR MOLDINGS. TRIM OR MOLDING SHALL BE AT LEAST FOUR INCHES OF NOMINAL WIDTH TO QUALIFY AS A SPECIAL ELEMENT.

# SOUTH COURTYARD ELEVATION

SCALE: 1/16" = 1'-0"

#### **ELEVATION LEGEND**

- 4 BALCONY/ TERRACE CONCRETE SLAB PROPERLY SLOPED TO
- 5 CONCRETE PROJECTION SLOPED TO EXTERIOR W/ APPLIED WATERPROOFING AT ALL ELEVATED SLABS OR AS OTHERWISE INDICATED BY DWGS.
- TEXTURE CEMENT PLASTER FINISH TYP.
- 7 CMU/CONCRETE PARAPET WALL. 60" HIGH TYP.
- SHALL REJECT 4" DIA. SPHERE
- REJECT 4" DIA. SPHERE

10 HORIZONTAL SLIDING WINDOW W/ BOTTOM FIXED GLASS PANEL ALUMINUM FRAME & IMPACT RESISTANT GLASS

ACCESS

6 5

**SOUTH GARAGE ELEVATION** 

SCALE: 1/16" = 1'-0"

- GRAY-TINTED GLASS (TYP.)
- 11 SLIDING GLASS DOORS. ALUMINUM FRAME & IMPACT RESISTANT GLASS. GRAY-TINTED GLASS (TYP.)
- 12 IMPACT RESISTANT ALUMINUM STOREFRONT SYSTEM (TYP.)
- 13 IMPACT RESISTANT GLASS/ALUMINUM DOOR
- 14 IMPACT RESISTANT METAL DOOR
- 15 IMPACT RESISTANT MECHANICAL LOUVER
- 16 GARAGE WALL OPENINGS. MIN. 42" HT. A.F.F.
- 17 GARAGE ENTRANCE
- 18 STAIR/ELEVATORS BULKHEAD
- 19 POTENTIAL LOCATION FOR BACKFLOW PREVENTORS
- 20 CONRETE COLUMN W/ LIGHT TEXTURE CEMENT PLASTER FINISH (TYP. THROUGHOUT UNLESS OTHERWISE NOTED)

BUILDING SECTION 7 6 5

2 3 16 1 5 6

BUILDING

SECTION

- 1 LIGHT TEXTURE CEMENT PLASTER FINISH (TYP. THROUGHOUT UNLESS OTHERWISE NOTED)
- 2 LIGHT TEXTURE CEMENT PLASTER SIDDING AT 8" O.C. 1" WIDE X1/4" DEEP CONTINUOUS LINE.
- 3 DECORATIVE ALUMINUM SLATS (WOOD LOOK)
- EXTERIOR W/ APPLIED WATERPROOFING AT ALL ELEVATED SLABS OR AS OTHERWISE INDICATED BY DWGS.
- 6 CMU/CONCRETE VERTICAL PROJECTION WALL WITH LIGHT
- 8 42" HT. A.F.F. BALCONY MESH GUARDRAIL SYSTEM
- 9 42" HT. A.F.F. CAT II IMPACT GLASS GUARDRAIL SYSTEM SHALL

CORWILARCHITECTS
4210 LAGUNA ST. CORAL GABLES FL, 33146
QUALIFIER LIC. NO. AR0016003 T:305.448.7383

**LEGACY AT DORAL** 


2525 NW 82ND AVENUE, DORAL, FL. 33122


**EWE WAREHOUSE** 

INVESTMENT XXXII, LTD

PROJECT:

OWNER:

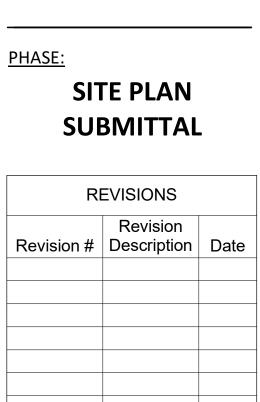

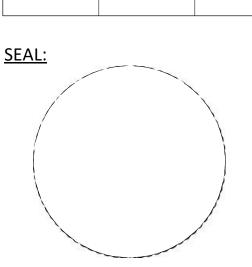

THESE DRAWINGS ARE THE PROPERTY OF CORWIL ARCHITECTS INC. UNLESS OTHERWISE PROVIDED FOR BY CONTRACT, THE CONTENTS OF THES DRAWINGS ARE CONFIDENTIAL AND SHALL NOT BE TRANSMITTED TO ANY OTHER PARTY EXCEPT AS AGREED TO BY THE ARCHITECT/ENGINEERS.

DATE:
JOB No.:
DRAWN BY:
APPR BY:
PRINTED: 05/27/2022 2021-21

SR/DA 3/2/2023 5:28:41 PM

SHEET NUMBER:





SOUTHWEST CORNER



**SOUTH FACADE** 



PROJECT:


**LEGACY AT DORAL** 


2525 NW 82ND AVENUE, DORAL, FL. 33122

OWNER:

EWE WAREHOUSE INVESTMENT XXXII, LTD

# SITE PLAN SUBMITTAL

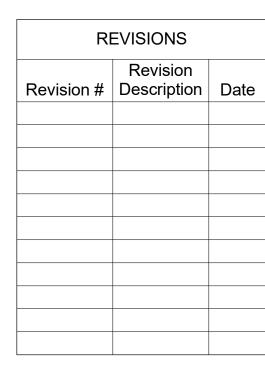

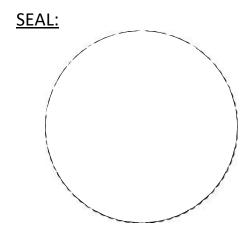

THESE DRAWINGS ARE THE PROPERTY OF CORWIL ARCHITECTS INC.

UNLESS OTHERWISE PROVIDED FOR BY CONTRACT, THE

CONTENTS OF THES DRAWINGS ARE CONFIDENTIAL AND

SHALL NOT BE TRANSMITTED TO ANY OTHER PARTY

EXCEPT AS AGREED TO BY THE ARCHITECT/ENGINEERS.

DATE:
JOB No.:
DRAWN BY:
APPR BY:
PRINTED:

05/27/2022 2021-21 SR/DA AMC 3/2/2023 5:28:49 PM

SHEET NUMBER:

A-5.01



**WEST FACADE** 





**LEGACY AT DORAL** 

2525 NW 82ND AVENUE, DORAL, FL. 33122

**EWE WAREHOUSE** INVESTMENT XXXII, LTD

### SITE PLAN SUBMITTAL

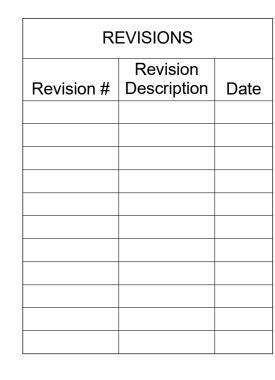

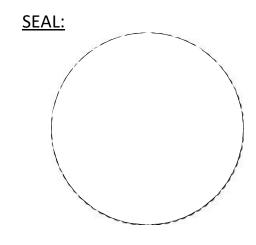

THESE DRAWINGS ARE THE PROPERTY OF CORWIL ARCHITECTS INC. UNLESS OTHERWISE PROVIDED FOR BY CONTRACT, THE CONTENTS OF THES DRAWINGS ARE CONFIDENTIAL AND SHALL NOT BE TRANSMITTED TO ANY OTHER PARTY EXCEPT AS AGREED TO BY THE ARCHITECT/ENGINEERS.

DATE:
JOB No.:
DRAWN BY:
APPR BY:
PRINTED:

05/27/2022 2021-21 SR/DA 3/2/2023 5:28:57 PM

SHEET NUMBER:
A-5.02

CORWILARCHITECTS
4210 LAGUNA ST. CORAL GABLES FL, 33146
QUALIFIER LIC. NO. AR0016003 T:305.448.7383

**LEGACY AT DORAL** 


2525 NW 82ND AVENUE, DORAL, FL. 33122


**EWE WAREHOUSE** 

**INVESTMENT XXXII, LTD** 

PROJECT:

OWNER:

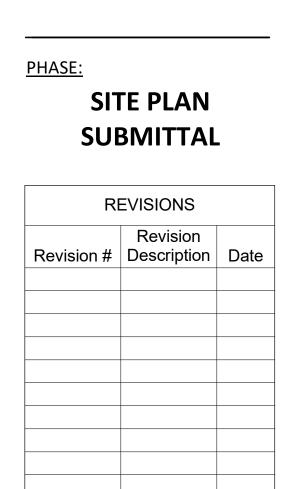

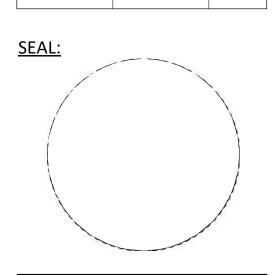

THESE DRAWINGS ARE THE PROPERTY OF CORWIL ARCHITECTS INC. UNLESS OTHERWISE PROVIDED FOR BY CONTRACT, THE CONTENTS OF THES DRAWINGS ARE CONFIDENTIAL AND SHALL NOT BE TRANSMITTED TO ANY OTHER PARTY EXCEPT AS AGREED TO BY THE ARCHITECT/ENGINEERS.

DATE:
JOB No.:
DRAWN BY:
APPR BY:
PRINTED:

05/27/2022 2021-21 SR/DA 2/22/2023 7:47:21 PM

SHEET NUMBER:
A-5.03



**WEST FACADE** 

CORWILARCHITECTS
4210 LAGUNA ST. CORAL GABLES FL, 33146
QUALIFIER LIC. NO. AR0016003 T:305.448.7383

**LEGACY AT DORAL** 

2525 NW 82ND AVENUE, DORAL, FL. 33122

**EWE WAREHOUSE** 

INVESTMENT XXXII, LTD


PROJECT:

OWNER:



SITE PLAN **SUBMITTAL** 

REVISIONS		
Revision #	Revision Description	Da

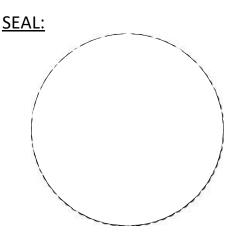

THESE DRAWINGS ARE THE PROPERTY OF CORWIL ARCHITECTS INC. UNLESS OTHERWISE PROVIDED FOR BY CONTRACT, THE CONTENTS OF THES DRAWINGS ARE CONFIDENTIAL AND SHALL NOT BE TRANSMITTED TO ANY OTHER PARTY EXCEPT AS AGREED TO BY THE ARCHITECT/ENGINEERS.

DATE:
JOB No.:
DRAWN BY:
APPR BY:
PRINTED:

05/27/2022 2021-21 SR/DA 2/22/2023 7:47:29 PM

SHEET NUMBER:
A-5.04



**WEST FACADE** 



NORTHWEST CORNER



**LEGACY AT DORAL** 

2525 NW 82ND AVENUE, DORAL, FL. 33122


OWNER:

EWE WAREHOUSE INVESTMENT XXXII, LTD

DHVCE.

## SITE PLAN SUBMITTAL

REVISIONS		
Revision #	Revision Description	Dat

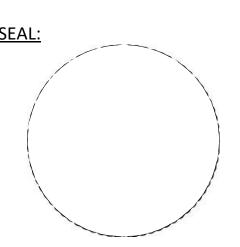

THESE DRAWINGS ARE THE PROPERTY OF CORWIL ARCHITECTS INC.
UNLESS OTHERWISE PROVIDED FOR BY CONTRACT, THE
CONTENTS OF THES DRAWINGS ARE CONFIDENTIAL AND
SHALL NOT BE TRANSMITTED TO ANY OTHER PARTY
EXCEPT AS AGREED TO BY THE ARCHITECT/ENGINEERS.

DATE:
JOB No.:
DRAWN BY:
APPR BY:
PRINTED:

05/27/2022 2021-21 SR/DA AMC 2/22/2023 7:47:36 PM

SHEET NUMBER:

A-5.05



**WEST FACADE** 



**LEGACY AT DORAL** 


2525 NW 82ND AVENUE, DORAL, FL. 33122

OWNER:

**EWE WAREHOUSE** INVESTMENT XXXII, LTD

### **SITE PLAN** SUBMITTAL

REVISIONS		
Revision #	Revision Description	Da

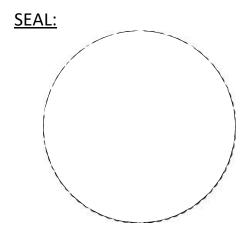

THESE DRAWINGS ARE THE PROPERTY OF CORWIL ARCHITECTS INC. UNLESS OTHERWISE PROVIDED FOR BY CONTRACT, THE CONTENTS OF THES DRAWINGS ARE CONFIDENTIAL AND SHALL NOT BE TRANSMITTED TO ANY OTHER PARTY EXCEPT AS AGREED TO BY THE ARCHITECT/ENGINEERS.

DATE:
JOB No.:
DRAWN BY:
APPR BY:
PRINTED:

05/27/2022 2021-21 SR/DA 2/22/2023 7:47:44 PM

SHEET NUMBER:
A-5.06

CORWILARCHITECTS
4210 LAGUNA ST. CORAL GABLES FL, 33146
QUALIFIER LIC. NO. AR0016003 T:305.448.7383

**LEGACY AT DORAL** 


2525 NW 82ND AVENUE, DORAL, FL. 33122


**EWE WAREHOUSE** 

**INVESTMENT XXXII, LTD** 

PROJECT:

OWNER:

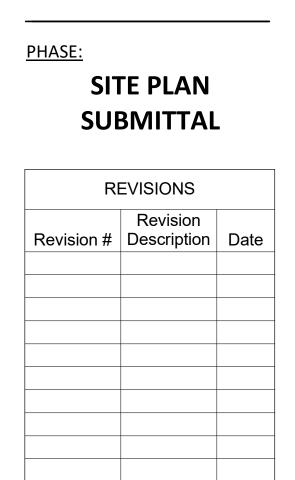

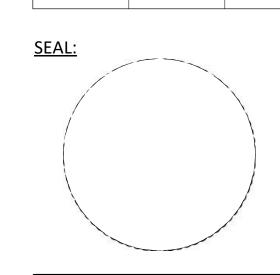

THESE DRAWINGS ARE THE PROPERTY OF CORWIL ARCHITECTS INC.

UNLESS OTHERWISE PROVIDED FOR BY CONTRACT, THE

CONTENTS OF THES DRAWINGS ARE CONFIDENTIAL AND

SHALL NOT BE TRANSMITTED TO ANY OTHER PARTY

EXCEPT AS AGREED TO BY THE ARCHITECT/ENGINEERS.

DATE:
JOB No.:
DRAWN BY:
APPR BY:
PRINTED: 2

05/27/2022 2021-21 SR/DA AMC 2/22/2023 7:47:51 PM

SHEET NUMBER:

A-5.07



**WEST FACADE** 



**WEST FACADE** 



PROJECT:

**LEGACY AT DORAL** 


2525 NW 82ND AVENUE, DORAL, FL. 33122


OWNER:

EWE WAREHOUSE INVESTMENT XXXII, LTD

PHASE:

# SITE PLAN SUBMITTAL

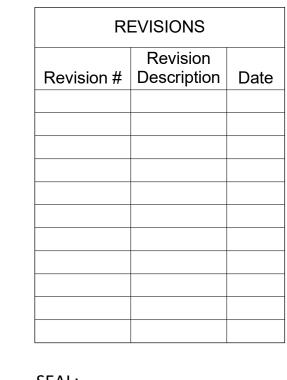

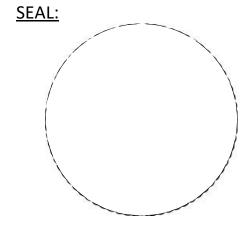

THESE DRAWINGS ARE THE PROPERTY OF CORWIL ARCHITECTS INC.

UNLESS OTHERWISE PROVIDED FOR BY CONTRACT, THE

CONTENTS OF THES DRAWINGS ARE CONFIDENTIAL AND

SHALL NOT BE TRANSMITTED TO ANY OTHER PARTY

EXCEPT AS AGREED TO BY THE ARCHITECT/ENGINEERS.

DATE:
JOB No.:
DRAWN BY:
APPR BY:
PRINTED:

05/27/2022 2021-21 SR/DA AMC 2/22/2023 7:47:59 PM

SHEET NUMBER:

A-5.08



**WEST FACADE** 



PROJECT:


**LEGACY AT DORAL** 

2525 NW 82ND AVENUE, DORAL, FL. 33122

**EWE WAREHOUSE** INVESTMENT XXXII, LTD

# SITE PLAN SUBMITTAL

RI	EVISIONS	
Revision #	Revision Description	Dat

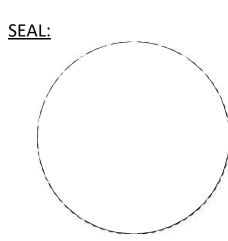

THESE DRAWINGS ARE THE PROPERTY OF CORWIL ARCHITECTS INC. UNLESS OTHERWISE PROVIDED FOR BY CONTRACT, THE CONTENTS OF THES DRAWINGS ARE CONFIDENTIAL AND SHALL NOT BE TRANSMITTED TO ANY OTHER PARTY EXCEPT AS AGREED TO BY THE ARCHITECT/ENGINEERS.

DATE:
JOB No.:
DRAWN BY:
APPR BY:
PRINTED:

05/27/2022 2021-21 SR AMC 2/22/2023 7:48:07 PM

SHEET NUMBER:
A-5.09



COURTYARD



PROJECT:

**LEGACY AT DORAL** 


2525 NW 82ND AVENUE, DORAL, FL. 33122

OWNER:

**EWE WAREHOUSE** INVESTMENT XXXII, LTD

# SITE PLAN SUBMITTAL

	Revision	
Revision #	Description	Date

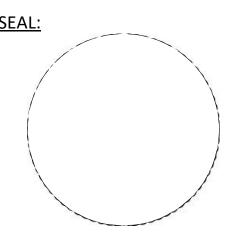


THESE DRAWINGS ARE THE PROPERTY OF CORWIL ARCHITECTS INC. UNLESS OTHERWISE PROVIDED FOR BY CONTRACT, THE CONTENTS OF THES DRAWINGS ARE CONFIDENTIAL AND SHALL NOT BE TRANSMITTED TO ANY OTHER PARTY EXCEPT AS AGREED TO BY THE ARCHITECT/ENGINEERS.

05/27/2022 2021-21 SR SR DATE:
JOB No.:
DRAWN BY:
APPR BY:
PRINTED: 2/22/2023 7:48:13 PM

SHEET NUMBER:



TYP. RESIDENTIAL PRIVATE STOOP VIEW

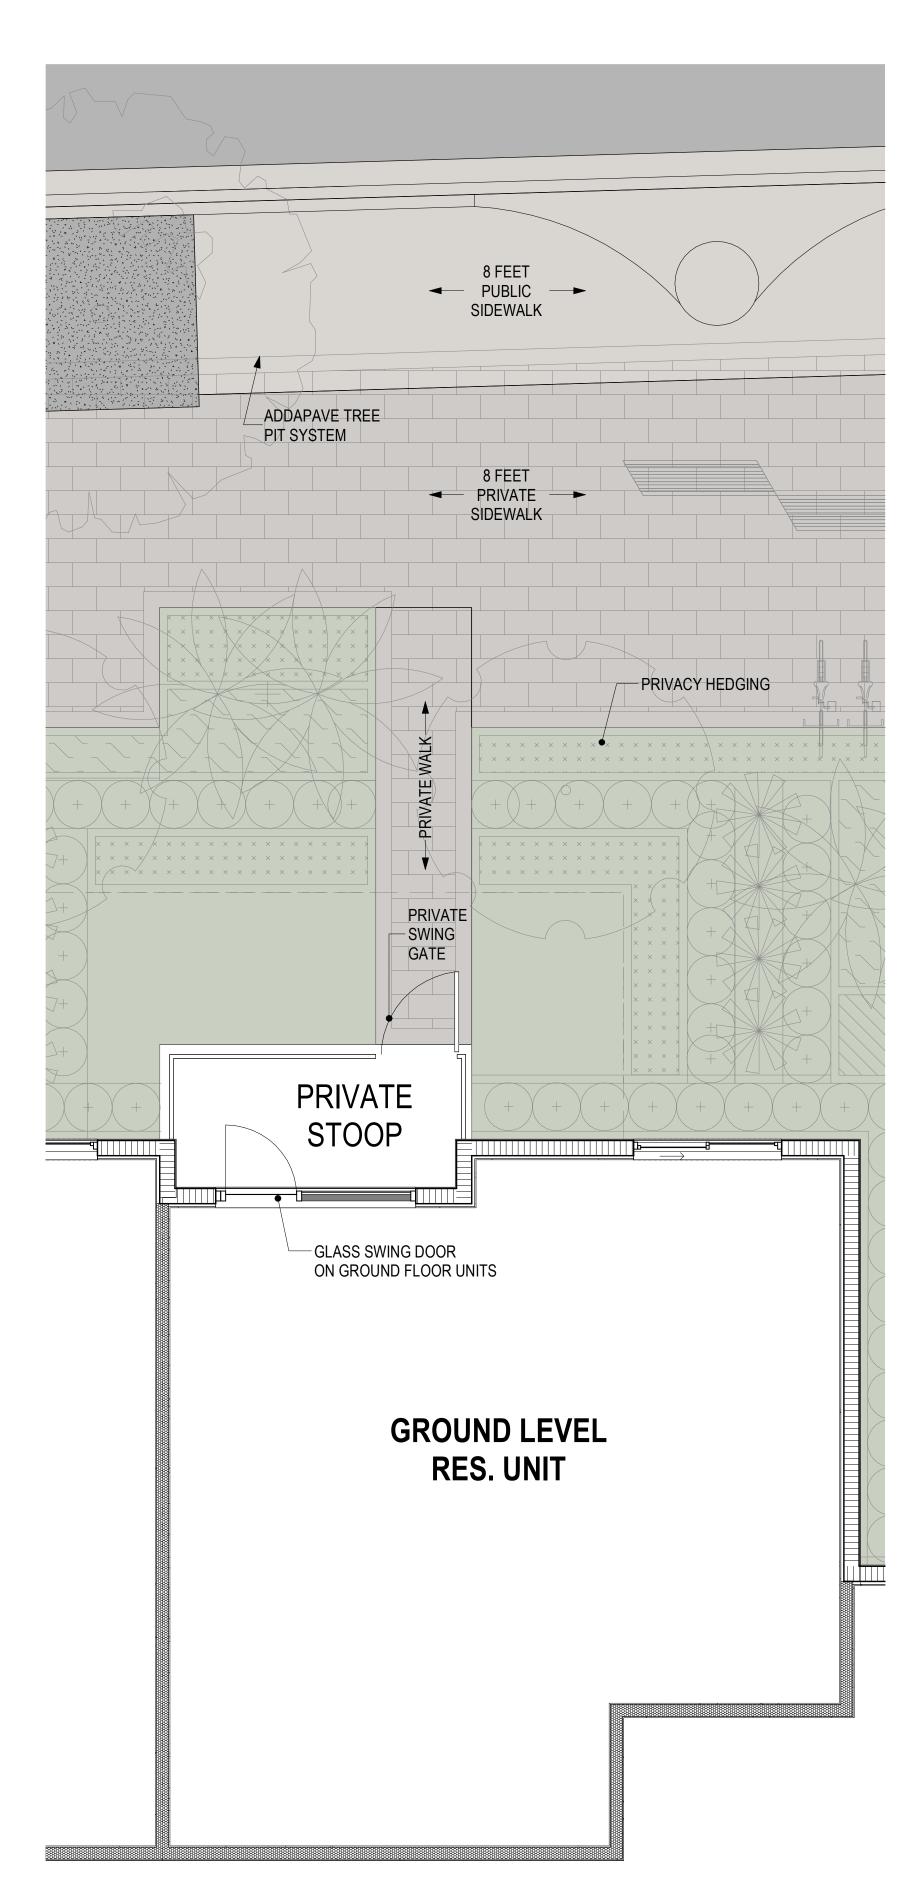

TYP. RESIDENTIAL PRIVATE STOOP PLAN



PROJECT:


**LEGACY AT DORAL** 

2525 NW 82ND AVENUE, DORAL, FL. 33122

OWNER:

**EWE WAREHOUSE** INVESTMENT XXXII, LTD

## SITE PLAN SUBMITTAL

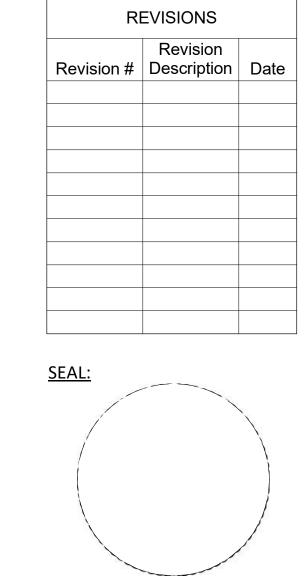

THESE DRAWINGS ARE THE PROPERTY OF CORWIL ARCHITECTS INC. UNLESS OTHERWISE PROVIDED FOR BY CONTRACT, THE CONTENTS OF THES DRAWINGS ARE CONFIDENTIAL AND SHALL NOT BE TRANSMITTED TO ANY OTHER PARTY EXCEPT AS AGREED TO BY THE ARCHITECT/ENGINEERS.

DATE:
JOB No.:
DRAWN BY:
APPR BY:
PRINTED:

05/27/2022 2021-21 2/22/2023 7:48:21 PM

#### CONSTRUCTION NOTES

- 1. ALL CONSTRUCTION ASSOCIATED WITH THIS PROJECT SHALL BE IN ACCORDANCE WITH APPLICABLE CODES OF AUTHORITIES HAVING JURISDICTION, INCLUDING BUT NOT LIMITED TO THE FLORIDA ADMINISTRATIVE CODE 62-555 & 62-610 AND ALL LOCAL AGENCIES INCLUDING: CITY OF DORAL, MIAMI-DADE COUNTY, AND FLORIDA DEPARTMENT OF TRANSPORTATION.
- 2. THE CONTRACTOR SHALL BE RESPONSIBLE FOR GETTING FAMILIARIZED WITH THE PROJECT SITE TO DETERMINE TOPOGRAPHIC OR UNDERGROUND FEATURES THAT WILL BE IMPACTED FROM AND DUE TO CONSTRUCTION. THE CONTRACTOR'S BID PRICE SHALL INCLUDE THE COST OF RELOCATING, ADJUSTING AND OR REPLACING IN KIND ANY FEATURES IMPACTED INCLUDING BUT NOT LIMITED TO TREES, UTILITY BOXES, SIGNAGE, POSTS, FENCES, GATES, HYDRANTS, POLES, VALVES, ETC. FINAL DISPOSITION OF IMPACTED FEATURE SHALL BE SUBJECT TO ACCEPTANCE OF OWNER OR AGENCY OR AUTHORITY HAVING JURISDICTION.
- 3. CONTRACTOR SHALL VERIFY THE EXACT LOCATION OF ALL EXISTING TREES, STRUCTURES AND UTILITIES, WHICH MAY OR MAY NOT BE SHOWN ON PLANS/DRAWINGS.
- 4. CONTRACTOR SHALL CONTACT SUNSHINE STATE ONE CALL AT LEAST (72) HOURS PRIOR TO PERFORMING ANY EXCAVATION / DIGGING TO VERIFY THE EXACT LOCATION OF EXISTING UTILITIES.
- 5. CONTRACTOR SHALL BE RESPONSIBLE FOR COORDINATING WITH EXISTING UTILITY OWNERS AND COMPANIES FOR TEMPORARY AND/OR PERMANENT RELOCATION AND ADJUSTMENT TO FACILITATE CONSTRUCTION.
- 6. THE LOCATION & SIZE OF EXISTING UTILITIES SHOWN ON THESE PLANS/DRAWINGS ARE APPROXIMATE. ADDITIONAL UTILITIES MAY EXIST WHICH ARE NOT SHOWN. THE CONTRACTOR SHALL VERIFY ALL UTILITIES BY ELECTRONIC METHODS AND BY HAND EXCAVATION IN COORDINATION WITH UTILITIES AGENCIES PRIOR TO BEGINNING CONSTRUCTION. ALL CONFLICTS WITH EXISTING UTILITIES SHALL BE RESOLVED PRIOR TO CONSTRUCTION. THIS IS CONSIDERED INCIDENTAL TO OVERALL CONSTRUCTION AND NO ADDITIONAL COMPENSATION SHALL BE PROVIDED.
- 7. CONTRACTOR SHALL BE RESPONSIBLE FOR PROMPTLY REPORTING ANY DISCREPANCIES RELATING TO SITE CONDITIONS.
- 8. CONTRACTOR SHALL TAKE ADEQUATE MEASURES TO ENSURE SAFETY WHEN WORKING IN THE VICINITY OF OVERHEAD ELECTRICAL, TELEPHONE, COMMUNICATIONS AND OTHER UTILITIES.
- 9. UNDER NO CIRCUMSTANCES SHALL THE CONTRACTOR LEAVE EXCAVATED TRENCHES OPEN, UNCOVERED, EXPOSED AND UNATTENDED TO.
- 10. CONTRACTOR SHALL KEEP THE SITE FREE OF DEBRIS, TRASH AND CONSTRUCTION WASTES. DEBRIS STOCKPILED FOR HAULING SHALL BE STORED AND SHALL BE ADEQUATELY MARKED AT ALL TIMES FOR TRAFFIC AND PEDESTRIAN SAFETY.
- 11. THE ENTIRE PROJECT SITE SHALL BE THOROUGHLY CLEANED AT THE COMPLETION OF THE WORK. CLEAN ALL INSTALLED PIPELINES, STRUCTURES, SIDEWALKS, PAVED AREAS, ACCUMULATED SILT IN PONDS, PLUS ALL ADJACENT AREAS AFFECTED BY CONSTRUCTION, AS DIRECTED BY THE OWNER OR JURISDICTIONAL AGENCY. EQUIPMENT TO CLEAN THESE SURFACES SHALL BE SUBJECT TO APPROVAL BY THE OWNER.
- 12. CONSTRUCTION HOURS AND NOISE CONTROL SHALL COMPLY WITH LOCAL JURISDICTIONAL ORDINANCES, CODES AND REQUIREMENTS.
- 13. CONTRACTOR SHALL OBTAIN ALL NECESSARY PERMITS AND/OR APPROVALS PRIOR TO THE START OF CONSTRUCTION.
- 14. CONTRACTOR SHALL BE RESPONSIBLE FOR RESTORING ALL PAVEMENT MARKINGS WITH NEW STRIPING IN THEIR PRE-CONSTRUCTION LOCATIONS. THE CONTRACTOR SHALL SURVEY THE LOCATIONS, DIMENSIONS, COLOR AND OTHER RELEVANT CHARACTERISTICS OF THE EXISTING PAVEMENT MARKINGS PRIOR TO CONSTRUCTION. FINAL PAVEMENT MARKING SHALL BE AS SPECIFIED BY THE RESPONSIBLE LOCAL JURISDICTION, OWNER AND EOR. ALL CONSTRUCTION EFFORTS AND EXPENSES TO RESTORE DAMAGED OR IMPACTED MARKINGS SHALL BE ASSUMED INCLUDED IN THE CONTRACTOR'S BID PRICE
- 15. CONTRACTOR SHALL BE RESPONSIBLE FOR REPLACING DAMAGED ALL TRAFFIC & NON-TRAFFIC SIGNAGE WITH NEW SIGNS IN THEIR PRE-CONSTRUCTION LOCATIONS AND CONDITIONS. THE CONTRACTOR SHALL SURVEY THE LOCATIONS, DIMENSIONS, COLOR AND OTHER RELEVANT CHARACTERISTICS OF THE EXISTING SIGNS PRIOR TO CONSTRUCTION. ALL CONSTRUCTION EFFORTS AND EXPENSES TO REPLACE DAMAGED OR IMPACTED SIGNS SHALL BE ASSUMED INCLUDED IN THE CONTRACTOR'S BID PRICE.
- 16. DEWATERING OPERATIONS REQUIRED FOR CONSTRUCTION SHALL BE APPROVED AND PERMITTED BY LOCAL JURISIDCTIONAL AGENCY /AGENCIES AND AUTHORITY/AUTHORITIES. COST OF DEWATERING AND PERMITTING EXPENSES SHALL BE BORNE BY THE CONTRACTOR AT NO ADDITIONAL COST TO OWNER.
- 17. ALL AREAS IMPACTED BEYOND THE CONSTRUCTION LIMITS, SHALL BE RESTORED TO THEIR ORIGINAL CONDITION OR BETTER AND SHALL BE ACCEPTED BY RESPONSIBLE OWNER, JURISDICTION OR AGENCY.
- 18. IN THE EVENT CONTAMINATED MATERIALS ARE ENCOUNTERED DURING CONSTRUCTION, THE CONTRACTOR SHALL STOP WORK AND IMMEDIATELY NOTIFY EOR, OWNER AND APPLICABLE REGULATORY AND JURISDICTIONAL AGENCY OR AGENCIES.
- 19. WHERE NEW PAVEMENT MEETS EXISTING, THE CONNECTION SHALL BE MADE IN A NEAT STRAIGHT LINE & FLUSH WITH EXISTING PAVEMENT.
- 20. ALL ELEVATIONS SHOWN ON THE PLANS/DRAWINGS REFER TO THE NATIONAL GEODETIC VERTICAL DATUM OF 1929. BENCHMARKS USED ARE THOSE IDENTIFIED ON THE SURVEY PREPARED BY ABRAHAM HADAD, PSM (DATED 04/27/2022).
- 21. SURVEY MONUMENTS WITHIN THE LIMITS OF THE PROJECT SHALL BE PROTECTED AND SHALL BE REPLACED BY THE CONTRACTOR AT NO ADDITIONAL COST IF DAMAGED DURING CONSTRUCTION.
- 22. THE CONTRACTOR SHALL BE RESPONSIBLE FOR ENSURING THAT CONSTRUCTION IS EXECUTED SAFELY AND IN STRICT COMPLIANCE WITH ALL REQUIREMENTS OF FEDERAL OCCUPATIONAL SAFETY AND HEALTH ACT (OSHA) OF 1970, AND ALL STATE AND LOCAL SAFETY AND HEALTH REGULATORY ORDINANCES.
- 23. THE CONTRACTOR SHALL UTILIZE A STREET SWEEPER (USING WATER) OR OTHER LOCAL JURISDICTION APPROVED EQUIPMENT FOR CONTROLLING AND REMOVING DUST.
- 24. THE CONTRACTOR SHALL MAINTAIN PEDESTRIAN AND VEHICULAR ACCESS TO ALL ADJACENT PROPERTIES AT ALL TIMES UNLESS OTHERWISE APPROVED BY REGULATORY AUTHORITIES.
- 25. THE CONTRACTOR SHALL NOT ENCROACH INTO PRIVATE PROPERTY WITH PERSONNEL, MATERIAL AND EQUIPMENT.
- 26. ALL EXISTING MANHOLE COVERS, TOPS, CATCH BASIN GRATES, VALVE BOX TOPS, AND OTHER UTILITY CASTINGS SHALL BE ADJUSTED TO MATCH FINISH GRADE.
- 27. CONTRACTOR SHALL VERIFY THE PRESENCE OF HISTORICAL AND CULTURAL ARTIFACTS AND RESOURCES ON THE SITE PRIOR TO CONSTRUCTION. IF PRESENT, THE CONTRACTOR SHALL CONTACT THE LOCAL JURISDICTIONAL AGENCY, OWNER AND EOR.
- 28. NO STAGING OR ACTIVITIES SHALL BE PERFORMED WITHIN THE DRIP LINE OF EXISTING TREES.
- 29. THE CONTRACTOR SHALL SUBMIT SHOP DRAWINGS TO THE ENGINEER FOR APPROVAL PRIOR TO ORDERING THE MATERIALS REQUIRED FOR CONSTRUCTION. PRIOR TO SUBMISSION, THE CONTRACTOR SHALL THOROUGHLY CHECK SHOP DRAWINGS, PRODUCT DATA, AND SAMPLES FOR COMPLETENESS AND FOR COMPLIANCE WITH THE CONSTRUCTION PLANS/DRAWINGS AND SHALL VERIFY ALL DIMENSIONS AND FIELD CONDITIONS AND SHALL COORDINATE THE SHOP DRAWINGS WITH THE REQUIREMENTS FOR OTHER RELATED WORK. THE CONTRACTOR'S RESPONSIBILITY FOR ERRORS AND OMISSIONS IN SUBMITTALS IS NOT RELIEVED BY THE ENGINEER'S REVIEW OF SUBMITTALS. THE CONTRACTOR SHALL NOTIFY THE ENGINEER OF RECORD, IN WRITING AT THE TIME OF SUBMISSION, OF DEVIATIONS IN SUBMITTALS FROM THE REQUIREMENTS OF THE CONTRACT DOCUMENTS.
- 30. THE CONTRACTOR IS RESPONSIBLE FOR ALL CONSTRUCTION TESTING. INCLUDING BUT NOT LIMITED TO:
- A. PIPING AND STRUCTURAL EXCAVATION, BEDDING AND BACKFILL MATERIALS AND DENSITY TESTS.
- B. DETERMINATION OF COMPACTIVE EFFORT NEEDED FOR COMPLIANCE WITH THE DENSITY REQUIREMENTS
- C. CONCRETE AND ASPHALT PAVING INCLUDING DESIGN MIX REVIEW, MATERIALS, FIELD SLUMP AND AIR CONTENT, AND FIELD AND LAB CURED STRENGTH SAMPLES AND TESTING.
- 31. IN ADDITION, THE CONTRACTOR SHALL BE RESPONSIBLE FOR REQUIRED TESTING OR APPROVALS FOR ANY WORK (OR ANY PART THEREOF) IF LAWS OR REGULATIONS OF ANY PUBLIC BODY HAVING JURISDICTION SPECIFICALLY REQUIRE TESTING, INSPECTIONS OR APPROVAL. THE CONTRACTOR SHALL PAY ALL COSTS IN CONNECTION THEREWITH AND SHALL FURNISH THE OWNER AND ENGINEER THE REQUIRED CERTIFICATES OF INSPECTION, TESTING OR APPROVAL.
- 32. ANY DESIGN OR TESTING LABORATORY UTILIZED BY THE CONTRACTOR SHALL BE AN INDEPENDENT LABORATORY ACCEPTABLE TO THE OWNER AND THE ENGINEER, APPROVED IN WRITING AND COMPLYING WITH THE LATEST EDITION OF THE "RECOMMENDED REQUIREMENTS FOR INDEPENDENT LABORATORY QUALIFICATION", AND PUBLISHED BY THE AMERICAN COUNCIL OF INDEPENDENT LABORATORIES.
- 33. TESTING RESULTS SHALL BE PROVIDED TO THE OWNER AND THE ENGINEER. ALL TEST RESULTS SHALL BE PROVIDED (PASSING AND FAILING) ON A REGULAR AND IMMEDIATE BASIS.
- 34. CONTRACTOR SHALL BE AWARE THAT DRAWING SCALE SHOWN ON THE PLANS/DRAWINGS CORRESPOND TO A PLOT SIZE ESTABLISHED FOR THE PROJECT. IF DRAWING IS PLOTTED ON OTHER SHEET SIZE, THE EOR, DOES NOT WARRANT ACCURACY OF DRAWING SCALE.

#### 35. AS-BUILT DRAWING REQUIREMENTS

- A. AS-BUILT DRAWINGS SHALL BE PROVIDED BY THE CONTRACTOR TO THE ENGINEER THREE WEEKS PRIOR TO FINAL INSPECTION. ALL AS-BUILT DATA SHALL BE PROVIDED BY A FLORIDA LICENSED SURVEYOR, SIGNED, SEALED AND DATED BY THE RESPONSIBLE PARTY.
- B. AT THE COMPLETION OF THE WORK, CONTRACTOR SHALL DELIVER THE DRAWINGS DOCUMENTING AS-BUILT INFORMATION, MEASURED BY A LICENSED SURVEYOR, TO THE ENGINEER, IN GOOD CONDITION AND FREE FROM ANY EXTRANEOUS NOTATION. THE AS-BUILT INFORMATION IS TO INCLUDE, BUT NOT BE LIMITED TO, THE FOLLOWING:
  - . HORIZONTAL LOCATIONS AND VERTICAL ELEVATIONS FOR ALL UTILITY AND STORM STRUCTURES INCLUDING BUT NOT LIMITED TO MANHOLES, INLETS AND CLEANOUTS, INCLUDING STRUCTURE TOP AND INVERT ELEVATIONS.
- ii. DISTANCE ALONG PIPELINES BETWEEN STRUCTURES.
- iii. RETENTION / DETENTION/ SWALE AREA TOP OF BERM AND POND BOTTOM ELEVATIONS AND HORIZONTAL DIMENSIONS MEASURED AT A MINIMUM OF FIVE LOCATIONS OR AT LOCATIONS DESIGNATED BY THE ENGINEER. TOP OF AREA HORIZONTAL DIMENSIONS ARE ALSO TO BE TIED TO PROPERTY CORNERS, EASEMENTS, AND RIGHTS-OF-WAY.
- iv. STORMWATER CONTROL STRUCTURE DIMENSIONS AND ELEVATIONS, INCLUDING ALL WEIRS, SLOTS, ORIFICES, GRATES, AND SKIMMERS.
- v. STORMWATER CONVEYANCE SYSTEMS INCLUDING DIMENSIONS, ELEVATIONS, CONTOURS, AND CROSS SECTIONS.
- vi. HORIZONTAL LOCATIONS AND VERTICAL ELEVATIONS OF ALL UTILITY VALVES, FITTINGS, CONNECTION POINTS, ETC.
- vii. VERTICAL ELEVATIONS OF ALL PIPELINES AT CROSSINGS OF POTABLE WATER MAINS (WHETHER THE WATER MAIN IS EXISTING OR NEW) IN ORDER TO DOCUMENT THAT THE MINIMUM REQUIRED VERTICAL SEPARATION HAS BEEN MET.
- viii. UTILITY PIPELINE TIED HORIZONTALLY TO EDGE OF PAVEMENT AND RIGHT-OF-WAY LINES, LOCATED EVERY 100-FT PLUS ALL CHANGES IN HORIZONTAL OFFSET.
- ix. PAVEMENT WIDTH AND ELEVATIONS AT THE CENTERLINE AND EDGE OF PAVEMENT EVERY 200 FEET PLUS AT ALL CHANGES IN LONGITUDINAL SLOPE, CROSS SLOPE, INLET LOCATIONS, AND AT ALL DRIVEWAY AND STREET INTERSECTIONS. FOR PARKING LOTS, RECORD CENTERLINE AND EDGE OF PAVEMENT ELEVATIONS ALONG ALL DRIVE AISLES AND ISLANDS.
- x. ALL PARKING AREAS AND SIDEWALK RAMPS DESIGNATED FOR HANDICAP ACCESS SHALL CONTAIN HORIZONTAL AND VERTICAL MEASUREMENTS IN ORDER TO VERIFY REQUIRED WIDTHS AND SLOPES HAVE BEEN MET.
- xi. HORIZONTAL AND VERTICAL DATA FOR ANY CONSTRUCTION THAT DEVIATES FROM THE APPROVED ENGINEERING DRAWINGS.
- xii. WHERE THE PLANS/DRAWINGS CONTAIN SPECIFIC HORIZONTAL LOCATION DATA, SUCH AS STATION AND OFFSET, THE AS-BUILT DRAWINGS ARE TO REFLECT THE ACTUAL HORIZONTAL LOCATION.
- xiii. WHERE THE PLANS/DRAWINGS CONTAIN SPECIFIC VERTICAL ELEVATION DATA, THE AS-BUILT DRAWINGS ARE TO REFLECT THE ACTUAL MEASURED VERTICAL ELEVATION.

#### **ABBREVIATIONS**

AC	PROPERTY LINE	GV	GATE VALVE
A/E	ARCHITECT/ENGINEER	HDPE	HIGH DENSITY POLYETHYLENE PIPE
APPROX	APPROXIMATE	HORIZ	HORIZONTAL
ARCH	ARCHITECTURAL/ARCHITECT	IE	INVERT ELEVATION
ARV	AIR RELEASE VALVE	IRR	IRRIGATION WATER LINE
ASPH	ASPHALT	L	LENGTH
ASPH DWY	ASPHALT DRIVEWAY	LAT	LATERALS
ASTM	AMERICAN SOCIETY FOR	LF	LINEAR FEET
ASTIVI	TESTING AND MATERIAL		
A)/F		LS	LUMP SUM
AVE	AVENUE	LT	LEFT
AVG	AVERAGE	MAX	MAXIMUM
B DWY	BRICK DRIVEWAY	MAS	MAINTENANCE ACCESS STRUCTURE
BE . / DI	BURIED ELECTRIC LINE	ME	MATCH EXISTING
₽/BL	BASELINE	MEP	MECHANICAL / ELECTRICAL / PLUMBING
BLDG	BUILDING	MH	MANHOLE
BLVD	BOULEVARD	MJ	MECHANICAL JOINT
ВТ	BURIED TELEPHONE LINE	MIN	MINIMUM
C&G	CURB & GUTTER	u / ML	MONUMENT LINE
CATV	CABLE TELEVISION	N	NORTHING NORTH
СВ	CATCH BASIN	NGVD	NATIONAL GEODETIC VERTICAL DATUM
CBS	CONCRETE BLOCK STRUCTURE	NAVD	NORTH AMERICAN VERTICAL DATUM
CD	CHANNEL DRAIN	NTP	NOTICE TO PROCEED
C.I.	CAST IRON	NTS	NOT TO SCALE
€ / CL	CENTERLINE	OC	ON CENTER
CLF	CHAIN LINK FENCE	PC	POINT OF CURVATURE
CMP	CORRUGATED METAL PIPE	PG	PAVING AND GRADING
CO	CLEANOUT	PI	POINT OF INTERSECTION
CONC	CONCRETE	PIV	POST INDICATOR VALVE
CONC DWY	CONCRETE DRIVEWAY	ዊ / PL	PROPERTY LINE
CONC SDWK	CONCRETE SIDEWALK	PROP	PROPOSED
CONC WALL	CONCRETE WALL	PSI	POUNDS PER SQUARE INCH
СР	COLLECTOR PIPE	PT	POINT OF TANGENCY
CPP	CORRUGATED PLASTIC PIPE	PVC	POLYVINYL CHLORIDE PIPE
CW	CHILLED WATER	PVI	POINT OF VERTICAL INTERSECTION
CY	CUBIC YARD	PVMT	PAVEMENT
DDCV	DOUBLE DETECTOR CHECK VALVE	RAD / R	RADIUS
DET	DETAIL	RCP	REINFORCED CONCRETE PIPE
DIA	DIAMETER	RPM	REFLECTIVE PAVEMENT MARKER
DIP	DUCTILE IRON PIPE	RE	RIM ELEVATION
DISP	DISPLACED	RT	RIGHT
DWG	DRAWING		RIGHT-OF-WAY
E	EASTING	SAN / SS	SANITARY SEWER LINE
EA	EACH	SD SD	STORM DRAINAGE LINE
ESMT	EASMENT	SDWK	SIDEWALK
EL/ELEV	ELEVATION	SPEC	SPECIFIC
ELEC	ELECTRICAL	SPECS	SPECIFICATIONS
EOP	EDGE OF PAVEMENT	STA	STATION
EOR	ENGINEER OF RECORD	STD	STANDARD
EQ	EQUATION	STRM	STORM DRAINAGE
EXIST	EXISTING	SWPP	STORM WATER POLLUTION PREVENTION
FD	FRENCH DRAIN	SY	SQUARE YARDS
FDC	FIRE DEPARTMENT CONNECTION	TP	-
FEE	FINISHED FLOOR ELEVATION	TOC	TRANSPORT PIPE TOP OF CURB
FH	FIRE HYDRANT		
		TOS	TOP OF STEP
FM	FORCE MAIN	TYP	TYPICAL VITRIEID CLAY DIDE
FT	FEET	VCP	VITRIFIED CLAY PIPE
G	GAS LINE	VERT	VERTICAL
GB	GALVANIZED IDON	WM	WATER MAIN
GI	GALVANIZED IRON		
GP	GUARD POST		

exp U.S. Services Inc.
t: +1.305.631.2208| f: +1.407.660.1655
201 Alhambra Circle, Suite 800
Coral Gables, FL 33134
U.S.A.

U.S.A.

www.exp.com

Cert of Auth: 29701

BUILDINGS • EARTH & ENVIRONMENT •
 ENERGY • INDUSTRIAL • INFRASTRUCTURE •
 SUSTAINABILITY •

PROJECT:

#### LEGACY AT DORAL

2525 NW 82ND AVENUE, DORAL, FL. 33122

OWNER:

#### TheEastonGroup

101 N.W. 19 ST.
MIAMI, FL 33172
TEL - (305) 593-2222
FAX - (305) 591-3863
www.theeastongroup.com


FNFRAI NOT

PHASE:

# SCHEMATIC

Revision #	Revision Description	Date	

SEAL

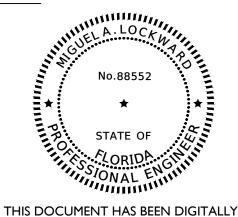

SIGNED AND SEALED BY MIGUEL A.
LOCKWARD, P.E. ON THE DATE ADJACENT
TO THE SEAL.

PRINTED COPIES OF THIS DOCUMENT ARE NOT CONSIDERED SIGNED AND SEALED. THE SIGNATURE MUST BE VERIFIED ON THE ELECTRONIC DOCUMENTS.

THIS DRAWINGS IS THE PROPERTY OF EXP U.S. SERVICES, INC.
UNLESS OTHERWISE PROVIDED FOR BY CONTRACT, THE
CONTENTS OF THIS DRAWINGS ARE CONFIDENTIAL AND
SHALL NOT BE TRANSMITTED TO ANY OTHER PARTY
EXCEPT AS AGREED TO BY THE ARCHITECT/ENGINEERS.

DATE:
PROJ No.:
DRAWN BY:
APPR BY:

DESIGN TICKET NO: 077201638

Call 811 or visit sunshine811.com two full business days before digging to have

buried facilities located and marked.

THE OFFICIAL RECORD OF THIS SHEET IS THE ELECTRONIC FILE DIGITALLY SIGNED AND SEALED UNDER RULE 61G15-23.004, F.A.C.

Check positive response codes before you dig!

**Sunshine** 

21010276-A0 : MB DS

2/22/2023

SHEET NUMBER:

C-1.01

#### 1. PROJECT/SITE DESCRIPTION

A. CONSTRUCTION ACTIVITY: CONSTRUCTION OF A PROPOSED X STORY RESIDENTIAL BUILDING, PARKING, UTILITIES AND DRAINAGE SYSTEM.

PROJECT LIMITS:

N.W. 82ND AVENUE AND 25TH STREET

#### B. MAJOR SOIL DISTURBING ACTIVITIES

INSTALLATION OF DRAINAGE SYSTEM

- CLEARING & GRUBBING
- INSTALLATION FOR UTILITIES (WATER AND SEWER)
- CONSTRUCTION OF BUILDING FOUNDATIONS

#### C. TOTAL PROJECT AREA: 2.662 ACRES

TOTAL SITE AREA: 9.270 ACRES TOTAL AREA TO BE DISTURBED: 2.662 ACRES

D. (1) RUNOFF COEFFICIENTS BEFORE, DURING AND AFTER CONSTRUCTION

BEFORE: 83

DURING: 83 AFTER: 92

#### (2) DESCRIPTION OF SOIL OR QUALITY OF DISCHARGE:

THE FOLLOWING GRAPH WAS DEVELOPED AS A GENERAL CONDITION FOR THE SUBJECT SITE FROM EXISTING GROUND LEVEL (SUBSOIL CONDITIONS ARE NON-HOMOGENOUS REFER TO FIELD BORING LOGS FOR EXACT SOIL CONDITIONS AT VARIOUS LOCATIONS). AVERAGE DEPTHS ARE APPROXIMATE AND WILL VARY:

**AVERAGE DEPTHS** SOIL DESCRIPTION

0'-0" TO 4'-0" LIMEROCK with Fine to Medium Grained Sand

4'-0" TO 17'-6" Weathered OOLITIC LIMESTONE with pockets of Sand with Limestone and Cemented Sand Fragments 17'-6" TO 27'-6" Fine to Medium Grained SAND/SAND with Silt

27'-6" TO 50'-0" Weathered LIMESTONE with Cemented Sand Fragments

(SOURCE: SUBSURFACE EXPLORATION AND GEOTECHNICAL ENGINEERING EVALUATION BY JOSE N. GOMEZ, P.E. FROM PROFESSIONAL SERVICE INDUSTRIES, INC. IN MAY, 18 2022).

#### (3) ESTIMATES OF SIZE OF DRAINAGE AREA FOR EACH OUTFALL: N/A

E. FOR LOCATIONS OF DRAINAGE AREAS AND OUTFALLS: DRAINAGE IMPROVEMENTS PROVIDED ON DRAINAGE PLANS & DETAILS.

F. (1) NAME OF RECEIVING WATERS: N/A

(2) WETLAND AREA: N/A

#### CONTROLS

A. SEQUENCE OF SOIL DISTURBING ACTIVITIES AND IMPLEMENTATION CONTROLS

- a. CLEARING AND GRUBBING
- b. INSTALLATION DRAINAGE STRUCTURES c. STABILIZATION
- d. BASE PREPARATION
- e. ASPHALT APPLICATION
- PLACEMENT OF ROCK BAGS AROUND INLETS
- PLACEMENT OF ROCK BAGS AROUND MANHOLES
- APPLICATION OF FRICTION COURSE A.C.
- PAVEMENT MARKINGS
- REMOVE ROCK BAGS
- k. CLEAN ALL CONSTRUCTION DEBRIS FROM CONSTRUCTION SITE

#### B. EROSION AND SEDIMENT CONTROLS: (1) STABILIZATION PRACTICES:

THE CONTRACTOR WILL MAINTAIN THE INLET PROTECTION, SILT FENCE AND WILL PROVIDE DUST CONTROL.

#### (2) STRUCTURAL PRACTICES: - SILT FENCE

- WIND SCREEN
- FILTER FABRIC

#### C. DESCRIPTION OF STORM WATER MANAGEMENT:

CONTRACTOR SHALL INSTALL AND MAINTAIN THE EROSION AND SEDIMENT CONTROL DESCRIBED HEREIN. AFTER ANY RAIN EVENT, THE CONTRACTOR WILL REPAIR OR REPLACE ANY AFFECTED CONTROLS.

#### D. OTHER CONTROLS: (1) WASTE DISPOSAL:

ANY CONSTRUCTION DEBRIS GENERATED AS A RESULT OF THIS PROJECT WILL BE DISPOSED OF OFF-SITE AT AN APPROPRIATE WASTE DISPOSAL FACILITY.

- a) CONCRETE WASH OUT LOCATIONS WILL BE PROVIDED IN AREAS WHERE THE DISPOSAL MATERIALS WILL BE CONTAINED SO AS TO PREVENT DISCHARGE OUTSIDE OF THE PROJECT LIMITS AND INTO THE WATERWAYS.
- b) NEW AND EXISTING DRAINAGE STRUCTURES WILL BE PROTECTED WITH FILTER FABRIC
- c) STAGING AREAS WILL BE LOCATED WITHIN THE PROJECT WORK ZONE UNLESS REQUESTED OTHERWISE FOR APPROVAL d) LITTER WILL BE DEPOSITED IN APPROPRIATE LOCATIONS. A DUMPSTER MAY BE PROVIDED AT THE SITE DEPENDING ON THE
- AMOUNT OF LITTER GENERATED
- e) LOADED TRUCKS WILL BE COVERED WITHIN TARPAULIN f) SWEEPERS AND/OR WATER TRUCKS WILL BE PROVIDED TO REDUCE DUST DAILY
- g) SOIL PREVENTION TRACKING WILL BE INSTALLED AS PER THE SWPPP AND/OR AS DIRECTED BY CITY INSPECTOR

#### (1) OFFSITE VEHICLE TRACKING:

- X HAUL ROADS DAMPED FOR DUST CONTROL X LOADED HAUL TRUCKS TO BE COVERED WITH TARPAULIN
- X EXCESS DIRT ON ROAD REMOVED DAILY X STABILIZED CONSTRUCTION ENTRANCE
- \_X\_ WATER TRUCKS SCHEDULING X STREET SWEEPING (DAILY)
- \_\_\_\_ OTHER:

(2) SANITARY WASTE REGULARLY AND ADEQUATE MAINTENANCE SHALL BE PROVIDED TO THE TEMPORARY SANITARY FACILITIES

#### (3) FERTILIZERS, PESTICIDES AND TREES:

NUTRIENT FILTERS WILL BE PROVIDED TO THE PLANTERS. PROTECT ALL TREES WITHIN PROJECT LIMITS THAT ARE TO REMAIN AS PER FDOT INDEX NO. 544

#### (4) TOXIC SUBSTANCES:

TOXIC SUBSTANCES WILL NOT BE STORED ON SITE

#### (5) NON-STORM WATER DISCHARGE (INCLUDING SPILL REPORTING):

MODIFICATIONS WILL BE APPROVED BY THE CITY OF DORAL.

NO NON-STORM WATER DISCHARGES ARE ANTICIPATED AT THIS TIME. CONTAMINATED SOIL OR GROUNDWATER ENCOUNTERED SHALL BE REPORTED IMMEDIATELY TO THE CITY PERSONNEL IN ACCORDANCE WITH CITY OF DORAL PUBLIC WORKS.

(6) EROSION CONTROL DEVICES: LOCATIONS AND TYPES OF ALL EROSION CONTROL DEVICES SHALL BE INSTALLED AS DIRECTED BY DRAWINGS/PLAN AND/OR BY THE CITY OF DORAL. CONTRACTOR SHALL IMPLEMENT THE SWPPP AS PER DRAWINGS/PLAN & JURISDICTIONAL REQUIREMENTS. HOWEVER, IT MAY BE REVISED BASED ON ACTUAL FIELD CONDITIONS AT THE TIME WORK IS BEING PERFORMED. FIELD

MONITORING SHALL BE PERFORMED ON A WEEKLY BASIS AND AFTER 1/2" STORM EVENT WITH ROUTINE MAINTENANCE AND REPLACEMENT OF ANY DEVICES AS REQUIRED.

CONTAINMENT OR REMOVAL OF POLLUTANTS SHALL BE IN ACCORDANCE WITH ALL APPLICABLE STATE AND CITY OF DORAL REGULATIONS AND/OR FDOT STANDARD SPECIFICATIONS.

THE RESPONSIBLE PERSONS FOR MONITORING AND MAINTAINING THE EROSION CONTROL DEVICES SHALL BE SITE CONTRACTOR/CONTRACTOR'S DESIGNATED SUPERINTENDENT.

#### **REMARKS:**

IF CONTAMINATED SOIL OR GROUNDWATER IS ENCOUNTERED, CONTACT: CITY OF DORAL PUBLIC WORKS DEPARTMENT (305)

### E. APPROVED STATE, LOCAL PLANS, OR STORM WATER PERMITS: (CHECK ALL THAT APPLY)

- NPDES PERMIT (0.5 ACRE OR MORE) X NATIONAL POLLUTION DISCHARGE ELIMINATION SYSTEM (NPDES) PERMIT FROM THE FLORIDA DEPARTMENT OF
- ENVIRONMENTAL PROTECTION (FDEP) FOR PROJECTS DISTURBING MORE THAN 1 ACRE. X ENVIRONMENTAL RESOURCES PERMIT (ERP) FROM THE SOUTH FLORIDA WATER MANAGEMENT DISTRICT (SFWMD) \_\_\_\_ U.S. ARMY CORPS OF ENGINEERS DREDGE AND FILL PERMIT
- \_\_\_\_ SOUTH FLORIDA WATER MANAGEMENT DISTRICT (SFWMD) RIGHT-OF-WAY USE PERMIT X PUBLIC WORKS EXCAVATION PERMIT
- \_\_\_\_ POLICE X TREE PERMIT
- X CITY DEWATERING PERMIT
- \_\_\_\_ FDEP UIC PERMIT

#### 3. MAINTENANCE:

- ALL MEASURES WILL BE MAINTAINED IN GOOD WORKING ORDER; IF A REPAIR IS NECESSARY, IT WILL BE INITIATED WITHIN 24

BUILT UP SEDIMENT WILL BE REMOVED FROM SILT FENCE WHEN IT HAS REACHED ONE-THIRD OF THE HEIGHT OF THE FENCE. PROTECT ALL INLETS SURROUNDING CONSTRUCTION SITE.STREET SWEEPING AND DUST PREVENTION MUST BE IMPLEMENTED

#### 4. INSPECTIONS:

A. QUALIFIED PERSONNEL FROM THE CITY AND CONTRACTOR SHALL INSPECT THE ITEMS DAILY THROUGHOUT THE CONSTRUCTION

- B. PREPARATION OF THE CONTRACTOR'S WEEKLY REPORT IF INSPECTION, MAINTENANCE AND REPAIRS FOR THE CONTROL AND ABATEMENT OF EROSION AND WATER POLLUTION SHALL BE INCLUDED IN THE COST OF THE RESPECTIVE PAY ITEMS. WHERE SITES HAVE BEEN FINALLY STABILIZED, INSPECTIONS SHALL BE CONDUCTED WEEKLY AND SHALL INCLUDE THE FOLLOWING:
- DISTURBED AREAS OF THE SITE THAT HAVE NOT BEEN FINALLY STABILIZED. - AREAS USED FOR STORAGE OF MATERIALS THAT ARE EXPOSED TO PRECIPITATION

D. REMOVE EXCESS DIRT FROM ALL ROADS ADJACENT TO PROJECT AREA ON A DAILY BASIS.


- STRUCTURAL CONTROLS
- STORMWATER MANAGEMENT SYSTEMS
- LOCATIONS WHERE VEHICLES ENTER OR EXIT THE SITE STREET SWEEPING AND DUST CONTROL
- C. A MAINTENANCE INSPECTION REPORT WILL BE MADE AFTER EACH INSPECTION. IF REPAIR IS NECESSARY, IT WILL BE INITIATED WITHIN 24 HOURS OF THE REPORT.


### GENERAL:

- A. APPROVED STATE, LOCAL PLANS OR STORM WATER PERMITS.
- B. ALL OF THE CONTROLS SHALL BE MAINTAINED AT ALL TIMES.
- C. ALL CONTROLS SHALL BE INSPECTED DAILY. D. APPLY FERTILIZERS AND PESTICIDES ACCORDING TO STANDADRD SPECIFICATIONS, DESIGN AND

E. SEDIMENT FOUND IN DRAINAGE INSPECTION WILL REQUIRE DRAINAGE SYSTEM CLEANING BY CONTRACTOR.

- E. SPECIAL PROVISIONS.
- F. REPORT NON-STORM WATER DISCHARDE (INCLUDING SPILL) (305) 593-6740.
- G. VISIT www.dep.state.fl.us/water/stormwater/npdes/

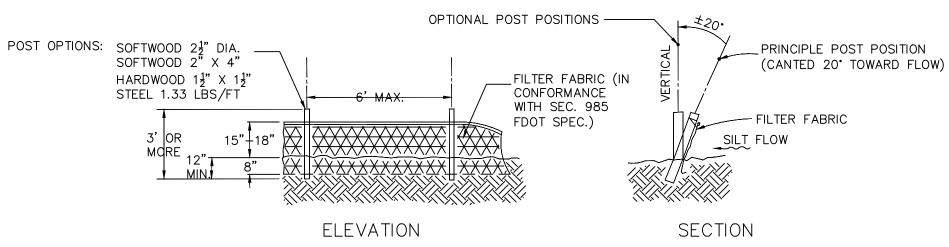


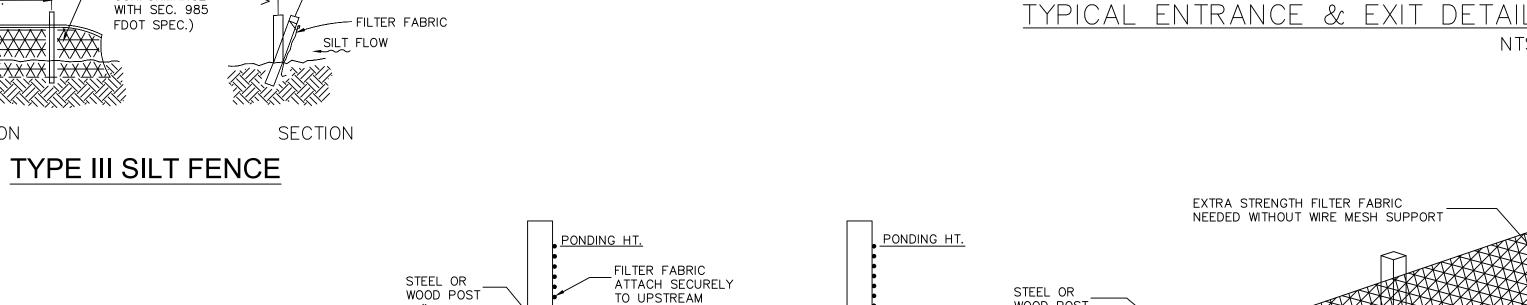

MATCH

EXIST

GRADE

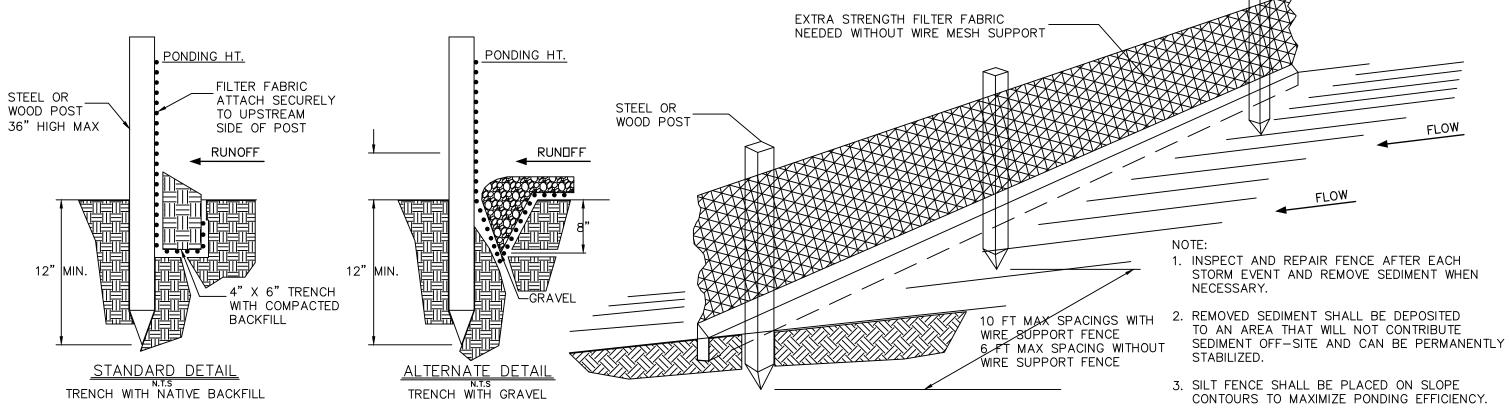

CRUSHED AGGREGATE GREATER THAN

-ORIGINAL GRADE

3 IN. BUT SMALLER THAN 6 IN.

CONSTRUCT SEDIMENT

RUNOFF TO SEDIMENT

TRAPPING DEVICE

'TEMPORARY PIPE

CULVERT AS NEEDED

50' Min

OR FOUR TIMES THE CIRCUMFERENCE OF THE LARGEST CONSTRUCTION VEHICLE TIRE,


WHICHEVER IS GREATER

BARRIER AND CHANNELIZE


FILTER FABRIC

SPECIFIED BY A SOILS ENGINEER

6 IN. MIN., UNLESS OTHERWISE

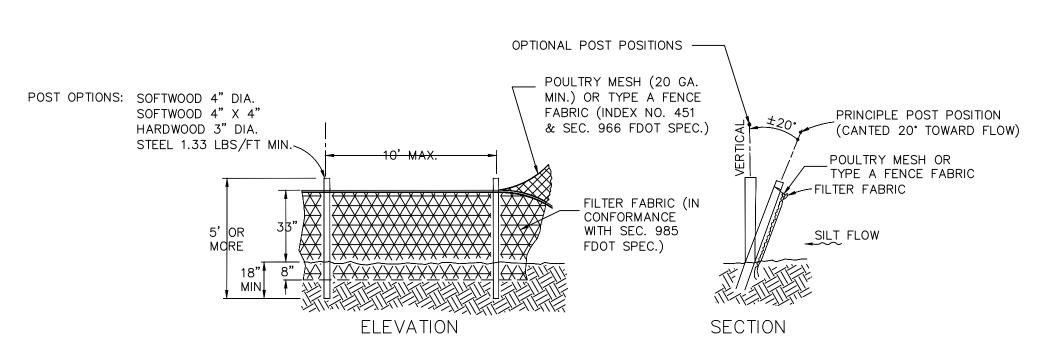



# TYPE IV SILT FENCE

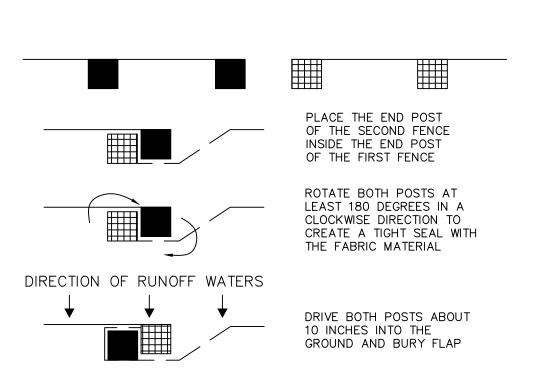

SILT FENCE ATTACHMENT DETAIL

# SILT FENCE INSTALLATION DETAIL

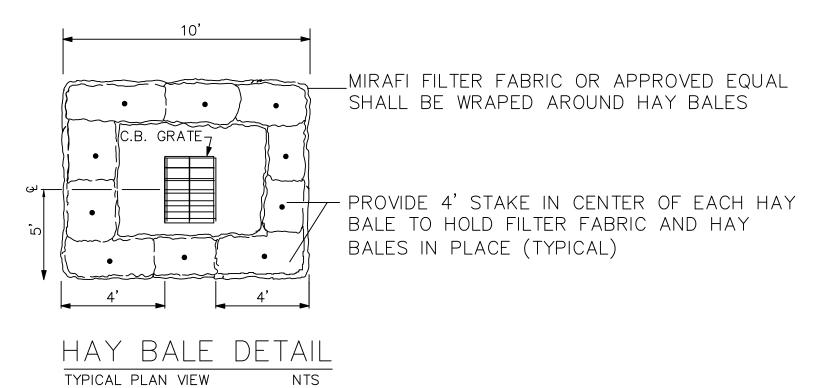

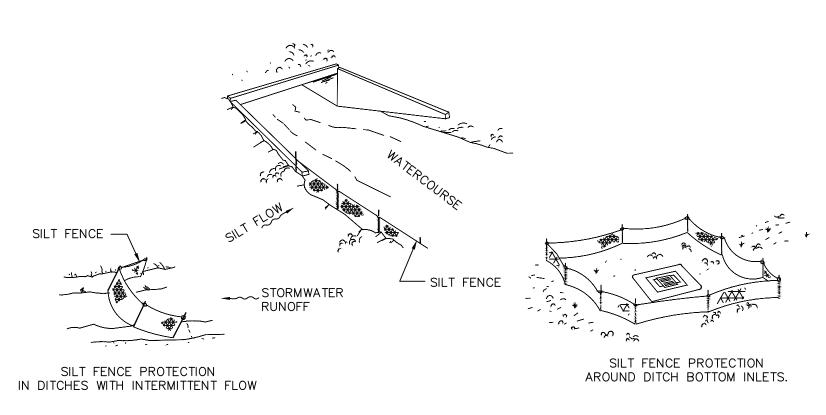

SILT FENCE APPLICATIONS



exp U.S. Services Inc. t: +1.305.631.2208| f: +1.407.660.1655 201 Alhambra Circle, Suite 800 Coral Gables, FL 33134 U.S.A. www.exp.com

> • BUILDINGS • EARTH & ENVIRONMENT • • ENERGY • INDUSTRIAL • INFRASTRUCTURE • SUSTAINABILITY

PROJECT:

### **LEGACY AT DORAL**

2525 NW 82ND AVENUE, DORAL, FL. 33122

OWNER:

## TheEastonGroup

101 N.W. 19 ST. MIAMI, FL 33172 TEL - (305) 593-2222 FAX - (305) 591-3863 www.theeastongroup.com

**≯** ō

PHASE:

#### **SCHEMATIC DESIGN**

REVISIONS		
Revision # Description		

THIS DOCUMENT HAS BEEN DIGITALLY SIGNED AND SEALED BY MIGUEL A.

LOCKWARD, P.E. ON THE DATE ADJACENT

THE SIGNATURE MUST BE VERIFIED ON THE

2/22/2023


21010276-A0

TO THE SEAL. PRINTED COPIES OF THIS DOCUMENT ARE NOT CONSIDERED SIGNED AND SEALED.

ELECTRONIC DOCUMENTS. THIS DRAWINGS IS THE PROPERTY OF EXP U.S. SERVICES, INC. UNLESS OTHERWISE PROVIDED FOR BY CONTRACT. THE CONTENTS OF THIS DRAWINGS ARE CONFIDENTIAL AND SHALL NOT BE TRANSMITTED TO ANY OTHER PARTY EXCEPT AS AGREED TO BY THE ARCHITECT/ENGINEERS.

DATE: PROJ No.: DRAWN BY: APPR BY:

SHEET NUMBER:

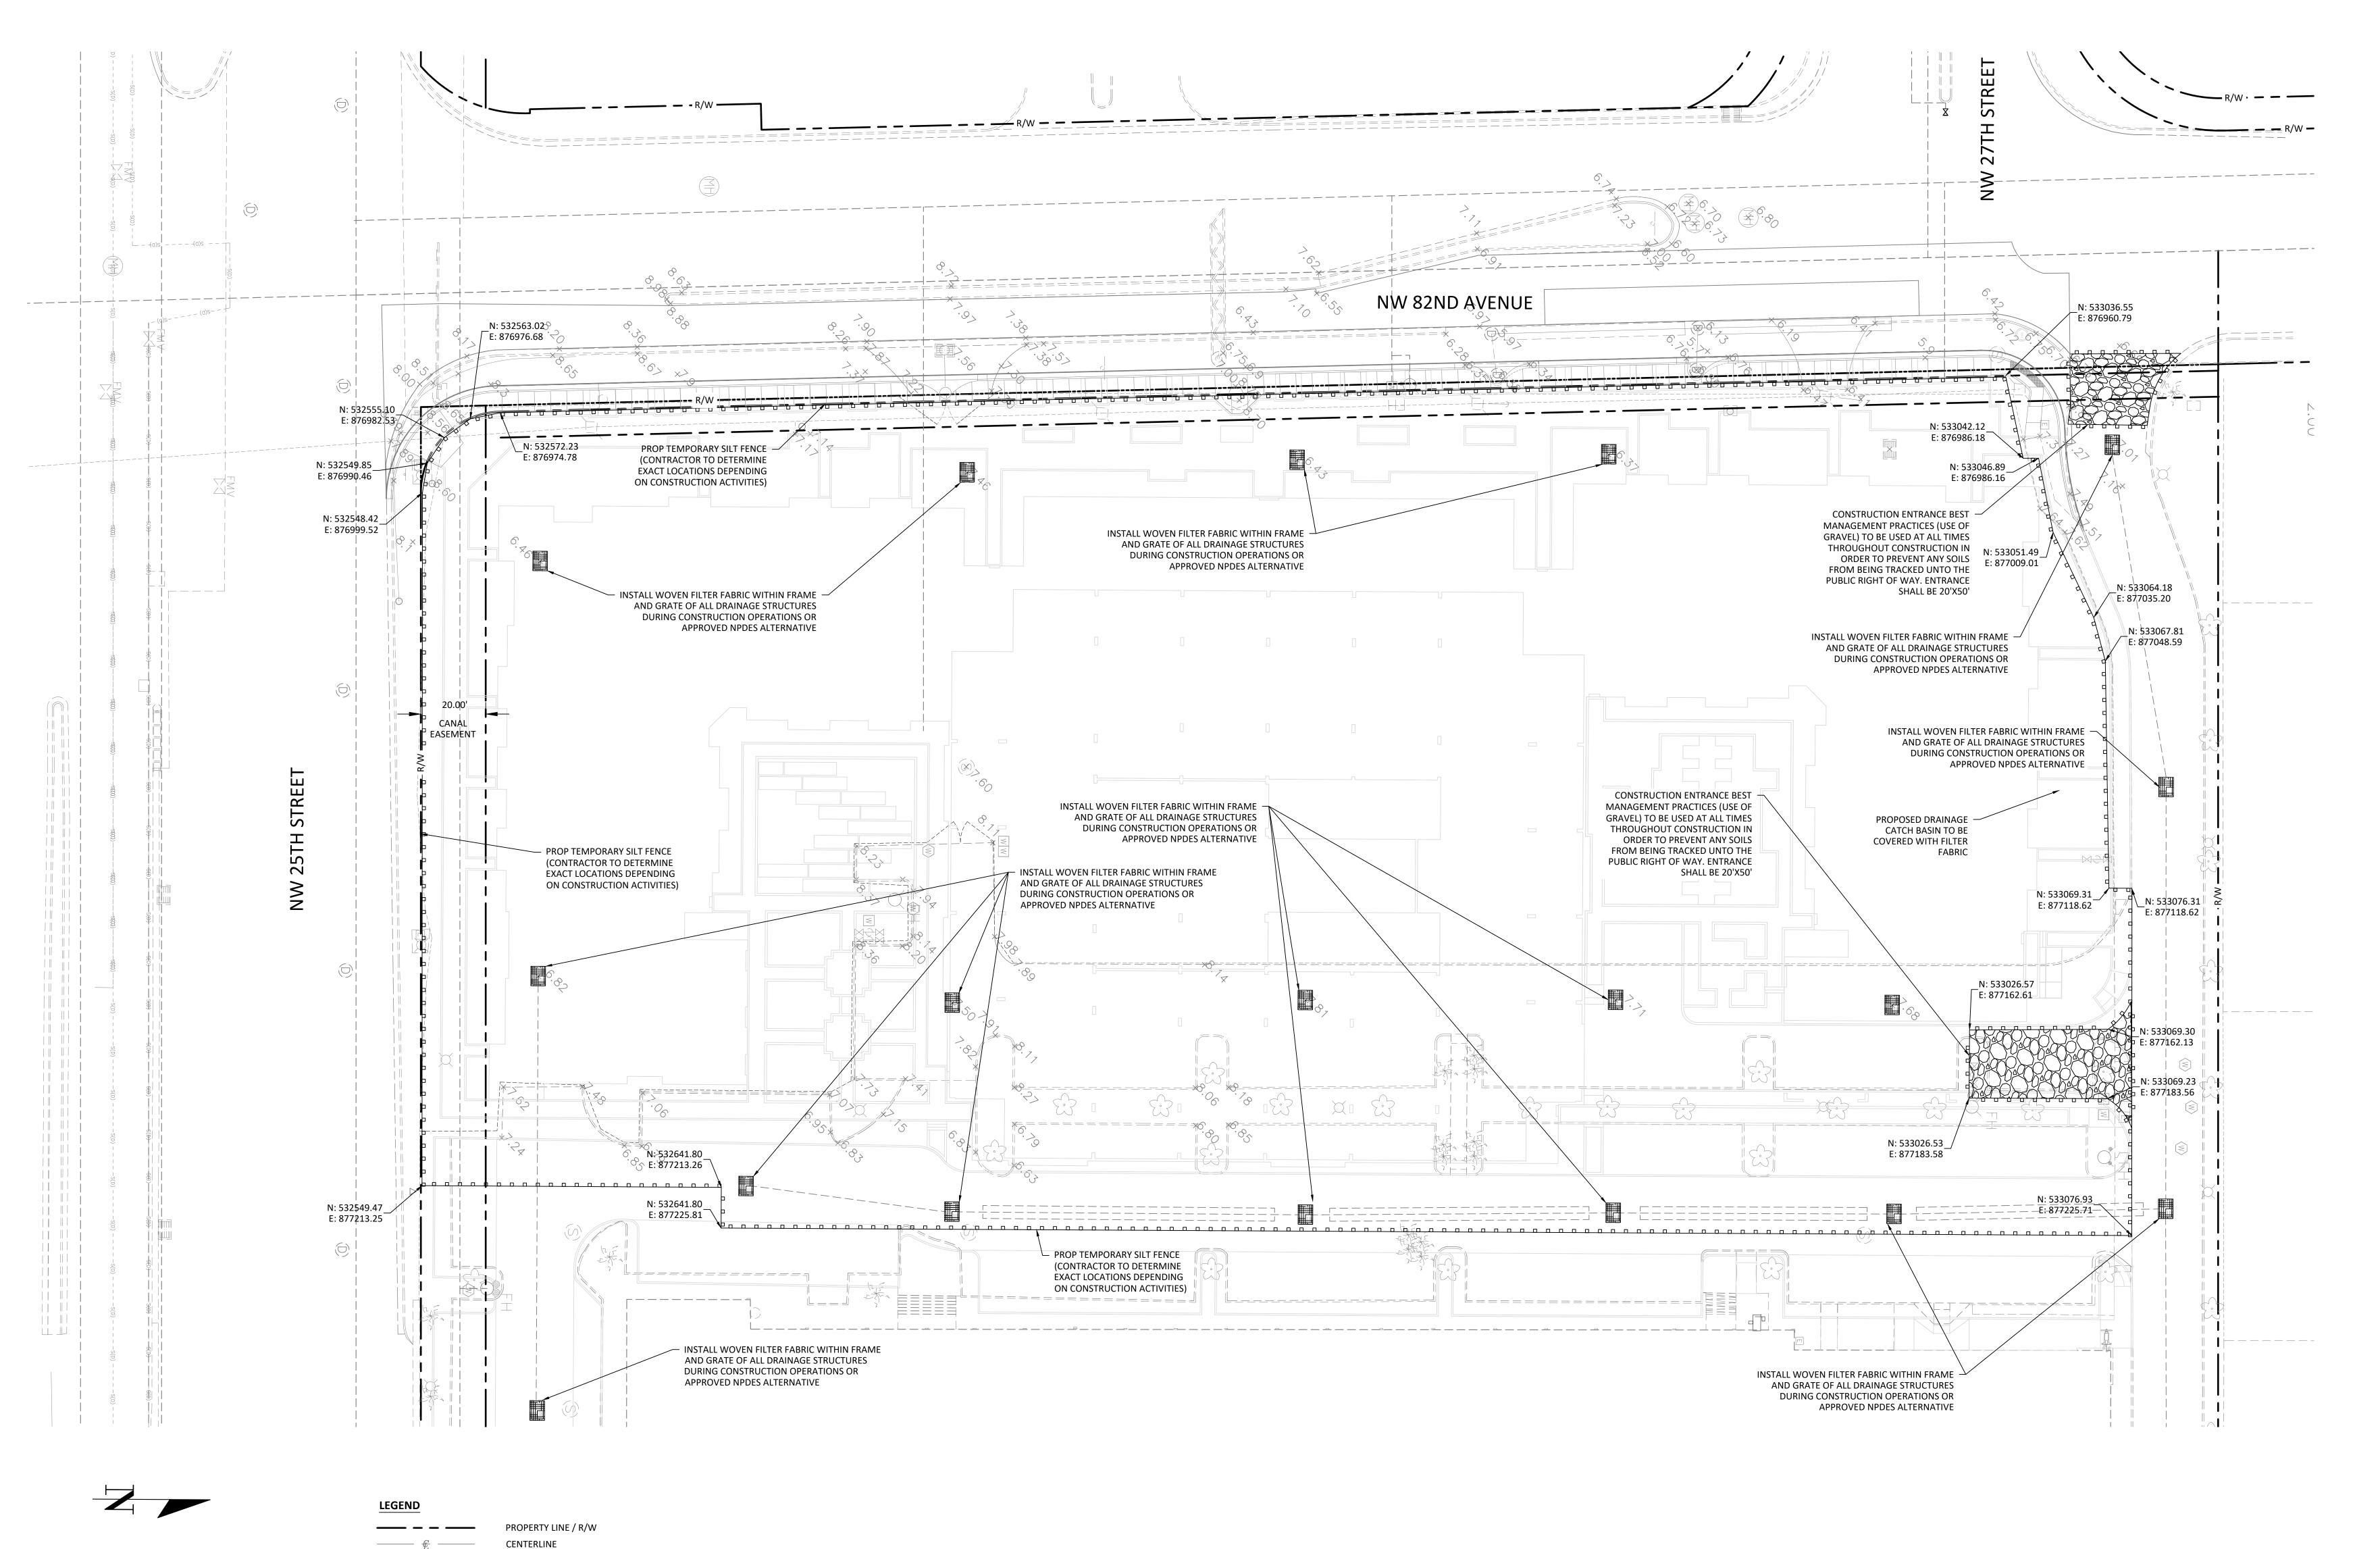

PROPOSED SITE

PROPOSED SILT FENCE

PROPOSED FILTER FABRIC

\_\_\_\_\_

Call 811 or visit sunshine811.com two full business days before digging to have buried facilities located and marked.

Check positive response codes before you dig!

THE OFFICIAL RECORD OF THIS SHEET IS THE ELECTRONIC FILE DIGITALLY SIGNED AND SEALED UNDER RULE 61G15-23.004, F.A.C.

exp U.S. Services Inc.

t: +1.305.631.2208| f: +1.407.660.1655
201 Alhambra Circle, Suite 800
Coral Gables, FL 33134
U.S.A.

www.exp.com

BUILDINGS • EARTH & ENVIRONMENT •

• ENERGY • INDUSTRIAL • INFRASTRUCTURE • • SUSTAINABILITY •

PROJECT:

## LEGACY AT DORAL

2525 NW 82ND AVENUE, DORAL, FL. 33122

OWNER:

# The East on Group


101 N.W. 19 ST. MIAMI, FL 33172 TEL - (305) 593-2222 FAX - (305) 591-3863 www.theeastongroup.com

FORM WATER POLLUTION
PREVENTION PLAN

PHA

### SCHEMATIC DESIGN

RI	EVISIONS	
Revision #	Revision Description	Date

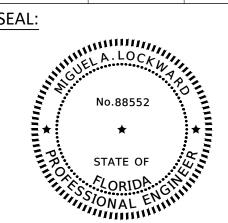

THIS DOCUMENT HAS BEEN DIGITALLY SIGNED AND SEALED BY MIGUEL A. LOCKWARD, P.E. ON THE DATE ADJACENT TO THE SEAL.

PRINTED COPIES OF THIS DOCUMENT ARE NOT CONSIDERED SIGNED AND SEALED. THE SIGNATURE MUST BE VERIFIED ON THE ELECTRONIC DOCUMENTS.


THIS DRAWINGS IS THE PROPERTY OF EXP U.S. SERVICES, INC.
UNLESS OTHERWISE PROVIDED FOR BY CONTRACT, THE
CONTENTS OF THIS DRAWINGS ARE CONFIDENTIAL AND
SHALL NOT BE TRANSMITTED TO ANY OTHER PARTY
EXCEPT AS AGREED TO BY THE ARCHITECT/ENGINEERS.

DATE:
PROJ No.:
DRAWN BY:
APPR BY:

2/22/2023 21010276-A0 MB DS

SHEET NUMBER:

C-2.02

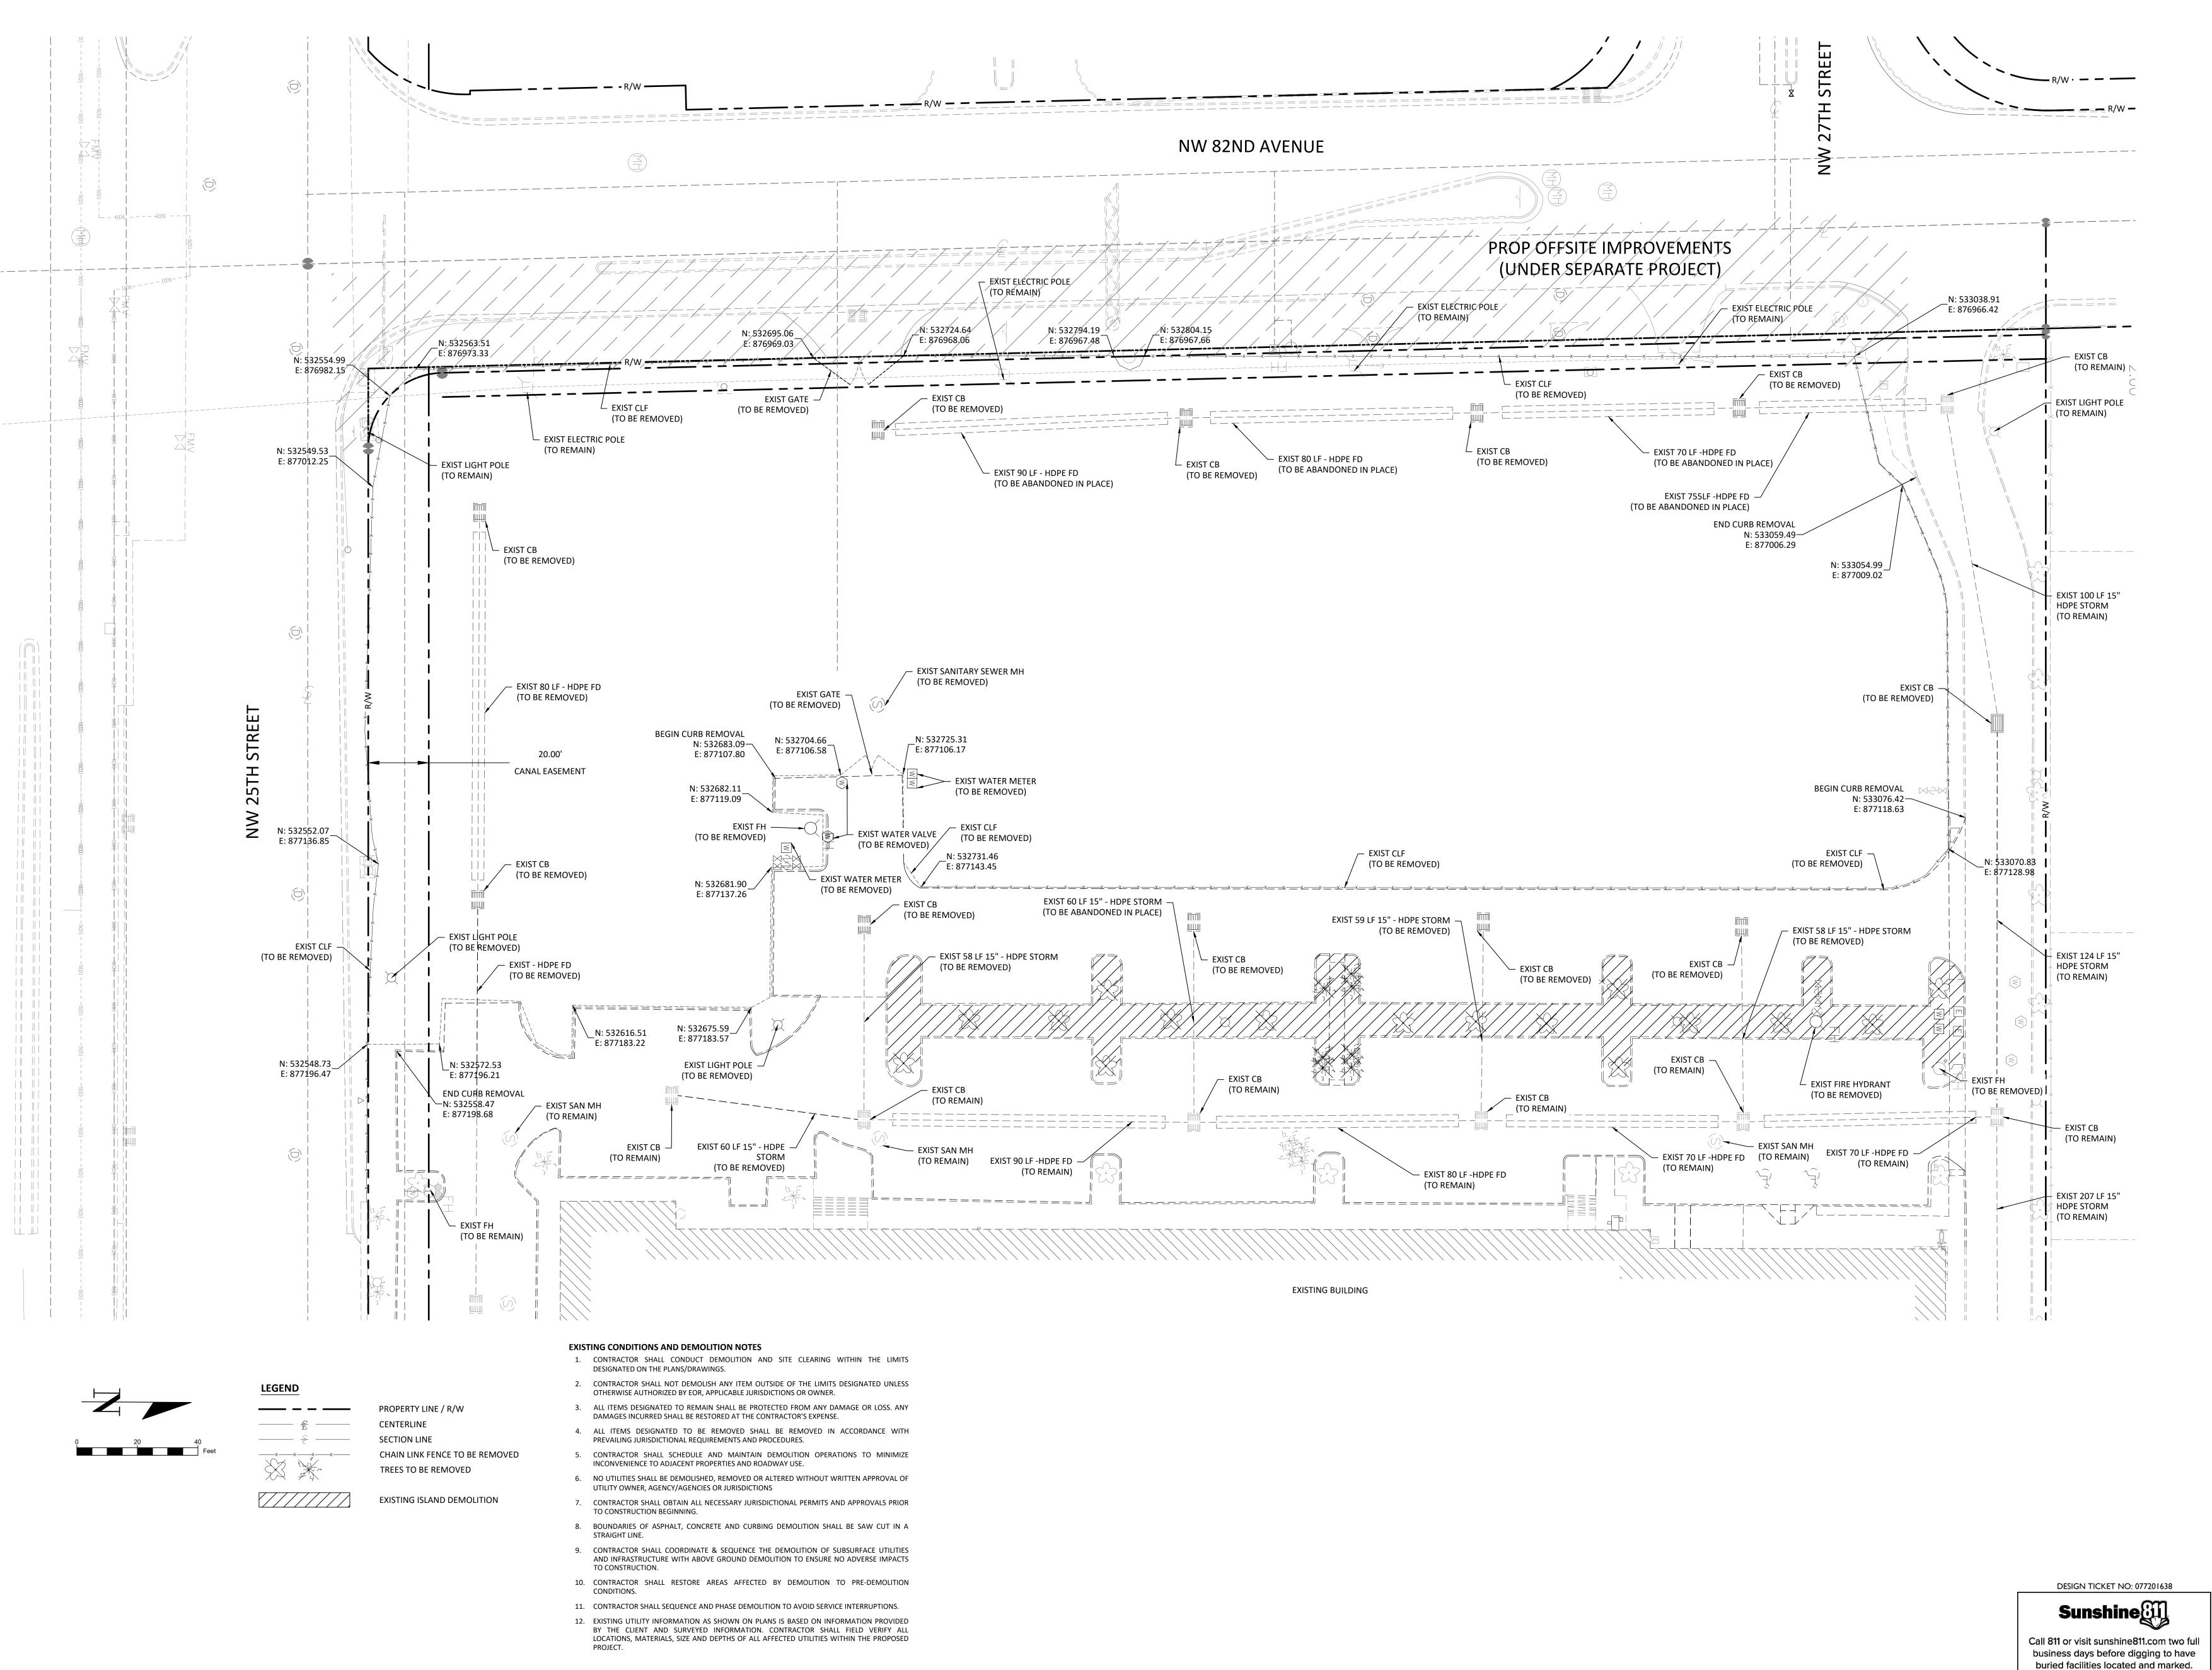

exp U.S. Services Inc.

t: +1.305.631.2208| f: +1.407.660.1655
201 Alhambra Circle, Suite 800
Coral Gables, FL 33134
U.S.A.

www.exp.com

Coral Gables, FL 33134 U.S.A. www.exp.com Cert of Auth: 29701

• SUSTAINABILITY •

• BUILDINGS • EARTH & ENVIRONMENT • • ENERGY • INDUSTRIAL • INFRASTRUCTURE •

PROJECT:

#### **LEGACY AT DORAL**

2525 NW 82ND AVENUE,

DORAL, FL. 33122

OWNER:

TheEastonGroup

101 N.W. 19 ST.

MIAMI, FL 33172

TEL - (305) 593-2222

FAX - (305) 591-3863


www.theeastongroup.com

(ISTING CONDITIONS AND DEMOLITION PLAN

ΡΗΔ

# SCHEMATIC DESIGN

RI	EVISIONS	
Revision #	Revision Description	Date

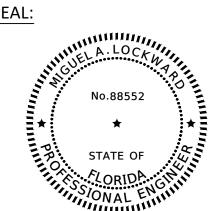

THIS DOCUMENT HAS BEEN DIGITALLY SIGNED AND SEALED BY MIGUEL A. LOCKWARD, P.E. ON THE DATE ADJACENT TO THE SEAL.

PRINTED COPIES OF THIS DOCUMENT ARE NOT CONSIDERED SIGNED AND SEALED. THE SIGNATURE MUST BE VERIFIED ON THE ELECTRONIC DOCUMENTS.

THIS DRAWINGS IS THE PROPERTY OF EXP U.S. SERVICES, INC.
UNLESS OTHERWISE PROVIDED FOR BY CONTRACT, THE
CONTENTS OF THIS DRAWINGS ARE CONFIDENTIAL AND
SHALL NOT BE TRANSMITTED TO ANY OTHER PARTY
EXCEPT AS AGREED TO BY THE ARCHITECT/ENGINEERS.

DATE:
PROJ No.:
DRAWN BY:
APPR BY:

Check positive response codes before you dig!


THE OFFICIAL RECORD OF THIS SHEET IS THE ELECTRONIC FILE DIGITALLY SIGNED AND SEALED UNDER RULE 61G15-23.004, F.A.C.

2/22/2023

21010276-A0

SHEET NUMBER:

C-3.01

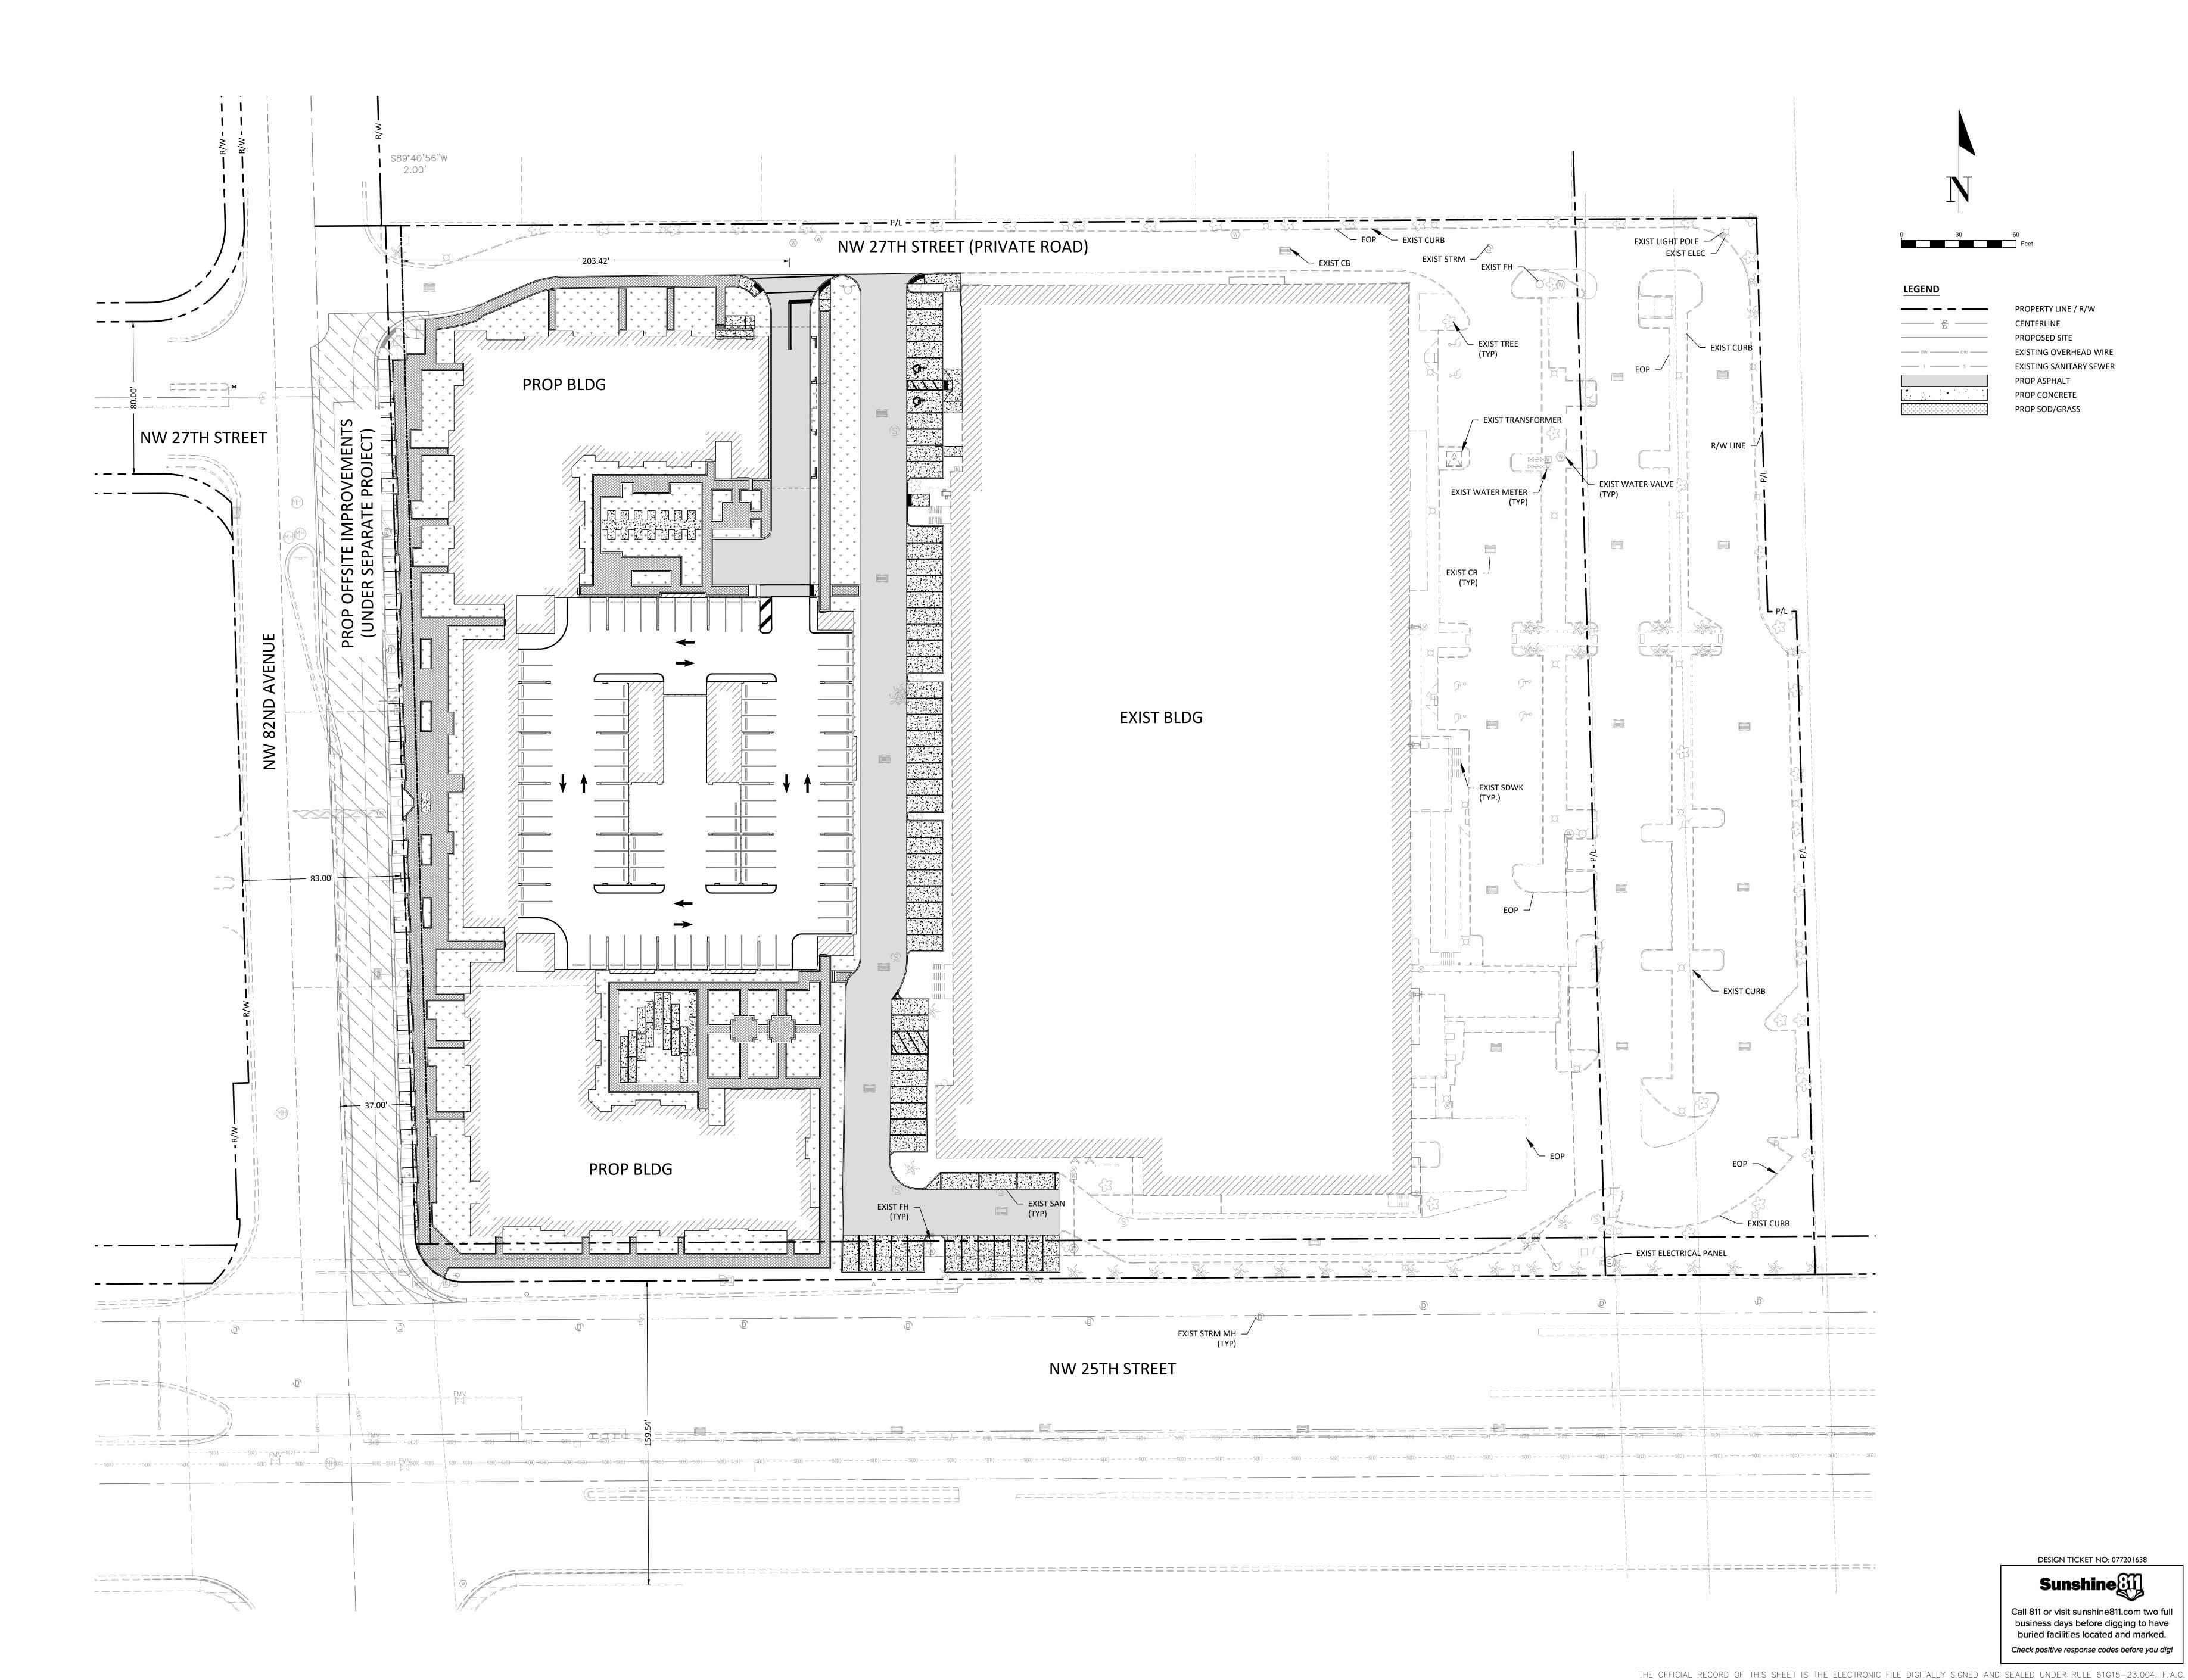

exp U.S. Services Inc.

t: +1.305.631.2208| f: +1.407.660.1655
201 Alhambra Circle, Suite 800
Coral Gables, FL 33134
U.S.A.

www.exp.com
Cert of Auth: 29701

BUILDINGS • EARTH & ENVIRONMENT •

PROJECT:

### LEGACY AT DORAL

2525 NW 82ND AVENUE, DORAL, FL. 33122

• ENERGY • INDUSTRIAL • INFRASTRUCTURE •

SUSTAINABILITY

OWNER:

### \_

TheEastonGroup

101 N.W. 19 ST.

MIAMI, FL 33172

TEL - (305) 593-2222

FAX - (305) 591-3863


www.theeastongroup.com

**VERALL SITE PLAN** 

DHASE.

# SCHEMATIC DESIGN

RI	EVISIONS	
Revision #	Revision Description	Date

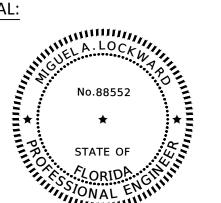

THIS DOCUMENT HAS BEEN DIGITALLY SIGNED AND SEALED BY MIGUEL A. LOCKWARD, P.E. ON THE DATE ADJACENT TO THE SEAL.

PRINTED COPIES OF THIS DOCUMENT ARE NOT CONSIDERED SIGNED AND SEALED. THE SIGNATURE MUST BE VERIFIED ON THE ELECTRONIC DOCUMENTS.


THIS DRAWINGS IS THE PROPERTY OF EXP U.S. SERVICES, INC.
UNLESS OTHERWISE PROVIDED FOR BY CONTRACT, THE
CONTENTS OF THIS DRAWINGS ARE CONFIDENTIAL AND
SHALL NOT BE TRANSMITTED TO ANY OTHER PARTY
EXCEPT AS AGREED TO BY THE ARCHITECT/ENGINEERS.

DATE:
PROJ No.:
DRAWN BY:
APPR BY:

2/22/2023 21010276-A0 MB DS

SHEET NUMBER:

C-4.01

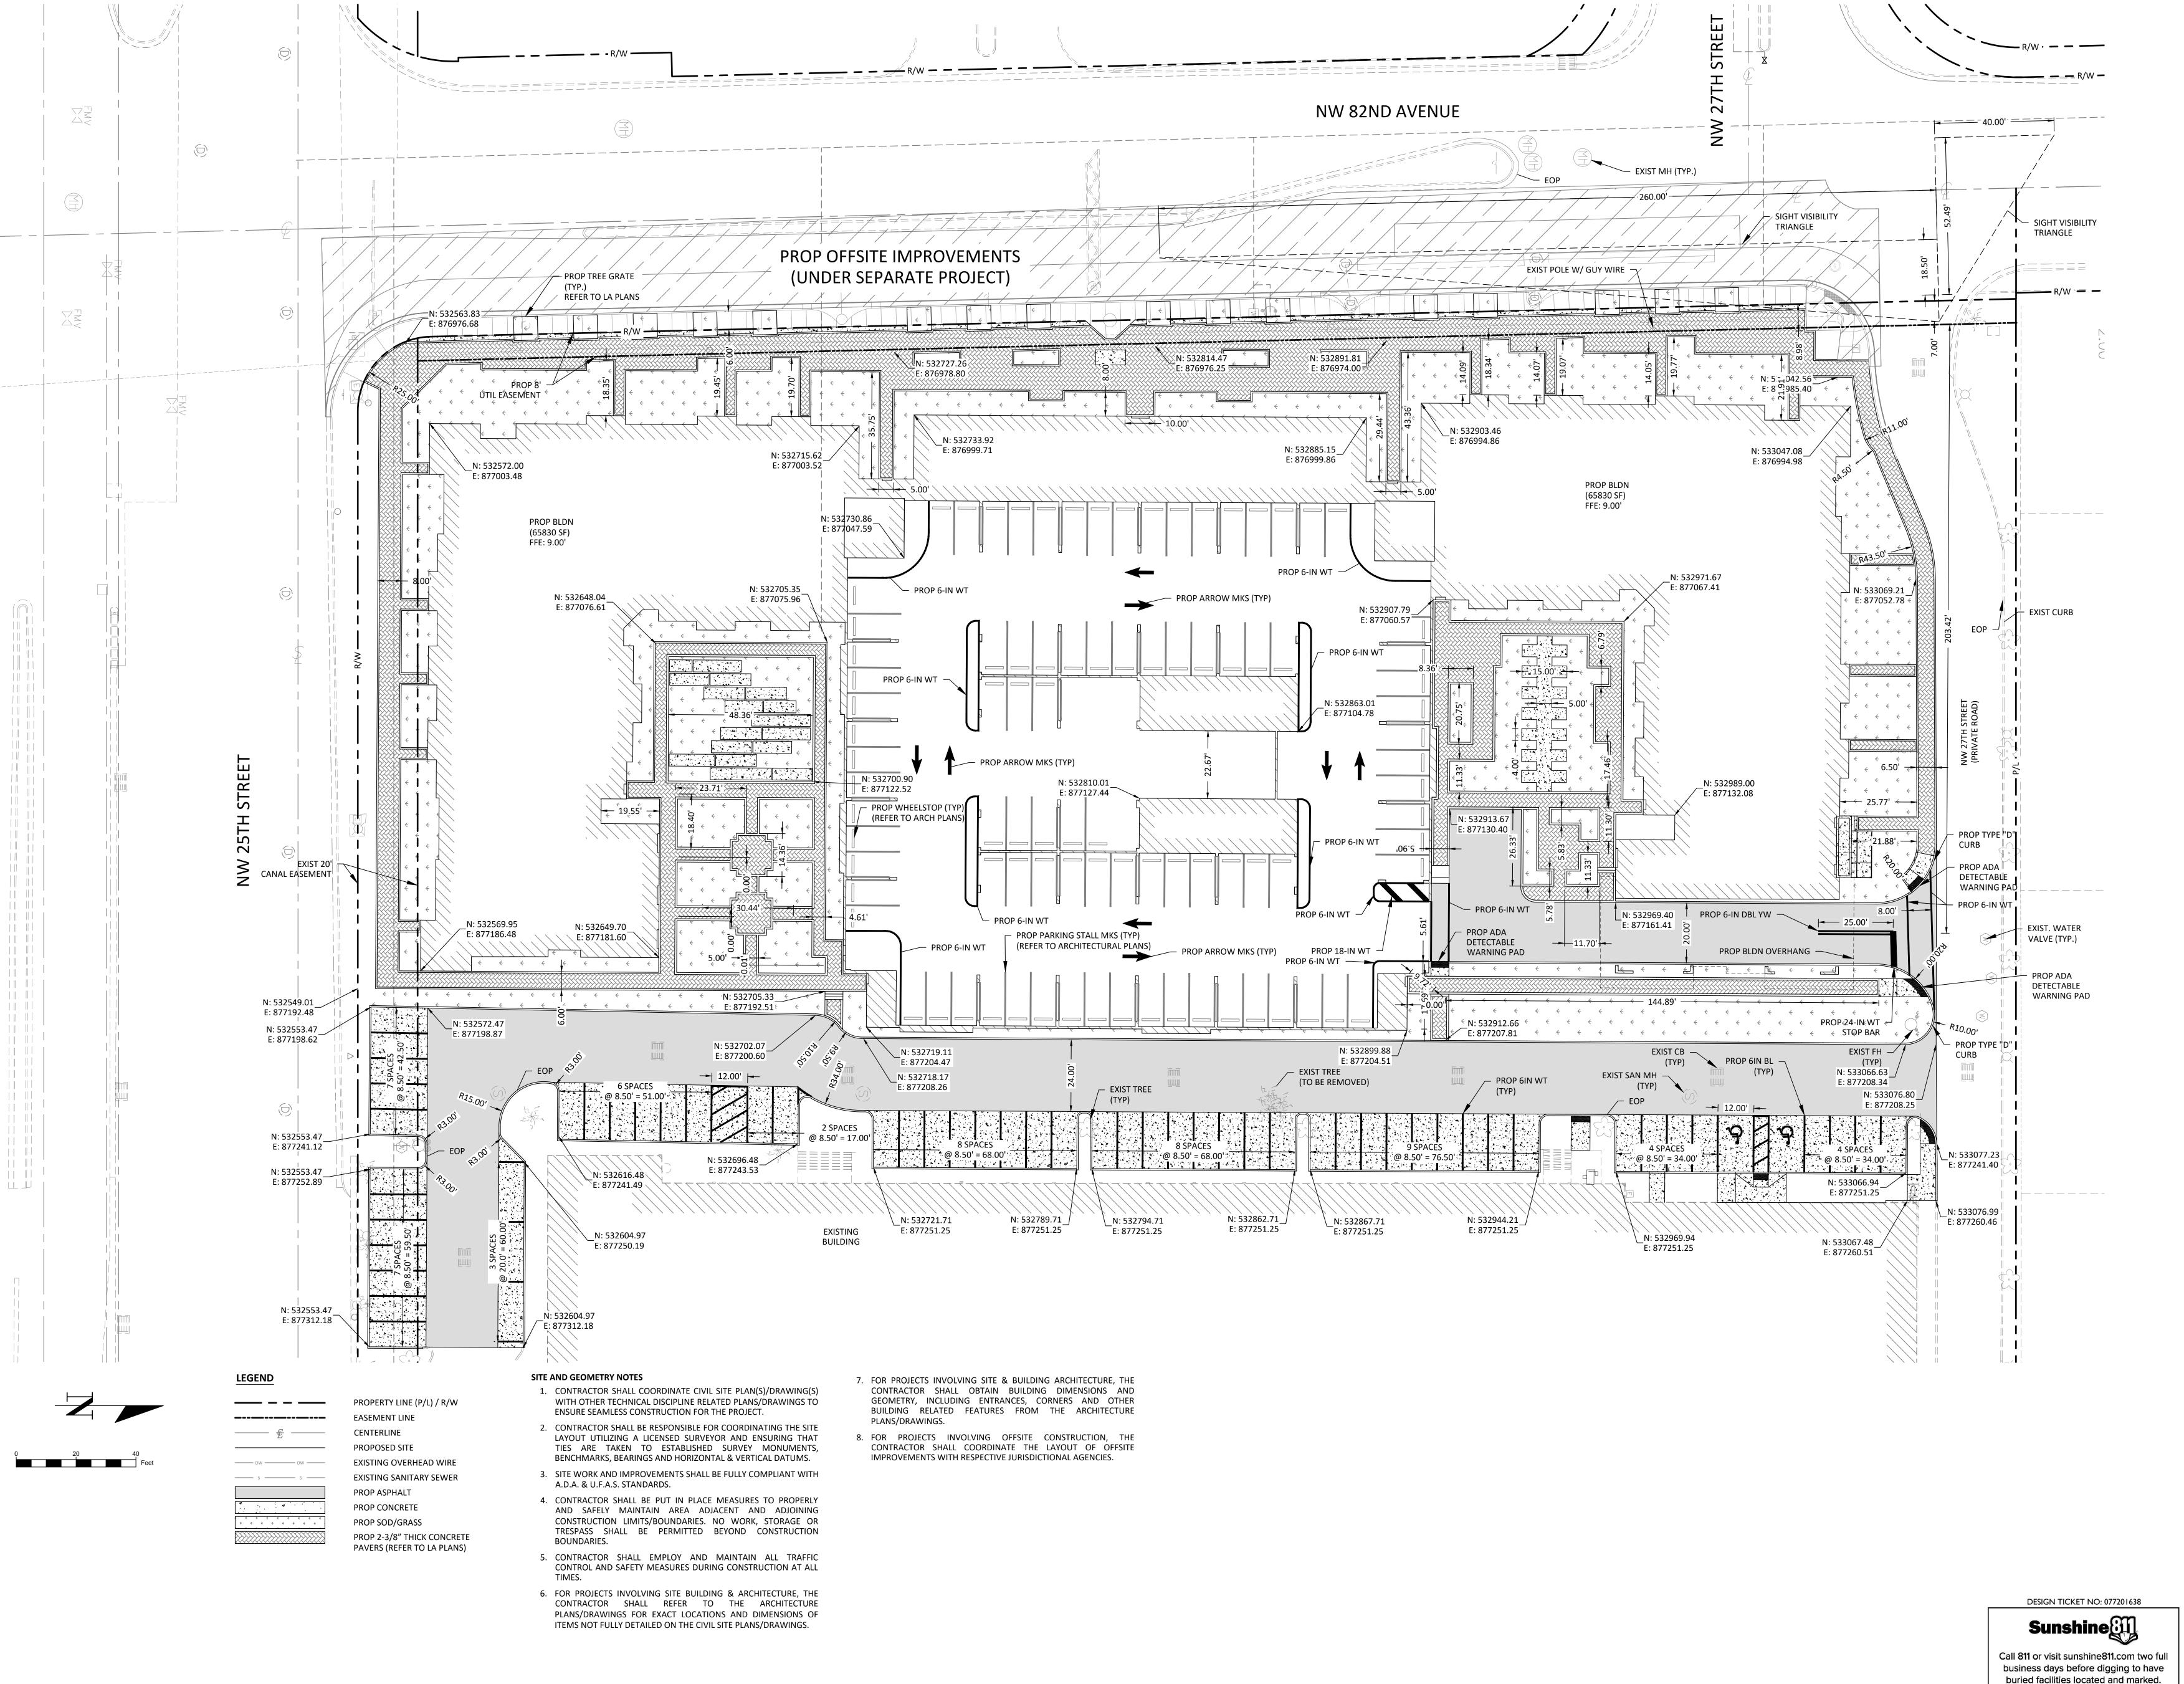

exp U.S. Services Inc. t: +1.305.631.2208| f: +1.407.660.1655 201 Alhambra Circle, Suite 800 Coral Gables, FL 33134 U.S.A.

U.S.A.

www.exp.com

Cert of Auth: 29701

BUILDINGS • EARTH & ENVIRONMENT •
 ENERGY • INDUSTRIAL • INFRASTRUCTURE •
 SUSTAINABILITY •

PROJECT:

#### **LEGACY AT DORAL**

2525 NW 82ND AVENUE,

DORAL, FL. 33122

OWNER:

\_\_\_\_

The East on Group


101 N.W. 19 ST.
MIAMI, FL 33172
TEL - (305) 593-2222
FAX - (305) 591-3863
www.theeastongroup.com

SITE PLAN

PHASE:

SCHEMATIC DESIGN

RI	EVISIONS		
Revision #	Revision Description	Date	

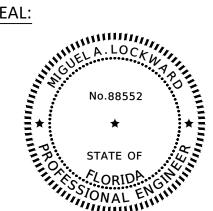

THIS DOCUMENT HAS BEEN DIGITALLY SIGNED AND SEALED BY MIGUEL A. LOCKWARD, P.E. ON THE DATE ADJACENT TO THE SEAL.

PRINTED COPIES OF THIS DOCUMENT ARE NOT CONSIDERED SIGNED AND SEALED. THE SIGNATURE MUST BE VERIFIED ON THE ELECTRONIC DOCUMENTS.

THIS DRAWINGS IS THE PROPERTY OF EXP U.S. SERVICES, INC.
UNLESS OTHERWISE PROVIDED FOR BY CONTRACT, THE
CONTENTS OF THIS DRAWINGS ARE CONFIDENTIAL AND
SHALL NOT BE TRANSMITTED TO ANY OTHER PARTY
EXCEPT AS AGREED TO BY THE ARCHITECT/ENGINEERS.

DATE:
PROJ No.:
DRAWN BY:
APPR BY:


Check positive response codes before you dig!

THE OFFICIAL RECORD OF THIS SHEET IS THE ELECTRONIC FILE DIGITALLY SIGNED AND SEALED UNDER RULE 61G15-23.004, F.A.C.

2/22/2023 21010276-A0 MB DS

SHEET NUMBER:

C-4.02

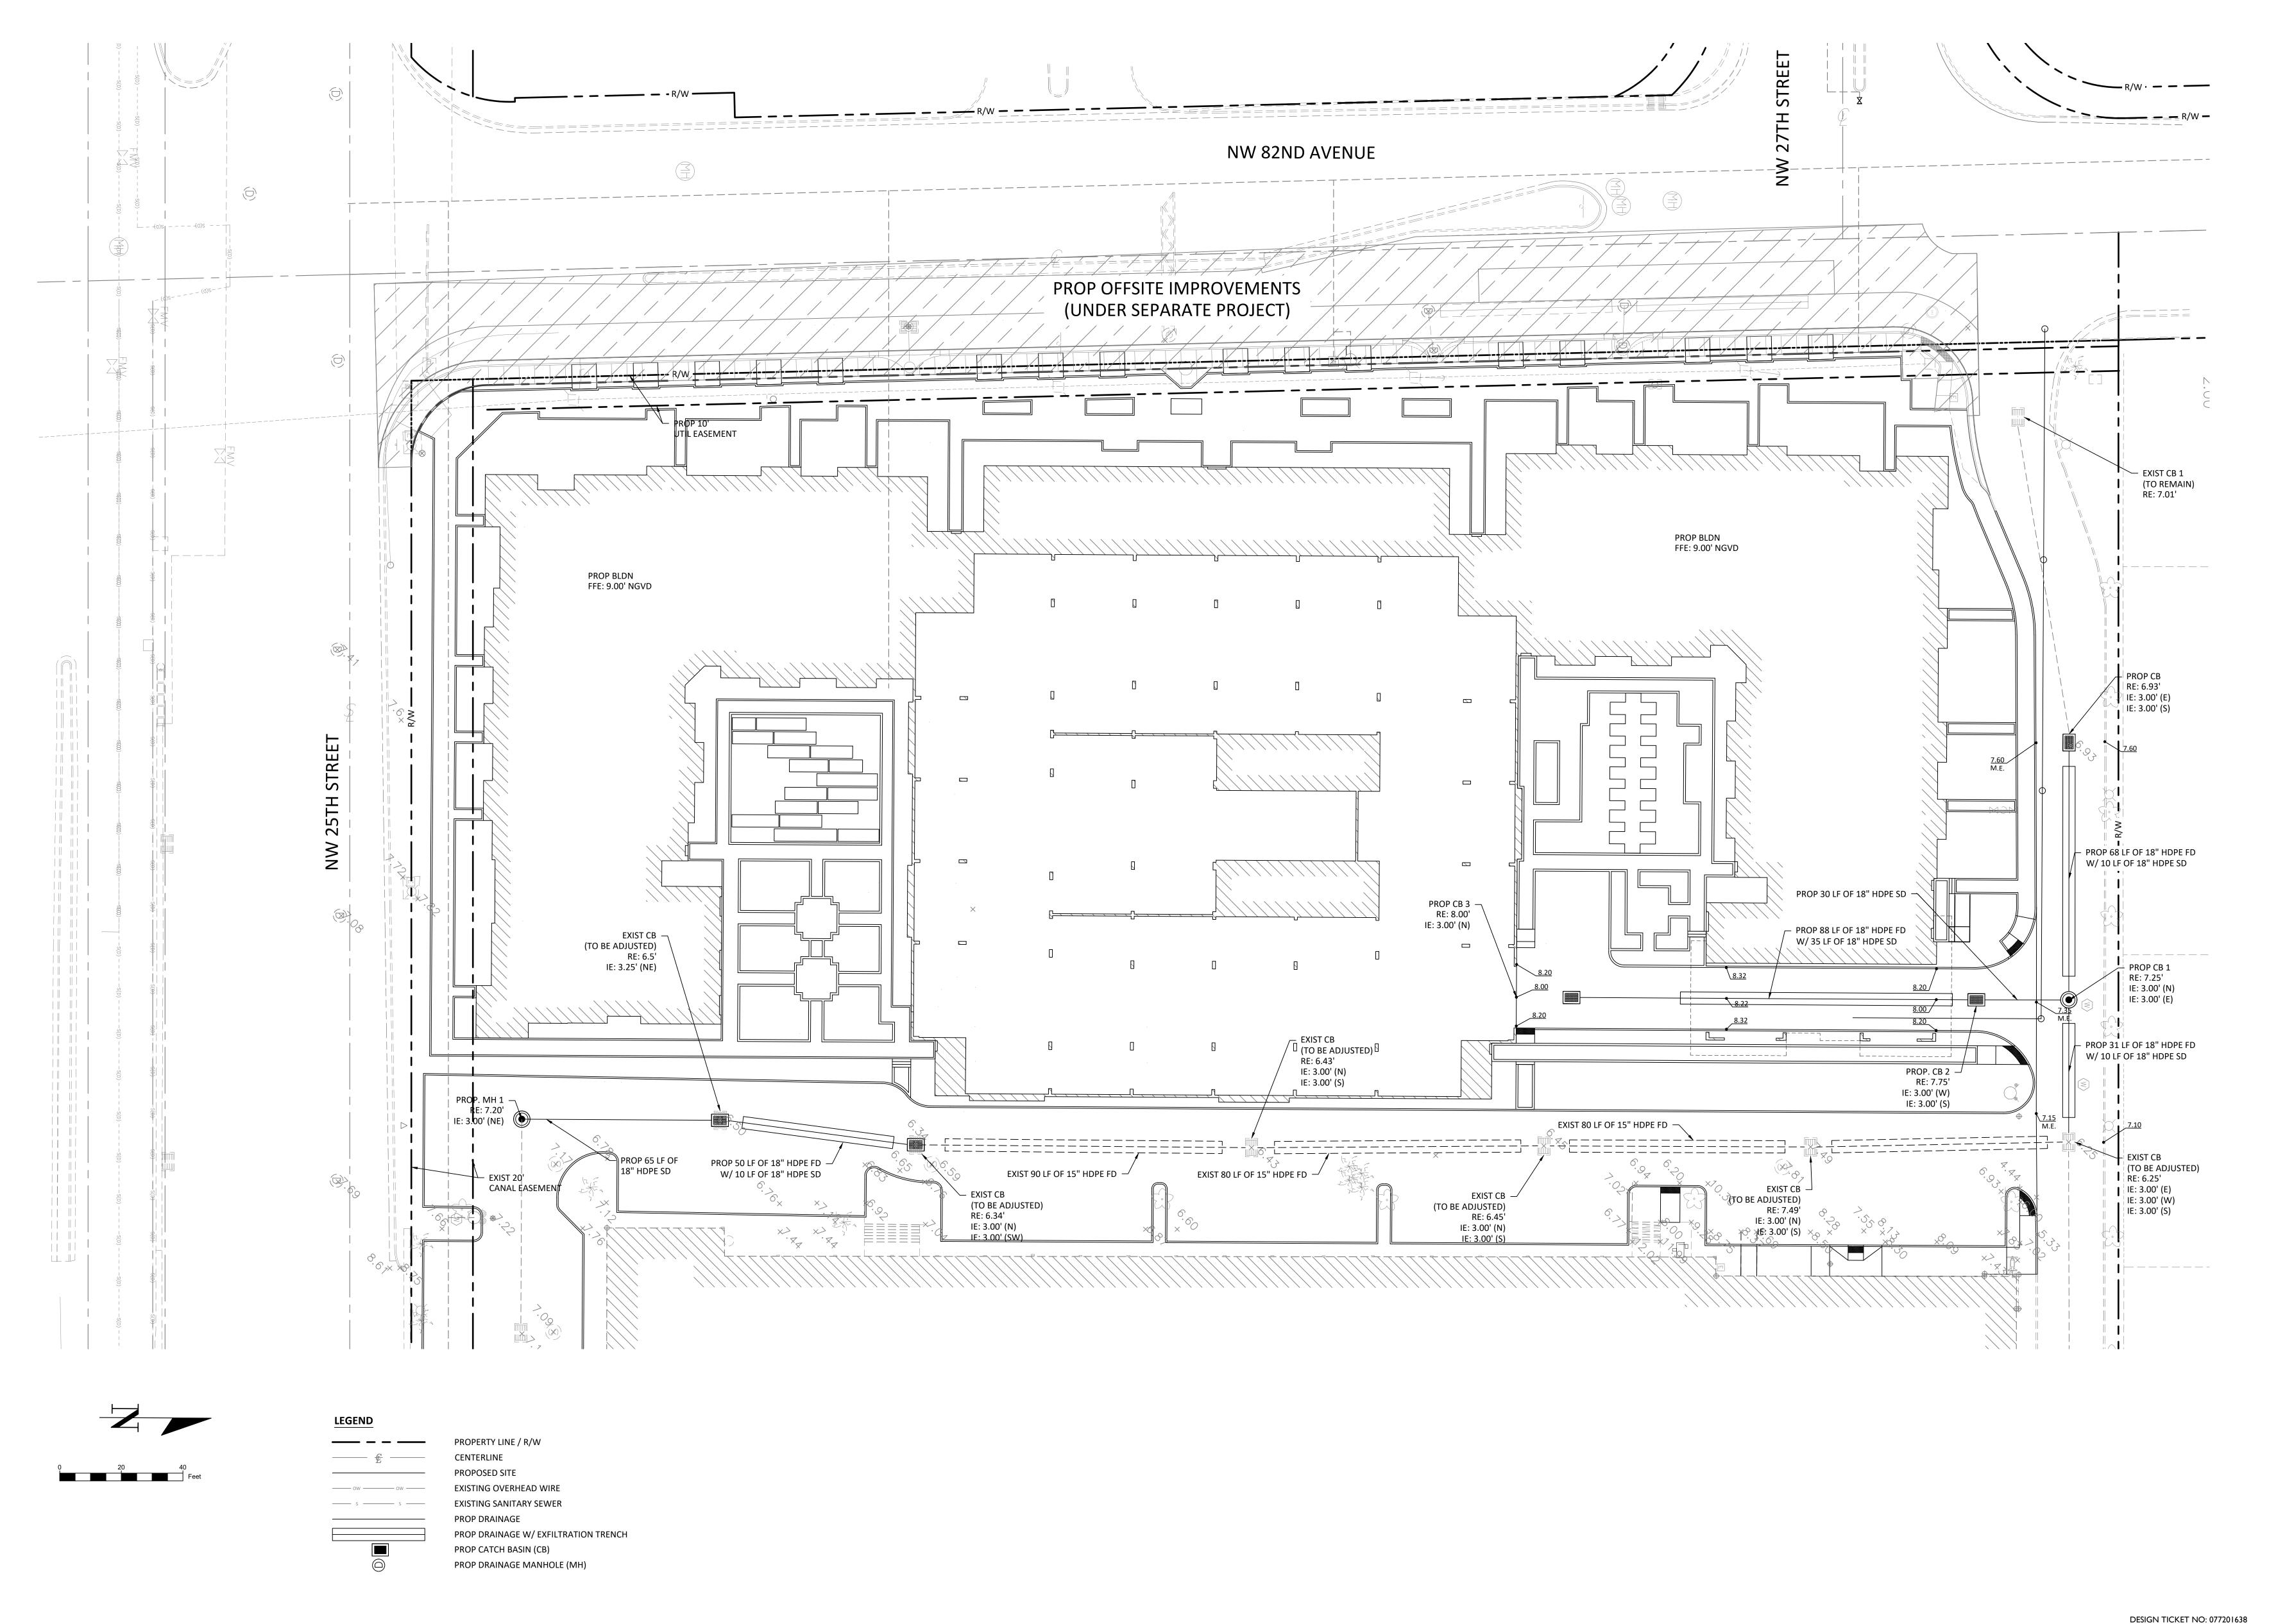

exp U.S. Services Inc. t: +1.305.631.2208| f: +1.407.660.1655 201 Alhambra Circle, Suite 800 Coral Gables, FL 33134 U.S.A.

oral Gables, FL 33134
S.A.

www.exp.com

ert of Auth: 29701

• BUILDINGS • EARTH & ENVIRONMENT • • ENERGY • INDUSTRIAL • INFRASTRUCTURE •

• SUSTAINABILITY •

PROJECT:

**LEGACY AT DORAL** 

2525 NW 82ND AVENUE, DORAL, FL. 33122

OWNER:

The East on Group

101 N.W. 19 ST.
MIAMI, FL 33172
TEL - (305) 593-2222
FAX - (305) 591-3863


www.theeastongroup.com

**AVING, GRADING AND DRAINAGE PLAN** 

PHASE:

SCHEMATIC DESIGN

REVISIONS		
Revision #	Revision Description	Date

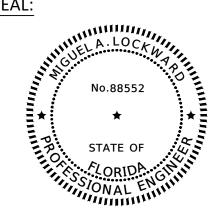

THIS DOCUMENT HAS BEEN DIGITALLY SIGNED AND SEALED BY MIGUEL A. LOCKWARD, P.E. ON THE DATE ADJACENT TO THE SEAL.

PRINTED COPIES OF THIS DOCUMENT ARE NOT CONSIDERED SIGNED AND SEALED. THE SIGNATURE MUST BE VERIFIED ON THE ELECTRONIC DOCUMENTS.

THIS DRAWINGS IS THE PROPERTY OF EXP U.S. SERVICES, INC.
UNLESS OTHERWISE PROVIDED FOR BY CONTRACT, THE
CONTENTS OF THIS DRAWINGS ARE CONFIDENTIAL AND
SHALL NOT BE TRANSMITTED TO ANY OTHER PARTY
EXCEPT AS AGREED TO BY THE ARCHITECT/ENGINEERS.

DATE:
PROJ No.:
DRAWN BY:
APPR BY:

**Sunshine** 

Call 811 or visit sunshine811.com two full business days before digging to have

buried facilities located and marked.


Check positive response codes before you dig!


THE OFFICIAL RECORD OF THIS SHEET IS THE ELECTRONIC FILE DIGITALLY SIGNED AND SEALED UNDER RULE 61G15-23.004, F.A.C.


2/22/2023 21010276-A0 MB DS

NUMBER:


SHEET NUMBER:

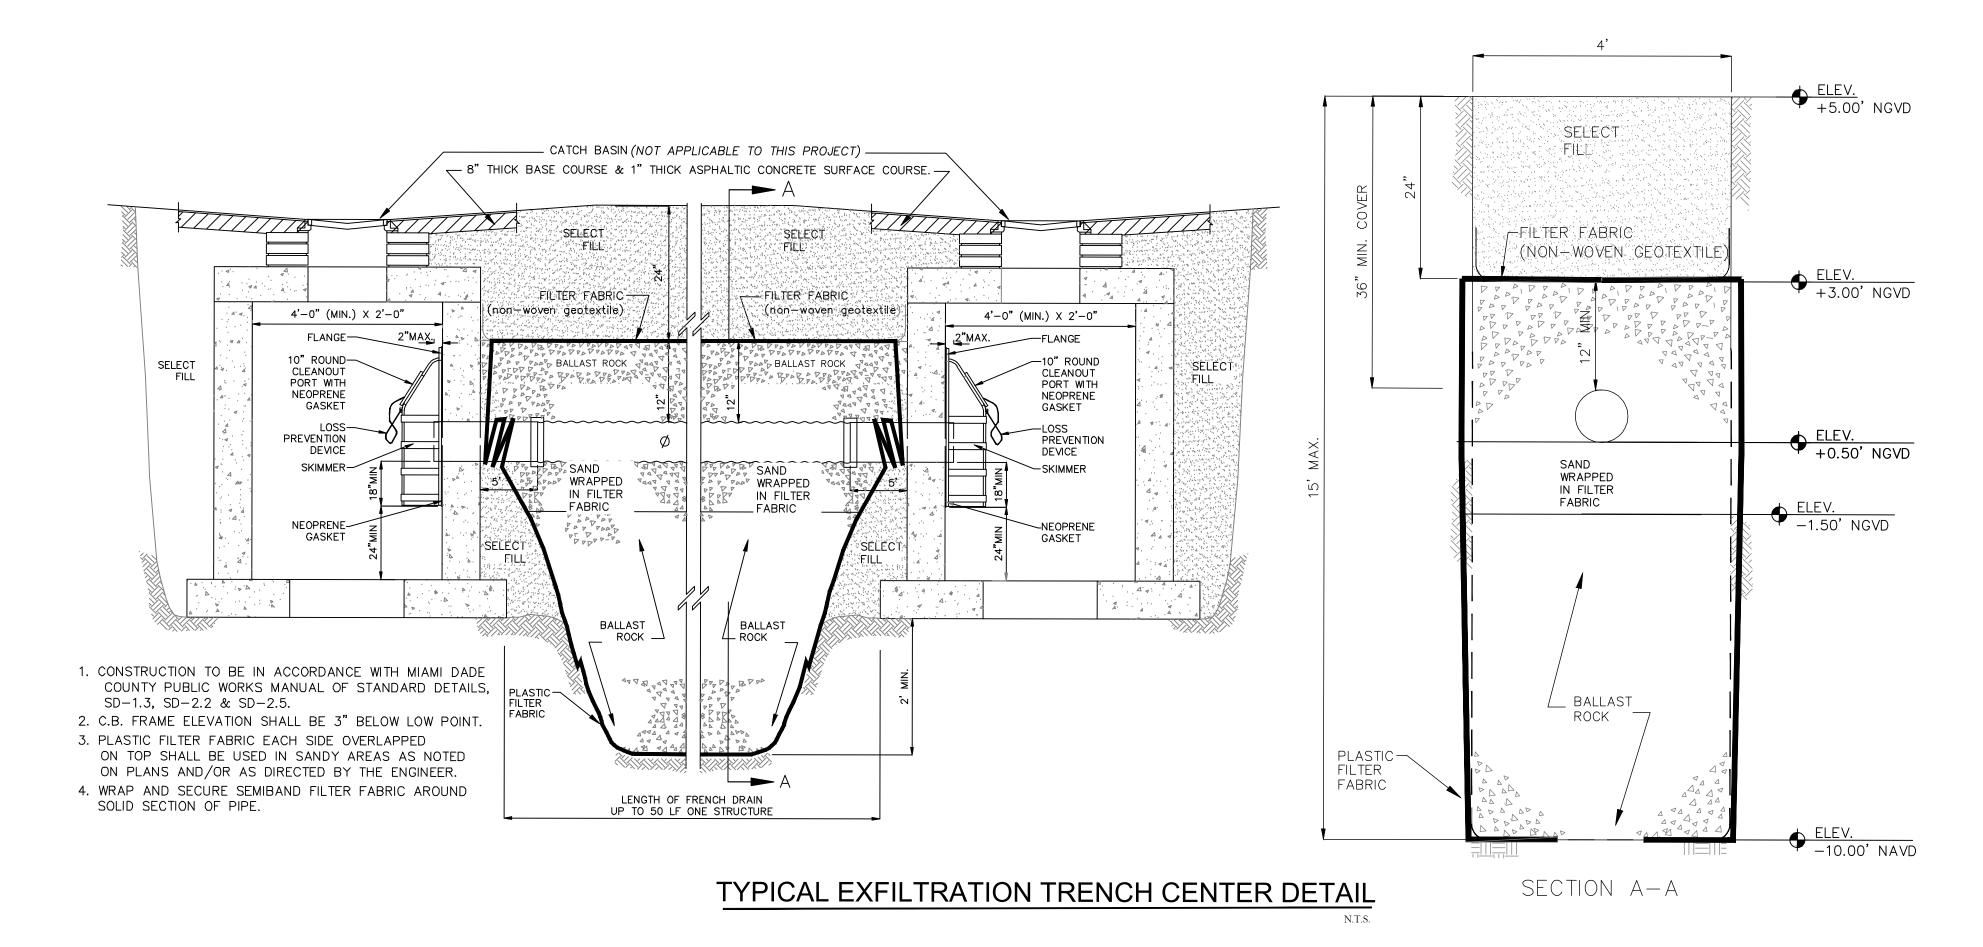

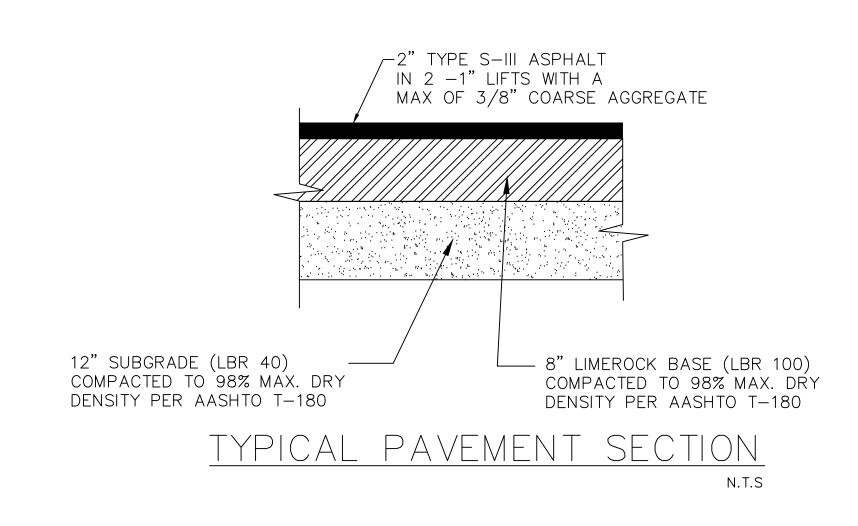

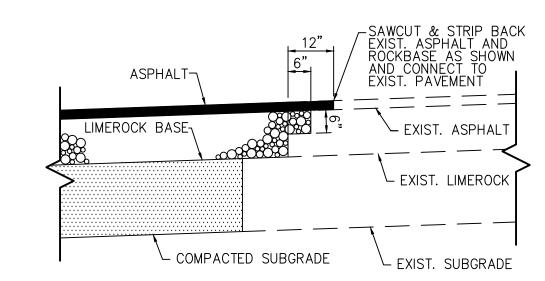

CONNECTION TO EXISTING PAVEMENT DETAIL

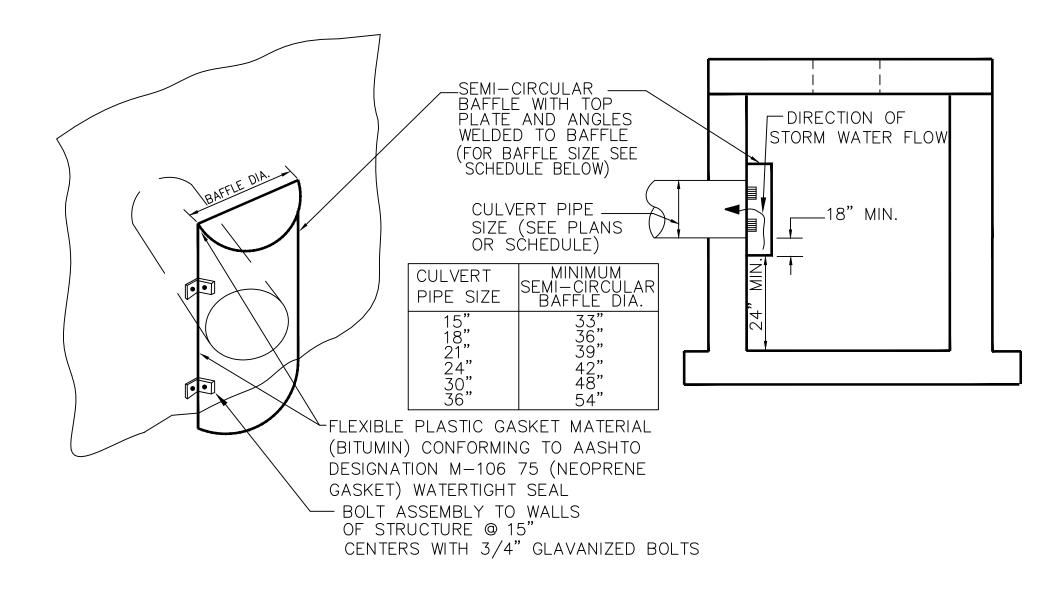

t: +1.305.631.2208| f: +1.407.660.1655 201 Alhambra Circle, Suite 800 Coral Gables, FL 33134 U.S.A. www.exp.com

**exp** U.S. Services Inc.

• BUILDINGS • EARTH & ENVIRONMENT • • ENERGY • INDUSTRIAL • INFRASTRUCTURE • SUSTAINABILITY

PROJECT:

#### **LEGACY AT DORAL**

2525 NW 82ND AVENUE, DORAL, FL. 33122

OWNER:


# TheEastonGroup

101 N.W. 19 ST. MIAMI, FL 33172 TEL - (305) 593-2222 FAX - (305) 591-3863 www.theeastongroup.com

PHASE:

### **SCHEMATIC DESIGN**

RI	EVISIONS	
Revision #	Date	

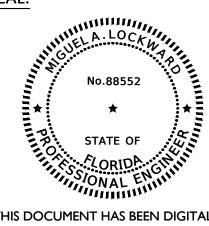

THIS DOCUMENT HAS BEEN DIGITALLY SIGNED AND SEALED BY MIGUEL A. LOCKWARD, P.E. ON THE DATE ADJACENT TO THE SEAL.

PRINTED COPIES OF THIS DOCUMENT ARE NOT CONSIDERED SIGNED AND SEALED. THE SIGNATURE MUST BE VERIFIED ON THE ELECTRONIC DOCUMENTS.

THIS DRAWINGS IS THE PROPERTY OF EXP U.S. SERVICES, INC. UNLESS OTHERWISE PROVIDED FOR BY CONTRACT, THE CONTENTS OF THIS DRAWINGS ARE CONFIDENTIAL AND SHALL NOT BE TRANSMITTED TO ANY OTHER PARTY EXCEPT AS AGREED TO BY THE ARCHITECT/ENGINEERS.


PROJ No.: DRAWN BY: APPR BY:

2/22/2023 21010276-A0

SHEET NUMBER:



THE OFFICIAL RECORD OF THIS SHEET IS THE ELECTRONIC FILE DIGITALLY SIGNED AND SEALED UNDER RULE 61G15-23.004, F.A.C.

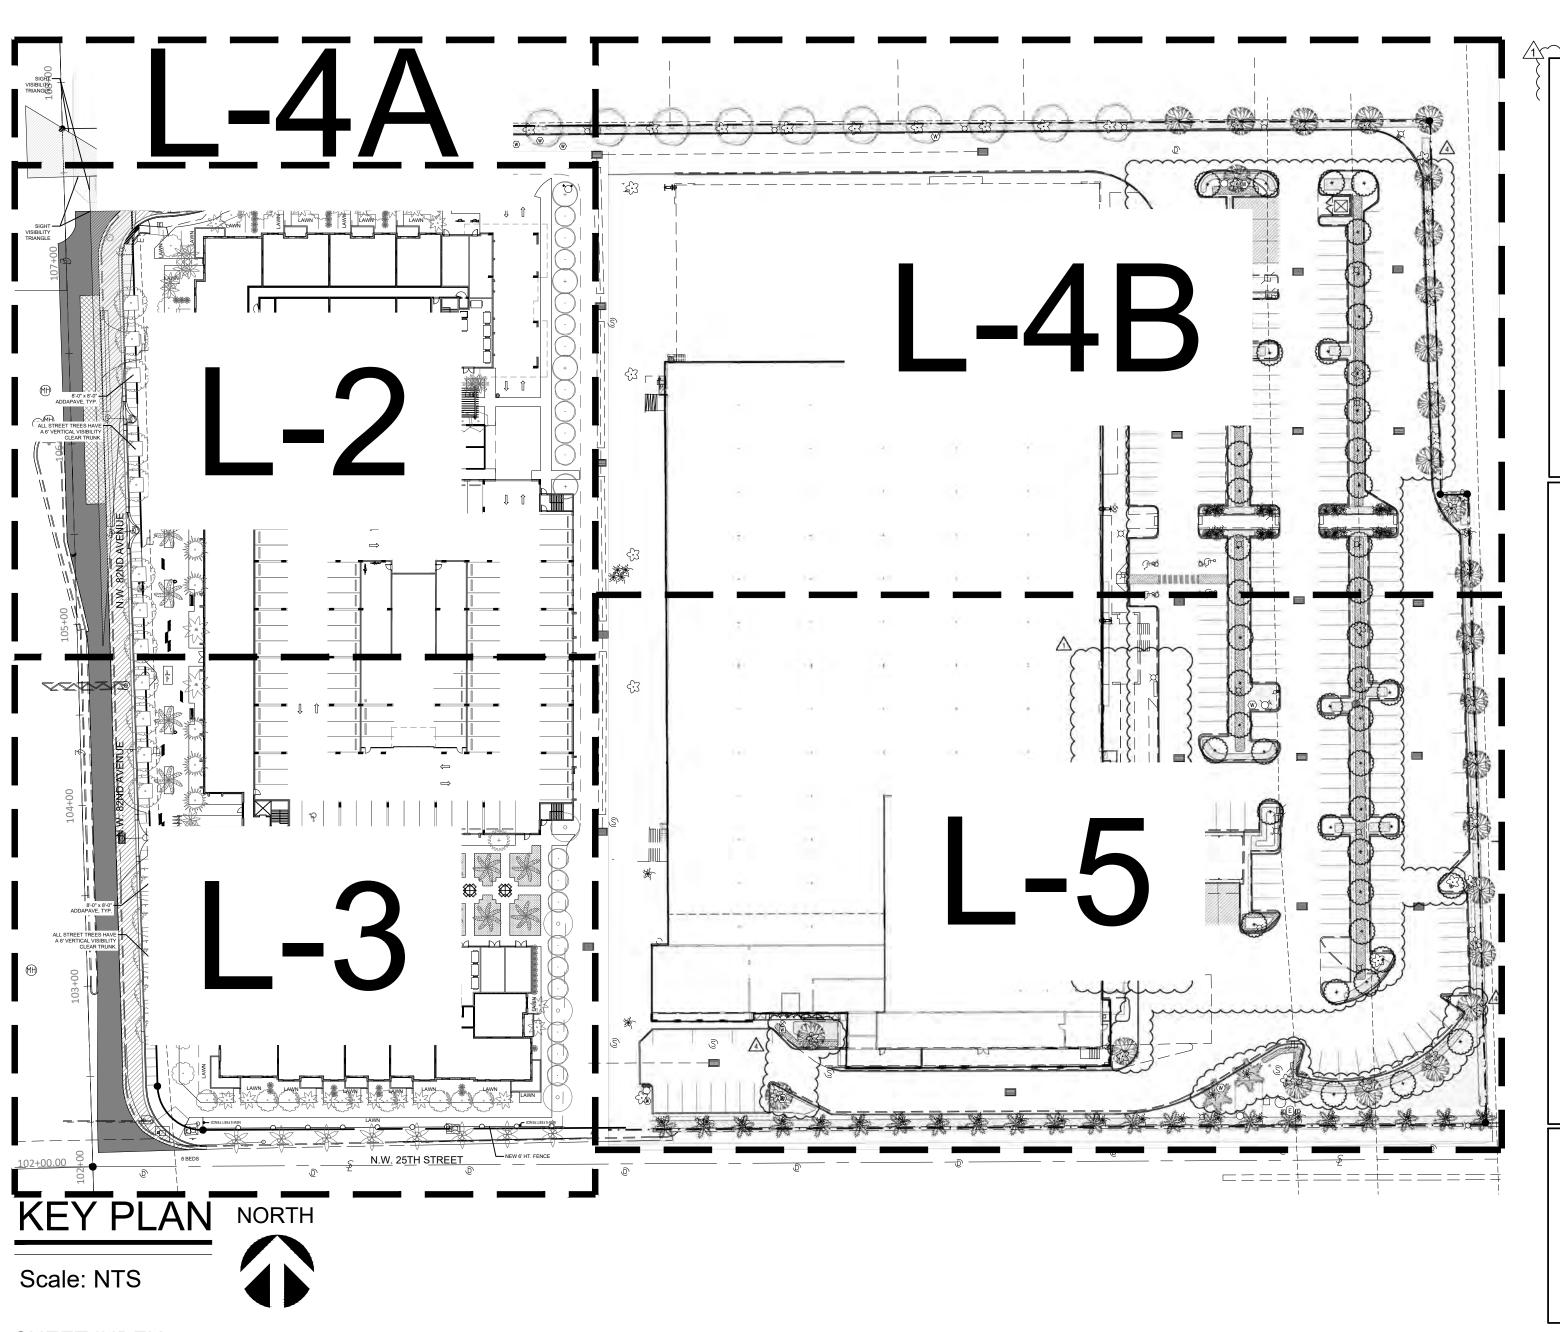

LANDSCAPE LEGEND Information Required to be Permanently Affixed to Plan

Net Lot Area 9.28 acres 404,159 s.f.

ENTIRE SITE

OPEN SPACE

REQUIRED

A. Square Feet of open space required by Chapter 71, as indicated on site plan:

Net lot area = 404,159 s.f. x 10 % = 40,416 s.f.

ENTIRE SITE

B. Square Feet of parking lot open space required by Chapter 71, as indicated on site plan:

No. outside/ground-level parking spaces N/A x 10 s.f. per parking spaces = N/A N/A

C. Total s.f. of landscaped open space required by Chapter 71: A + B = 40,416 49,740

LAWN AREA CALCULATION

A. <u>40,416</u> total s.f. of landscaped open space required by Chapter 71

B. Maximum lawn area (sod) permitted = <u>60</u> % x <u>40,416</u> s.f. =

LANDSCAPE LEGEND Information Required to be Permanently Affixed to Plan Zoning District: MULTI-FAMILY RESIDENTIAL Net Lot Area 2,88 acres 125,602 s.f. MULTI-FAMILY RESIDENCE ONLY — **TREES** A. No. trees required per net lot acre Less existing number of trees meeting minimum requirements = <u>28</u> trees x net lot acres = B. % Palms Allowed: No. trees required x 30% = C. % Natives Required: No. trees provided x 50% = D. Street trees (maximum average spacing of 35' o.c.): Palms as Street Trees (max. average spacing 25' o.c.) (Along N.W. 25TH ST.) = 195\_\_\_ linear feet along street = E. Street trees (maximum average spacing of 20' o.c.): (Along N.W. 82ND AVE) \_\_\_327\_\_ linear feet along street = F. Street trees located directly beneath power lines (maximum average spacing of 25' o.c.):\_\_\_\_\_ linear feet along street / 25 = G. Total Trees Required A + D + E + F = <u>106</u> Total Trees 1,060 A. No. trees required x 10 = No. of shrubs allowed B. No. shrubs allowed x 50% = No. of native shrubs required

LANDSCAPE LEGEND Information Required to be Permanently Affixed to Plan

Zoning District: <u>I- INDUSTRIAL</u>

Net Lot Area 6,40 acres 278,557 s.f. INDUSTRIAL SITE ONLY

SEE LANDSCAPE

\_\_24,250\_\_\_\_\_18,428\_\_\_

SEE LANDSCAPE PLAN BY CABRERA RAMOS ARCHITECTS, INC.

\*See Previously approved Landscape plan, Landscape Legend and Landscape List BY CABRERA RAMOS ARCHITECTS, INC. on Sheets <u>L-1</u>, <u>L-4</u> and

### SHEET INDEX:

TD-1 TREE DISPOSITION PLAN

L-1 INDEX

L-2 GROUND FLOOR LANDSCAPE PLAN

L-3 GROUND FLOOR LANDSCAPE PLAN

L-4 INDUSTRIAL SITE LANDSCAPE PLAN BY CABRERA

RAMOS ARCHITECTS, INC.

L-5 INDUSTRIAL SITE LANDSCAPE PLAN BY CABRERA

RAMOS ARCHITECTS, INC.

L-6 POOL DECK LANDSCAPE PLAN

L-7 LANDSCAPE DETAILS

		GROUND FLOOR NEW LANDS		51
		TREES AND PALMS	S	
SYMBOL	QUAN.	PROPOSED MATERIAL		DESCRIPTION
	17	\(^\text{Yuercus virginiana}\) *Quercus virginiana [STR]	EET TREES]	16' HT. X 6' SPR. 2.5" Cal. / 6' C.T
WVV	-			
12755544 + + 127557444	4 -	Polyalthia longifolia 'Pendula  Mast Tree		10' HT. 2.5" Cal.
- Synne				F.G.
{·}	20	Lagerstroemia indica 'Natchez'		12' HT. X 5' SPR. 2.5" Cal.
~~~		WHITE CREPE MYRTLE		F.G.
(+)	4 -	*Bursera simaruba		12' HT. X 5' SPR. 2.5" Cal.
		GUMBO LIMBO		F.G.
$\bigcirc$	23	*Coccoloba diversiflora		10' HT. 2.5" Cal.
$\bigcirc$	20	PIGEON PLUM		F.G.
$\langle \mathbb{D} \rangle$	3	*Ilex cassine		10' HT. 2.5" Cal.
6772	3	DAHOON HOLLY		F.G.
$\overline{\wedge}$		*Myrcianthis fragrans		10' HT. 2.5" Cal.
	6	SIMPSON'S STOPPER		F.G.
	4	*Conocarpus erectus		12' HT. X 5' SPR. 2.5" Cal.
$( \cdot )$	7	GREEN BUTTONWOOD		F.G.
		*Bursera simaruba 'Specimen'		20' HT. MIN. X 12' SPR.
	2	SPECIMEN GUMBO LIMBO		F.G.
promote the same of the same o	40	*Conocarpus erectus 'sericeus'		10' HT. 2.5" Cal.
المريم	13	SILVER BUTTONWOOD		F.G.
while		Elaeocarpus decipiens		12' HT. X 5' SPR. 2.5" Cal.
man man	6	JAPANESE BLUEBERRY		F.G.
A.A.		Phoenix sylvestris	[2:1]	10' C.T.
	10	SILVER DATE PALM		F.G.
		*Roystonea elata [STR	EET TREES]	10' G.W.
$\gg$	8	ROYAL PALM		F.G., MATCHED HTS.
2002		Caryota mitis		10'-12' O.A. HT.
	56	FISHTAIL PALM		25 GAL., FULL
M -		Veitchia montgomeryana 'single'	[2:1]	10' O.A. HT. MIN.
	20	SINGLE MONTGOMERY PALM		F.G.
M		Wodyetia bifurcata	[2:1]	16' O.A. HT. MIN., TRIPLE
Z*>	2	FOXTAIL PALM		F.G., STAGGERED.
NAD	10	Veitchia montgomeryana 'double'	[2:1]	
	19	DOUBLE MONTGOMERY PALM		F.G., STAGGERED.

SYMBOL	QUAN.	PROPOSED MATERIAL	DESCRIPTION
CA		Crinum augustum 'Queen Emma'	3' O.A. HT.
	8	PURPLE CRINUM LILY	7 GAL.
CFT 26	00	Cordyline fruticosa 'Tricolor'	3' O.A. HT. 3 PPP
	26	GREEN/WHITE/PINK TI PLANT	3 GAL.
CG	777	*Clusia guttifera	30" HT. X 30" SPR. / 24" O.C.
CG	///	SMALL LEAF CLUSIA	7 GAL.
CG2	40	Canna generalis	36" HT. X 18" SPR. / 18" O.C.
CGZ	18	CANNA LILY	3 GAL.
ED	4.4	Elaeocarpus decipiens	6-7' HT., STANDARD
ED	14	JAPANESE BLUEBERRY	15 GAL.
FM 1	4470	Ficus microcarpa 'Green Island'	15" HT. X 15" SPR. / 15" O.C.
	1173	GREEN ISLAND FICUS	3 GAL.
JI	4	Jatropha integerrima	6' HT. X 4' SPR.
JI	4	JATROPHA TREE	30 GAL. , FULL
PM	101	Podocarpus macrophyllus	5' HT. X 24" SPR. / 24" O.C.
FIVI		PODOCARPUS	7 GAL.
PR	80	Philodendron 'Rojo Congo'	24" HT. X 24" SPR. / 24" O.C.
PK		CONGO RED PHILODENDRON	3 GAL.
PS	577	*Pennisetum setaceum 'Alba'	18" HT. X 18" SPR. / 18" O.C.
г 3	5//	WHITE FOUNTAIN GRASS	3 GAL.
PX	457	Philodendron xanadu	18" HT. X 15" SPR. / 18" O.C.
	157	DWARF PHILODENDRON	3 GAL.
SA	500	Schefflera arboricola	24" HT. X 24" SPR. / 24" O.C.
SA	520	GREEN SCHEFFLERA	3 GAL.
SV	160	Schefflera arboricola 'Trinette'	18" HT. X 18" SPR. / 18" O.C.
SV	160	VARIEGATED SCHEFFLERA	3 GAL.
TD	64	*Tripsacum dactyloides	36" HT. X 36" SPR. / 36" O.C.
טו	61	FAKAHATCHEE GRASS	3 GAL.
TF	60	*Tripsacum floridana	24" HT. X 24" SPR. / 24" O.C.
IF	60	DWARF FAKAHATCHEE GRASS	3 GAL.
LAWN	As	Stenotaphrum secundatum 'Floratam'	SOLID EVEN SOD
∟/\VVIN	Required	ST. AUGUSTINE GRASS	SOLID EVEN SOD

		TREES	
SYMBOL	QUAN.	PROPOSED MATERIAL	DESCRIPTION
$\overline{}$	10	*Coccoloba diversiflora	10' HT. 2.5" Cal.
$\bigcirc$	10	PIGEON PLUM	F.G.
€ G	4	Ligustrum japonicum	10' HT. X 8' SPR., MULTI TRUN
C. B.	4	JAPANESE PRIVET	F.G.
Zuluz	8	Elaeocarpus decipiens	10' HT. 2.5" Cal.
Francis	l ° [	JAPANESE BLUEBERRY	F.G.
1	6	Bulnesia arborea	10' HT. 2.5" Cal.
		VERAWOOD	F.G.
W.	12	Phoenix sylvestris	10' C.T.
Me	12	SILVER DATE PALM	F.G.
	10	Veitchia montgomeryana 'double'	16' O.A. HT. MIN., DOUBLE
TOP	10	DOUBLE MONTGOMERY PALM	F.G., STAGGERED.
		SHRUBS AND GROUNDCOV	'ERS
SYMBOL	QUAN.	PROPOSED MATERIAL	DESCRIPTION
CG	102	*Clusia guttifera	24" HT. X 24" SPR. / 24" O.C.
CG		SMALL LEAF CLUSIA	3 GAL.
ED	2	Elaeocarpus decipiens	6-7' HT., STANDARD
ED		JAPANESE BLUEBERRY	15 GAL.
FM	366	Ficus microcarpa 'Green Island'	15" HT. X 15" SPR. / 15" O.C.
I IVI	300	GREEN ISLAND FICUS	3 GAL.
IC	36	Ipomoea 'Margarite'	15" O.C.
10	30	CHARTREUSE SWEET POTATO	1 GAL. FULL
JI	6	Jatropha integerrima	6' HT. X 4' SPR.
JI	0 [	JATROPHA TREE	30 GAL. , FULL
DV	434	Philodendron xanadu	18" HT. X 15" SPR. / 18" O.C.
DΥ	434	DWARF PHILODENDRON	3 GAL.
PX	450	Schefflera arboricola 'Trinette'	18" HT. X 18" SPR. / 18" O.C.
	150	Contoniona andoniona minoto	
PX SV	158	VARIEGATED SCHEFFLERA	3 GAL.
	158		3 GAL.  SOLID EVEN SOD

	NDSCAPE LEGEND (This information is required to be permanently affixed to the planing District: I-INDUSTRIAL Net Lot Area: 9.3 acres 404.915 square			$\perp \Delta$
OP	EN SPACE	EQUIRED	PROVIDED	D
A.	Square feet of open space required by Chapter 33, as indicated on site plan: Net lot area = $404.915$ square feet x 10 % = $40.491$ square feet	40,491	79,104	\
В.	Square feet of parking lot open space required by Chapter 18A, as indicated on site plan:	>	A	12
	The number of parking spaces 437 x 10 square feet per parking space =	4,370	4,370	1)
C.	Total square feet of landscaped open space required by Chapter 33 = A + B =	44,861	83,474	13
LA	WN AREA CALCULATION	(	~~	13
A.	Total square feet of landscaped open space required by Chapter 33 =	44,861 ( (		1
B.	Maximum lawn area (St. Augustine sod) permitted = 20 % x 44.861 square feet =	8,972 (Max.)	8,964	<b>!</b> ?
TR	EES	>>		22 6
77.77	The number of trees required per net lot acre	15		)~~~
	less the existing number of trees that meet minimum requirements = 15 trees x net lot acreage = 139.5  (minus)	140		(9 as part of
B.	30% palm trees allowed (two palms = one tree) Palms provided =	42 (Max)	27.5	phase 1)
C.	하고 사용하는 경기를 가게 되었다고 있다면 하는 사람들이 되었다면 그렇게 되었다면 살아왔다면 하는 사용이 하는 사용하는 사람들이 모르는데 그 모든데 그	42 (Min.)	152	(102 as part of
D.		N/A /	N/A	phase 1)
	Palms as street trees (max. average spacing 25' o.c.): 1,290' linear feet along street + 25 =	52	53	(23 as part of
E.	Street trees located directly beneath power lines (maximum average spacing of 25' o.c.):  N/A linear feet along street ÷ 25 =	}	N/A	phase 1)
F.	Total number of trees provided =	192 (Req)	207.5	(126 as part of
		(		phase 1)
	RUBS	( (		(000
	The total number of trees required $x = 10$ = the number of shrubs required	1920	2,666	(923 as part of
B.	The number of shrubs required x 30% = the number of native shrubs required	576	1,150	phase 1)
mi	RIGATION PLAN: Required by Chapter 33. Auto irrigation X or hose bib	provided. (		(266 as part of phase 1)

~~~~\\<u>\</u>

|             | D ON PLAN | PLANT                               | NAME                                      | NATIVE S | SPECIES | SIZE  | QUANTITY   | FUTURE    |
|-------------|-----------|-------------------------------------|---|----------|---------|---|--|-----------|
| SYM         | 30L       | SCIENTIFIC                          | COMMON                                    | YES      | NO      |   | > PHASE 1  | PENDING   |
|             |           |                                     | TRE                                       | ES       |         |   | <b>\</b>   |           |
| OTY VM      |           | Verteho<br>montgomeryana            | MONTGOMERY<br>PALM STREET<br>PALM         |          | ×       | AVERAGE SPACING OF 25' O.C.<br>OR LESS<br>14'-O' OR 4' CALIPER * TIME OF<br>PLANTING<br>15' MIN.CANOPY * MATURITY | 22   | 27        |
| OTY.        |           | Phoenix cananensis                  | CANARY ISLAND<br>DATE PALM<br>STREET FALM |          | ×       | AVERAGE SPACING OF 25' O.C.<br>OR LESS<br>14'-O' OR 4' CALIPER * TIME OF<br>PLANTING<br>15' MINICANOPY * MATURITY | j  | 3         |
| PC PC       |           | Phoenix cananensis                  | CANARY ISLAND<br>DATE PALM                |          | ×       | AVERAGE SPACING OF 25' O.C.<br>OR LESS<br>IA'-O' OR A' CALIPER * TIME OF<br>PLANTING<br>IS' MIN.CANOPY * MATURITY | 2 /2 =1  | 3 /2 =1.5 |
| (OTY)       |           | Themax radiata                      | FLORIDA THATCH<br>PALM                    | ×        |         | 15'-0' TO 20'-0'  | 16 /2- 8   | 34 /2- 17 |
| (CTY)<br>BS |           | Birsera simaruba                    | GUMBO LIMBO                               | ×        |         | 25'-0' TO 50'-0'<br>MATURE  | \{\begin{align*} \begin{align*} \beg | 15        |
| (CV)        |           | Querous virginiana                  | LIVE OAK                                  | ×        |         | 40'-0' TO 50'-0"<br>MATURE  | 8 3  | 18        |
| (CITY.)     |           | Conocurpus Erectus                  | GREEN<br>BUTTONWOOD                       | ×        | ~~      | 15'-0' TO 20'-0'<br>MATLIRE   | 28   | O.        |
|             | 0         | Cordia Sebestena                    | ORANGE GEIGER                             | ×        |         | 15'-0' TO 20'-0'<br>MATLRE  | 50   | °         |
|             |           | s                                   | SHRUBS AND G                              | ROUND (  | COVER   |   |  |           |
| (CI)        |           | Chrysobalanus icaco                 | COCOPLLM                                  | ×        |         | 24° H. 2' O.C.  | 266  | 884       |
| QTY:        |           | Codiaesim vanegatum                 | CROTON                                    |          | ×       | 18° H. 2° O.C.  | 412  | 465       |
| GTY.        |           | Shefflera arboricola<br>"Tonese"    | VARIEGATED<br>ARBORICOLA                  |          | ×       | 18° H. 2° O.C.  | 245  | 146       |
| CS)         | *         | Спишт эрр.                          | CRINUM LILY                               |          | x       | 5' H. 3' O.C.   | 0  | 108       |
| UM)         |           | Linope muasari<br>'EVERGREEN GIANT' | EVERGREEN<br>GIANT LIRIOPE                |          | ×       | 18° H, 12° O.C.   | 0  | 140       |
|             |           | Et Augustine floratain              | INDICATIVE<br>NATIVE SPECIES              | ×        | 12.1    | -   | 1,760 S.F.   | 7,162 S.F |


# LANDSCAPE LEGEND AND LANDSCAPE LIST BY CABRERA RAMOS ARCHITECTS, INC.

CATYODODORAN ZOUNUS ADMINISTRATINE SITE PLANARENIEW FILENDS. 2018-08-

NOTES:

ALL TREES ON INDUSTRIAL SITE ARE EXISTING.


EXISTING BUILDING IS A VACANT WAREHOUSE.
FUTURE USE OF BUILDING AND SITE DEVELOPMENT WILL BE RETAIL AS PER

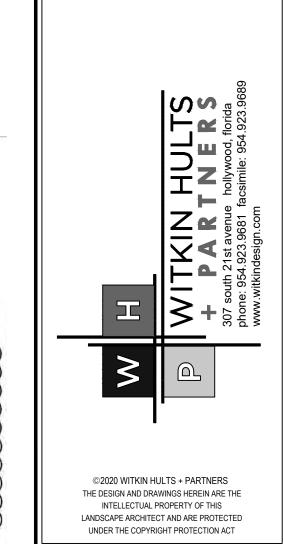


| Seal:                                |
|--------------------------------------|
|                                      |
|                                      |
|                                      |
| Lic. # LA0000889<br>Member: A.S.L.A. |

Drawing: Index
Date: 05/11/2021
Scale: See Left
Drawn by: MAV
Sheet No.:

Cad Id.: 2021-037

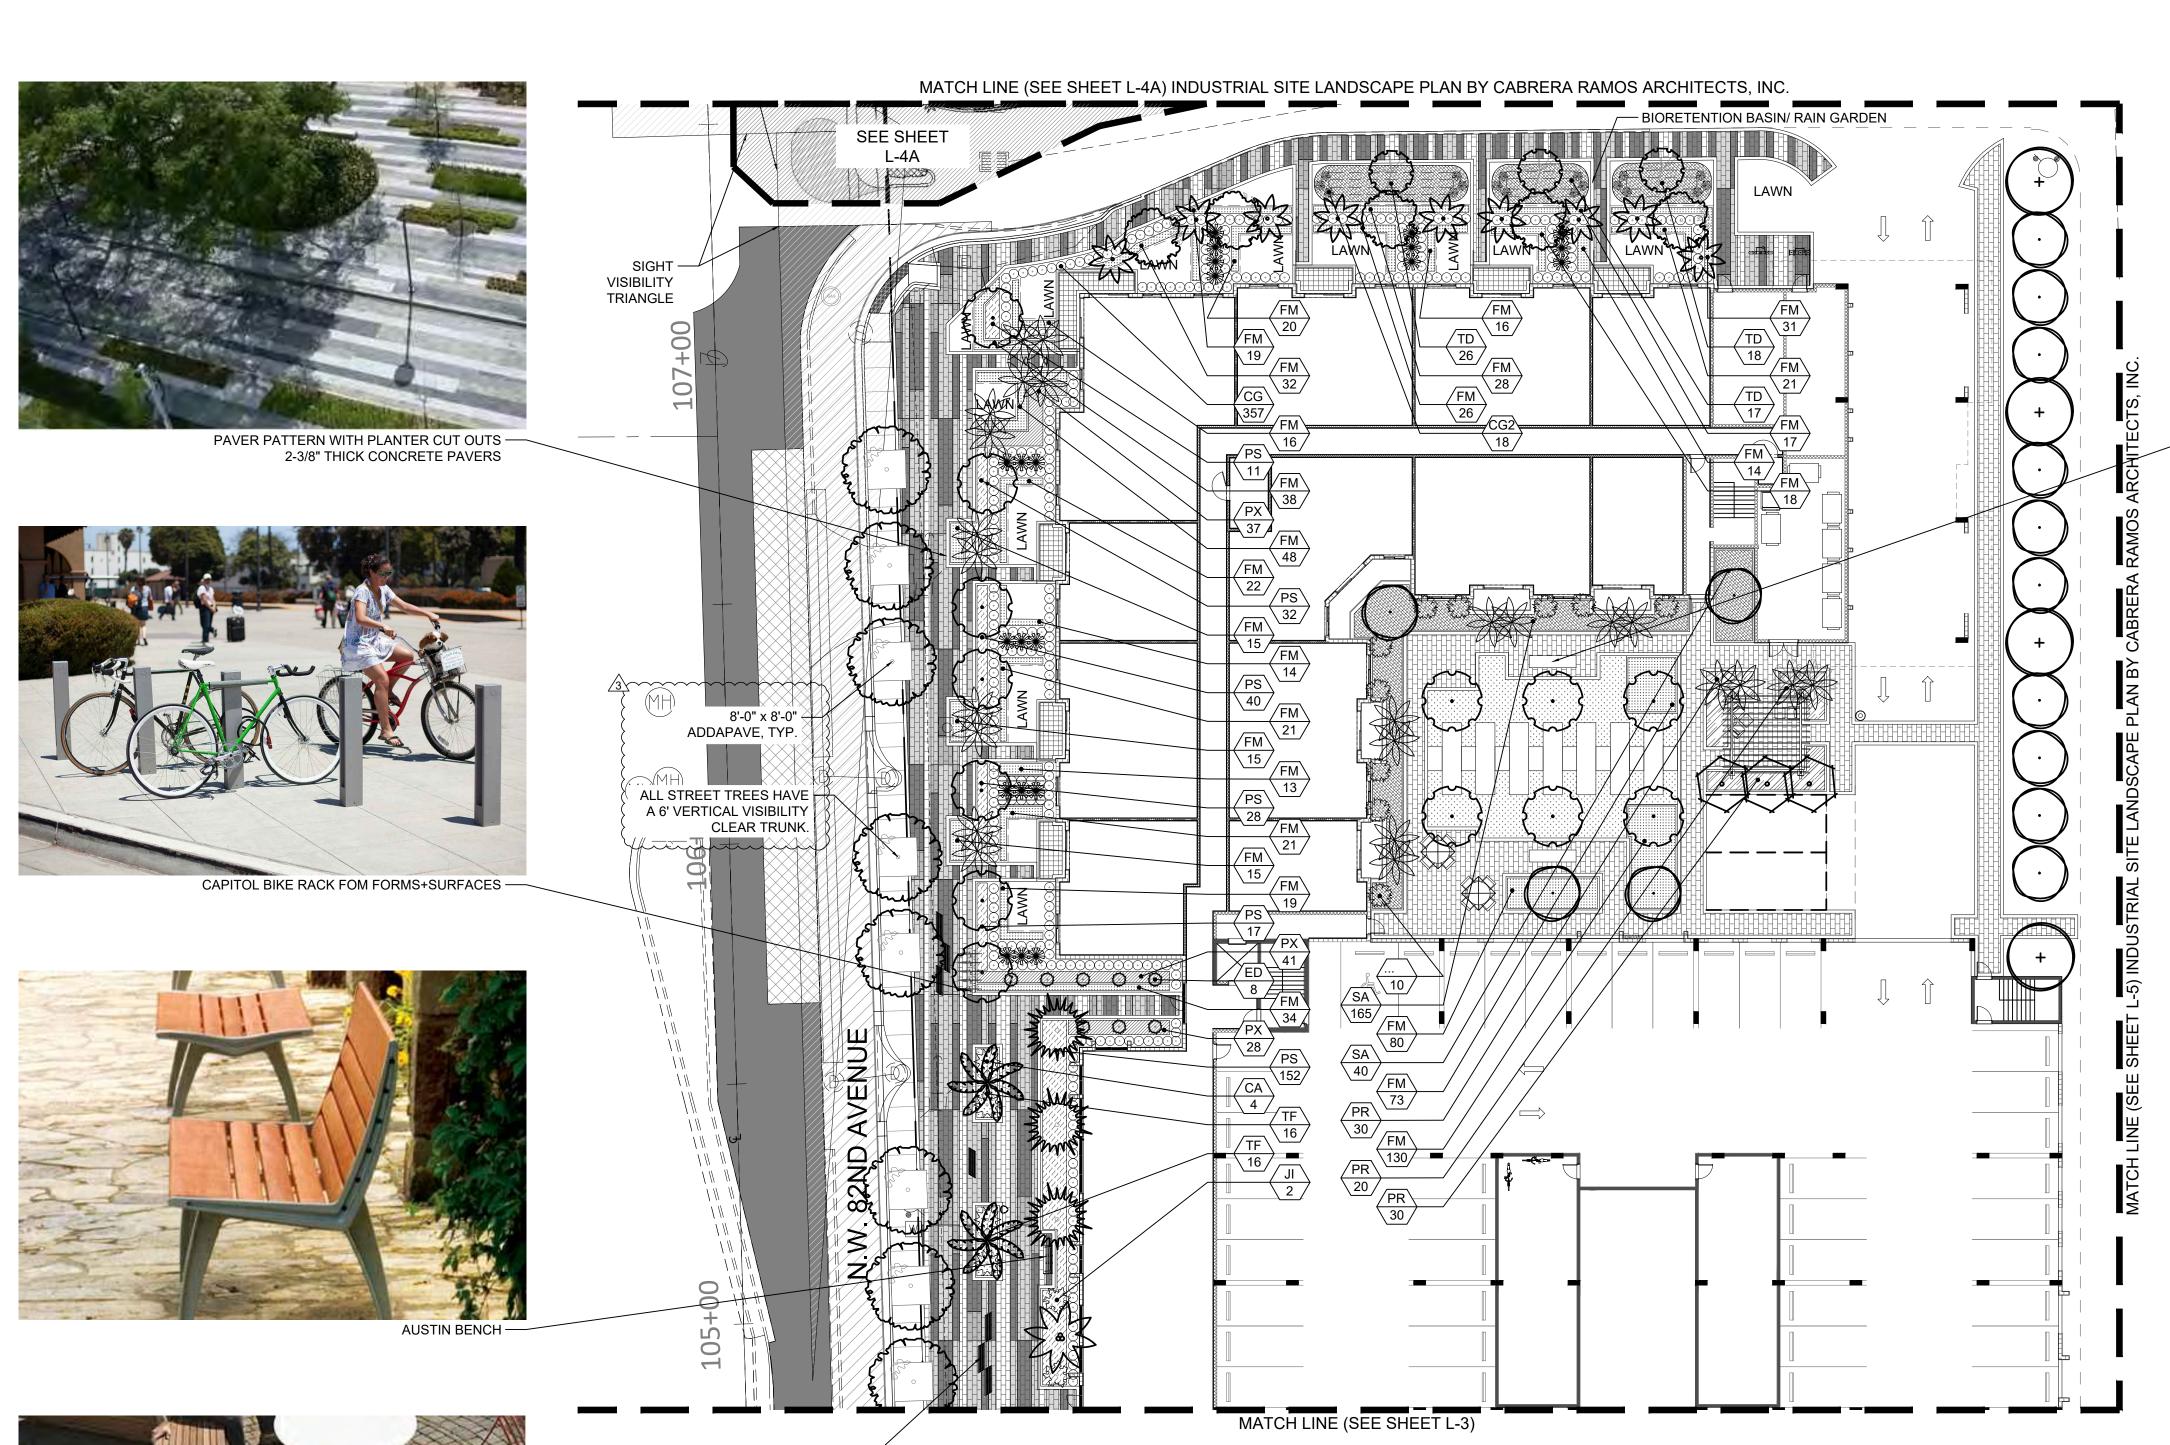

GROUND FLOOR LANDSCAPE PLAN NORTH

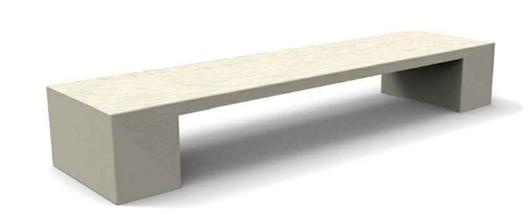

- ABRIL BENCH FROM LANDSCAPE FORMS



TRASH RECEPTICLE - FGP LITTER FROM LANDSCAPE FORMS

1) City Comments
2) Site Plan Coordination
3) Site Plan Coordination

Lic. # LA0000889 Member: A.S.L.A.

Drawing: Landscape Plan Scale: See Left Drawn by: MAV Sheet No.:

Cad Id.: 2021-037

ALL TREES ON INDUSTRIAL SITE ARE EXISTING.

Scale: 1"=20'-0"


NOTES:

82ND

DORAL

DORAL

©2020 WITKIN HULTS + PARTNERS THE DESIGN AND DRAWINGS HEREIN ARE THE INELLECTUAL PROPERTY OF THIS
LANDSCAPE ARCHITECT AND ARE PROTECTED
UNDER THE COPYRIGHT PROTECTION ACT

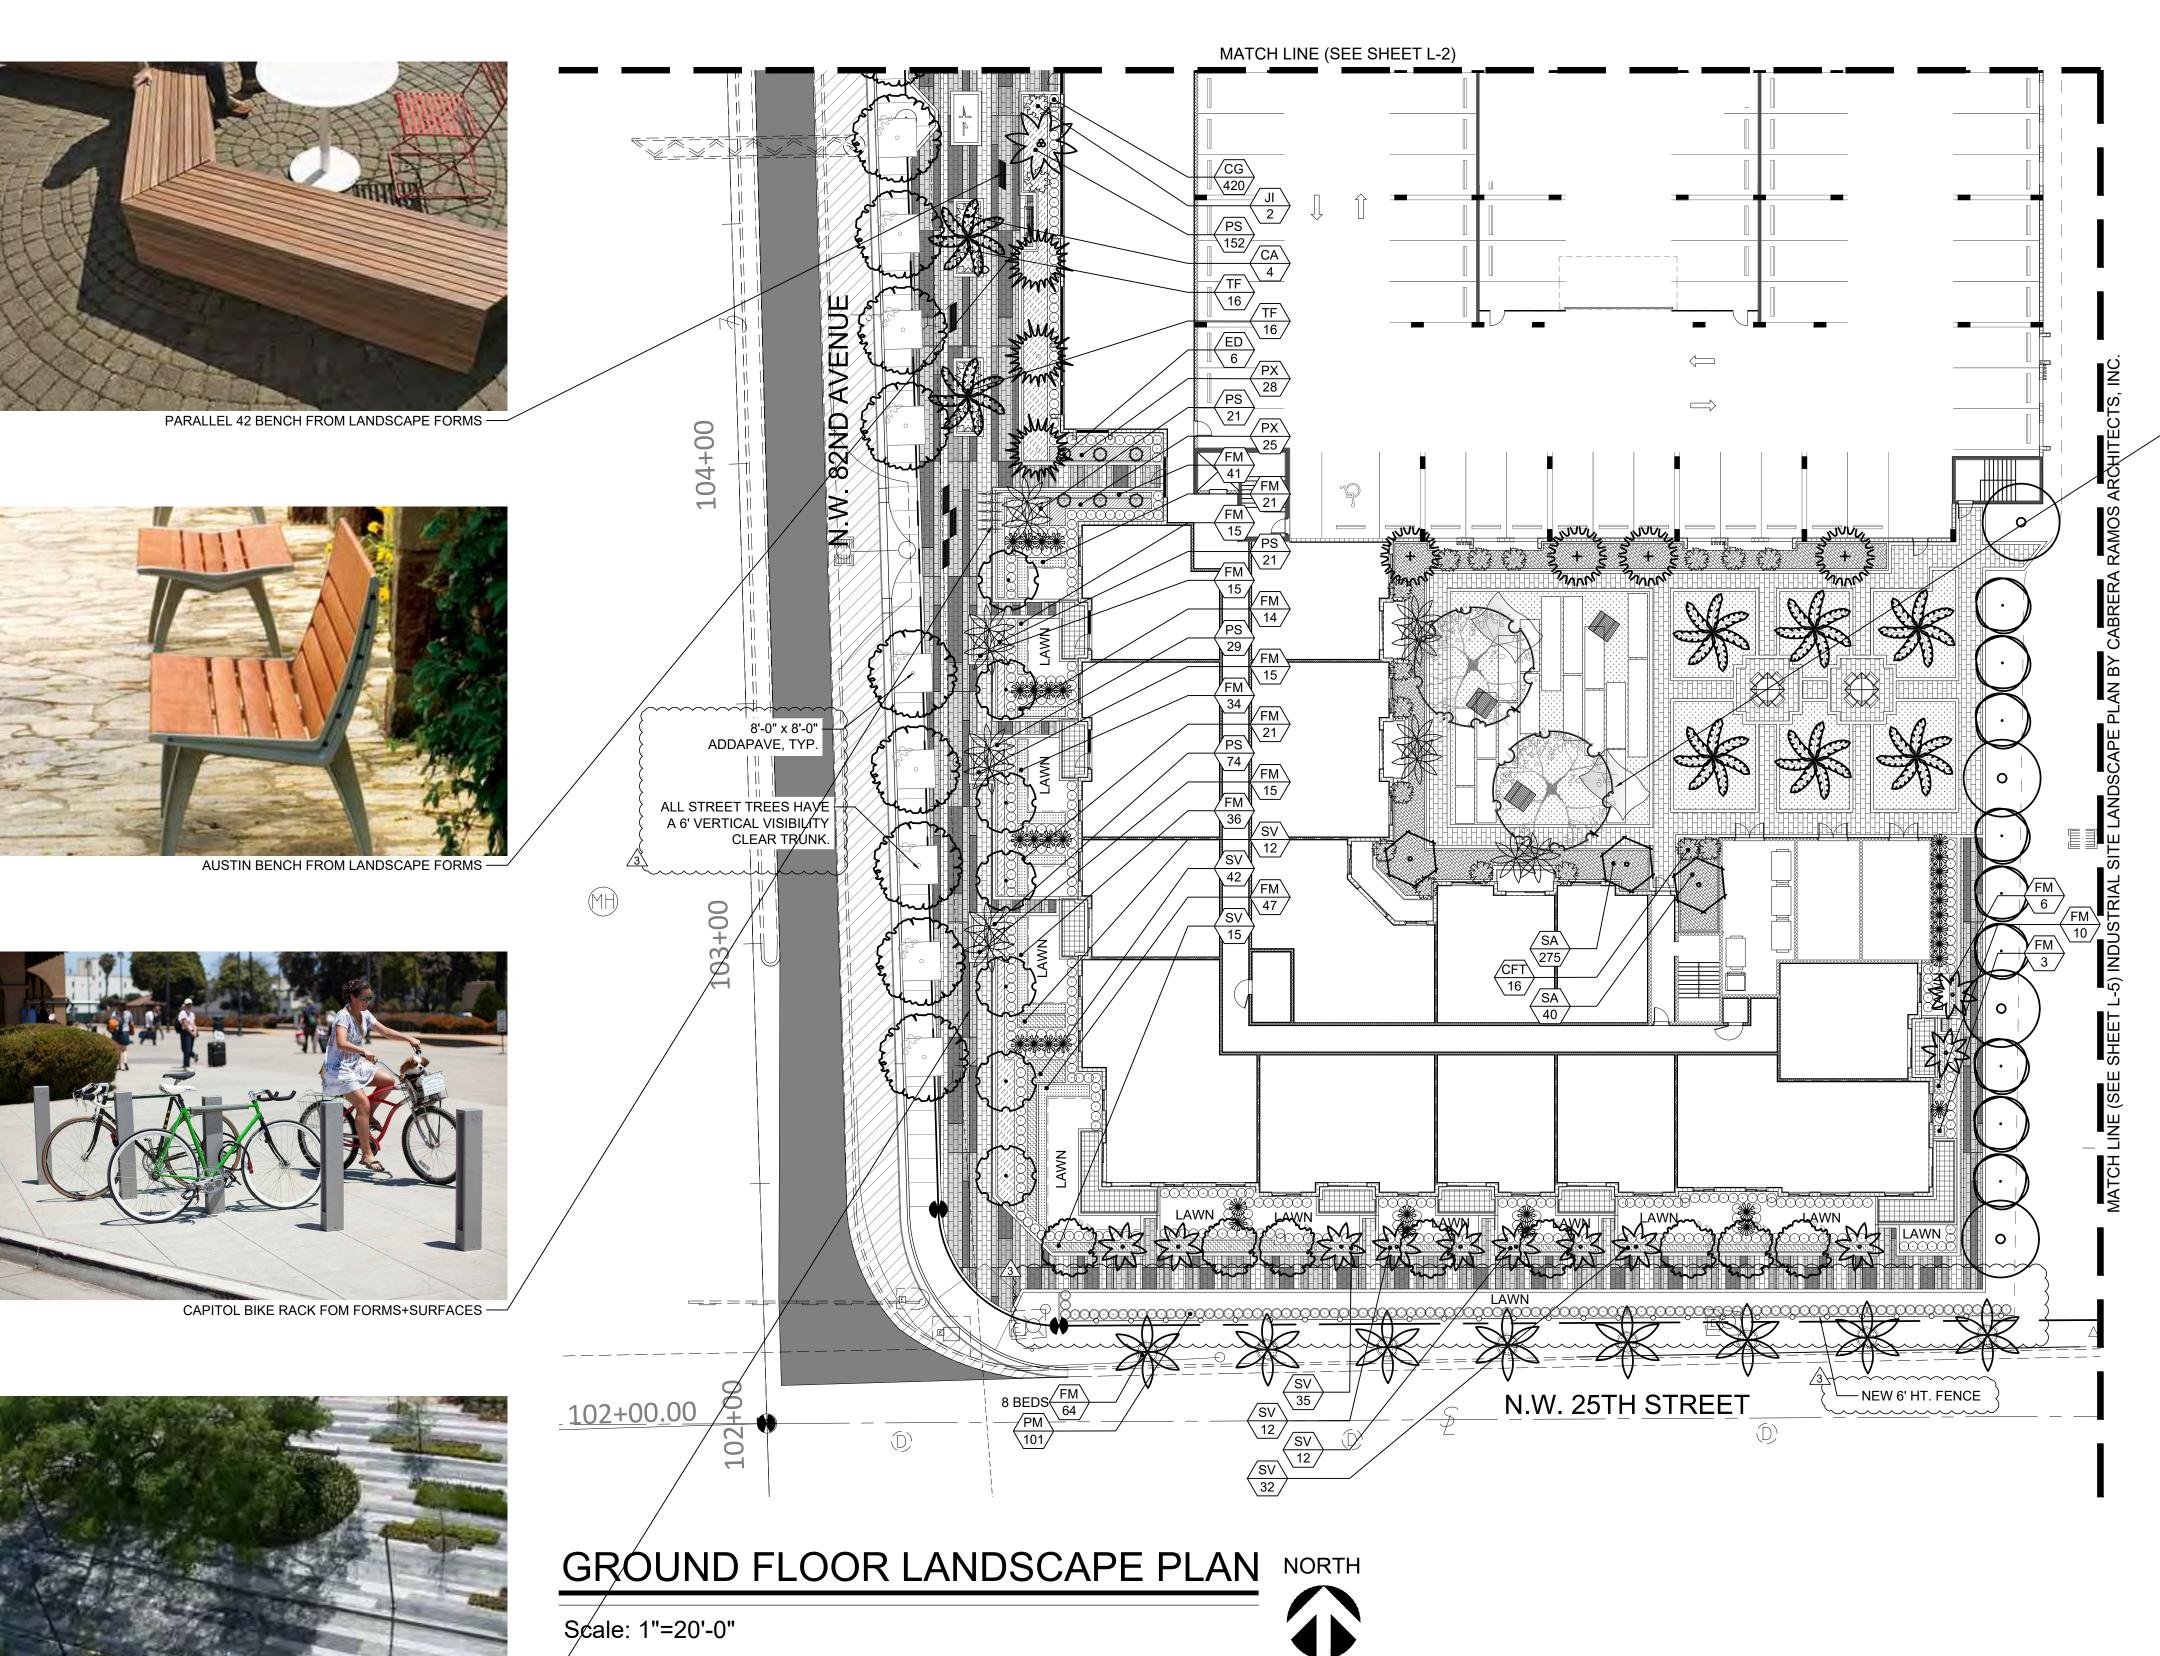

PAVER PATTERN WITH PLANTER CUT OUTS – 2-3/8" THICK CONCRETE PAVERS




— LUNGO MARE BENCH FROM LANDSCAPE FORMS



TRASH RECEPTICLE - FGP LITTER FROM LANDSCAPE FORMS



PICNIC TABLE - GRETCHEN PICNIC TABLE FROM LANDSCAPE FORMS

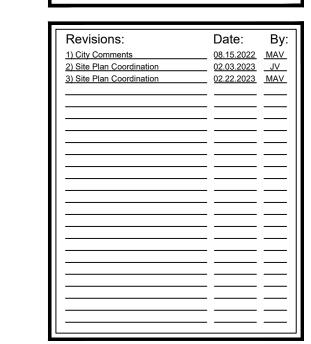


©2020 WITKIN HULTS + PARTNERS
THE DESIGN AND DRAWINGS HEREIN ARE THE
INTELLECTUAL PROPERTY OF THIS
LANDSCAPE ARCHITECT AND ARE PROTECTED
UNDER THE COPYRIGHT PROTECTION ACT

DORAL

82ND

| _ |                  |
|---|------------------|
|   | Seal:            |
|   |                  |
|   |                  |
|   |                  |
|   |                  |
|   |                  |
|   |                  |
|   |                  |
|   | Lic. # LA0000889 |
|   | Member: A S I A  |

| 23   |                         |
|--|-------------------------|
| Mixed UseIEWE Warehouse Investment XXXII LTD 2021-037 Landscapel 2023 02 201L-1 dvg Mar 02, 2023 | Drawing: Landscape Plan |
| 02.20\L-1.d  | Date: 05/11/2021        |
| scape\2023.  | Scale: See Left         |
| 21-037\Land  | Drawn by: MAV           |
| XII LTD 202  | Sheet No.:              |
| vestment XX  |                         |
| arehouse In  | 1 2                     |
| Jse\EWE W  | L-3                     |
| /Mixed (   | Cad Id.: 2021-037       |

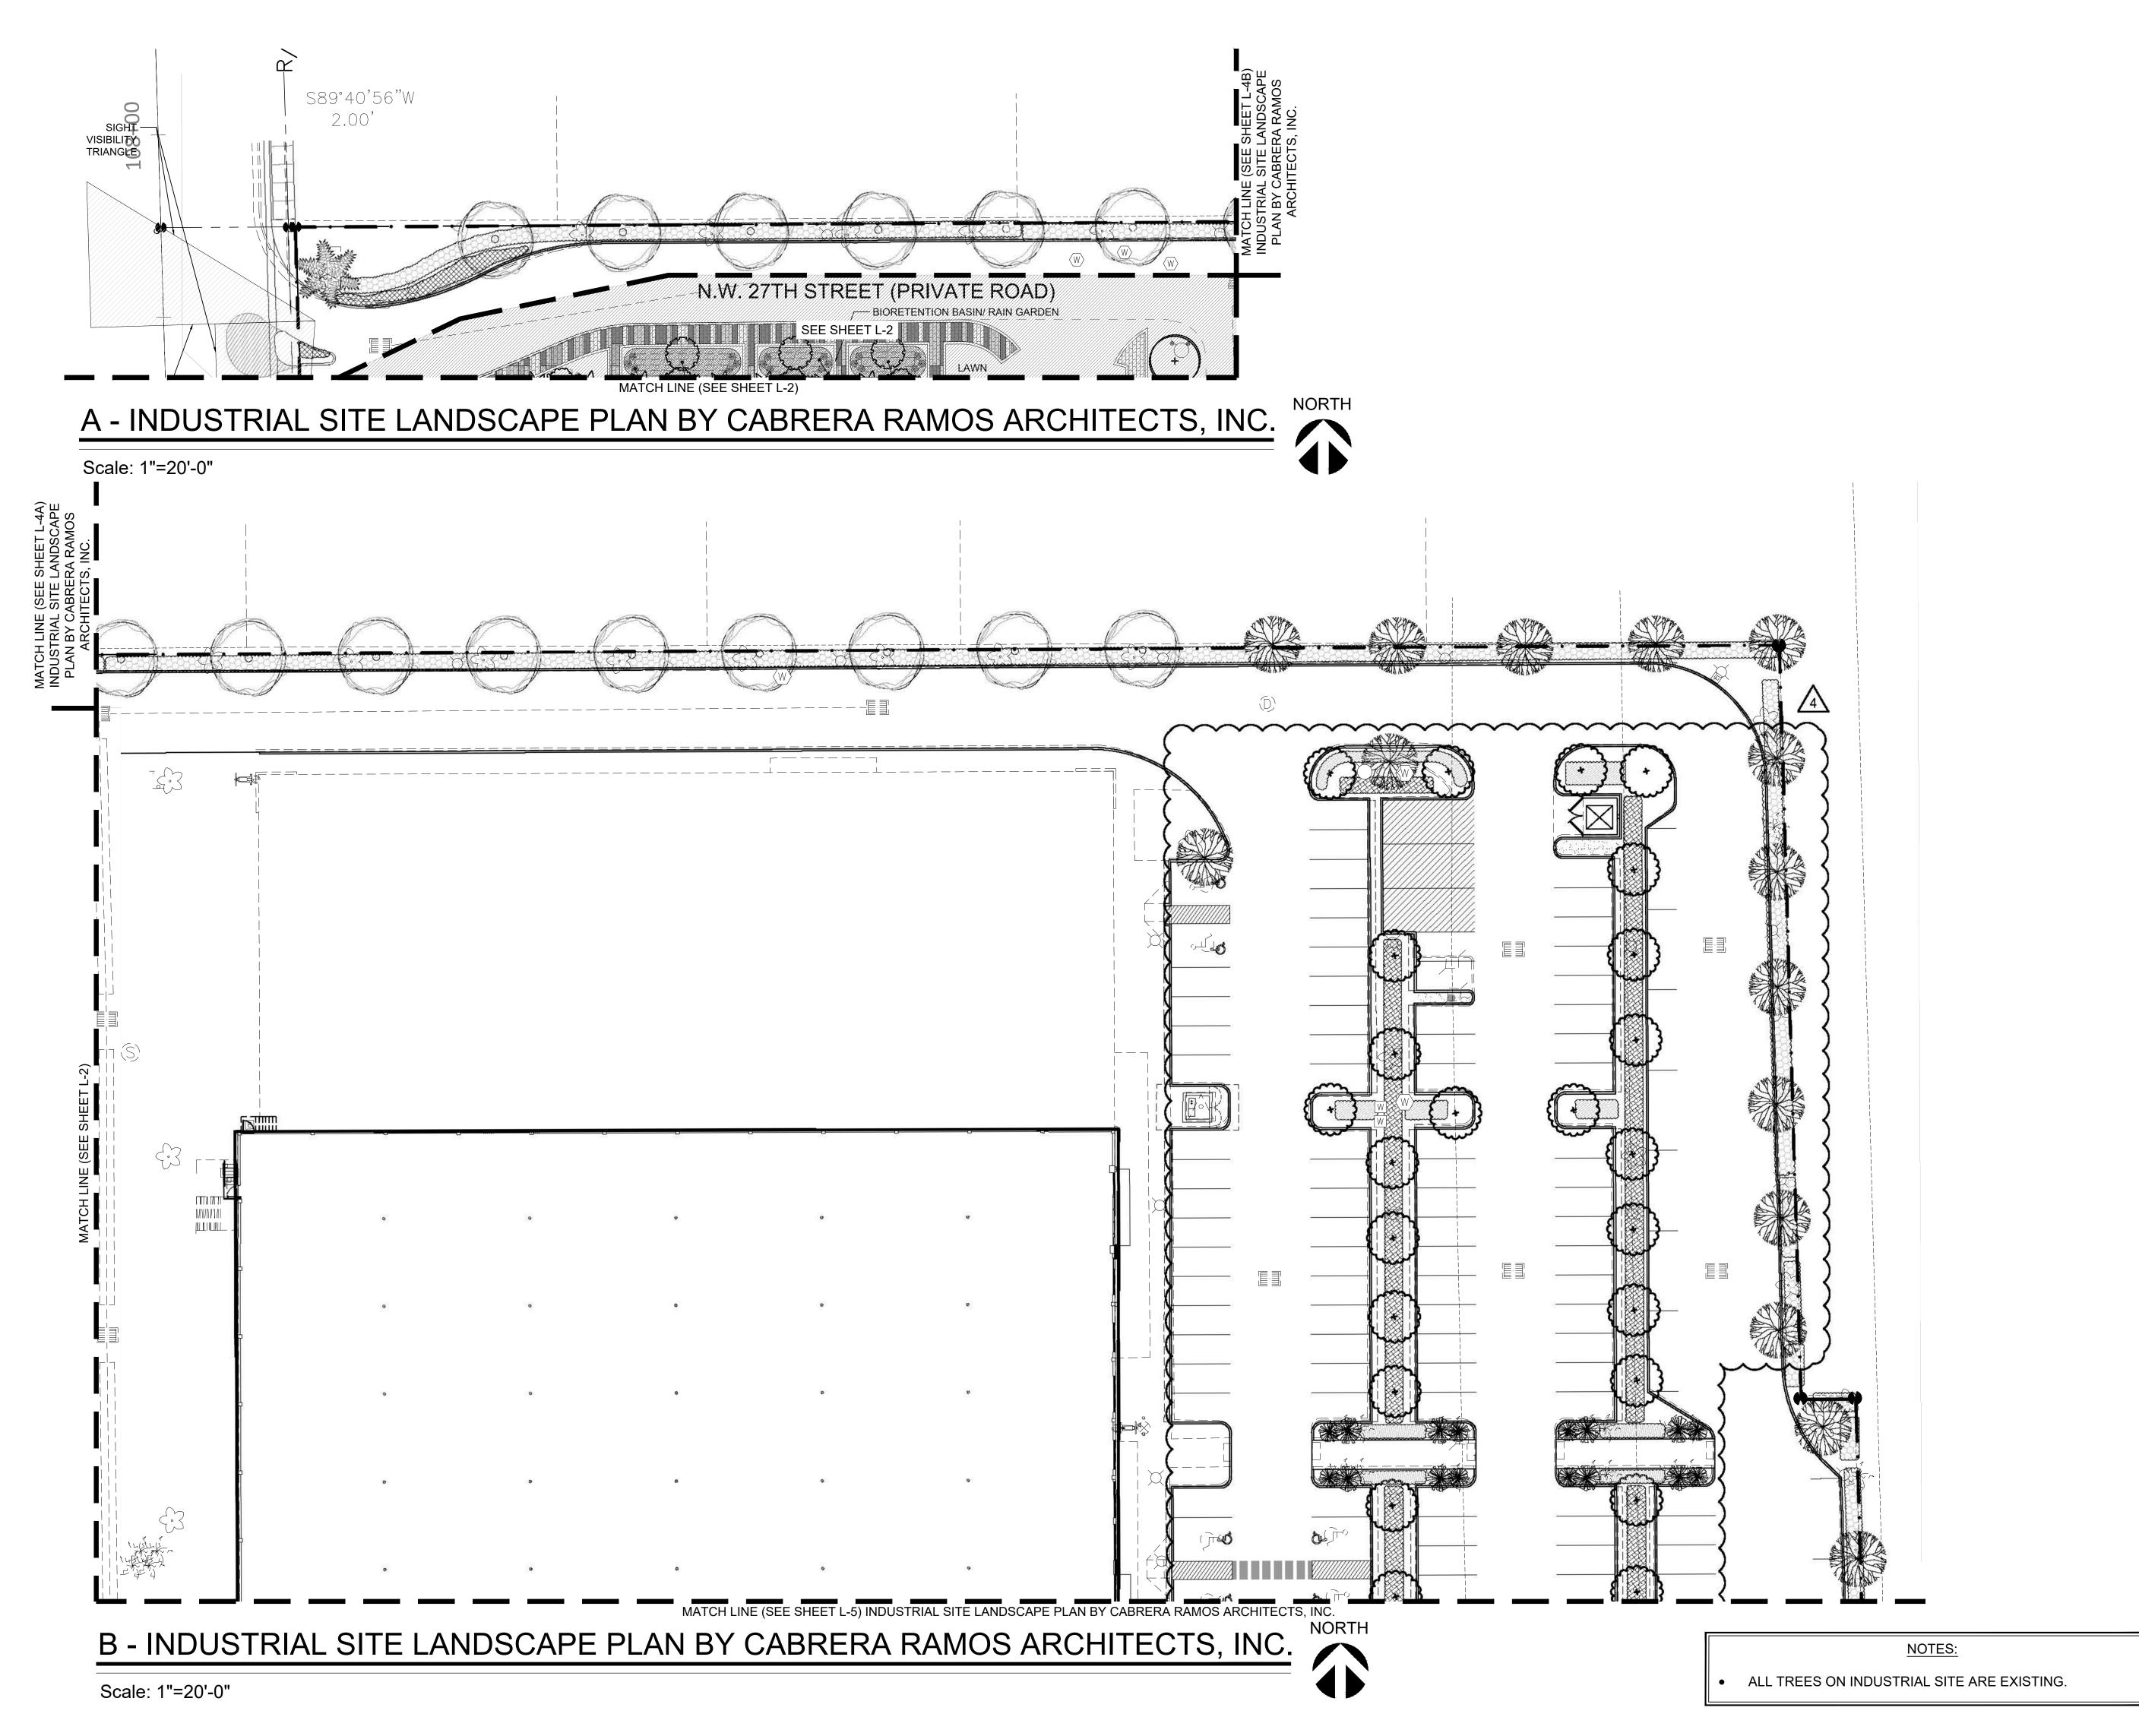

WITKIN HULTS

\*\* PART NERS

THE DESIGN AND DAY SHOULD SHOULD A STANDARD SHOULD SHOULD

LEGACY AT DORAL

2525 NW 82ND AVENUE DORAL FLORIDA 33122
INDUSTRIAL SITE LANDSCAPE PLAN BY CABRERA

PAMOS APCHITECTS INC

Seal:
Lic. # LA0000889
Member: A.S.L.A.


Drawing: Landscape Plan

Date: 05/11/2021

Scale: See Left

Drawn by: MAV

Sheet No.:

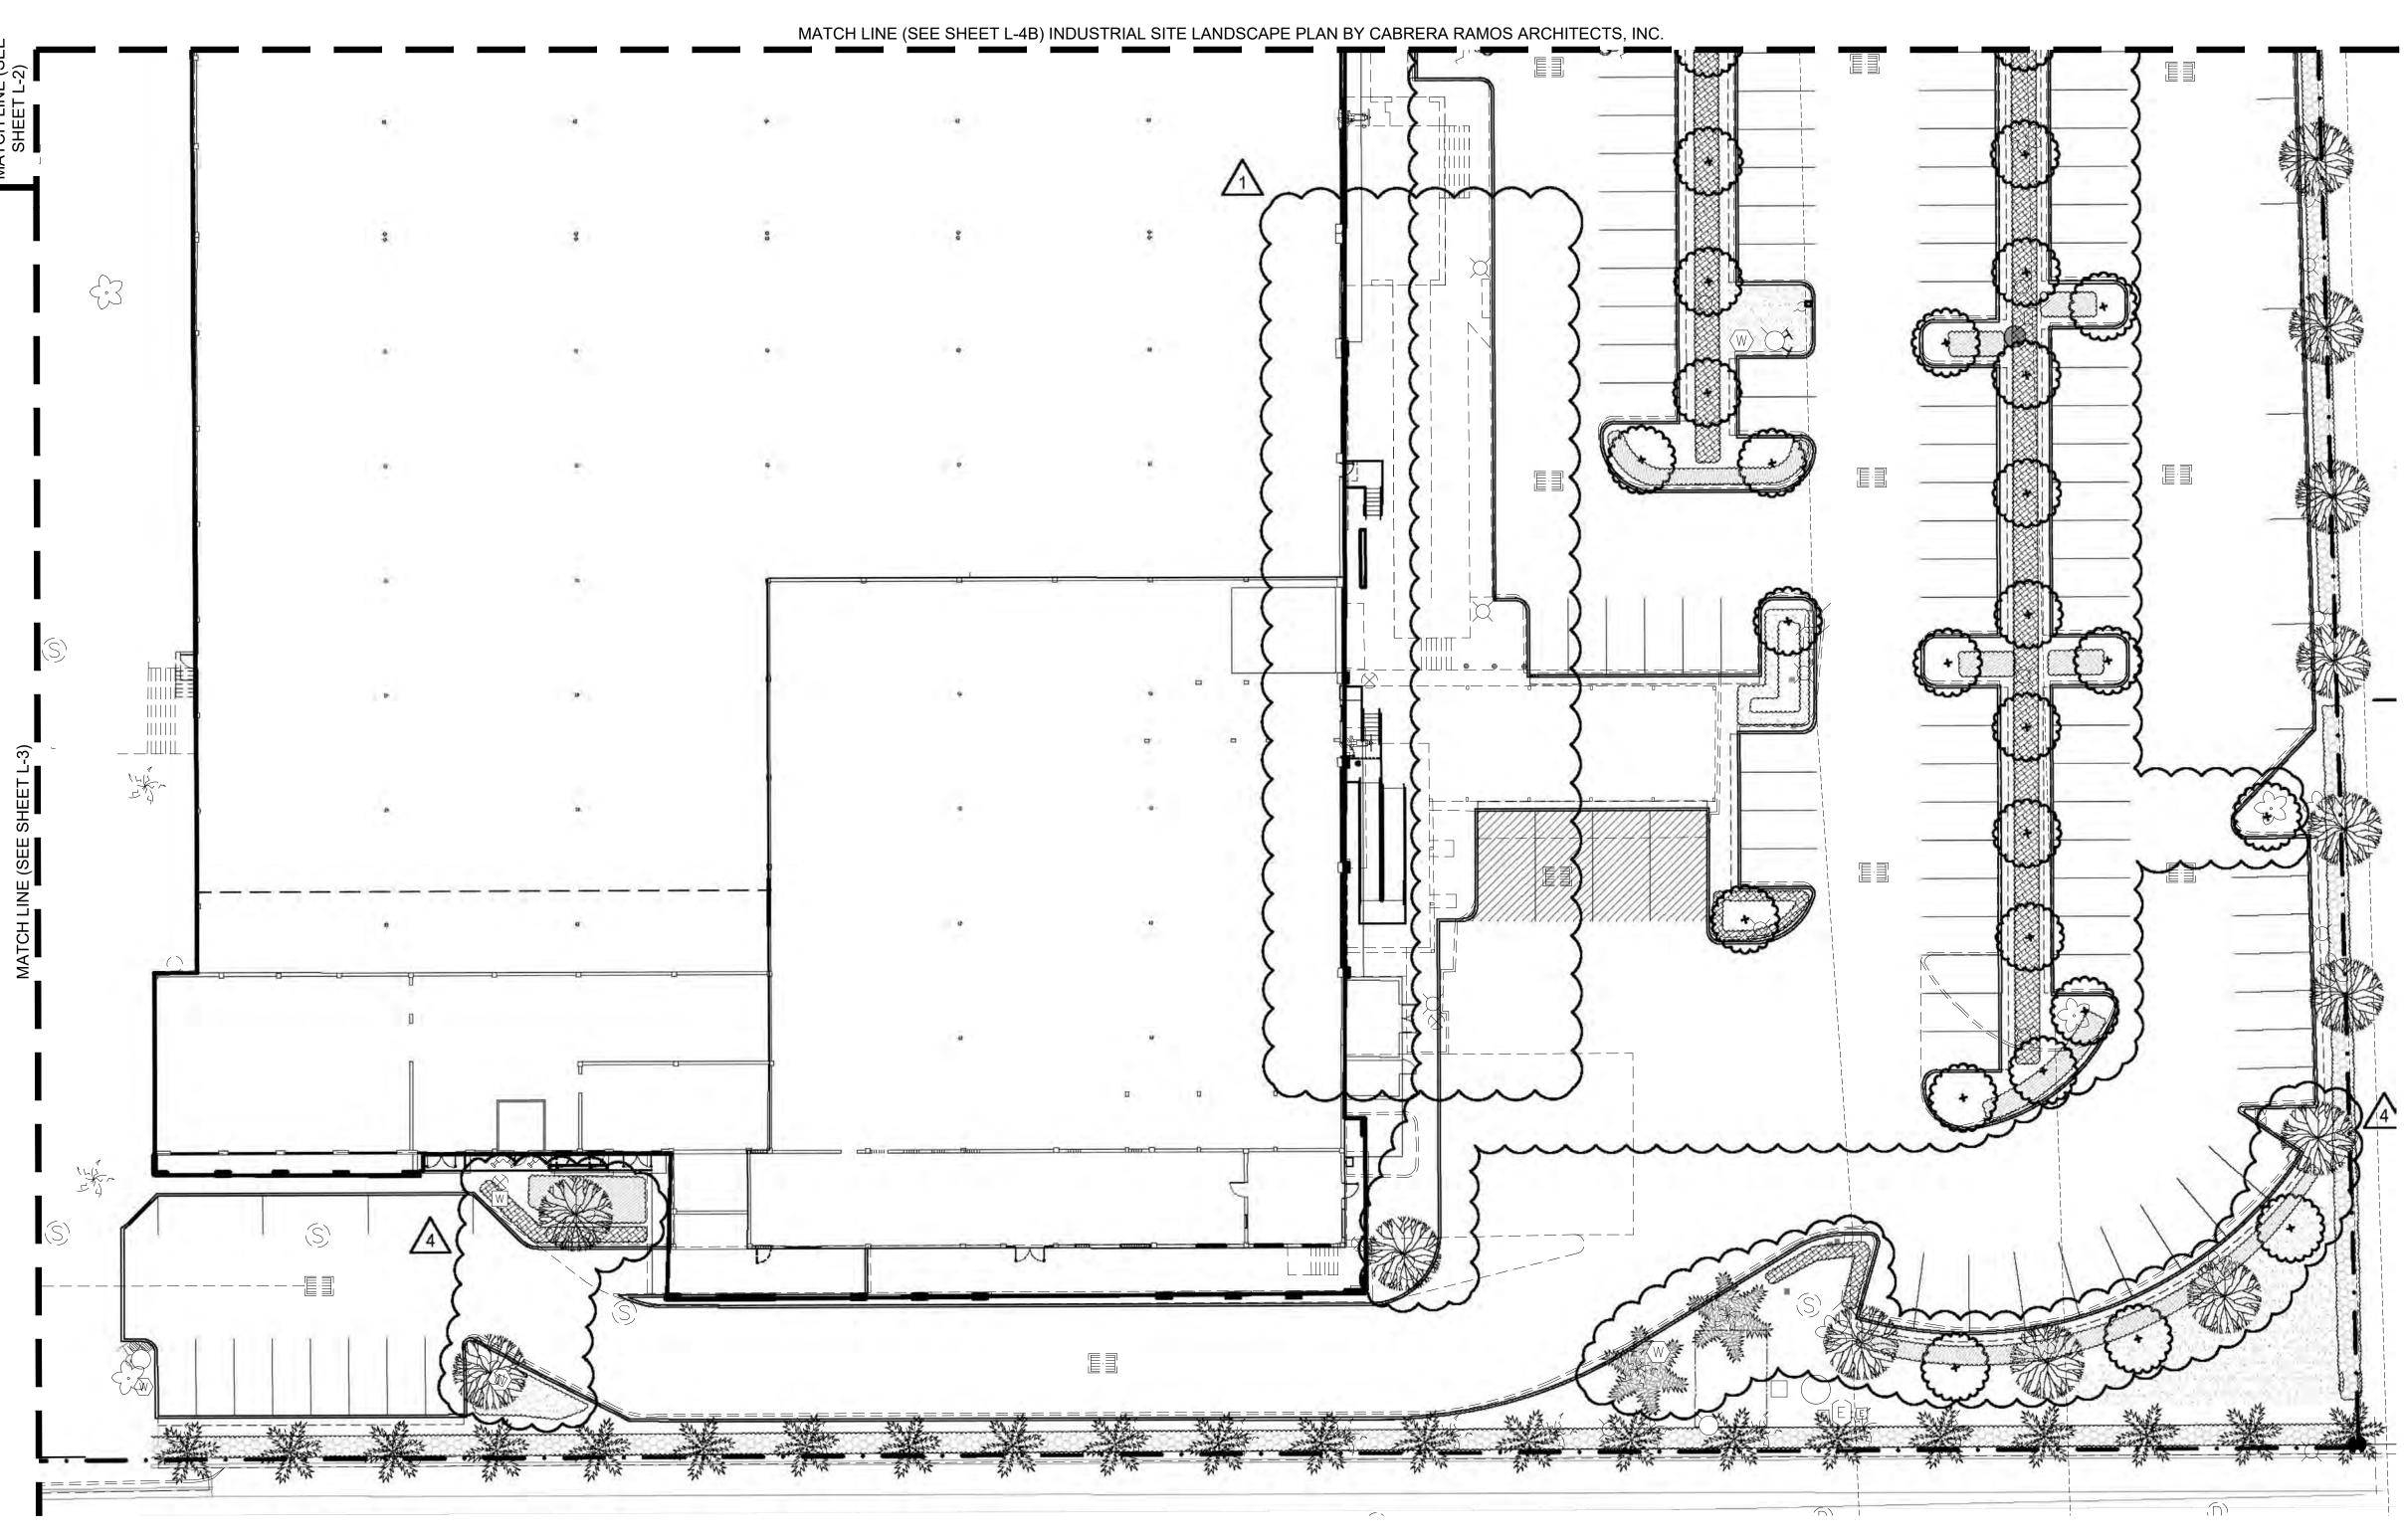

INDUSTRIAL SITE LANDSCAPE PLAN BY CABRERA RAMOS ARCHITECTS, INC.

Scale: 1"=20'-0"

Scale: 1"=20'-0"



©2020 WITKIN HULTS + PARTNERS
THE DESIGN AND DRAWINGS HEREIN ARE THE
INTELLECTUAL PROPERTY OF THIS
LANDSCAPE ARCHITECT AND ARE PROTECTED
UNDER THE COPYRIGHT PROTECTION ACT

82ND AVENUE DORAL FLORIDA 33122 LEGACY AT DORAL 2525 NW


Lic. # LA0000889 Member: A.S.L.A.

Drawing: Landscape Plan Scale: See Left Drawn by: MAV

Cad Id.: 2021-037

NOTES:

• ALL TREES ON INDUSTRIAL SITE ARE EXISTING.

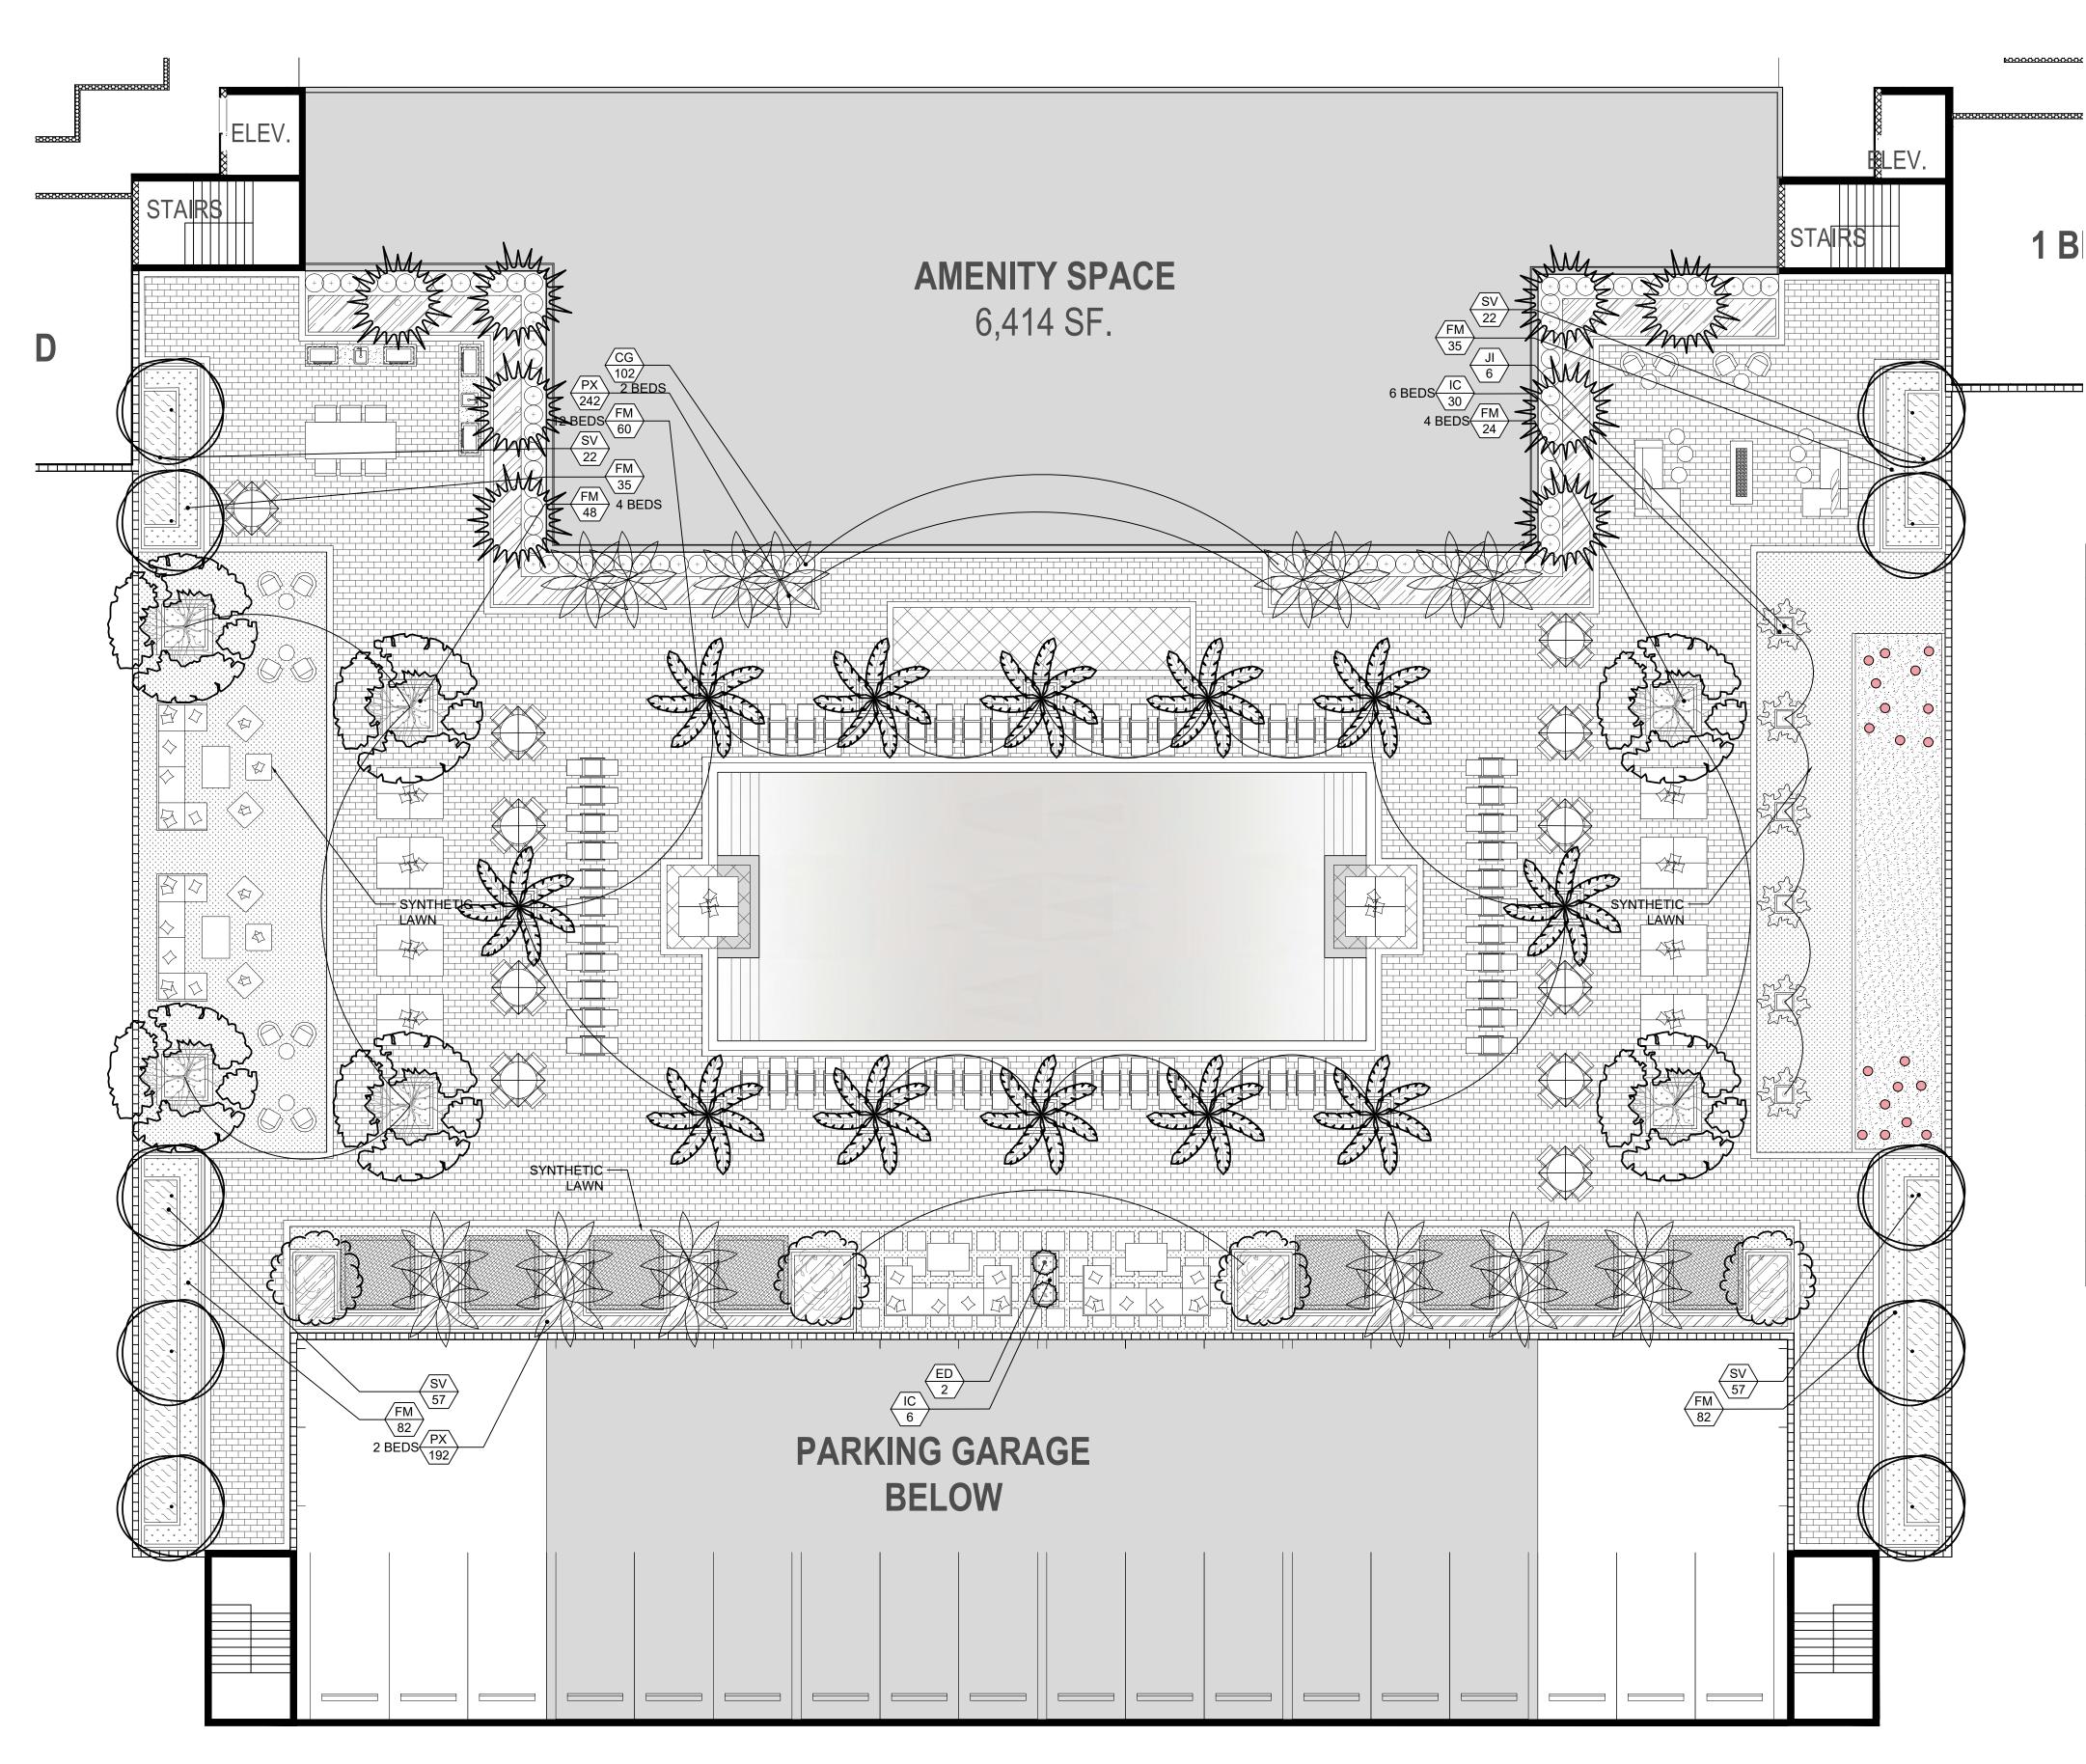

#### LANDSCAPE LIST

|  |          | TREES                              |                               |
|--|----------|------------------------------------|-------------------------------|
| SYMBOL   | QUAN.    | PROPOSED MATERIAL                  | DESCRIPTION                   |
| $\bigcirc$   | 10       | *Coccoloba diversiflora            | 10' HT. 2.5" Cal.             |
|  | 10       | PIGEON PLUM                        | F.G.                          |
| (E)3   | 4        | Ligustrum japonicum                | 10' HT. X 8' SPR., MULTI TRUN |
| E CONTRACTOR OF THE PARTY OF TH | 4        | JAPANESE PRIVET                    | F.G.                          |
| Sully Market   | 8        | Elaeocarpus decipiens              | 10' HT. 2.5" Cal.             |
|  | 0        | JAPANESE BLUEBERRY                 | F.G.                          |
|  | 6        | Bulnesia arborea                   | 10' HT. 2.5" Cal.             |
|  | 6        | VERAWOOD                           | F.G.                          |
| M  | 10       | Phoenix sylvestris                 | 10' C.T.                      |
|  | 12       | SILVER DATE PALM                   | F.G.                          |
|  | 40       | Veitchia montgomeryana 'double'    | 16' O.A. HT. MIN., DOUBLE     |
|  | 10       | DOUBLE MONTGOMERY PALM             | F.G., STAGGERED.              |
|  |          | SHRUBS AND GROUNDCO                | VERS                          |
| SYMBOL   | QUAN.    | PROPOSED MATERIAL                  | DESCRIPTION                   |
| CG   | 102      | *Clusia guttifera                  | 24" HT. X 24" SPR. / 24" O.C. |
|  |          | SMALL LEAF CLUSIA                  | 3 GAL.                        |
| ED   | 2        | Elaeocarpus decipiens              | 6-7' HT., STANDARD            |
| ED   |          | JAPANESE BLUEBERRY                 | 15 GAL.                       |
| FM   | 200      | Ficus microcarpa 'Green Island'    | 15" HT. X 15" SPR. / 15" O.C. |
| ΓIVI   | 366      | GREEN ISLAND FICUS                 | 3 GAL.                        |
| IC   | 20       | Ipomoea 'Margarite'                | 15" O.C.                      |
| 10   | 36       | CHARTREUSE SWEET POTATO            | 1 GAL. FULL                   |
| П  | (        | Jatropha integerrima               | 6' HT. X 4' SPR.              |
| JI   | 6        | JATROPHA TREE                      | 30 GAL., FULL                 |
| DV   | 101      | Philodendron xanadu                | 18" HT. X 15" SPR. / 18" O.C. |
| PX   | 434      | DWARF PHILODENDRON                 | 3 GAL.                        |
| SV   | 150      | Schefflera arboricola 'Trinette'   | 18" HT. X 18" SPR. / 18" O.C. |
| 31   | 158      | VARIEGATED SCHEFFLERA              | 3 GAL.                        |
| Ι Λ\Λ/ΝΙ   | As       | Stenotaphrum secundatum 'Floratam' | COLID EVEN COD                |
| LAWN   | Required | ST. AUGUSTINE GRASS                | SOLID EVEN SOD                |

POOL DECK LANDSCAPE PLAN NORTH

Scale: 1"=10'-0"



©2020 WITKIN HULTS + PARTNERS
THE DESIGN AND DRAWINGS HEREIN ARE THE
INTELLECTUAL PROPERTY OF THIS
LANDSCAPE ARCHITECT AND ARE PROTECTED
UNDER THE COPYRIGHT PROTECTION ACT


82ND AVENUE DORAL FLORIDA AT DORAL

| Ш  |                                   |          |
|--|-----------------------------------|----------|
|  |                                   |          |
| Revisions:  1) City Comments 2) Site Plan Coordination | Date:<br>08.15.2022<br>02.03.2023 | By:      |
| 3) Site Plan Coordination                              | 02.22.2023                        | MAV      |
|  |                                   | <u> </u> |
|  |                                   | _        |
|  |                                   | <u> </u> |
|  |                                   | _        |
|  |                                   | _        |
|  |                                   |          |


| Seal:            |  |
|------------------|--|
|                  |  |
|                  |  |
|                  |  |
|                  |  |
|                  |  |
|                  |  |
| Lic. # LA0000889 |  |
| Member: A.S.L.A. |  |

| Drawing: Landscape Plan | _ |
|-------------------------|---|
| Date: 05/11/2021        |   |
| Scale: See Left         |   |
| Drawn by: MAV           |   |
| Sheet No.:              |   |
|                         |   |
| L-6                     |   |
| Cad Id.: 2021-037       |   |


WHEN USED AS A HEDGE. PLANTINGS SHALL BE PLANTED AT A MAXIMUM AVERAGE SPACING OF 30 INCHES ON CENTER OR, IF PLANTED AT A MINIMUM HEIGHT OF 36 INCES, SHALL HAVE A MAXIMUM AVERAGE SPACING OF 48 INCHES ON CENTER AND SHALL BE MAINTAIBED SO AS TO FORM A CONTINUOUS, UNBROKEN AND SOLID VISUAL SCREEN WITHIN ONE YEAR AFTER TIME OF PLANTING.

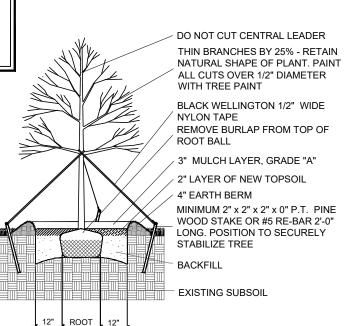


LARGE TREE PLANTING DETAIL

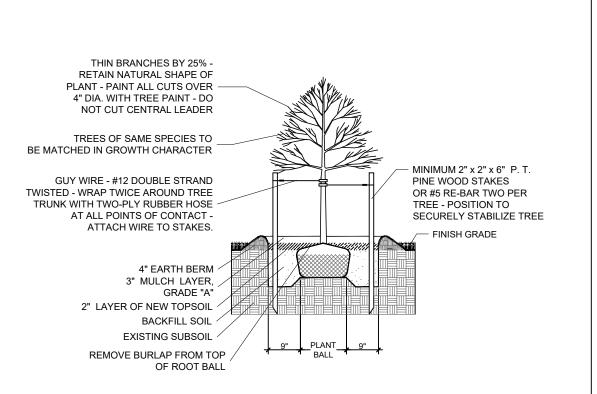


SMALL TREE PLANTING DETAIL

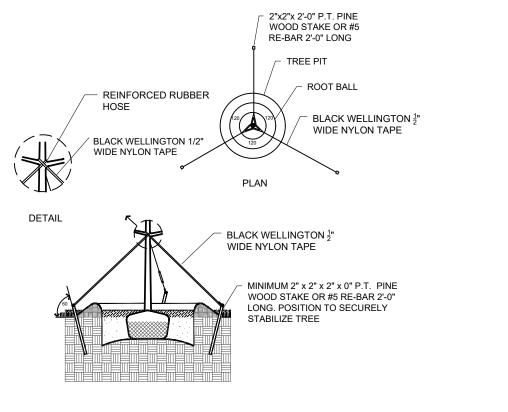


TYPICAL TREE GUYING DETAIL

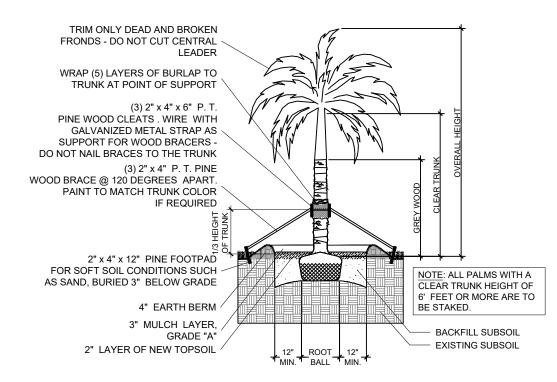


STRAIGHT TRUNK PALM PLANTING DETAIL

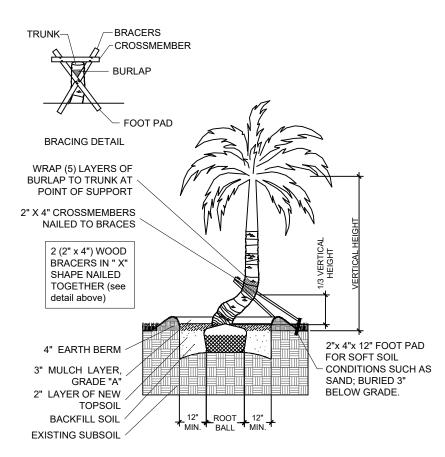



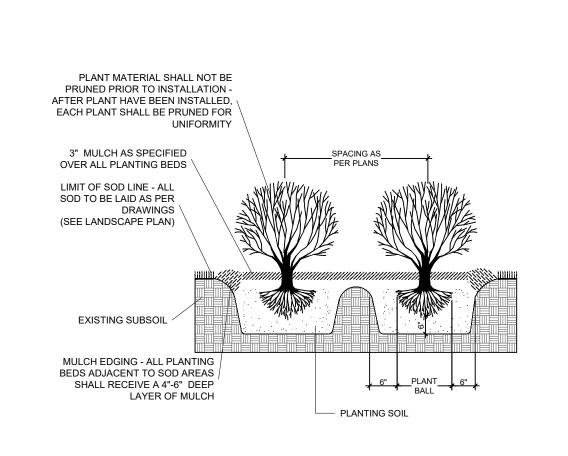


TYPICAL SHRUB PLANTING DETAIL

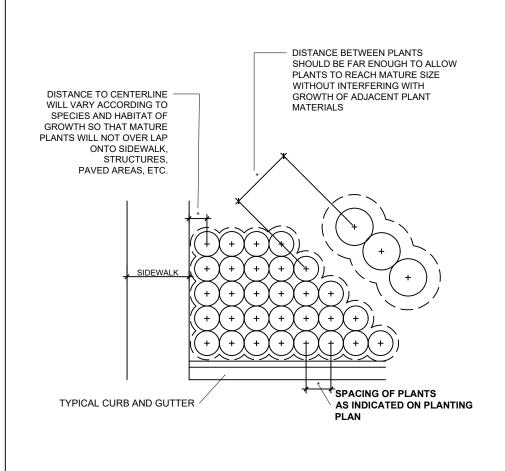

TYPICAL CONTAINER SPACING DETAIL

**SOD NOTES:** 

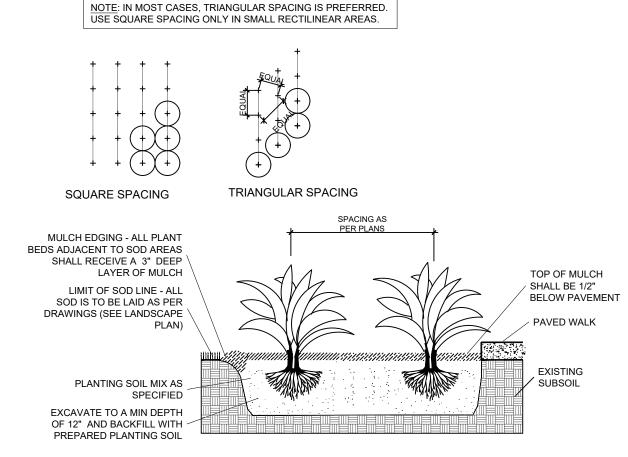

TYPICAL GROUNDCOVER PLANTING DETAIL

-Sod is to be grade "A" weed free.

-All areas marked "LAWN" shall be solid sodded with St. Augustine 'Floratam' solid sod. See limit on plan. All areas marked 'Bahia Grass' shall be solid sodded with Paspalum.

-Provide a 2" deep blanket of planting soil as described in planting notes this sheet. Prior to planting, remove stones, sticks, etc. from the sub soil surface. Excavate existing non-conforming soil as required so that the finish grade of sod is flush with adjacent pavement or top of curb as well as adjacent sod in the case of sod patching.

-Place sod on moistened soil, with edges tightly butted, in staggered rows at right angles to slopes.

-Keep edge of sod bed a minimum of 18" away from groundcover beds and 24" away from edge of shrub beds and 36" away from trees, measured from center of plant.

-Sod Shall be watered immediatley after installation to uniformily wet the soil to at least 2" below the bottom of the sod

-Excavate and remove excess soil so top of sod is flush with top of curb or adjacent pavement or adjacent existing


#### **GENERAL NOTES:**


-The Landscape Contractor is to locate and verify all underground and overhead utilities prior to beginning work. Contact proper utility companies and / or General Contractor prior to digging for field verification. The Owner and the Landscape Architect shall not be responsible for any damages to utility or irrigation lines (see Roadway Plans for more utility notes).

-Landscape Contractor is to verify all current drawings and check for discrepancies and bring to the attention of the Landscape Architect prior to commencing with the work.

-All unattended and unplanted tree pits are to be properly barricaded and flagged during installation.

-All planting plans are issued as directives for site layout. Any deviations, site changes, etcetera are to be brought to the attention of the Landscape Architect for clarification prior to installation.

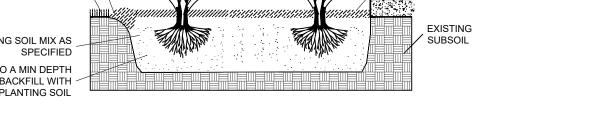

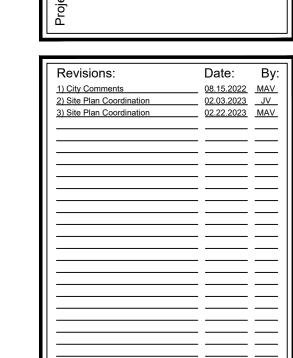

©2020 WITKIN HULTS + PARTNERS

THE DESIGN AND DRAWINGS HEREIN ARE THE

INTELLECTUAL PROPERTY OF THIS

LANDSCAPE ARCHITECT AND ARE PROTECTED UNDER THE COPYRIGHT PROTECTION ACT

OR.

| Seal:                                |  |
|--------------------------------------|--|
|                                      |  |
|                                      |  |
|                                      |  |
|                                      |  |
| Lic. # LA0000889<br>Member: A.S.L.A. |  |

| Drawing: Landscape Details |
|----------------------------|
| Date: 05/11/2021           |
| Scale: See Left            |
| Drawn by: MAV              |
| Sheet No.:                 |
| L-7                        |
| Cad Id.: 2021-037          |
|                            |

#### **PLANTING NOTES:**

-All plant material is to be Florida Number 1 or better pursuant to the Florida Department of Agriculture's Grades and Standards for Nursery Plants.

-All plants are to be top dressed with a minimum 3" layer of Melaleuca mulch, Eucalyptus mulch or equal.

-Planting plans shall take precedence over plant list in case of discrepancies.

-No changes are to be made without the prior consent of the Landscape Architect and Owner. Additions and or deletions to the plant material must be approved by the project engineer.

-Landscape Contractor is responsible for providing their own square footage takeoffs and field verification for 100% sod coverage for all areas specified.


- All landscape areas are to be provided with automatic sprinkler system which provide 100% coverage, and 50% overlap.

- All trees in lawn areas are to receive a 24" diameter mulched saucer at the base of the trunk.

- Trees are to be planted within parking islands after soil is brought up to grade. Deeply set root balls are not acceptable.

- Planting soil for topsoil and backfill shall be 50/50 mix, nematode free. Planting soil for annual beds to be comprised of 50% Canadian peat moss, 25% salt free coarse sand and 25% Aerolite.


- Tree and shrub pits will be supplemented with "Agriform Pells", 21 gram size with a 20-10-5 analysis, or substitute application accepted by Landscape Architect. Deliver in manufacturer's standard containers showing weight, analysis and name of manufacturer.

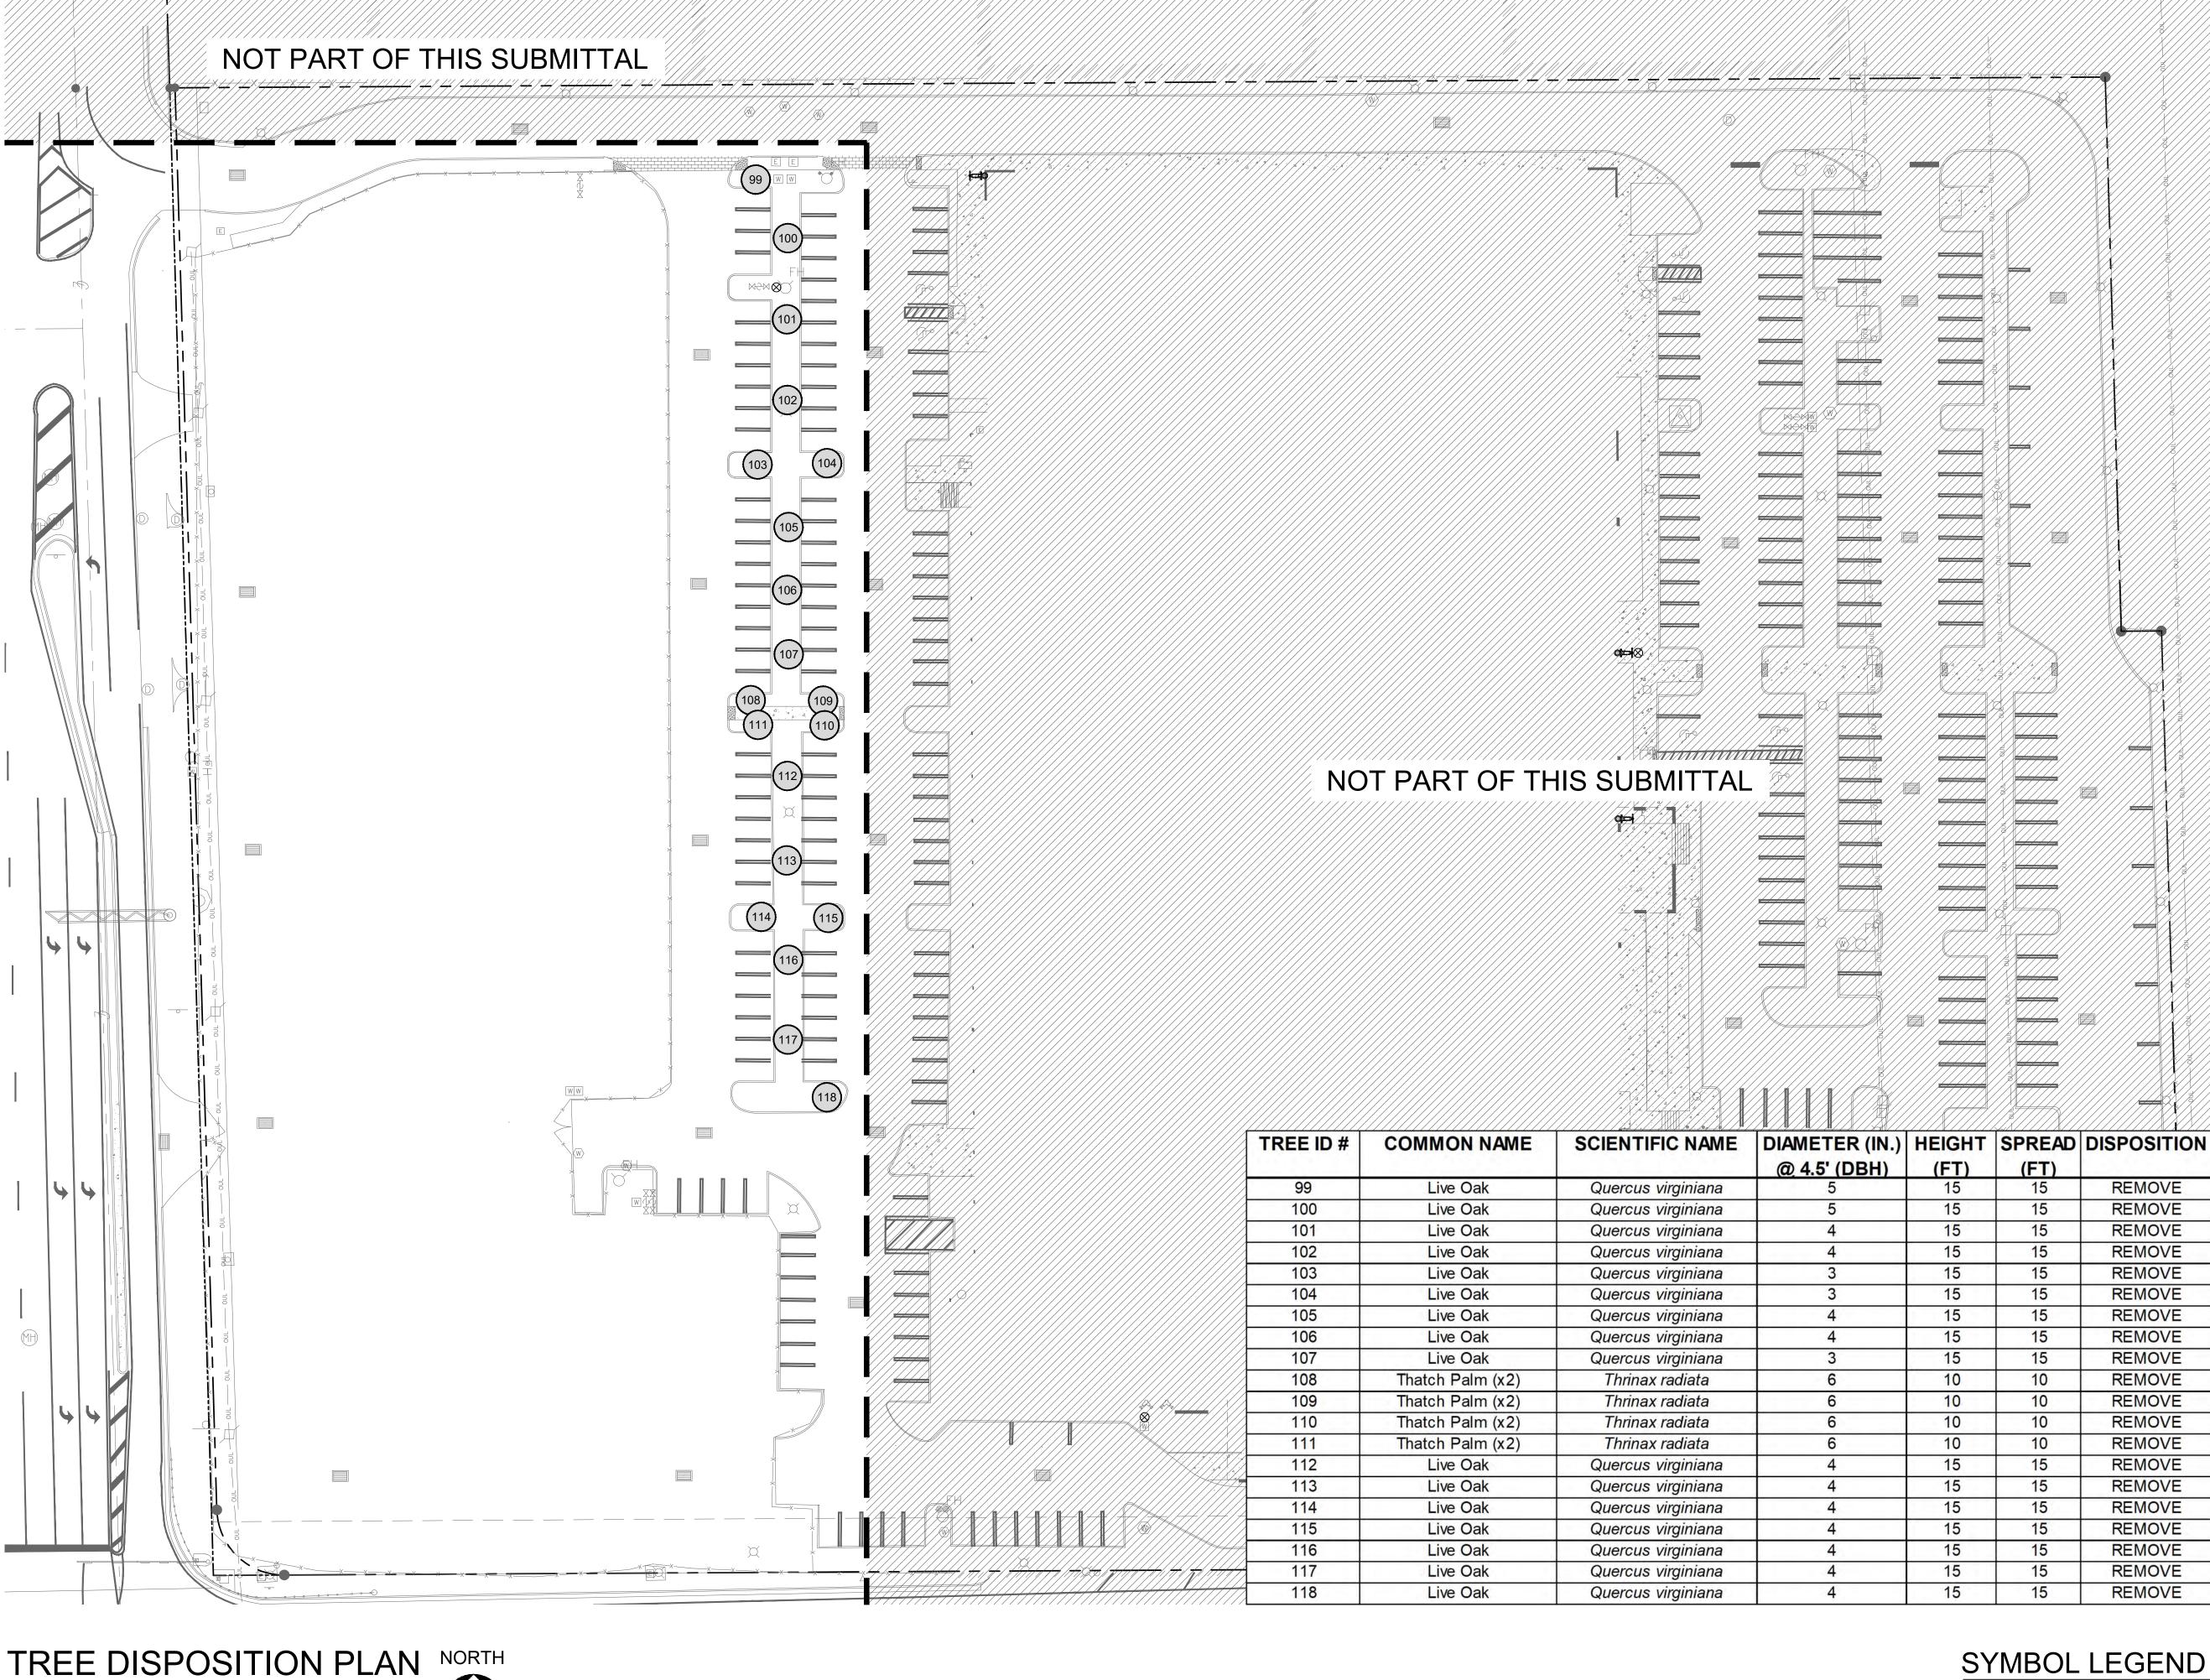

Scale: 1"=30'-0"

SYMBOL LEGEND


(#x) Tree to Remove

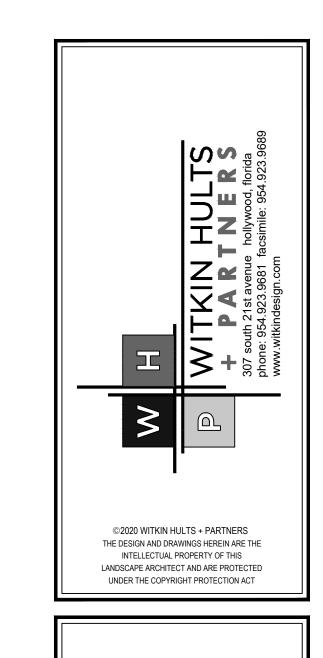



2525 NW

| Revisions:  1) City Comments | Date:<br>08.15.2022 | By<br>MAV |
|------------------------------|---------------------|-----------|
|                              |                     |           |
|                              |                     |           |
|                              |                     |           |
|                              |                     |           |
|                              |                     |           |
|                              |                     |           |
|                              |                     |           |
|                              |                     | _         |
|                              |                     |           |
|                              |                     | _         |
|                              |                     |           |
|                              |                     |           |


| _        |                  |
|----------|------------------|
|          |                  |
|          | Seal:            |
|          |                  |
|          |                  |
|          | Lic. # LA0000889 |
| ~        | Member: A.S.L.A. |
| 15, 2022 |                  |
| 15       |                  |

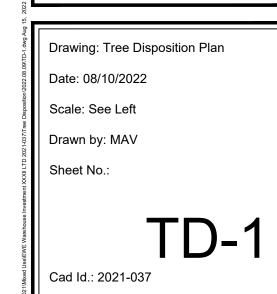

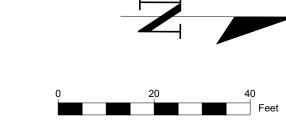

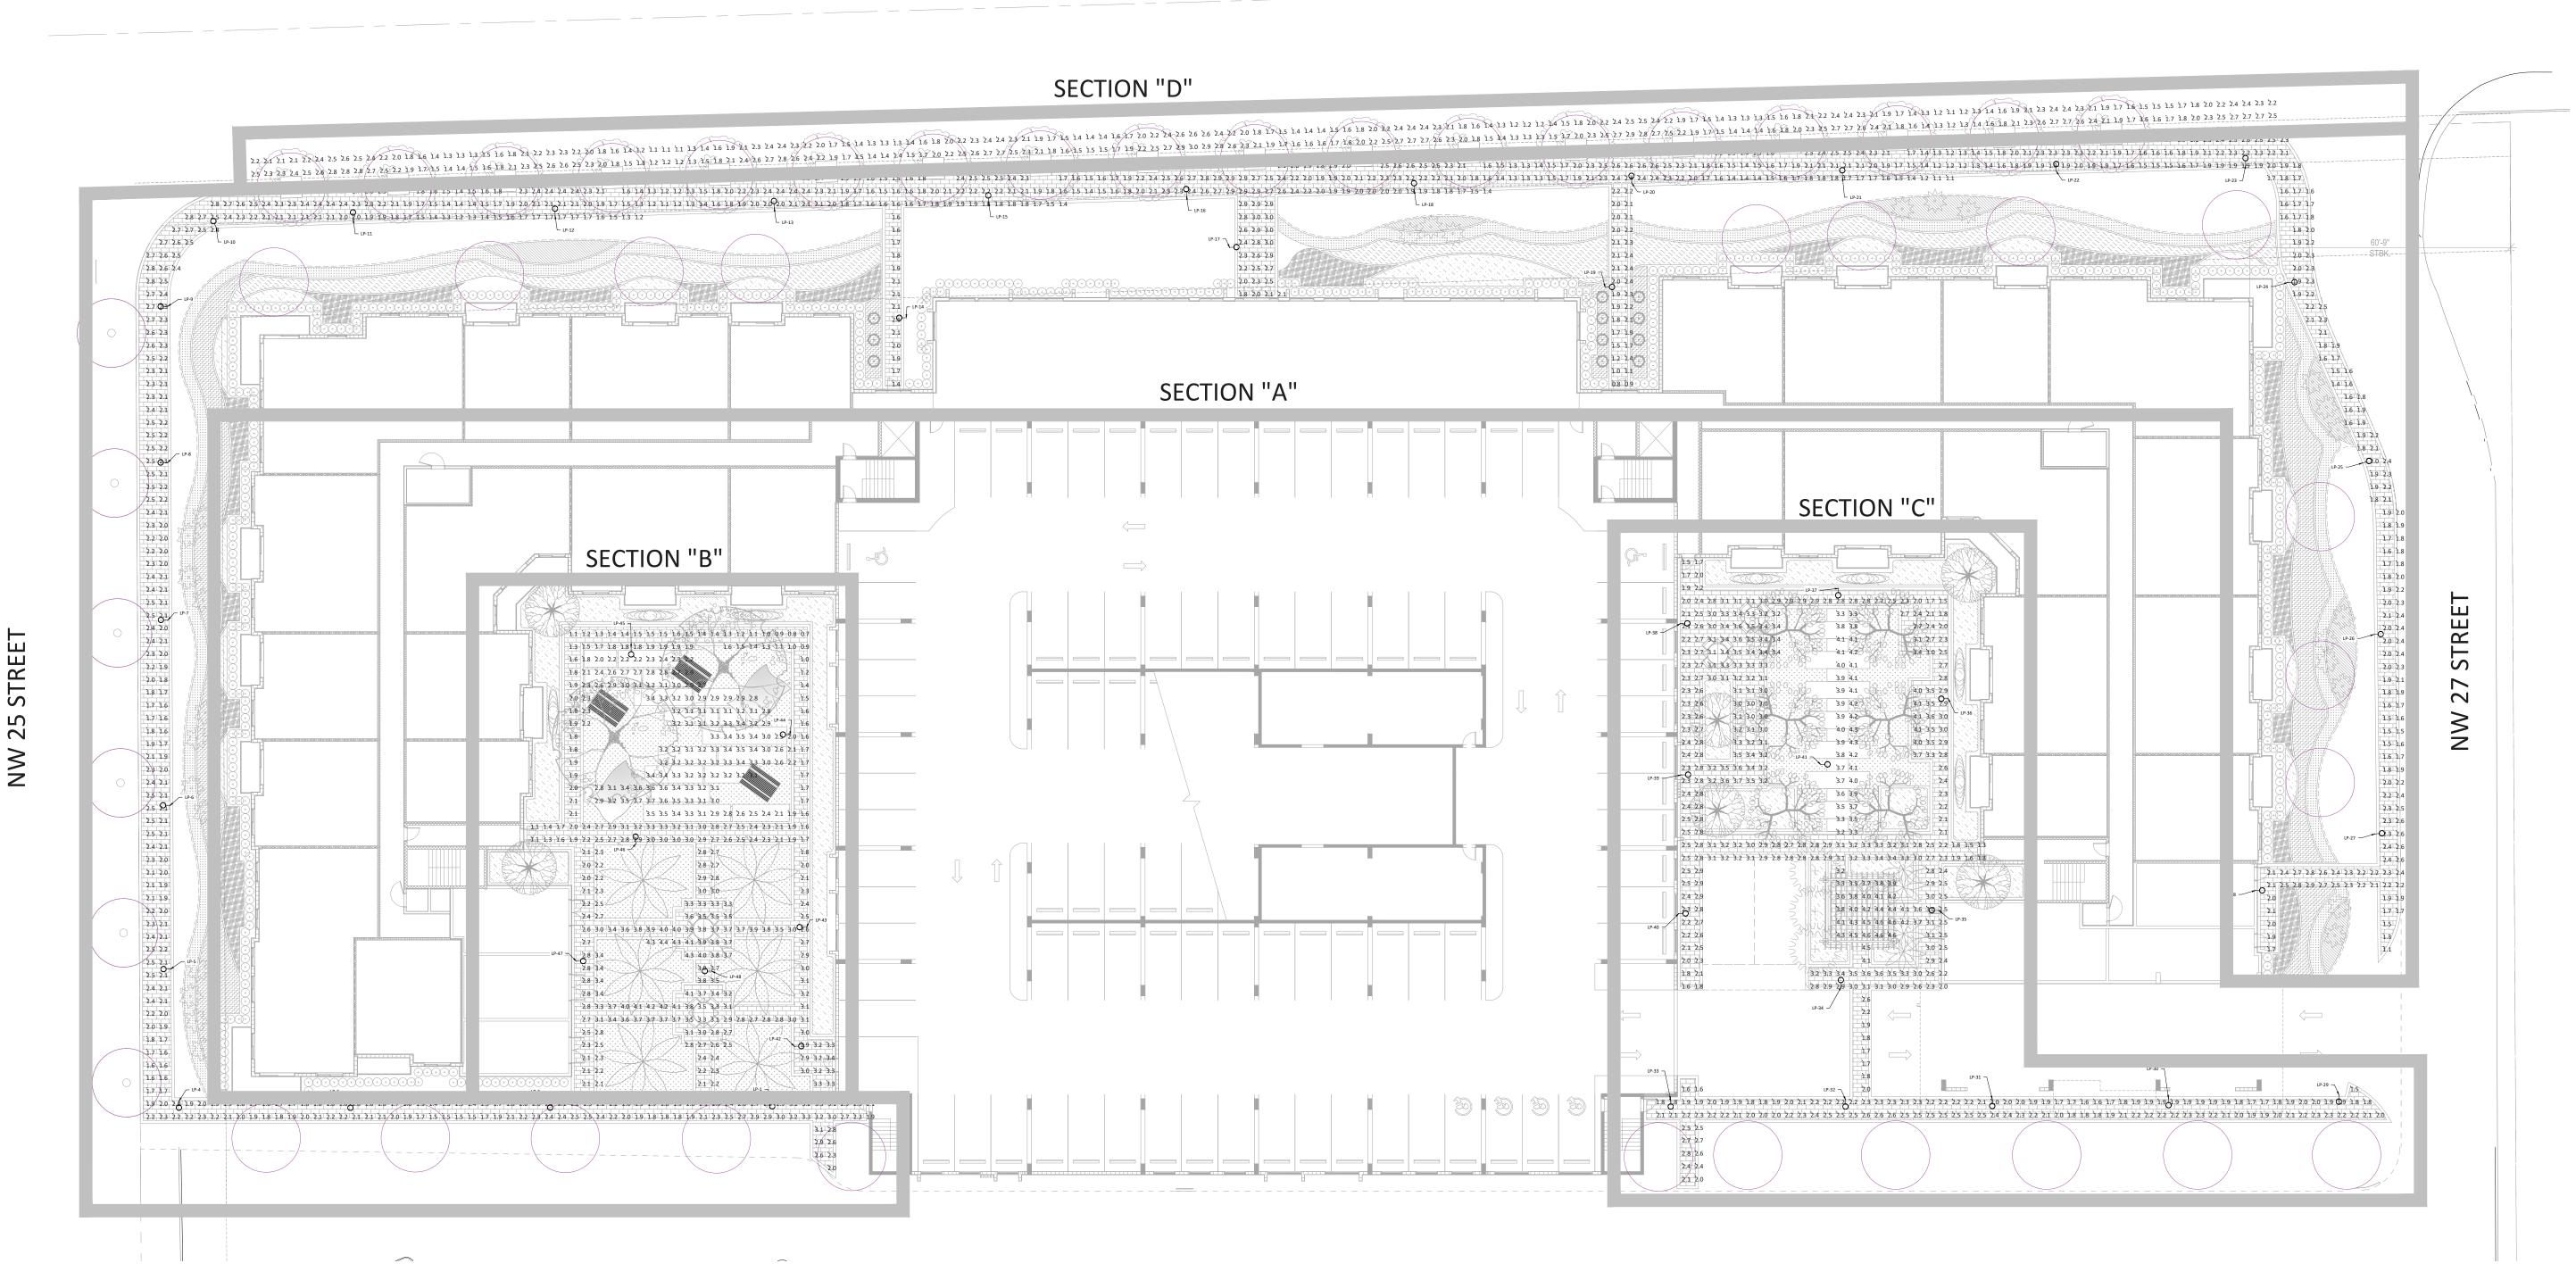

| LUMINAIRE DEFINITION   | DN   | CALCULATIO   | ON SUMMARY   |
|--|--|--|--|
| LUMINAIRE: DESCRIPTION   | GRLF3_P10_27K_XXXXX_ASY GRLF3 P10 27K XXXXX ASY  | SECTION "A"  | SECTION "C"  |
| ATTRIBUTES FILENAME [MANUFAC] [LUMCAT] PHOTOMETRY  | GRLF3 P10_27K_XXXXX AST  GRLF3 P10_27K_XXXXX_SYM.IES HOLOPHANE GRLF3 P10 27K XXXXX ASY | ILLUMINANCE (FC)<br>AVERAGE 2.05<br>AVG/MIN 2.56<br>MAX/MIN 4.13 | ILLUMINANCE (FC)<br>AVERAGE 2.79<br>AVG/MIN 2.15<br>MAX/MIN 3.54 |
| ARRANGEMENT LUMINAIRE LUMENS<br>LUMINAIRE LUMENS   | 3738<br>3738   | SECTION "B"  | SECTION "D"  |
| LUMINAIRE WATTS ARRANGEMENT WATTS LUMINAIRE EFFICIENCY (%) S/P RATIO TOTAL LIGHT LOSS FACTOR ROAD CLASSIFICATION | 30<br>30<br>N.A.<br>1.00<br>1.000<br>TYPE IV   | ILLUMINANCE (FC)<br>AVERAGE 2.73<br>AVG/MIN 3.90<br>MAX/MIN 6.29 | ILLUMINANCE (FC)<br>AVERAGE 2.02<br>AVG/MIN 1.84<br>MAX/MIN 2.73 |
| LONGTITUDINAL CLASSIFICATION INDOOR CLASSIFICATION LER UPWARD WASTE LIGHT RATIO MAX UGR BUG RATING               | VERY SHORT DIRECT 125 0.00 33.3 B1-U0-G1   | NOTE: SEE SHEETS L-2 VIEWS OF PHOT                               | THRU L-5 FOR SCALED<br>OMETRIC SECTIONS                          |
| CONTROL: PR7:7 PIN NEMA PHOTOCONTRO SH:SHORTING CAP,   |  |  |  |

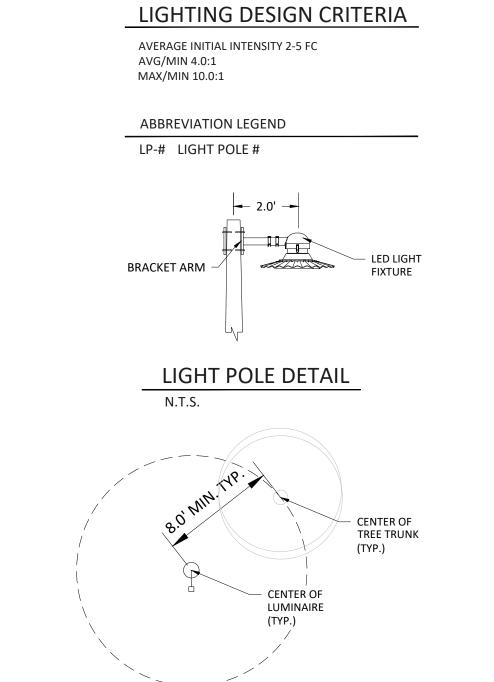

LIGHT POLE CLEARANCE DETAIL

Sunshine

Call 811 or visit sunshine811.com two full business days before digging to have buried facilities located and marked.

Check positive response codes before you dig!

THE OFFICIAL RECORD OF THIS SHEET IS THE ELECTRONIC FILE DIGITALLY SIGNED AND SEALED UNDER RULE 61G15-23.004, F.A.C.

exp U.S. Services Inc.

t: +1.305.631.2208| f: +1.407.660.1655
201 Alhambra Circle, Suite 800
Coral Gables, FL 33134
U.S.A.

www.exp.com

BUILDINGS • EARTH & ENVIRONMENT •
 ENERGY • INDUSTRIAL • INFRASTRUCTURE •

SUSTAINABILITY

PROJECT:

#### **LEGACY AT DORAL**

2525 NW 82ND AVENUE, DORAL, FL. 33122

OWNER:

## TheEastonGroup

101 N.W. 19 ST.
MIAMI, FL 33172
TEL - (305) 593-2222
FAX - (305) 591-3863
www.theeastongroup.com

SHTING PHOTOMETRIC PLAN

PHASE:

# SCHEMATIC DESIGN

| RI         | EVISIONS                |      |
|------------|-------------------------|------|
| Revision # | Revision<br>Description | Date |
|            |                         |      |
|            |                         |      |
SEAL



THIS DOCUMENT HAS BEEN DIGITALLY SIGNED AND SEALED BY EUGENE COLLINGS-BONFILL, PE, PSM, MBA, PMP, DBIA,ENV SP, CFM ON THE DATE ADJACENT TO THE SEAL.

PRINTED COPIES OF THIS DOCUMENT ARE NOT CONSIDERED SIGNED AND SEALED. THE SIGNATURE MUST BE VERIFIED ON THE ELECTRONIC DOCUMENTS.


THIS DRAWINGS IS THE PROPERTY OF EXP U.S. SERVICES, INC.
UNLESS OTHERWISE PROVIDED FOR BY CONTRACT, THE
CONTENTS OF THIS DRAWINGS ARE CONFIDENTIAL AND
SHALL NOT BE TRANSMITTED TO ANY OTHER PARTY
EXCEPT AS AGREED TO BY THE ARCHITECT/ENGINEERS.

DATE:
PROJ No.:
DRAWN BY:
APPR BY:

**8/18/2022** 21010276-A0 **ED RM** 

SHEET NUMBER:

L-1.01

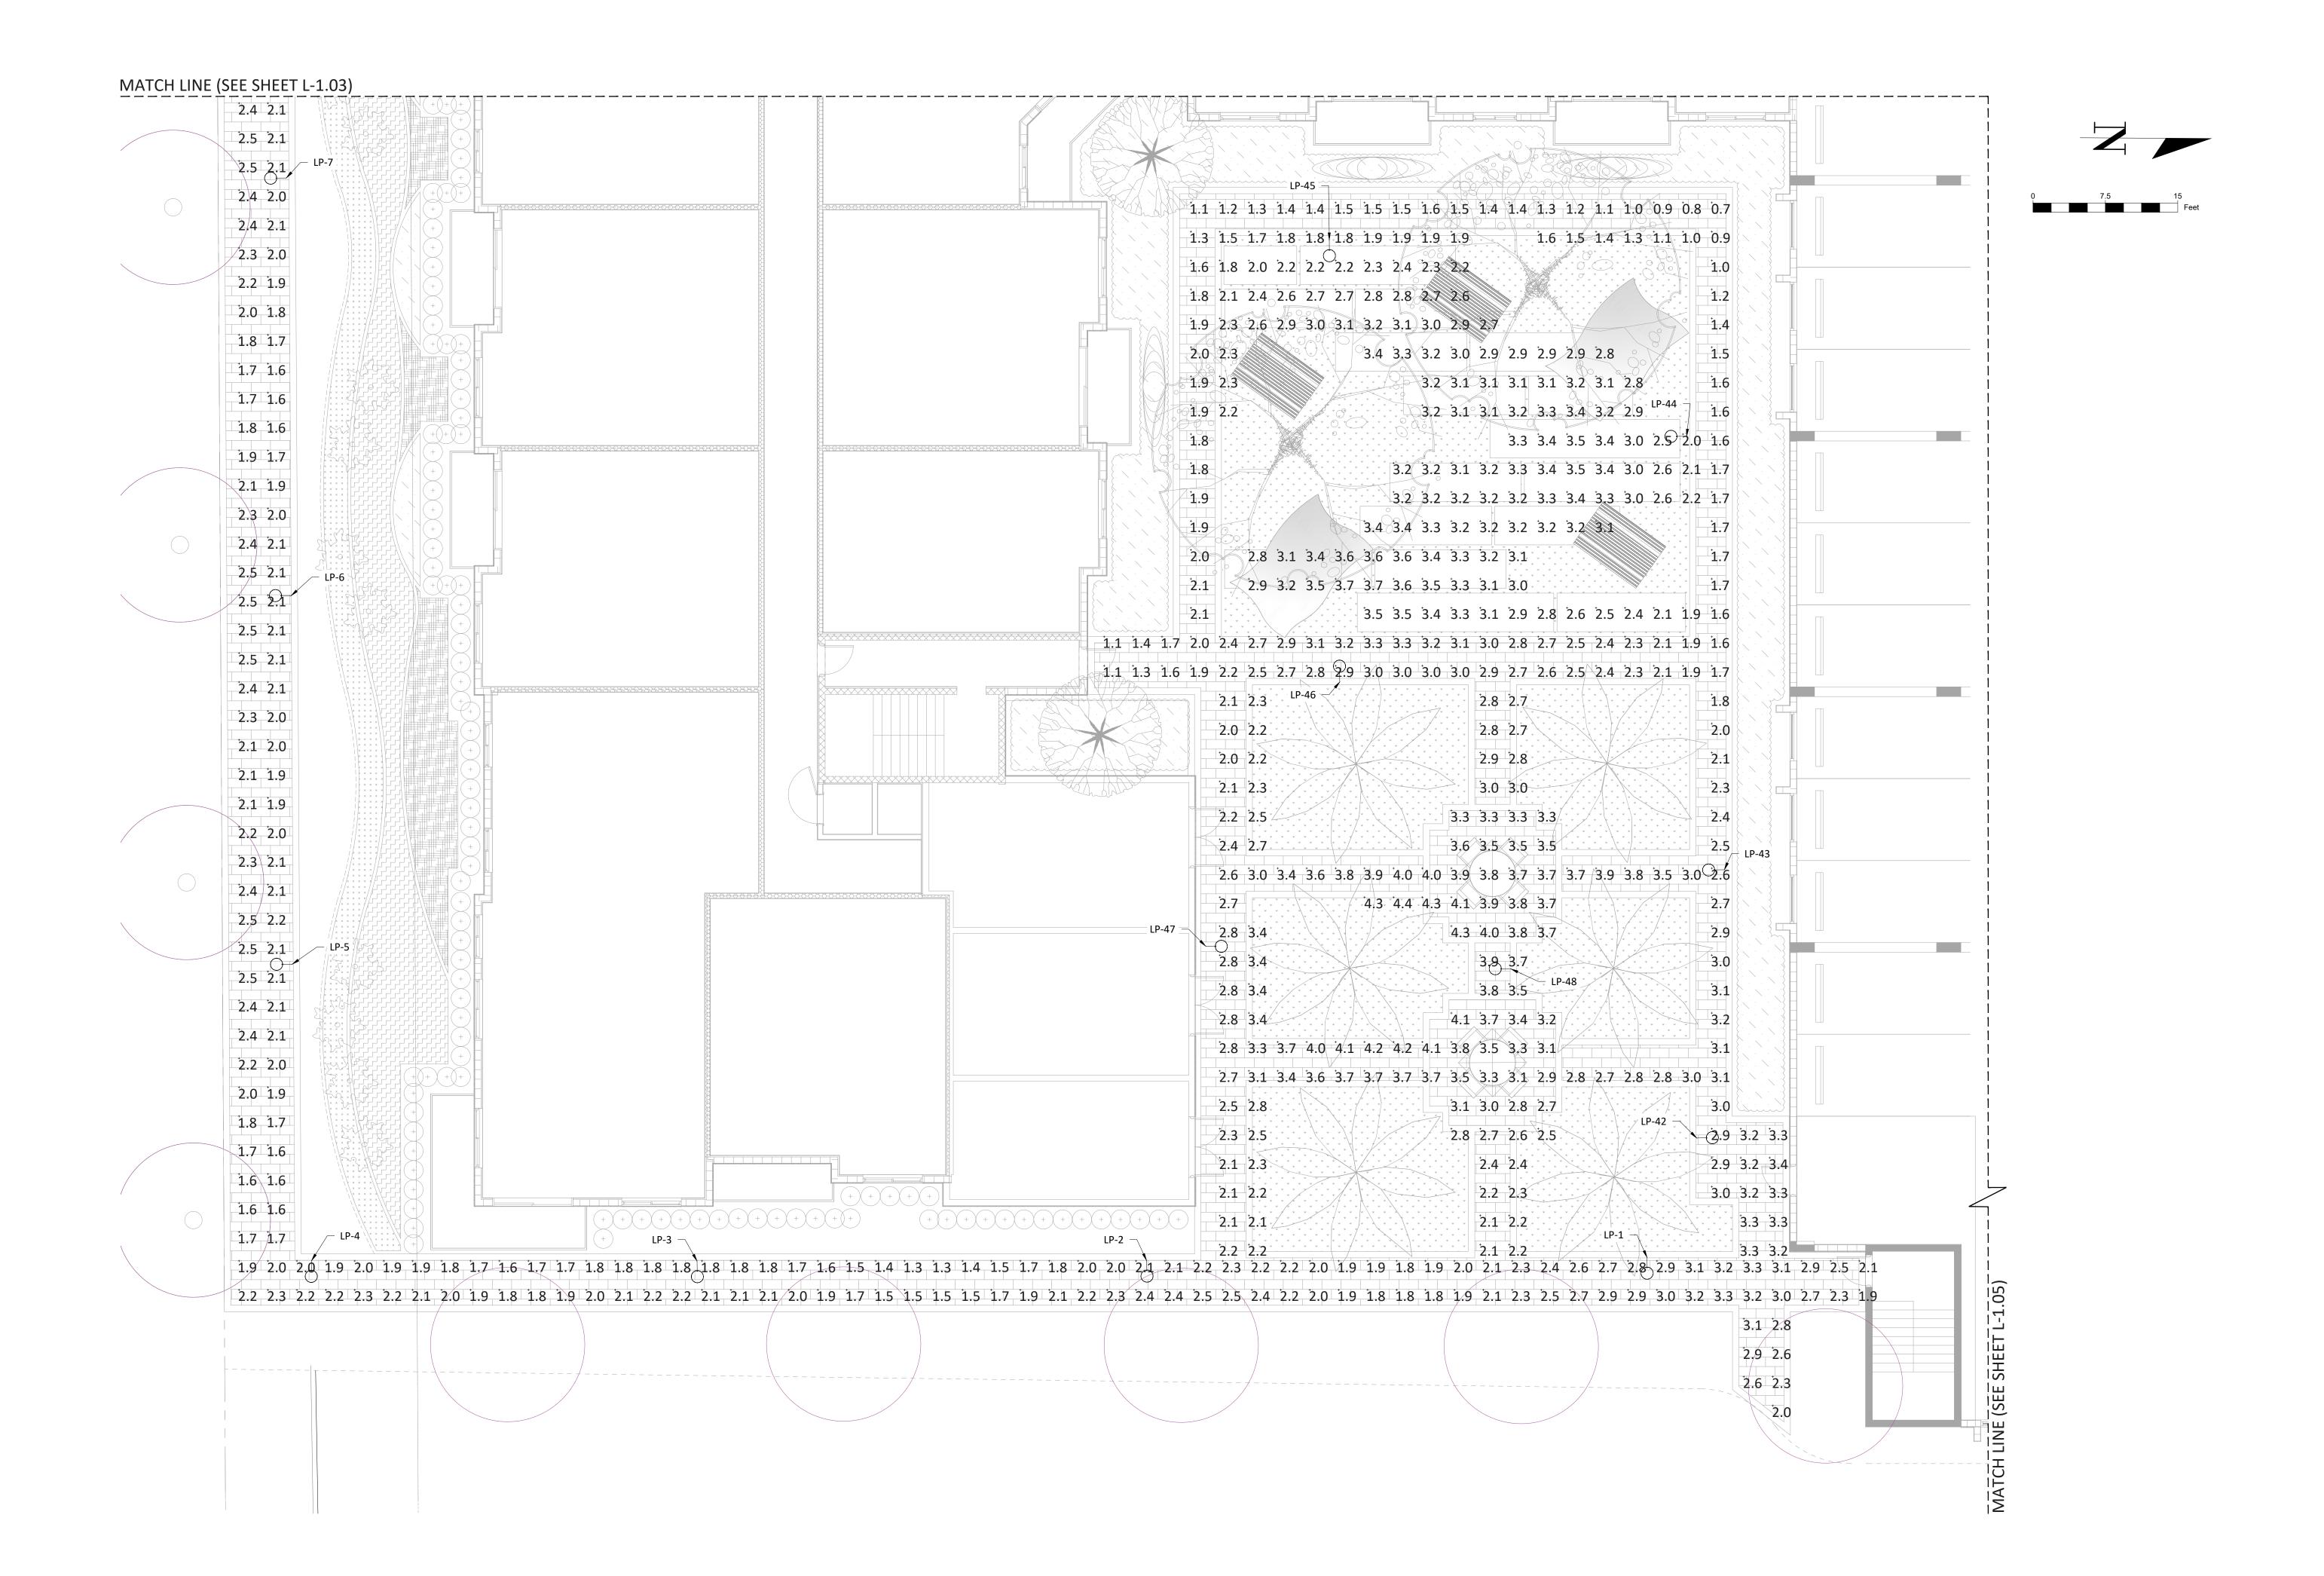

**exp** U.S. Services Inc. 201 Alhambra Circle, Suite 800 Coral Gables, FL 33134 www.exp.com

• BUILDINGS • EARTH & ENVIRONMENT • • ENERGY • INDUSTRIAL • INFRASTRUCTURE •

• SUSTAINABILITY •

PROJECT:

#### **LEGACY AT DORAL**

2525 NW 82ND AVENUE, DORAL, FL. 33122

OWNER:

#### TheEastonGroup

101 N.W. 19 ST. MIAMI, FL 33172 TEL - (305) 593-2222 FAX - (305) 591-3863 www.theeastongroup.com

PHASE:

## **SCHEMATIC DESIGN**

| REVISIONS  |                         |      |  |
|------------|-------------------------|------|--|
| Revision # | Revision<br>Description | Date |  |
|            |                         |      |  |
|            |                         |      |  |
THIS DOCUMENT HAS BEEN DIGITALLY SIGNED AND SEALED BY EUGENE COLLINGS-BONFILL, PE, PSM, MBA, PMP, DBIA, ENV SP, CFM ON THE DATE ADJACENT

PRINTED COPIES OF THIS DOCUMENT ARE NOT CONSIDERED SIGNED AND SEALED. THE SIGNATURE MUST BE VERIFIED ON THE ELECTRONIC DOCUMENTS.

THIS DRAWINGS IS THE PROPERTY OF EXP U.S. SERVICES, INC. UNLESS OTHERWISE PROVIDED FOR BY CONTRACT, THE CONTENTS OF THIS DRAWINGS ARE CONFIDENTIAL AND SHALL NOT BE TRANSMITTED TO ANY OTHER PARTY EXCEPT AS AGREED TO BY THE ARCHITECT/ENGINEERS.

PROJ No.: DRAWN BY: APPR BY:

DESIGN TICKET NO: 077201638

Call 811 or visit sunshine811.com two full business days before digging to have

buried facilities located and marked.

Check positive response codes before you dig!


THE OFFICIAL RECORD OF THIS SHEET IS THE ELECTRONIC FILE DIGITALLY SIGNED AND SEALED UNDER RULE 61G15-23.004, F.A.C.


Sunshine U

8/18/2022 21010276-A0 RM

SHEET NUMBER:

#### **NW 82 AVENUE**

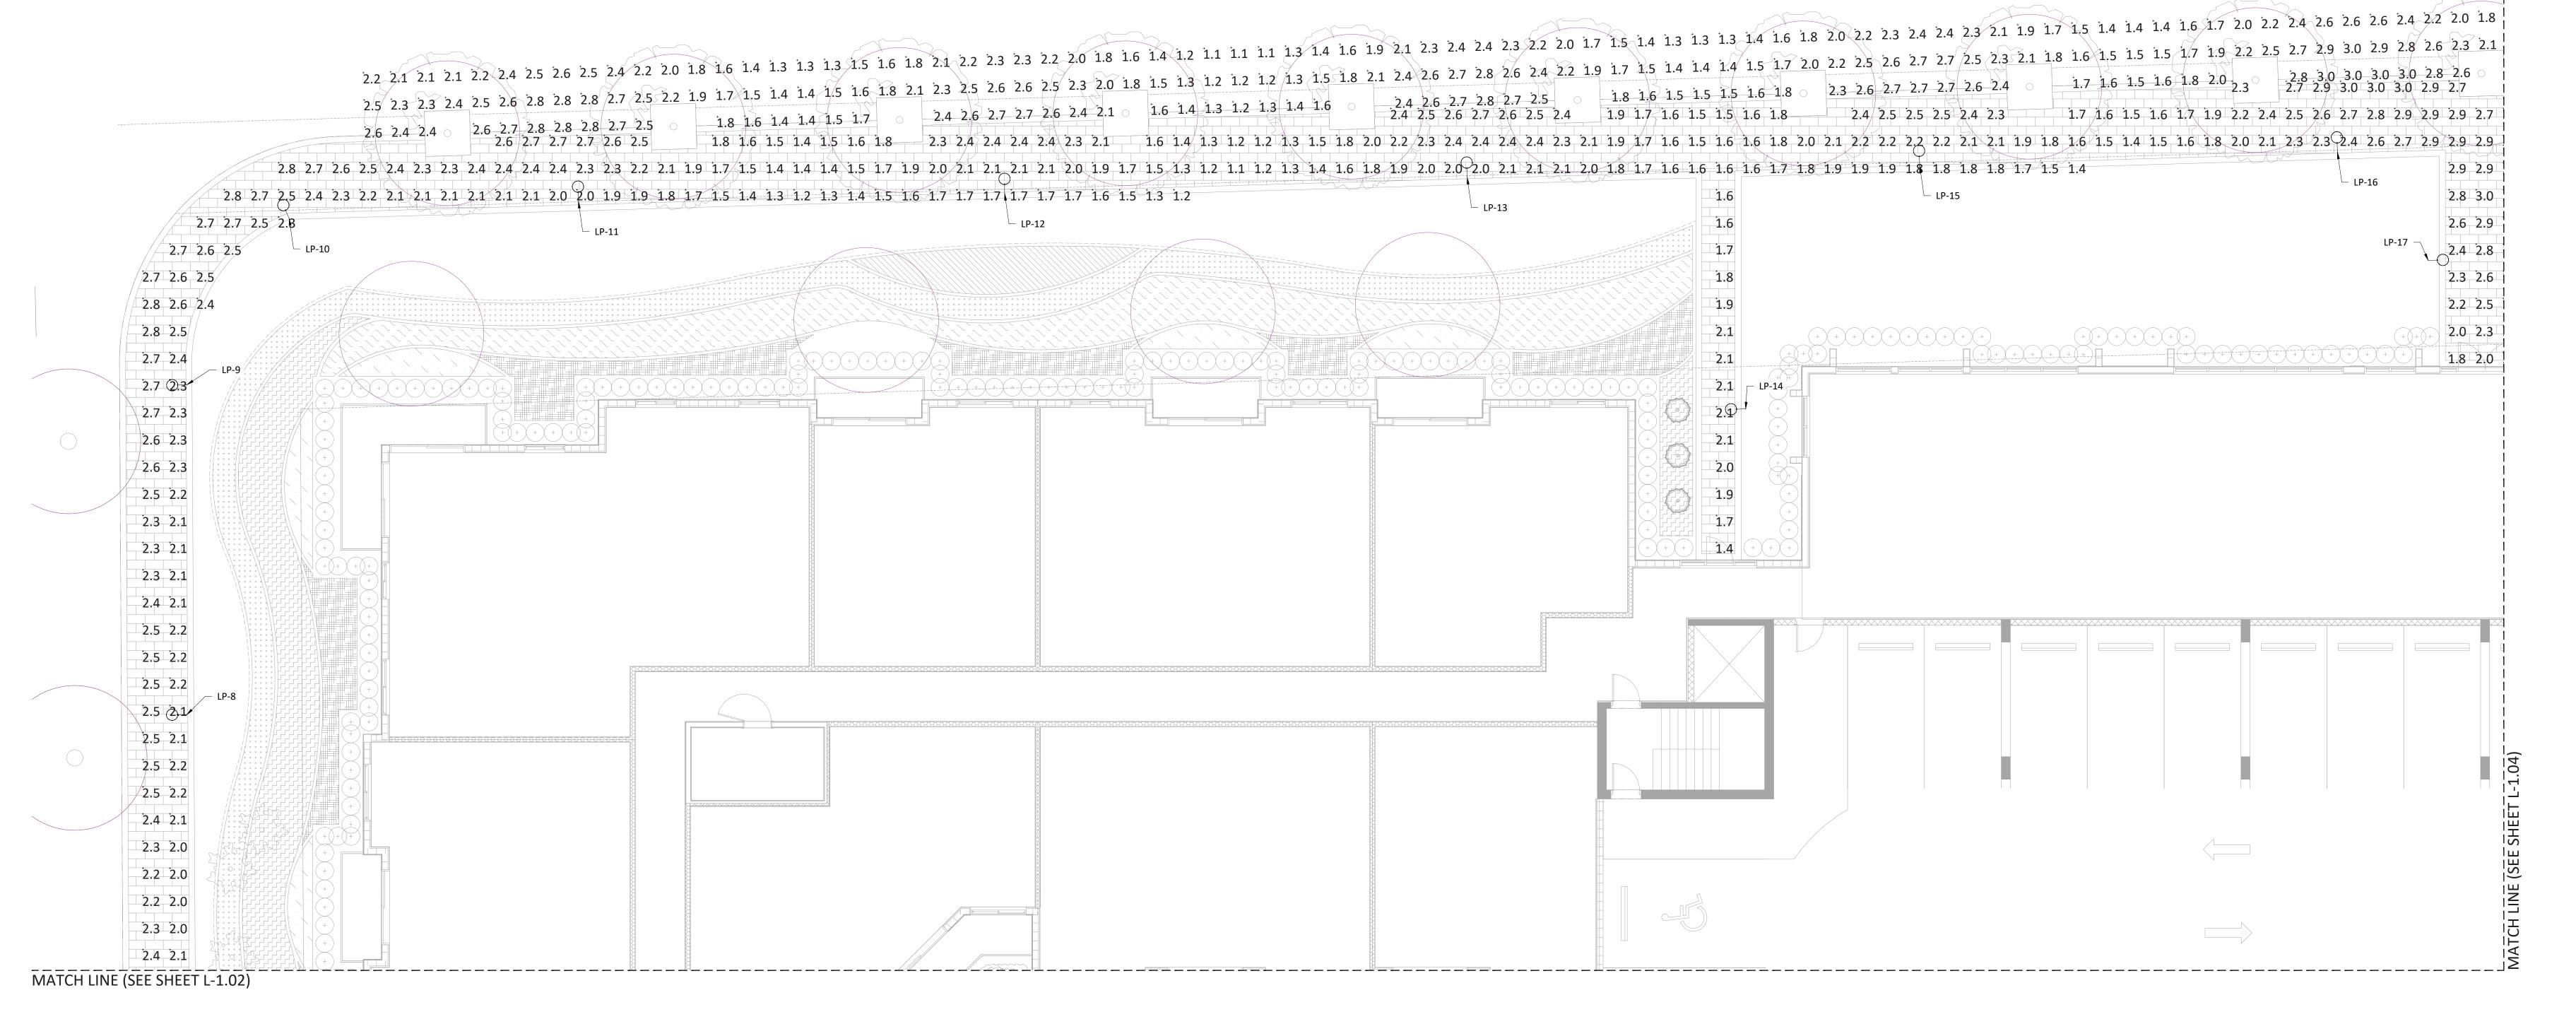

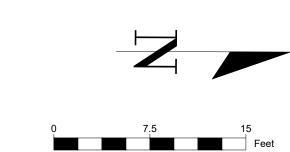

THE OFFICIAL RECORD OF THIS SHEET IS THE ELECTRONIC FILE DIGITALLY SIGNED AND SEALED UNDER RULE 61G15-23.004, F.A.C.

Call 811 or visit sunshine811.com two full business days before digging to have buried facilities located and marked.

Check positive response codes before you dig!

exp U.S. Services Inc.

t: +1.305.631.2208| f: +1.407.660.1655
201 Alhambra Circle, Suite 800
Coral Gables, FL 33134
U.S.A.

www.exp.com
Cert of Auth: 29701

• BUILDINGS • EARTH & ENVIRONMENT •
• ENERGY • INDUSTRIAL • INFRASTRUCTURE •
• SUSTAINABILITY •

PROJECT:

#### **LEGACY AT DORAL**

2525 NW 82ND AVENUE, DORAL, FL. 33122

OWNER:

TheEastonGroup

101 N.W. 19 ST.

MIAMI, FL 33172

TEL - (305) 593-2222

FAX - (305) 591-3863


www.theeastongroup.com

HTING PHOTOMETRIC DETAIL (2 OF 4)

PHASE:

### SCHEMATIC DESIGN

| Revision # | Revision<br>Description | Date |
|------------|-------------------------|------|
|            |                         |      |
|            |                         |      |
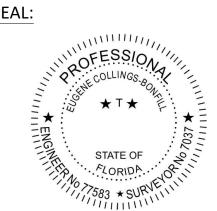

THIS DOCUMENT HAS BEEN DIGITALLY SIGNED AND SEALED BY EUGENE COLLINGS-BONFILL, PE, PSM, MBA, PMP, DBIA,ENV SP, CFM ON THE DATE ADJACENT TO THE SEAL.

PRINTED COPIES OF THIS DOCUMENT ARE NOT CONSIDERED SIGNED AND SEALED. THE SIGNATURE MUST BE VERIFIED ON THE ELECTRONIC DOCUMENTS.

THIS DRAWINGS IS THE PROPERTY OF EXP U.S. SERVICES, INC.
UNLESS OTHERWISE PROVIDED FOR BY CONTRACT, THE
CONTENTS OF THIS DRAWINGS ARE CONFIDENTIAL AND
SHALL NOT BE TRANSMITTED TO ANY OTHER PARTY
EXCEPT AS AGREED TO BY THE ARCHITECT/ENGINEERS.

 DATE:
 8/18/2022

 PROJ No.:
 21010276-A0

 DRAWN BY:
 ED


 APPR BY:
 RM

SHEET NUMBER:

L-1.03

#### **NW 82 AVENUE**

1.6 1.4 1.3 1.3 1.4 1.6 1.8 2.6 2.7 2.8 2.7 2.6 2.4 2.3 2.4 2.5 2.5 2.4 2.3 2.1 1.7 1.4 1.3 1.2 1.3 1.4 1.5 1.8 2.0 2.1 2.3 2.3 2.3 2.3 2.2 2.1 1.9 1.7 1.6 1.6 1.6 1.8 1.9 2.1 2.2 2.3 2.2 2.3 2.2 2.1 2.2 2.0 1.8 1.7 1.7 1.8 1.9 2.1 2.0 1.9 1.8 1.9 2.0 1.7 1.8 1.7 2.7 2.6 2.4 2.2 2.0 1.9 1.9 2.0 2.0 2.0 2.0 1.9 1.9 1.8 1.8 1.7 1.5 1.4 2.2 2.2 LP-20 1.6 1.7 1.6 2.0 2.1 1.6 1.7 1.7 2.0 2.1 1.6 1.7 1.8 1.8 2.0 2.0 2.2 2.1 2.3 1.9 2.2 2.1 2.4 2.0 2.3 2.0 2.3 19 2.3 1.9 2.2 1.9 2.2 2.2 2.5 1.8 1.9 1.6 1.7 1.5 1.6 1.0 1.1 1.6 1.8 1.6 1.9 1.6 1.9 1.9 2.2 1.8 2.1 2.0 2.4 1.9 2.3 1.9 2.2 1.8 2.1 1.9 2.0 1.8 1.9 1.7 1.8 1.6 1.8 1.5 1.7 1.7 1.8 1.7 2.0 1.8 2.0 MATCH LINE (SEE SHEET L-1.05)

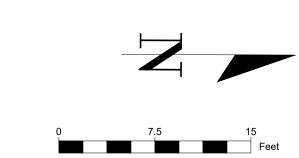

THE OFFICIAL RECORD OF THIS SHEET IS THE ELECTRONIC FILE DIGITALLY SIGNED AND SEALED UNDER RULE 61G15-23.004, F.A.C.



exp U.S. Services Inc.

t: +1.305.631.2208| f: +1.407.660.1655
201 Alhambra Circle, Suite 800
Coral Gables, FL 33134
U.S.A.

www.exp.com

• BUILDINGS • EARTH & ENVIRONMENT •
• ENERGY • INDUSTRIAL • INFRASTRUCTURE •
• SUSTAINABILITY •

PROJECT:

#### **LEGACY AT DORAL**

2525 NW 82ND AVENUE, DORAL, FL. 33122

OWNER:

TheEastonGroup

101 N.W. 19 ST.

MIAMI, FL 33172

TEL - (305) 593-2222


FAX - (305) 591-3863

www.theeastongroup.com

SHTING PHOTOMETRIC DETAIL (3 OF 4)

PHASE:

## SCHEMATIC DESIGN

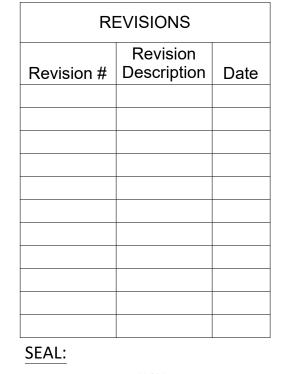



THIS DOCUMENT HAS BEEN DIGITALLY SIGNED AND SEALED BY EUGENE COLLINGS-BONFILL, PE, PSM, MBA, PMP, DBIA,ENV SP, CFM ON THE DATE ADJACENT TO THE SEAL.

PRINTED COPIES OF THIS DOCUMENT ARE NOT CONSIDERED SIGNED AND SEALED.
THE SIGNATURE MUST BE VERIFIED ON THE ELECTRONIC DOCUMENTS.


THIS DRAWINGS IS THE PROPERTY OF EXP U.S. SERVICES, INC.
UNLESS OTHERWISE PROVIDED FOR BY CONTRACT, THE
CONTENTS OF THIS DRAWINGS ARE CONFIDENTIAL AND
SHALL NOT BE TRANSMITTED TO ANY OTHER PARTY
EXCEPT AS AGREED TO BY THE ARCHITECT/ENGINEERS.

DATE:
PROJ No.:
DRAWN BY:
APPR BY:

**8/18/2022** 21010276-A0 **ED RM** 

SHEET NUMBER:

L-1.04

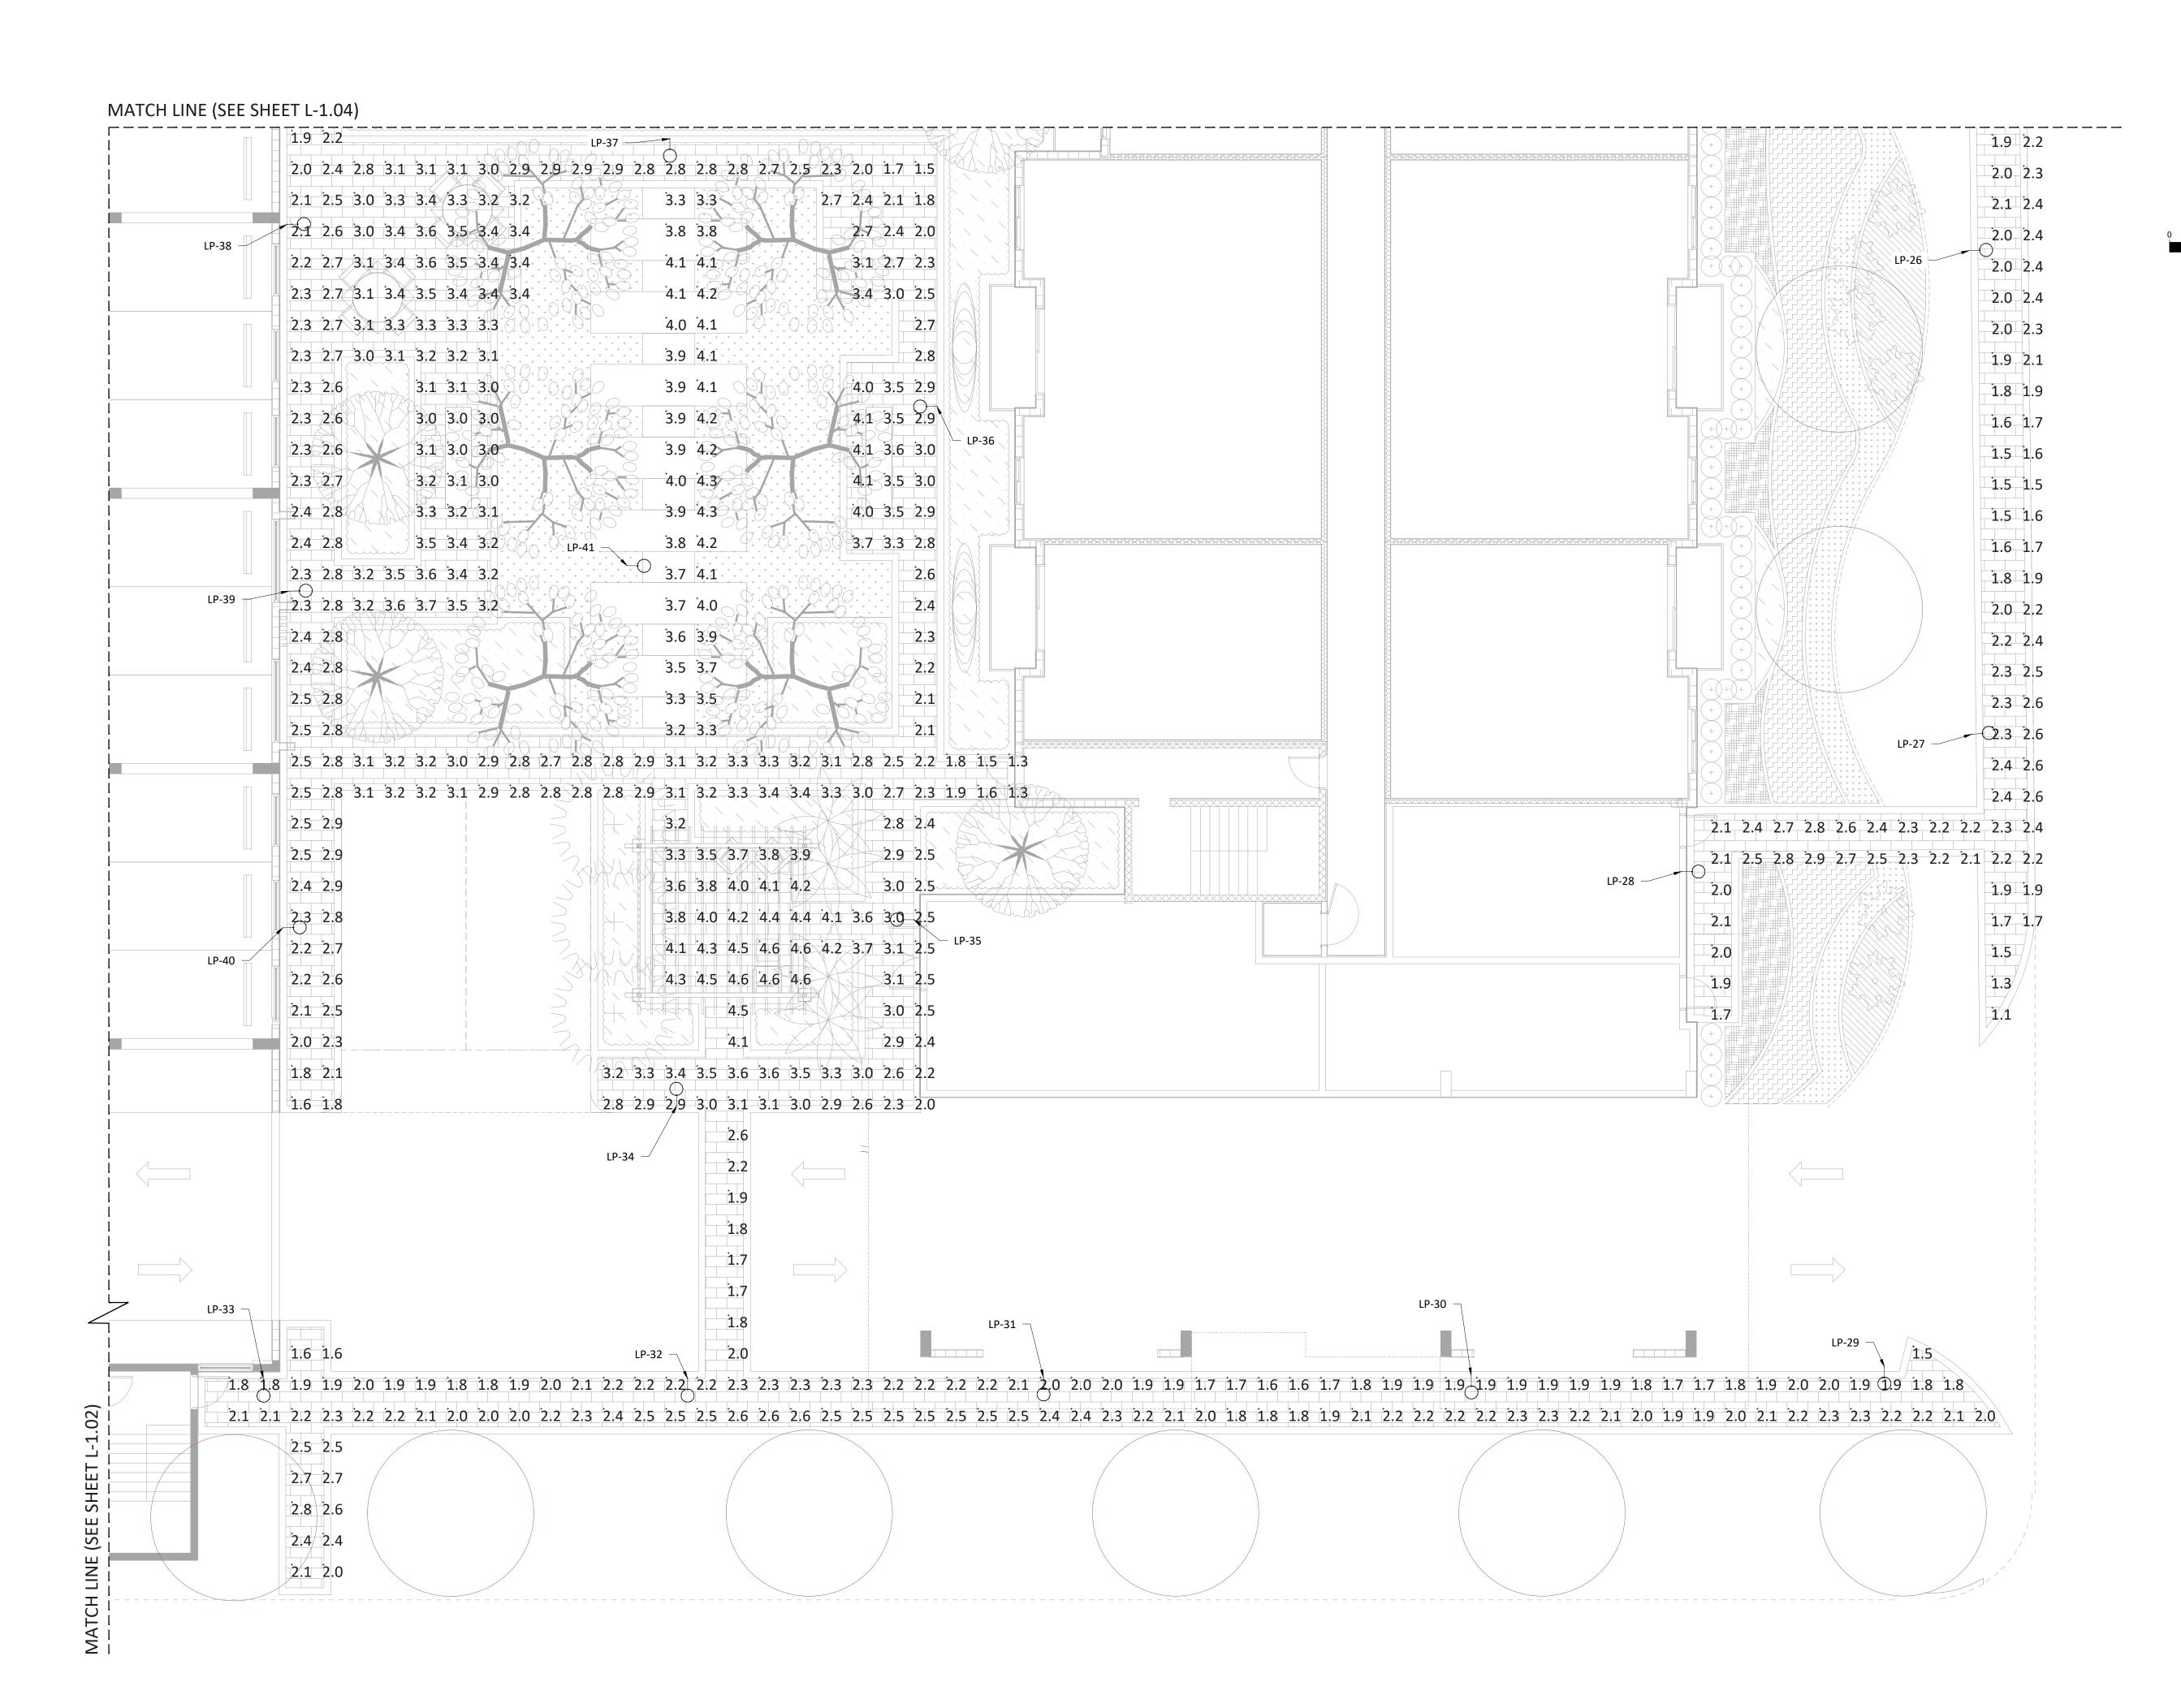

exp U.S. Services Inc.
t: +1.305.631.2208| f: +1.407.660.1655
201 Alhambra Circle, Suite 800
Coral Gables, FL 33134
U.S.A.
www.exp.com

J.S.A.

www.exp.com

Cert of Auth: 29701

BUILDINGS • EARTH & ENVIRONMENT •
 ENERGY • INDUSTRIAL • INFRASTRUCTURE •
 SUSTAINABILITY •

PROJECT:

#### **LEGACY AT DORAL**

2525 NW 82ND AVENUE, DORAL, FL. 33122

OWNER:

# The East on Group

101 N.W. 19 ST.
MIAMI, FL 33172
TEL - (305) 593-2222
FAX - (305) 591-3863
www.theeastongroup.com

IGHTING PHOTOMETRIC DETAIL (4 OF 4)

PHASE:

# SCHEMATIC DESIGN

| REVISIONS  |                         |      |
|------------|-------------------------|------|
| Revision # | Revision<br>Description | Date |
|            |                         |      |
|            |                         |      |
SE



THIS DOCUMENT HAS BEEN DIGITALLY SIGNED AND SEALED BY EUGENE COLLINGS-BONFILL, PE, PSM, MBA, PMP, DBIA,ENV SP, CFM ON THE DATE ADJACENT TO THE SEAL.

PRINTED COPIES OF THIS DOCUMENT ARE NOT CONSIDERED SIGNED AND SEALED. THE SIGNATURE MUST BE VERIFIED ON THE ELECTRONIC DOCUMENTS.

THIS DRAWINGS IS THE PROPERTY OF EXP U.S. SERVICES, INC.
UNLESS OTHERWISE PROVIDED FOR BY CONTRACT, THE
CONTENTS OF THIS DRAWINGS ARE CONFIDENTIAL AND
SHALL NOT BE TRANSMITTED TO ANY OTHER PARTY
EXCEPT AS AGREED TO BY THE ARCHITECT/ENGINEERS.

DATE:
PROJ No.:
DRAWN BY:
APPR BY:

8/18/2022 21010276-A0 ED RM

SHEET NUMBER:

I\_1 OS

Call 811 or visit sunshine811.com two full business days before digging to have buried facilities located and marked.

THE OFFICIAL RECORD OF THIS SHEET IS THE ELECTRONIC FILE DIGITALLY SIGNED AND SEALED UNDER RULE 61G15-23.004, F.A.C.

DESIGN TICKET NO: 077201638

Check positive response codes before you dig!