RESOLUTION No. 17-100

A RESOLUTION OF THE MAYOR AND THE CITY COUNCIL OF THE CITY OF DORAL, FLORIDA, APPROVING THE SITE PLAN FOR DORAL GLADES PARK, LOCATED AT 9775 NW 74 STREET, DORAL, FLORIDA 33178; PROVIDING FOR IMPLEMENTATION; AND PROVIDING FOR AN EFFECTIVE DATE

WHEREAS, On November 2, 2016, the City of Doral (the "City") adopted Ordinance No. 2016-29 amending the City's Land Development Code to establish procedures for the Mayor and City Council site plan review and approval process;

WHEREAS, the City, by and through the Parks and Recreation Department, has submitted an application for Mayor and Council site plan review and approval for Doral Glades Park, located east of the Doral Commons development, west of NW 97th Avenue, and south of an existing undeveloped site, as legally described in Exhibit "A" ("Glades Park"); and

WHEREAS, staff recommend approval of the proposed site plan provided in Exhibit "B" (the "Site Plan"); and

WHEREAS, the Site Plan is consistent with the previously approved conceptual site plan for Glades Park and all the requirements and standards set forth in Section 53-184 (3) of the Land Development Code.

WHEREAS, pursuant to law, notice has been given by publication in a paper of general circulation in the City, notifying the public of this proposed Resolution and of the public hearings; and

WHEREAS, the Mayor and City Council of the City of Doral finds that the adoption and implementation of this Resolution is in the best interest and welfare of the residents of the City.

Res. No. 17-100 Page **2** of **3**

NOW THEREFORE, BE IT RESOLVED BY THE MAYOR AND CITY COUNCIL
OF THE CITY OF DORAL, FLORIDA, THAT:

Section 1. Recital. The above recitals are confirmed, adopted, and incorporated herein and made a part hereof by this reference.

Section 2. Approval of Site Plan. The Site Plan for Glades Park, which contains an existing 12.5 acre retention lake and 3.36 acre wetlands preserve, a multi-purpose field, two tennis courts, one beach sand volleyball court, playground area, two basketball courts, rental pavilions, and a 9,000 square feet nature center, is hereby approved. This Site Plan approval is subject to the City meeting all of the conditions set forth in the development approval, attached hereto as Exhibit "C", which is incorporated herein and made a part hereof by this reference.

<u>Section 3.</u> <u>Implementation.</u> The City Manager and the City Attorney are hereby authorized to take such further action as may be necessary to implement the purpose and provisions of this Resolution.

<u>Section 4.</u> <u>Effective Date.</u> This Resolution shall become effective upon its passage and adoption by the City Council and is binding on all successors and assigns.

Res. No. 17-100 Page **3** of **3**

The foregoing Resolution was offered by Councilmember Rodriguez who moved its adoption. The motion was seconded by Councilmember Mariaca and upon being put to a vote, the vote was as follows:

Mayor Juan Carlos Bermudez Absent/Excused

Vice Mayor Pete Cabrera Yes

Councilwoman Christi Fraga Not Present at Time of the Vote

Councilwoman Claudia Mariaca Yes Councilwoman Ana Maria Rodriguez Yes

PASSED AND ADOPTED this 24 day of May, 2017.

JUAN CARLØS BERMUDEZ, MAYOF

ATTEST:

CONNIE DIAZ, CMC

CITY CLERK

APPROVED AS TO FORM AND LEGAL SUFFIENCY FOR THE USE AND RELIANCE OF THE CITY OF DORAL ONLY:


WEISS, SEROTA, HELFMAN, COLE & BIERMAN, P.L.


CITY ATTORNEY

LEGAL DESCRIPTION:


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TIE INTO EXISTING _ JOGGERS PATH

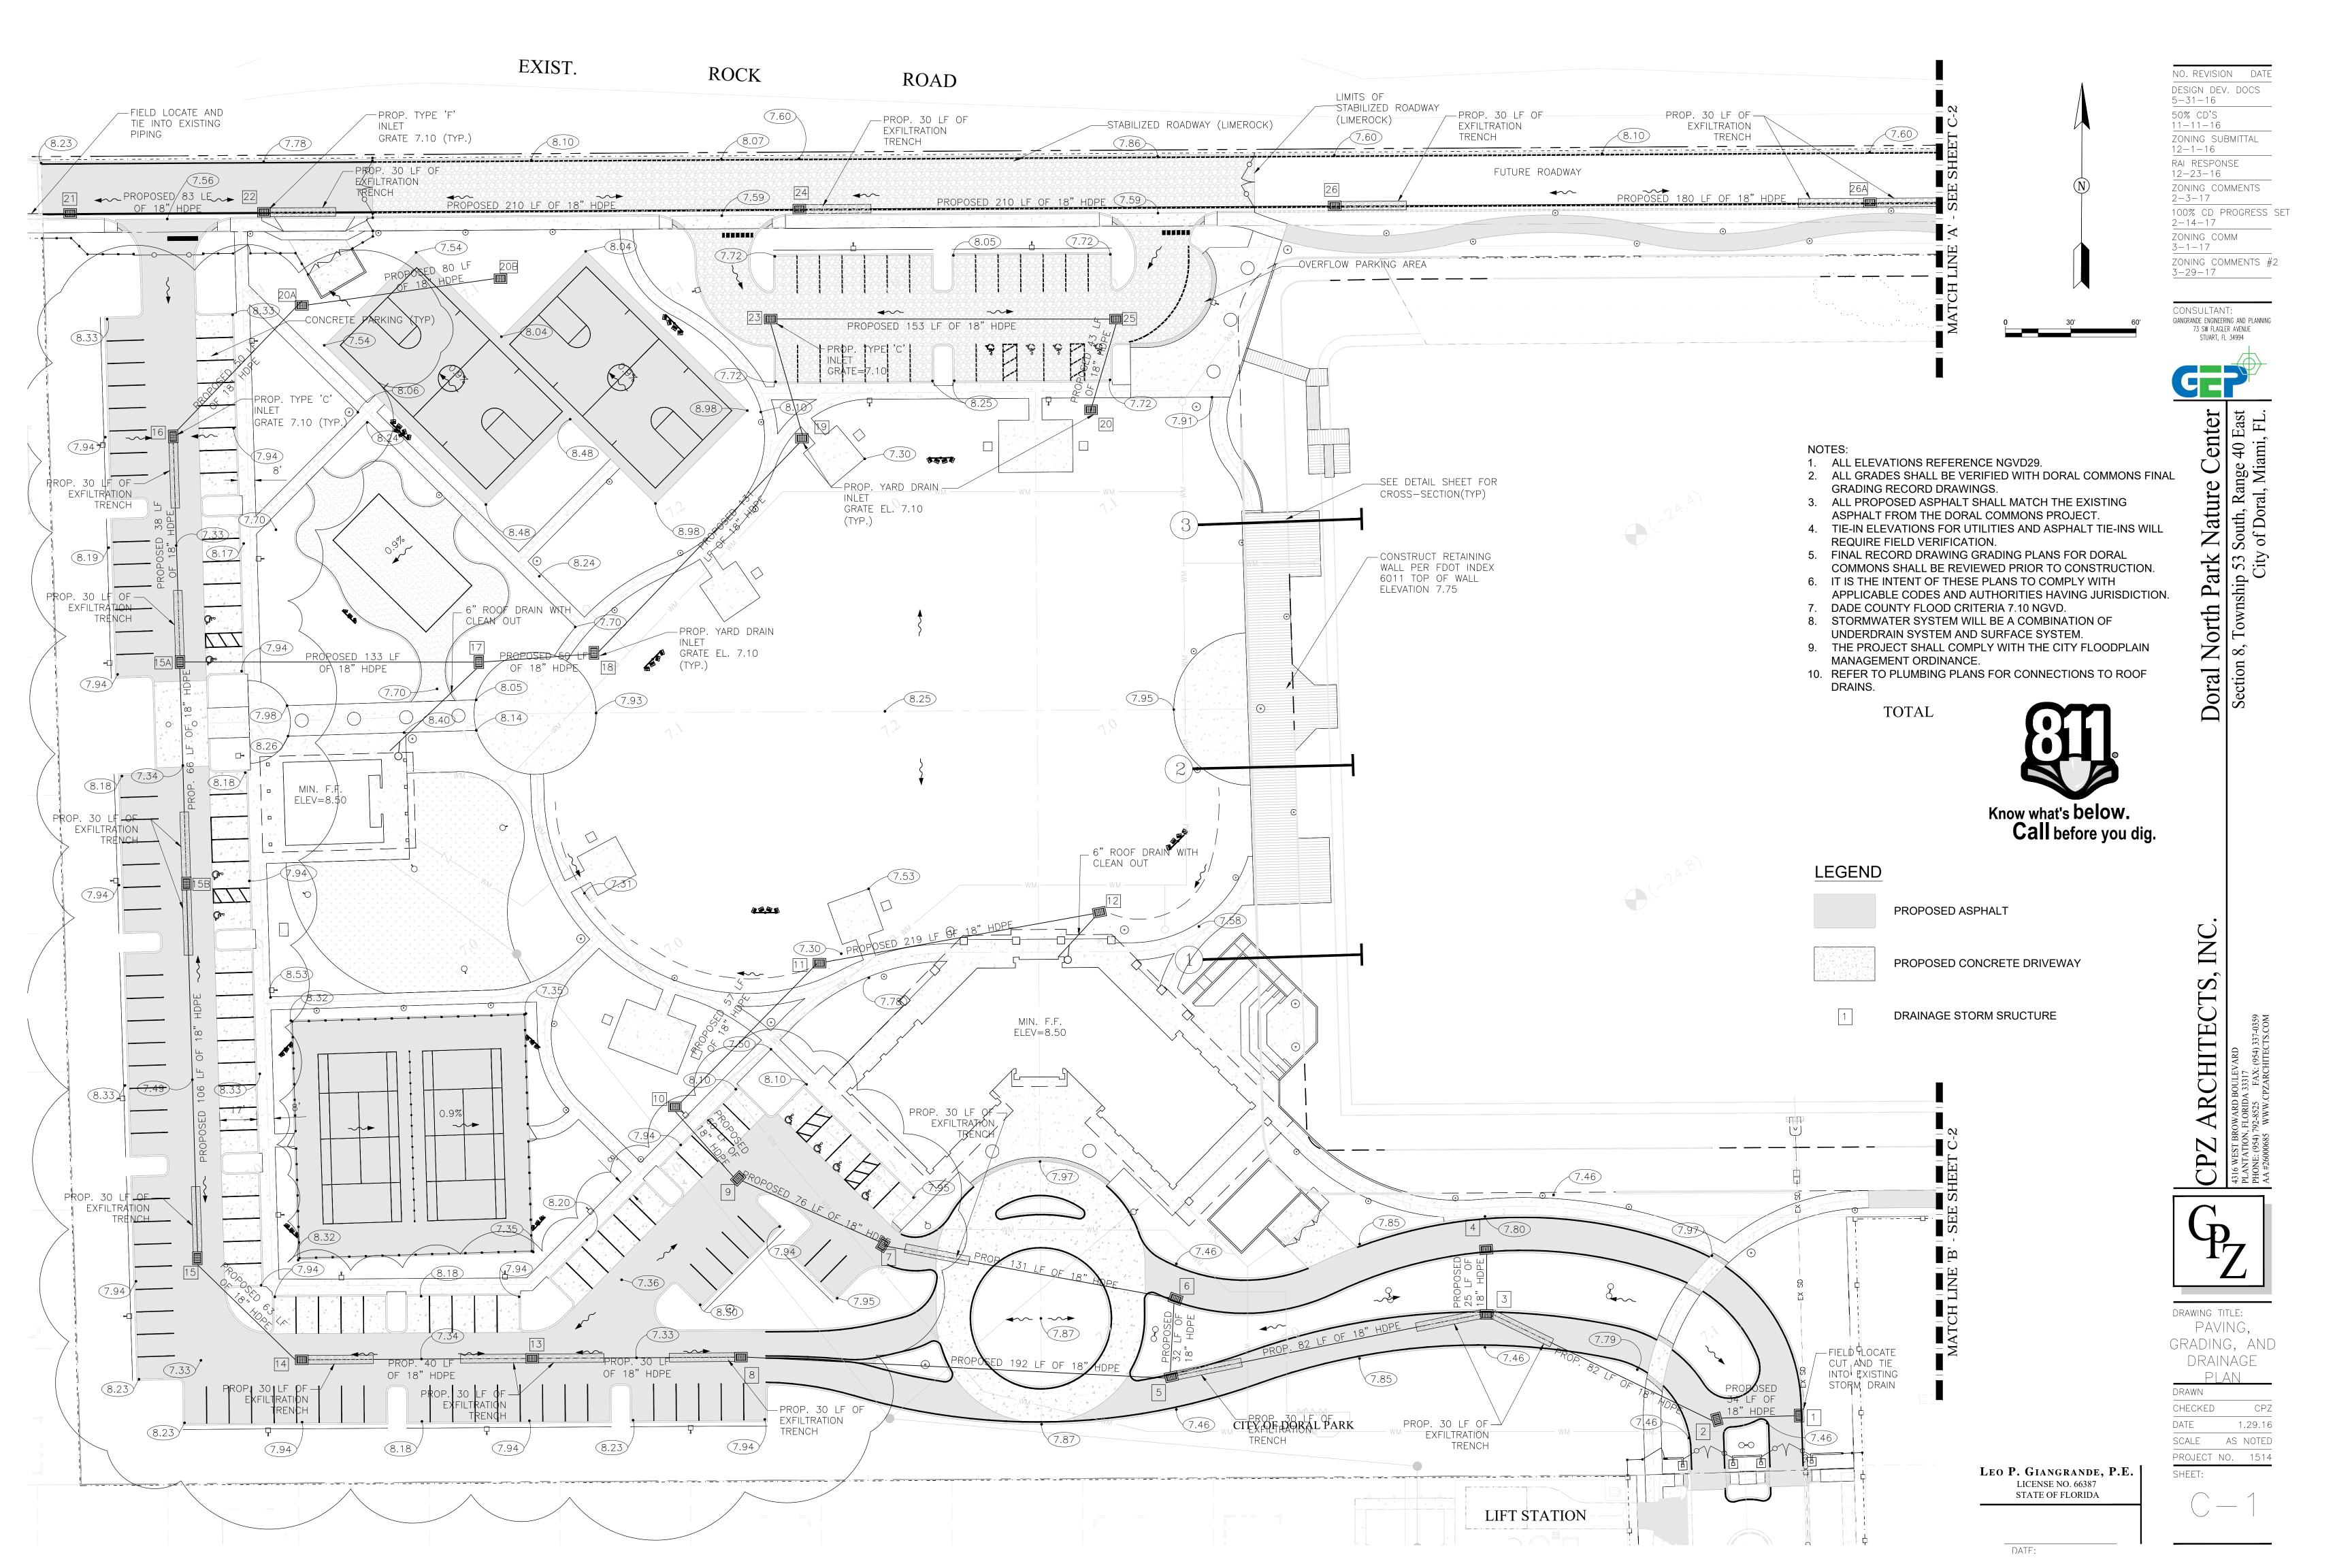

DESIGN DEV. DOCS 5-31-16 50% CD'S 11-11-16 ZONING SUBMITTAL 12-1-16 RAI RESPONSE 12-23-16 ZONING COMMENTS 2 - 3 - 17100% CD PROGRESS SET 2 - 14 - 17ZONING COMM 3-1-17 ZONING COMMENTS #2 3-29-17

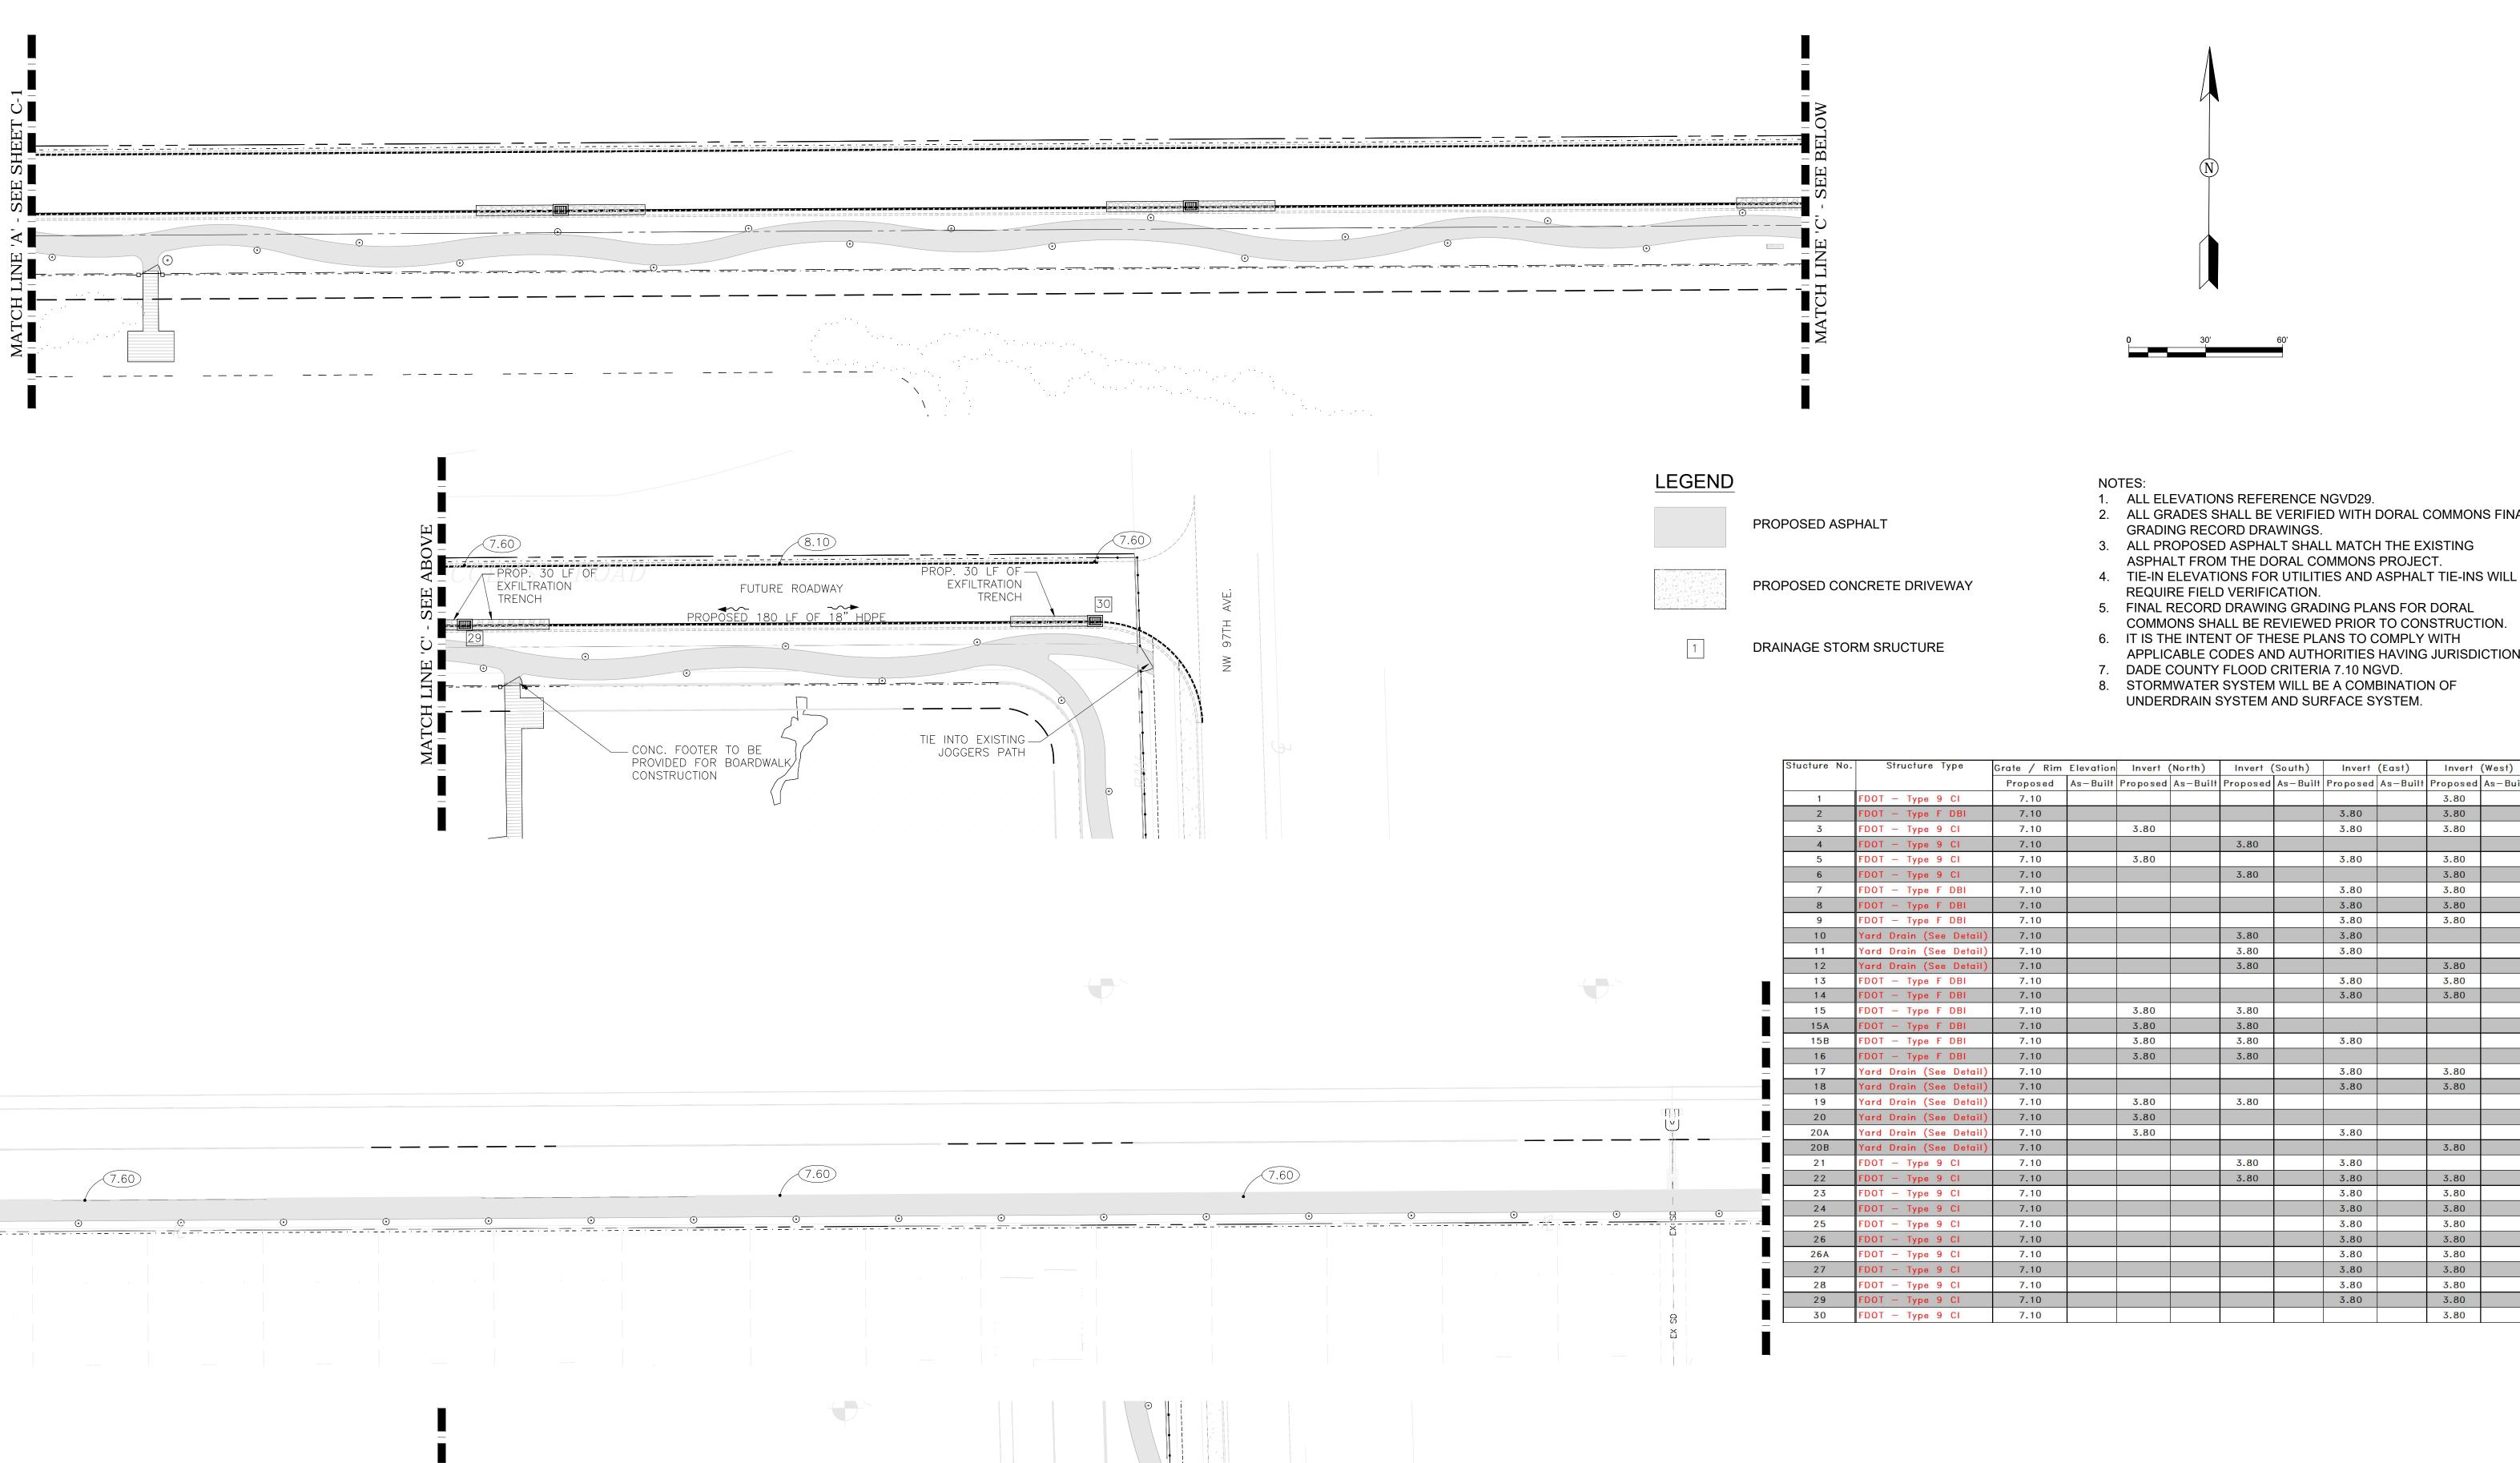NO. REVISION DATE

CONSULTANT: GIANGRANDE ENGINEERING AND PLANNING 73 SW FLAGLER AVENUE STUART, FL 34994

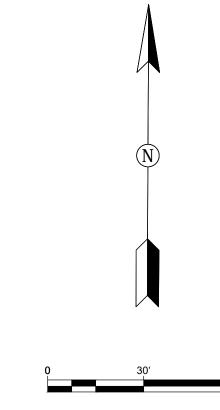Doral | Section

NOTES:

1. ALL ELEVATIONS REFERENCE NGVD29.

2. ALL GRADES SHALL BE VERIFIED WITH DORAL COMMONS FINAL GRADING RECORD DRAWINGS.

3. ALL PROPOSED ASPHALT SHALL MATCH THE EXISTING ASPHALT FROM THE DORAL COMMONS PROJECT.

4. TIE-IN ELEVATIONS FOR UTILITIES AND ASPHALT TIE-INS WILL REQUIRE FIELD VERIFICATION.

5. FINAL RECORD DRAWING GRADING PLANS FOR DORAL COMMONS SHALL BE REVIEWED PRIOR TO CONSTRUCTION.

6. IT IS THE INTENT OF THESE PLANS TO COMPLY WITH

APPLICABLE CODES AND AUTHORITIES HAVING JURISDICTION.

7. DADE COUNTY FLOOD CRITERIA 7.10 NGVD. 8. STORMWATER SYSTEM WILL BE A COMBINATION OF

UNDERDRAIN SYSTEM AND SURFACE SYSTEM.


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			Proposed	As-Built	Proposed	As-Built	Proposed	As-Built	Proposed	As-Built	Proposed	As-Built
	1	FDOT - Type 9 CI	7.10								3.80	
	2	FDOT - Type F DBI	7.10						3.80		3.80	
	3	FDOT - Type 9 CI	7.10		3.80				3.80		3.80	
	4	FDOT - Type 9 CI	7.10				3.80					
	5	FDOT - Type 9 CI	7.10		3.80				3.80		3.80	
	6	FDOT - Type 9 CI	7.10				3.80				3.80	
	7	FDOT - Type F DBI	7.10						3.80		3.80	
	8	FDOT - Type F DBI	7.10						3.80		3.80	
	9	FDOT - Type F DBI	7.10						3.80		3.80	
	10	Yard Drain (See Detail)	7.10				3.80		3.80			
	11	Yard Drain (See Detail)	7.10				3.80		3.80			
	12	Yard Drain (See Detail)	7.10				3.80				3.80	
	13	FDOT - Type F DBI	7.10						3.80		3.80	
	1.4	FDOT - Type F DBI	7.10						3.80		3.80	
	15	FDOT - Type F DBI	7.10		3.80		3.80					
	15A	FDOT - Type F DBI	7.10		3.80		3.80					
_	15B	FDOT - Type F DBI	7.10		3.80		3.80		3.80			
	16	FDOT - Type F DBI	7.10		3.80		3.80					
_	17	Yard Drain (See Detail)	7.10						3.80		3.80	
	18	Yard Drain (See Detail)	7.10						3.80		3.80	
	19	Yard Drain (See Detail)	7.10		3.80		3.80					
	20	Yard Drain (See Detail)	7.10		3.80							
	20A	Yard Drain (See Detail)	7.10		3.80				3.80			
	20B	Yard Drain (See Detail)	7.10								3.80	
	21	FDOT - Type 9 CI	7.10				3.80		3.80			
	22	FDOT - Type 9 CI	7.10				3.80		3.80		3.80	
	23	FDOT - Type 9 CI	7.10						3.80		3.80	
	24	FDOT - Type 9 CI	7.10						3.80		3.80	
	25	FDOT - Type 9 CI	7.10						3.80		3.80	
	26	FDOT - Type 9 CI	7.10						3.80		3.80	
	26A	FDOT - Type 9 CI	7.10						3.80		3.80	
	27	FDOT - Type 9 CI	7.10						3.80		3.80	
	28	FDOT - Type 9 CI	7.10						3.80		3.80	
	29	FDOT - Type 9 CI	7.10						3.80		3.80	

DRAWING TITLE: PAVING,

LEO P. GIANGRANDE, P.E. LICENSE NO. 66387 STATE OF FLORIDA

Know what's below.
Call before you dig.

DATE:

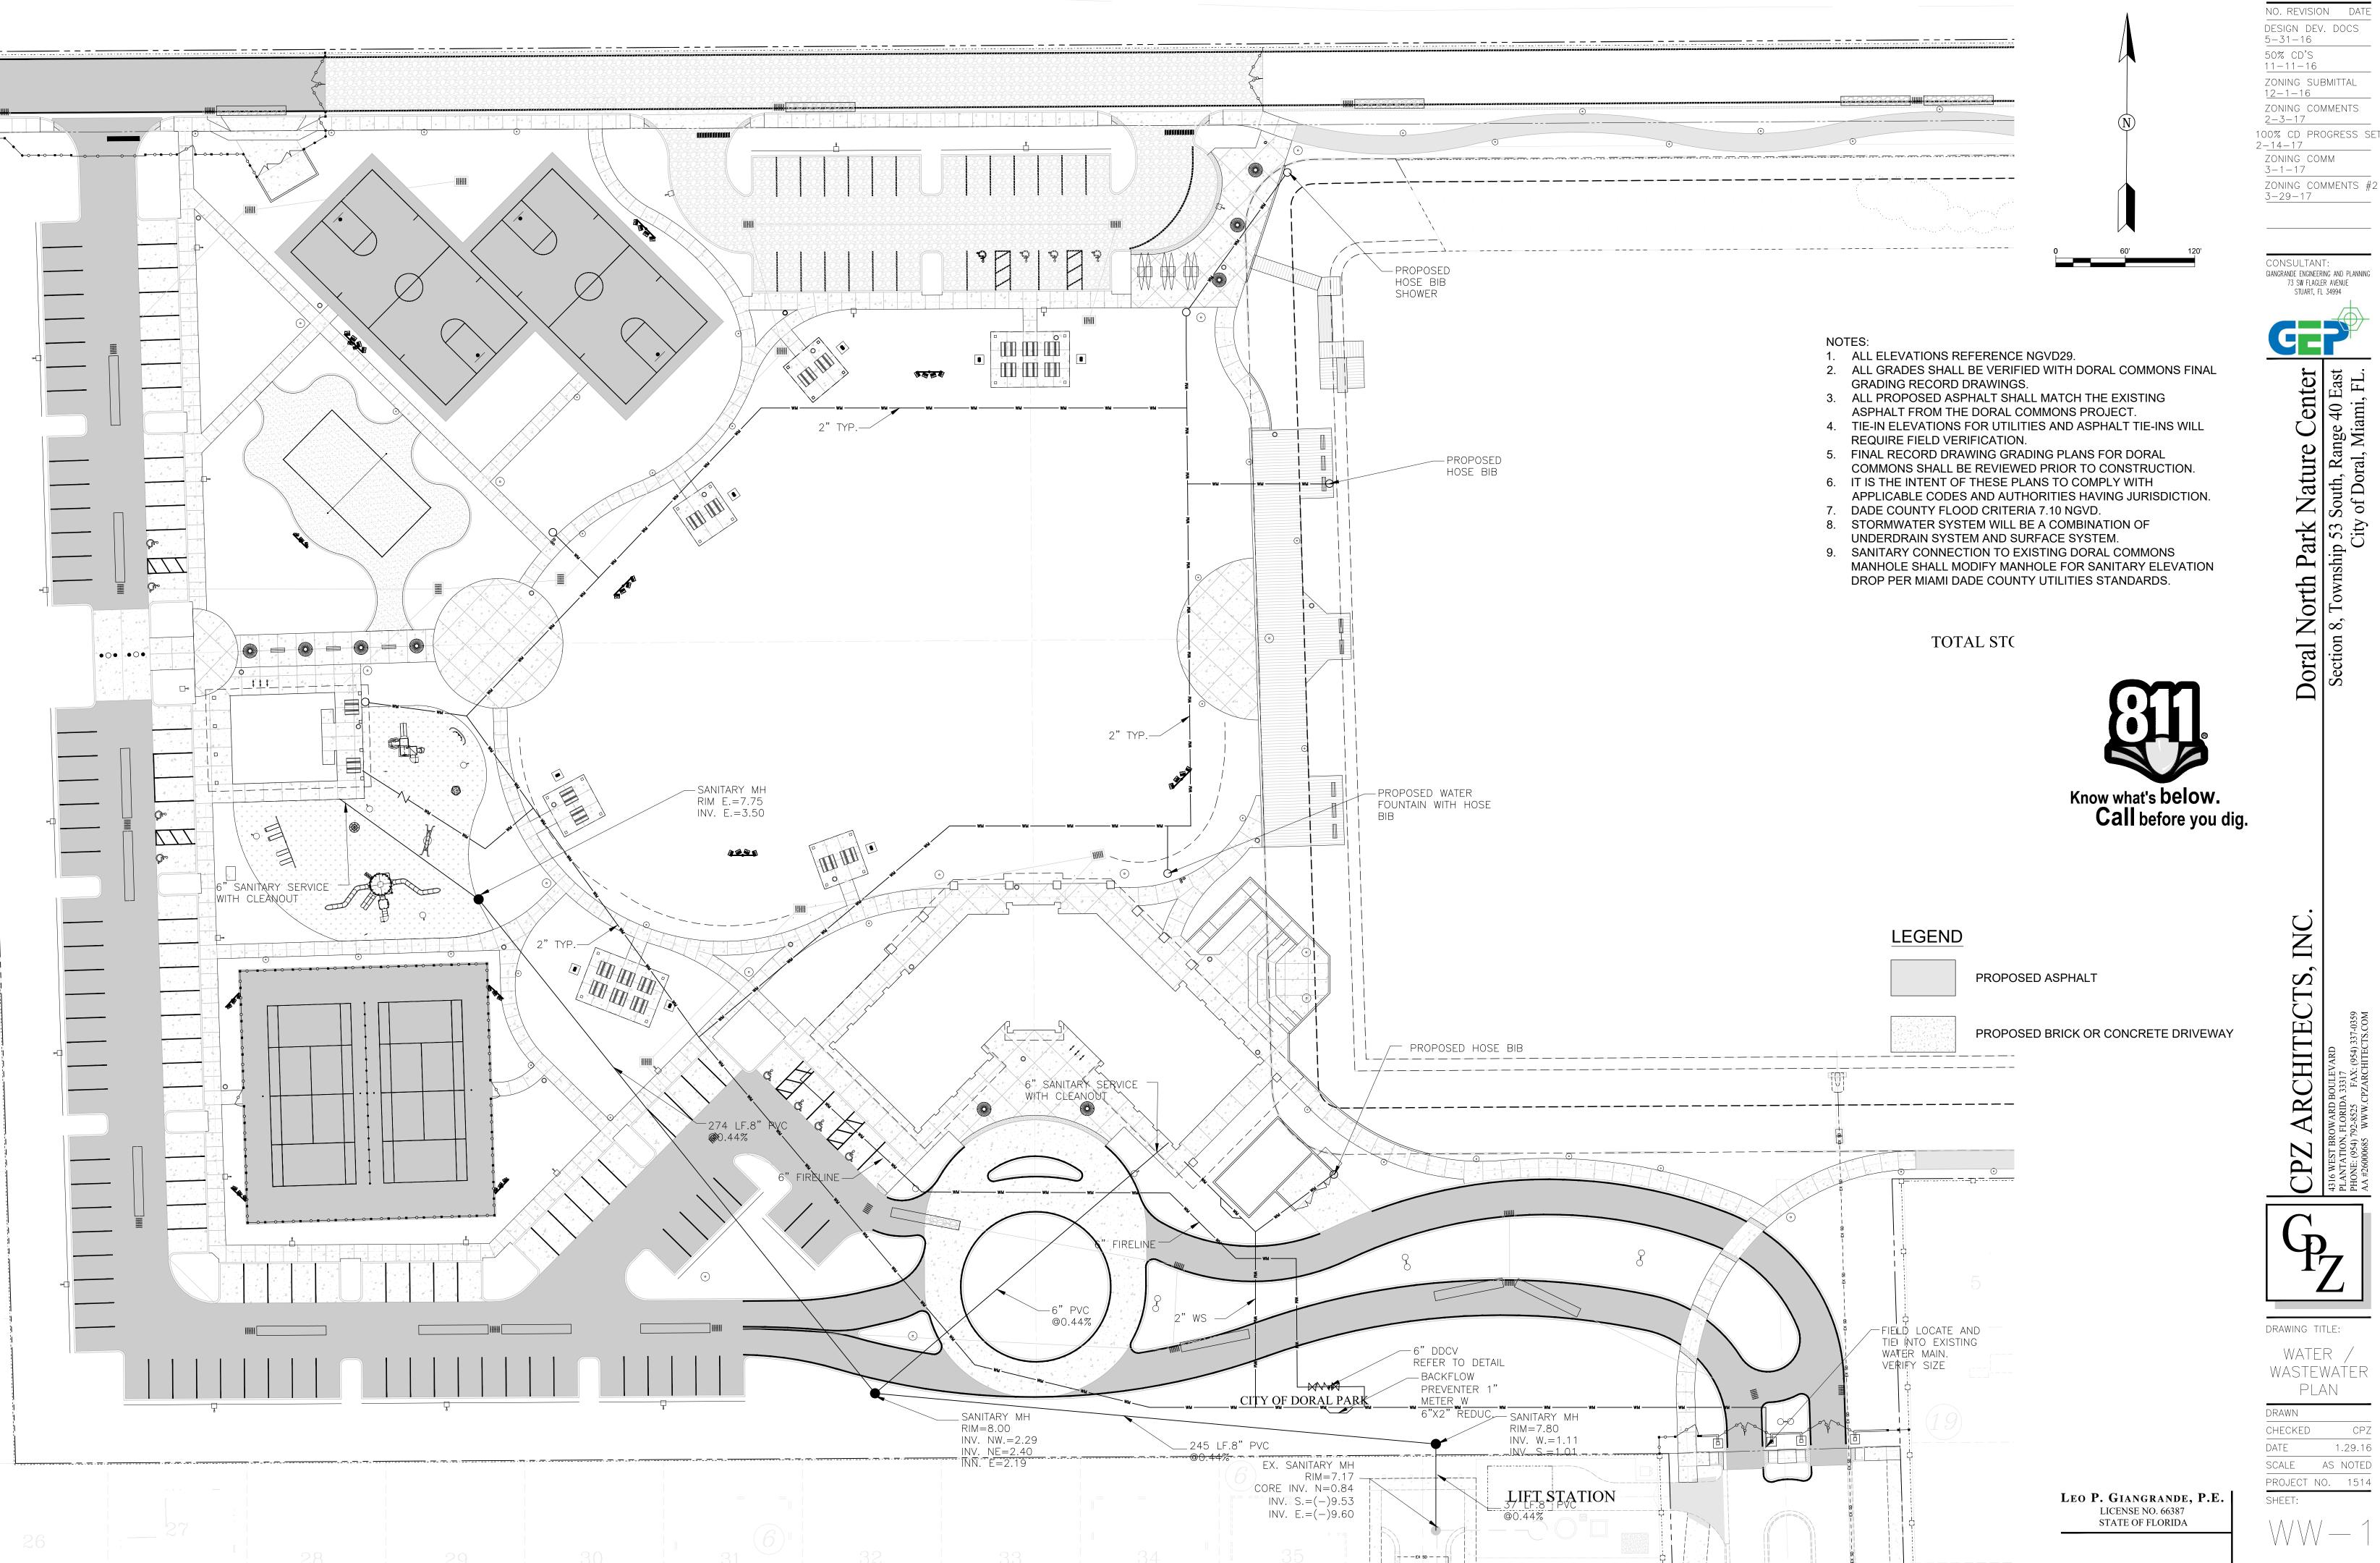

NO. REVISION DATE DESIGN DEV. DOCS 5-31-16

50% CD'S 11-11-16 ZONING SUBMITTAL

12-1-16 ZONING COMMENTS

100% CD PROGRESS SET 2-<u>14-17</u> ZONING COMM

3-29-17

CONSULTANT: GIANGRANDE ENGINEERING AND PLANNING 73 SW FLAGLER AVENUE STUART, FL 34994

enter

DRAWING TITLE:

CHECKED 1.29.16

PROJECT NO. 1514

DEWATERING

CONSTRUCTION DEWATERING MAY REQUIRE A SHORT OR LONG - TERM DEWATERING PERMIT FROM THE SFWMD. IF DEWATERING IS TO TAKE PLACE THE CONTRACTOR SHALL BE RESPONSIBLE FOR OBTAINING A DEWATERING PERMIT FOR HIS WORK.

RECORD DRAWINGS


AFTER COMPLETION OF THE CONTRACT WORK, BUT PRIOR TO SUBMITTAL OF THE REQUEST FOR FINAL PAYMENT, THE CONTRACTOR SHALL PROVIDE FINAL RECORD DRAWINGS TO THE OWNER OF THE IMPROVEMENTS. THE RECORD DRAWINGS SHALL BE PREPARED IN ACCORDANCE WITH THE REQUIREMENTS OF CITY OF STUART, AND SHALL INCLUDE, BUT NOT BE LIMITED TO THE FOLLOWING:


THE FINAL LOCATION, BY REFERENCE TO AT LEAST TWO COMPLETED VISIBLE IMPROVEMENTS OR OTHER PERMANENT POINTS, OF ALL ROAD AND DRAINAGE ELEMENTS, AND SHALL INCLUDE ELEVATIONS OF PERTINENT POINTS IN THE PAVEMENT AND DRAINAGE IMPROVEMENTS, ALL REVISIONS TO THE ORIGINAL PLANS, VERIFICATION OF ALL DESIGN DIMENSIONS AND ELEVATIONS, LOCATION AND ELEVATIONS AND ALL OTHER INFORMATION NECESSARY TO HORIZONTALLY AND VERTICALLY LOCATE AND OPERATE THE IMPROVEMENTS CONSTRUCTED UNDER THIS CONTRACT.

DRAWINGS SHALL INCLUDE:

- ANY CHANGES OR VERIFICATIONS GET MARKED
- MARK OUT ALL "PROPOSED" OR "CONSTRUCTS"
- DRAW IN A DETAIL BOX OF ANY SUBSTANTIAL CHANGES

THE CONTRACTOR SHALL PROVIDE FIVE SETS OF RECORD DRAWING PRINTS, ONE ELECTRONIC SET ON CD (PDF OR DWG) AND ONE COPY OF CERTIFIED FIELD NOTES TO THE OWNER THAT ARE SIGNED AND SEALED BY A FLORIDA REGISTERED LAND SURVEYOR.

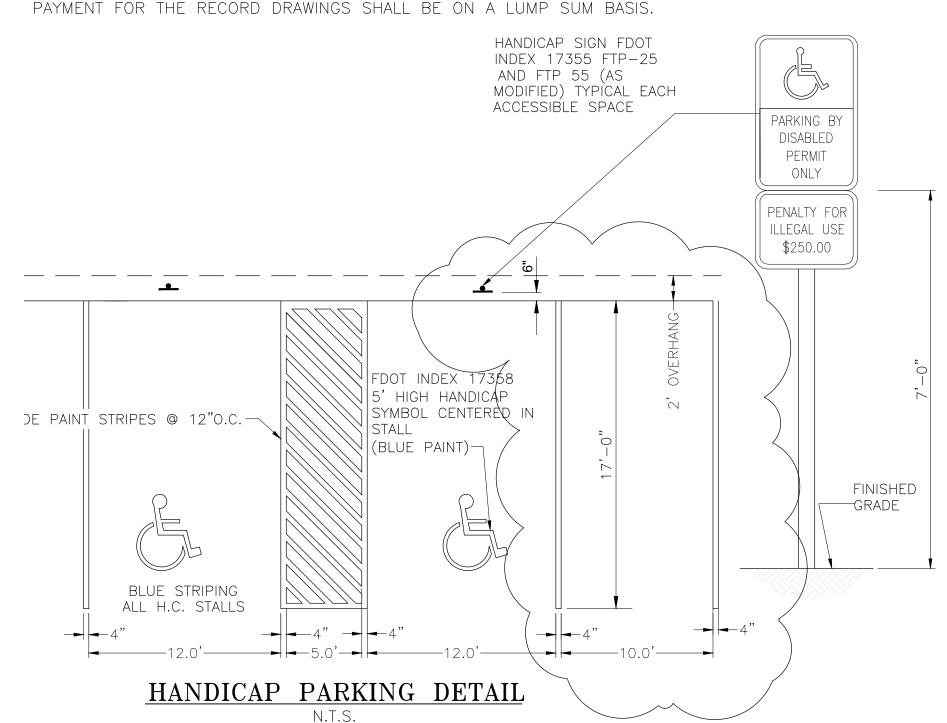

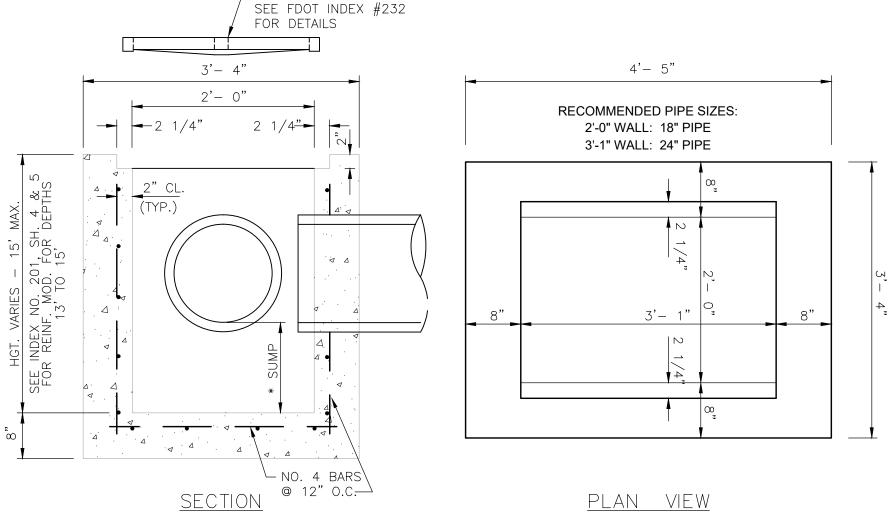


GRATE (SEE NOTE 5)OR -CAST IRON GRATE


TYPE 'C' INLET FDOT INDEX NO. 232 (NTS)


INLET NOTES:


DETAILS.

- 1. REFER TO FDOT STANDARD INDEX NO. 200, 201 AND 232 FOR ADDITIONAL AND SUPPLEMENTARY
- 2. STRUCTURES MAY BE CAST IN PLACE OR PRE CAST WITH CLASS I (MIN 3000 psi) CONCRETE PER FDOT SECTION 425. CONCRETE AS SPECIFIED BY ASTM C-478 (MIN 4000 psi) MAY BE USED IN PRE CAST ITEMS MANUFACTURED IN PLANTS AS SPECIFIED IN FDOT STANDARD INDEX NO. 201.
- 3. R.C.P. SHALL BE REINFORCED CONCRETE PIPE CONFORMING TO F.D.O.T. SEC. 941.
- 4. PLACE SOD 4' ON ALL SIDES OF INLET IN GREEN AREAS UNLESS OTHERWISE NOTED.
- 5. USE USF GRATE #6212 AND FRAME #4160 FOR PAVEMENT AREAS. USE ÜSF GRATE #6210 FOR GRASSED AREAS.
- 6. ALL INLET GRATES SHALL BE COVERED WITH FILTER FABRIC DURING CONSTRUCTION.
- * AT INLETS INDICATED WITH SUMP, SEE PLANS.

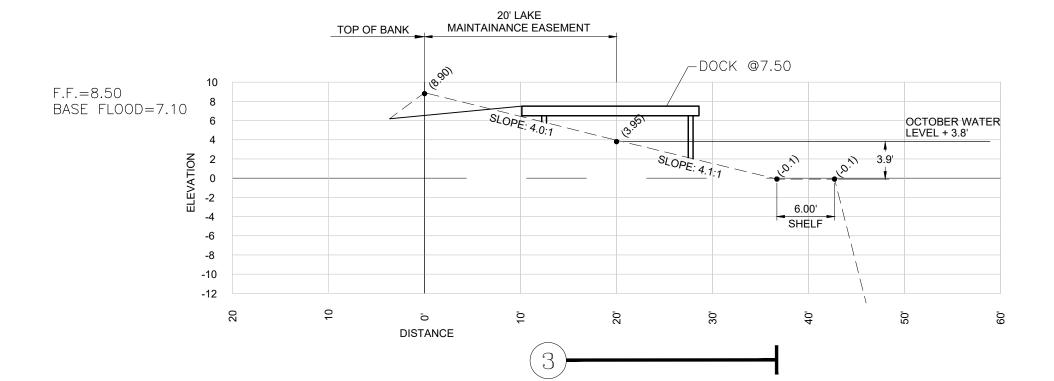

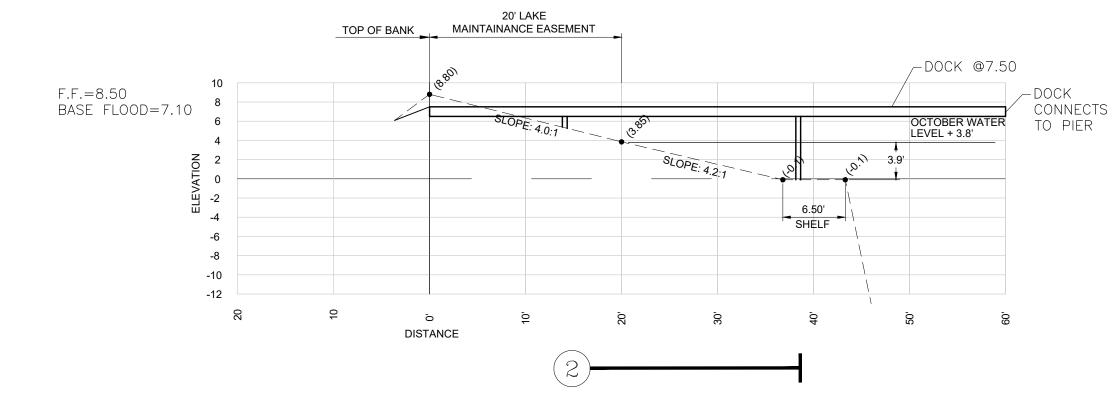

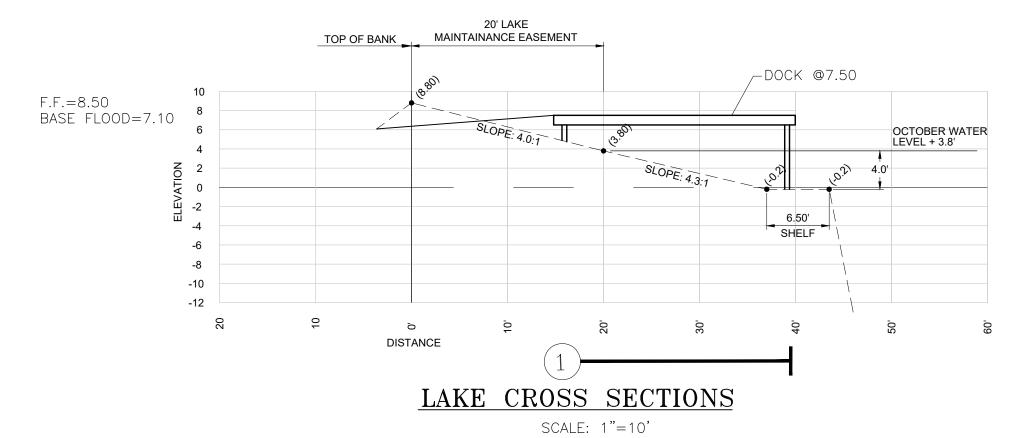

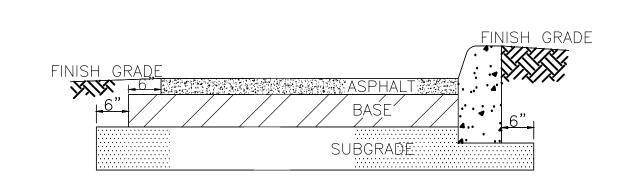


ASPHALT CONCRETE PAVEMENT: 1 1/2" FDOT TYPE SP-9.5 (SURFACE) (NOT PROVIDED ON STABILIZED SECTIONS)

BASE: 6" COMPACTED LIMEROCK OR COQUINA BASE (LBR-100) SAME


N.T.S.

DENSITY AS SUBGRADE

SUBGRADE: 12" THICK COMPACTED SUBGRADE (LBR-40) DENSITY SHALL BE

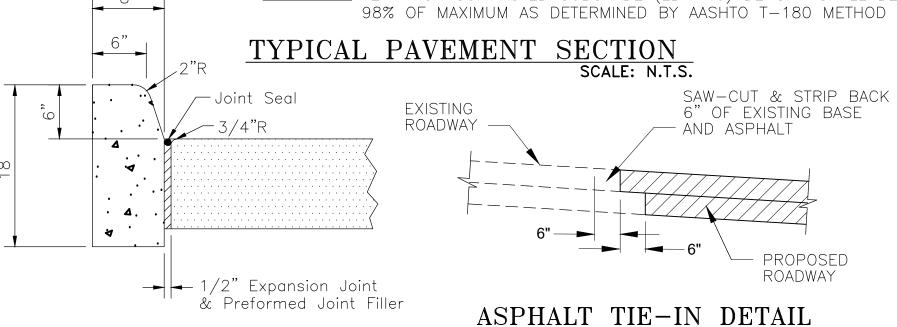

TYPE 'D' CURB DETAIL

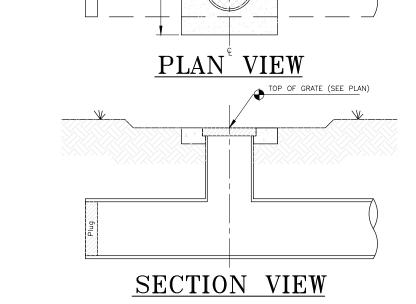

STAKE-OUT REFERENCE PER SUMMARY OF DRAINAGE

STRUCTURES SHEET

FDOT INDEX 282 YARD DRAIN


1/4"R-(Typ.) --3/16" Saw Cut Joint 1/2" Pre-molded Maybe Substituted Expansion Joint Material

EXPANSION JOINTS CONTRACTION JOINTS Sod Per Plan VARIES REFER TO PLAN -3000psi Class 12" Concrete Slope to - 3/4" Chamfer Slope per Plan Natural Grade ♦ REFER TO PLAN 2" Chamfer

SIDEWALK ADJACENT TO PAVEMENT

— Stabilize Subgrade to a

Minimum FBV of 60 P.S.I.

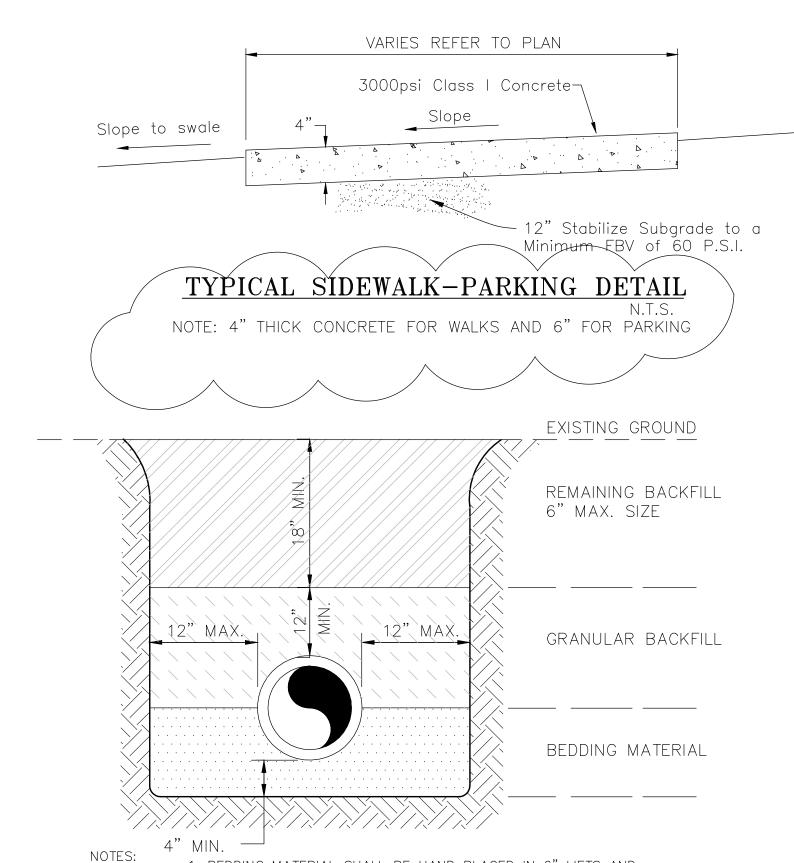

1. BEDDING MATERIAL SHALL BE HAND PLACED IN 6" LIFTS AND SHALL CONSIST OF IN-SITU GRANULAR MATERIAL OR WASHED AND GRADED LIMEROCK 3/8"-7/8" SIZING. UNSUITABLE IN-SITU MATERIALS SUCH AS MUCK, DEBRIS AND LARGER ROCK SHALL BE REMOVED.

- 2. THE PIPE SHALL BE FULLY SUPPORTED FOR ITS ENTIRE LENGTH WITH APPROPRIATE COMPACTION UNDER THE PIPE HAUNCHES.
- 3. THE PIPE SHALL BE PLACED IN A DRY TRENCH.
- 4. BACKFILL SHALL BE DONE WITH APPROVED MATERIAL, CLEAN AND FREE OF ROCKS, MUCK AND OTHER DELETERIOUS MATTER, AND COMPACTED BENEATH THE HAUNCHES OF THE PIPE USING MECHANICAL TAMPERS TO 100% MAXIMUM DENSITY AS DETERMINED BY AASHTO T-99.
- 5. BACKFILL TO BE COMPACTED ALONG THE SIDES OF THE PIPE AND TO A POINT ONE FOOT ABOVE THE TOP OF THE PIPE TO 100% MAXIMUM DENSITY AS DETERMINED BY AASHTO T-99.
- 6. A.) WHERE PAVEMENT IS TO BE CONSTRUCTED OVER THE PIPE, THE REMAINING BACKFILL SHALL BE COMPACTED IN 6 INCH LAYERS TO 98% OF THE MAXIMUM DENSITY AS DETERMINED BY AASHTO T-180.
- B.) WHERE NO PAVEMENT IS TO BE CONSTRUCTED OVER THE PIPE, THE REMAINING BACKFILL SHALL BE COMPACTED IN 6 INCH LAYERS TO 95% OF THE MAXIMUM DENSITY AS DETERMINED BY AASHTO T-180.

N.T.S.

7. THE CONTRACTOR SHALL COMPLY WITH ALL STATE AND LOCAL TRENCH SAFETY REGULATIONS

TYPICAL TRENCH DETAIL

LEO P. GIANGRANDE, P.E. LICENSE NO. 66387 STATE OF FLORIDA

NO. REVISION DATE DESIGN DEV. DOCS 5-31-16 50% CD'S 11-11-16

ZONING SUBMITTAL 12-1-16 ZONING COMMENTS 2-3-17

100% CD PROGRESS SET 2 - 14 - 17ZONING COMM 3 - 1 - 17

3-28-17

ZONING COMMENTS #2

CONSULTANT: GIANGRANDE ENGINEERING AND PLANNING 73 SW FLAGLER AVENUE STUART, FL 34994

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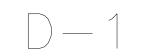
Doral North Park
Section 8, Township 53


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DRAWING TITLE:


DETAILS

DRAWN CHECKED DATE 1.29.16 SCALE AS NOTED PROJECT NO. 1514





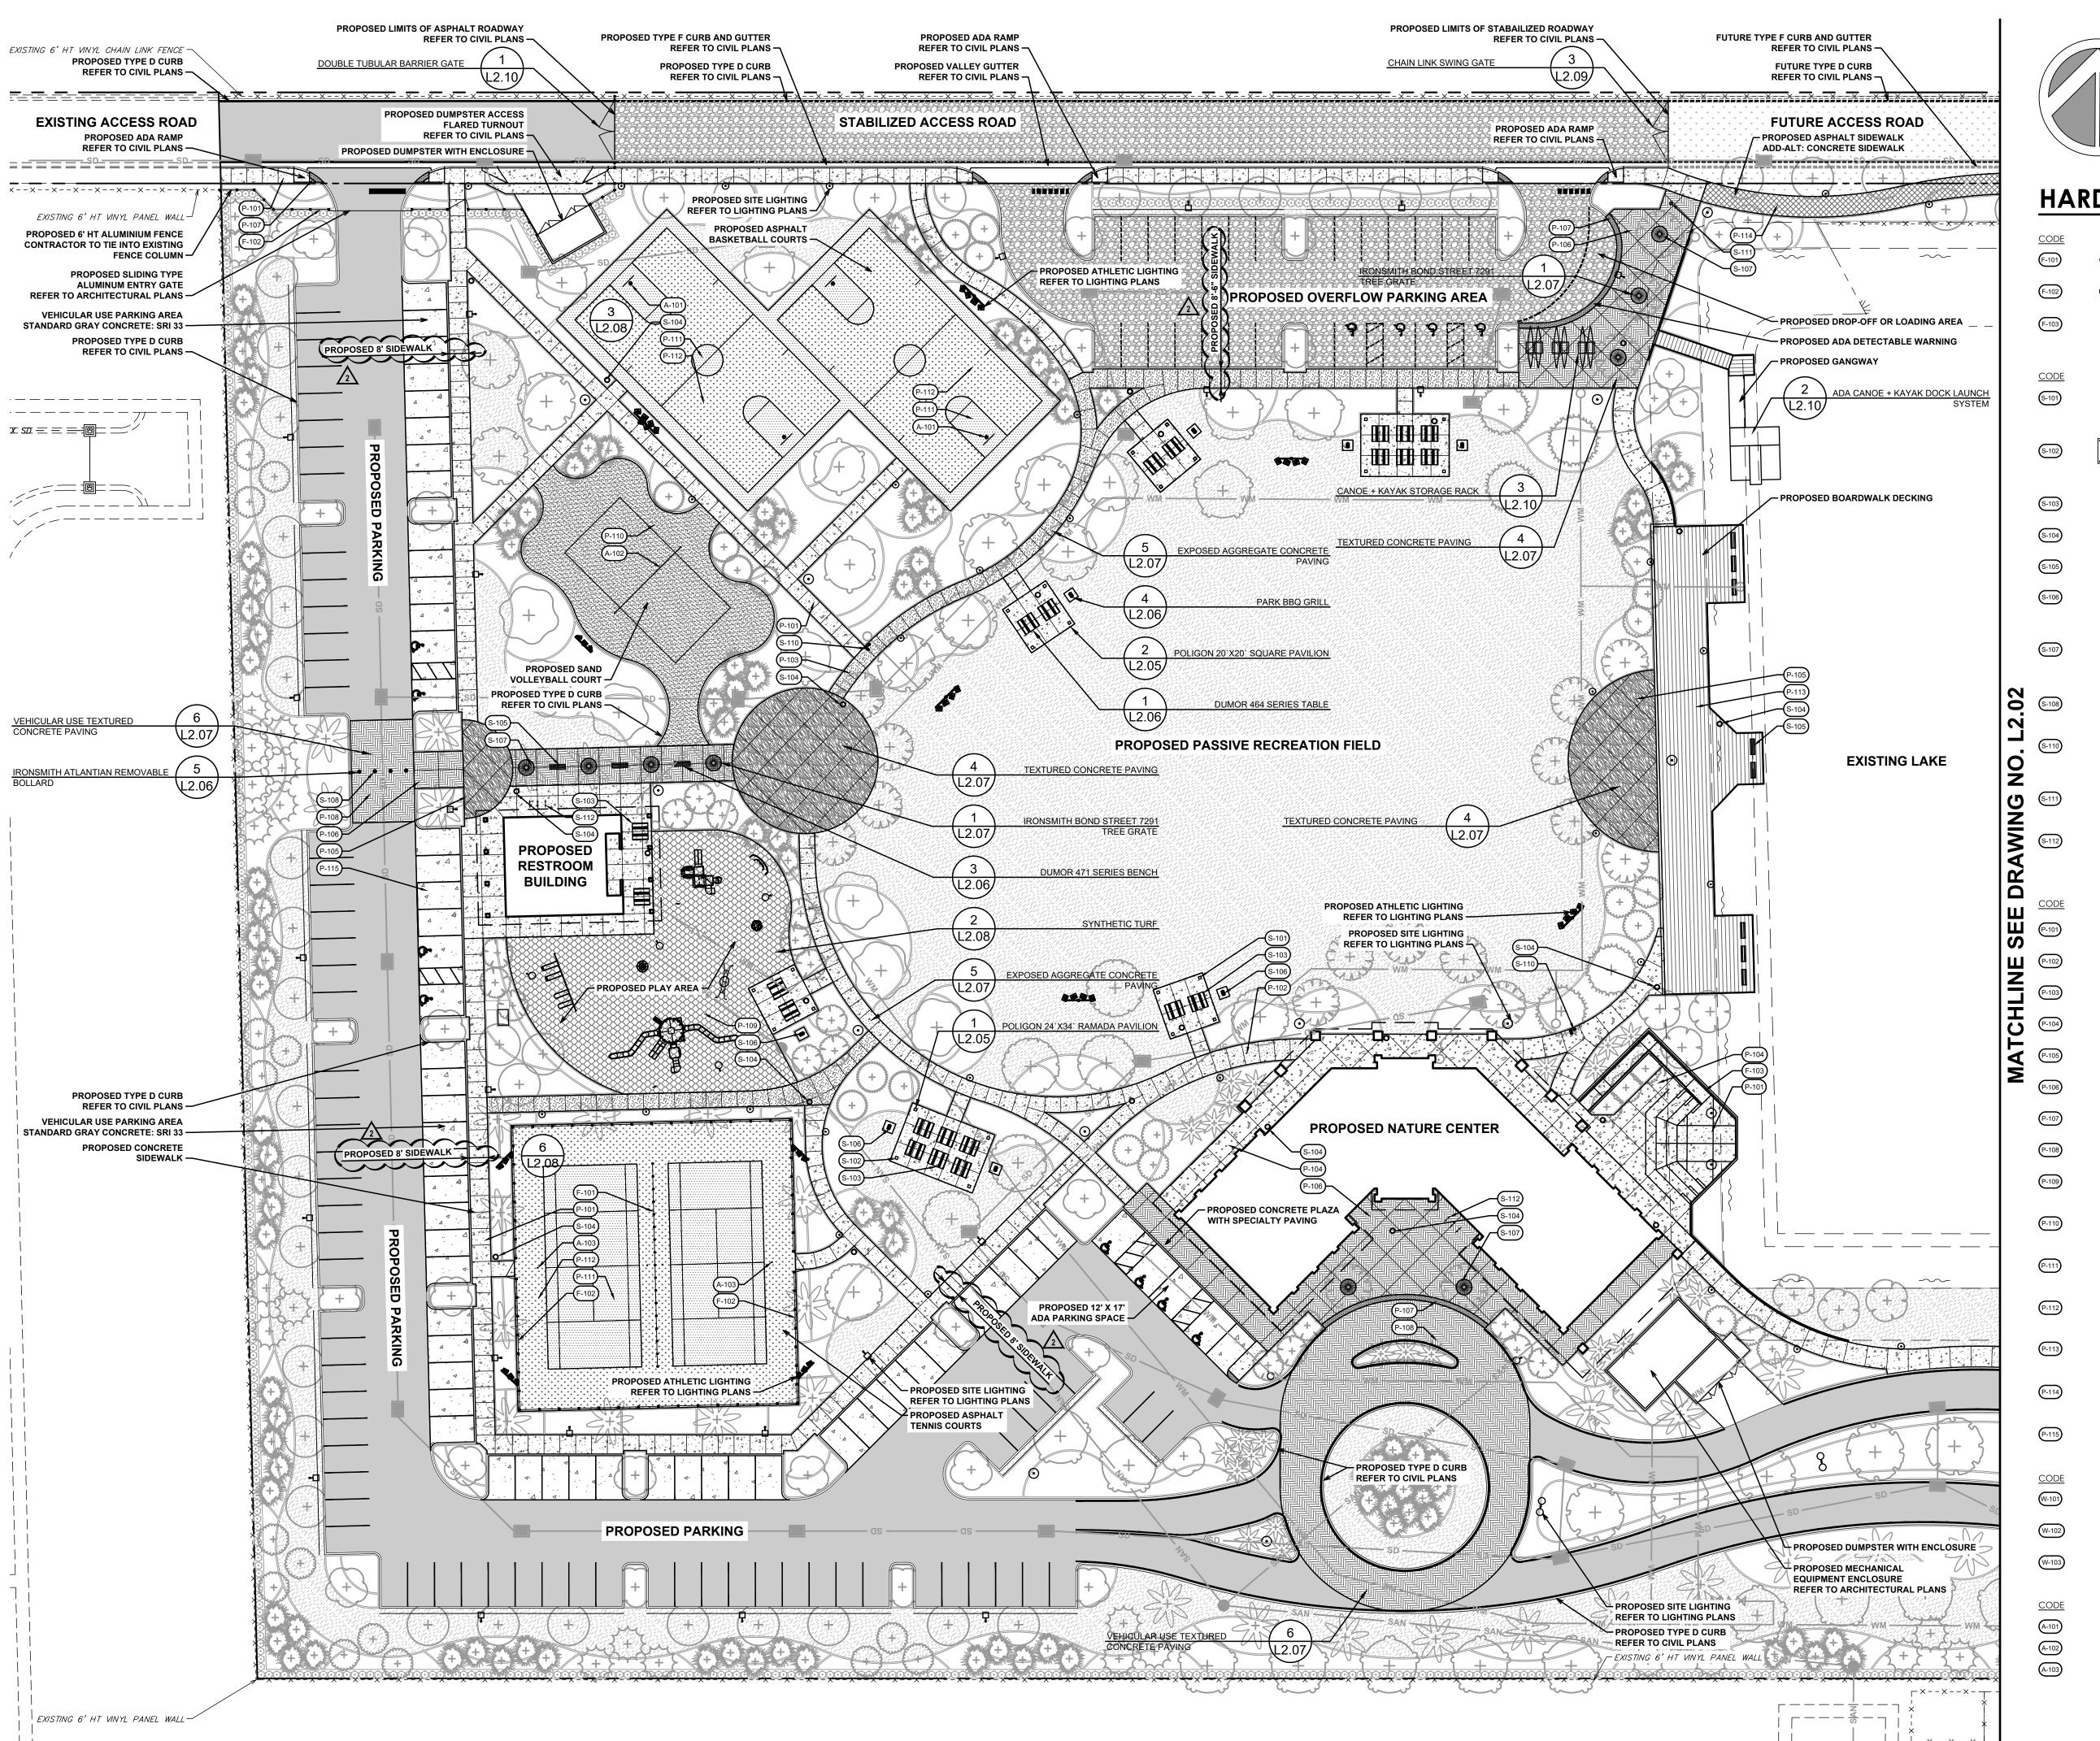

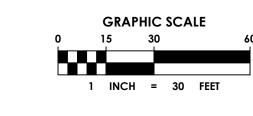

HARDSCAPE LEGEND

SYMBOL DESCRIPTION

•—• Chain Link Fence 6` Height, Black Vinyl Coated

> ■ ■ Aluminum Fence with Decorative Columns 6` Height, Pro-Fit Ledgestone "Autumn" Veneer Wrapped Columns

— Deck Railing IPE Lumber Construction Aluminum Picket, Black Powder Coated

20` Square, Tongue and Groove IPE Ceiling Add-Alternate: Pro-Fit Ledgestone "Autumn" Veneer Column

Poligon Shelter 24` x 34`, Tongue and Groove IPE Ceiling Add-Alternate: Pro-Fit Ledgestone "Autumn" Veneer Column

DuMor Table Set 464

DuMor Litter Receptacle 474

DuMor Bench 471

DuMor Grill 15" x 20" Galvanized Steel In-Ground Post Mount, 360° Rotation

> Ironsmith Bond Street Aluminum Tree Grate 72" round in quarter sections, 1/2" maximum slot openings, two openings for uplights, and steel angle frame with cross supports

Ironsmith Atlantian Removable Bollard 36" x 6" schedule 40 pipe with Cast aluminum cap.

MDF 440 Series Drinking Fountain Pedestal mounted drinking fountain with ADA arm and pet

MDF 500 Series Shower Pedestal mounted shower with foot wash and hose bib

DuMor Bike Rack 293

Two-Bike capacity bicycle rack, embedded mount, spaced 36" minimum in groups of three

Concrete Sidewalk

Exposed Aggregate Concrete

Shellrock Aggregate Concrete

Glass Aggregate Concrete Sidewalk

Integrally Colored + Textured Concrete Plaza

Integrally Colored + Textured Concrete Arrival Plaza

ooo Integrally Colored ADA Detectable Concrete

Integrally Colored + Textured Vehicular Use Concrete

Artificial Turfgrass
Play Surface, 12` Fall Height

Sand Volleyball Court
Play Surface

: Asphalt Play Surface Colorcoat Overlay

Asphalt Play Surface
Colorcoat Overlay

Deck Boardwalk \coprod IPE Lumber Construction

Asphalt Sidewalk
(Add-Alternate Concrete Sidewalk)

Vehicular Use Concrete

7` height x 10" width x 10" depth

Informational Sign 7` height x 4` width x 10" depth Identification Sign

4` height x 2` width x 10" depth

Basketball Goal Volleyball

> CRISTOBAL A. BETANCOURT, RLA REGISTRATION NO. 6666941

DATE: 03-01-2017

CONSULTANT:

&ASSOCIATES

500 West Cypress Creek Road

Ft. Lauderdale, FL 33309

954.730.0707

www.chenmoore.com

CERTIFICATES OF AUTHORIZATION

EB4593 LC26000425

DRAWING TITLE: HARDSCAPE PLANS

CHECKED: 03-01-2017 SCALE: AS SHOWN PROJECT NO. 1514

- 1.1.1. THESE GENERAL NOTES, CONSTRUCTION DOCUMENTS AND SPECIFICATIONS.
- ALL APPLICABLE LOCAL, STATE AND FEDERAL CODES, ORDINANCES AND REGULATIONS.
- 1.2. SOURCE OF BASE INFORMATION IS ASSUMED TO BE CORRECT. IF SITE DISCREPANCIES ARE PRESENT, CONTRACTOR SHALL NOTIFY OWNER'S REPRESENTATIVE IMMEDIATELY. IF CONTRACTOR CONTINUES WORK WITHOUT THE PROPER NOTIFICATION, CONTRACTOR DOES SO AT HIS OWN RISK.
- 1.3. THE CONTRACTOR SHALL FURNISH ALL MATERIALS, LABOR, SUPERVISION, AND EQUIPMENT REQUIRED FOR THE WORK AS SHOWN ON THE CONSTRUCTION DOCUMENTS DESCRIBED HEREIN.
- 1.4. CONTRACTOR SHALL BE RESPONSIBLE FOR ANY COORDINATION WITH SUB-CONTRACTORS AS REQUIRED TO COMPLETE THE WORK OF THIS PROJECT.
- 1.5. CONTRACTOR SHALL VERIFY LOCATIONS OF PERTINENT SITE IMPROVEMENTS INSTALLED UNDER OTHER CONTRACTS. IF ANY PART OF THIS PLAN CANNOT BE FOLLOWED DUE TO SITE CONDITIONS, CONTACT OWNER'S REPRESENTATIVE FOR INSTRUCTIONS PRIOR 4.25. CONTRACTOR SHALL REMOVE ALL NURSERY STAKES, CONDUIT, FLAGGING AND NURSERY TAPE PRIOR TO STAKING. TO COMMENCING WORK.
- 1.6. CONTRACTOR TO NOTIFY "SUNSHINE STATE ONE CALL OF FLORIDA, INC." AT 1-800-432-4770 TWO FULL BUSINESS DAYS PRIOR TO DIGGING FOR UNDERGROUND UTILITY LOCATIONS.
- 1.7. CONTRACTOR IS RESPONSIBLE FOR DETERMINING ALL UTILITY LOCATIONS AND INSTALLING FACILITIES SO AS TO NOT CONFLICT. 4.27. TREES THAT CANNOT STAND WITHOUT THE SUPPORT OF STAKES AND/OR GUYS SHALL BE REJECTED. THE LOCATION OF EXISTING UTILITIES OR SITE FEATURES AS SHOWN ON THE PLANS MAY VARY IN RELATION TO ACTUAL EXISTING 5. TURF GRASSES CONDITIONS. ANY DIFFERING SITE CONDITIONS FROM THAT WHICH IS REPRESENTED HEREON, WHETHER ABOVE, ON OR BELOW THE SURFACE OF THE GROUND, SHOULD BE BROUGHT TO THE IMMEDIATE ATTENTION OF THE LANDSCAPE ARCHITECT AND THE OWNER IN WRITING. NO CLAIM FOR EXPENSES INCURRED BY THE CONTRACTOR DUE TO DIFFERING SITE CONDITIONS WILL BE ALLOWED IF THE CONTRACTOR FAILS TO PROVIDE THE REQUIRED WRITTEN NOTIFICATION OF SUCH CONDITIONS FOR REVIEW BY 6. MULCH & FERTILIZER THE LANDSCAPE ARCHITECT AND THE OWNER.
- CONTRACTOR SHALL NOTIFY ALL APPROPRIATE UTILITY COMPANIES OF PROPOSED START OF WORK IN ACCORDANCE WITH THEIR STANDARD REQUIREMENTS, INCLUDING BUT NOT LIMITED TO, WATER, SANITARY SEWER, POWER, NATURAL GAS, TELEPHONE AND 6.2. INDIVIDUAL TREES PLANTED IN LAWN AREAS SHALL BE MULCHED WITH A MINIMUM 3' DIAMETER MULCH RING.
- CABLE TV COMPANIES. 1.9. IT SHALL BE THE CONTRACTOR'S SOLE RESPONSIBILITY TO TAKE THE NECESSARY PRECAUTIONS TO ENSURE PROPER SAFETY AND
- WORKMANSHIP WHEN WORKING IN THE VICINITY OF EXISTING UTILITY LINES. 1.10. PERFORM EXCAVATION IN THE VICINITY OF UNDERGROUND UTILITIES WITH CARE AND BY HAND, IF NECESSARY. THE CONTRACTOR BEARS FULL RESPONSIBILITY FOR THIS WORK AND DISRUPTION OF DAMAGE TO UTILITIES SHALL BE REPAIRED
- IMMEDIATELY AND AT NO EXPENSE TO THE OWNER. DISCRETION, ADD OR DELETE FROM THE MATERIALS UTILIZING THE UNIT PRICE BREAKDOWN SUBMITTED.
- 1.12. IT IS THE RESPONSIBILITY OF THE CONTRACTOR TO ENSURE THAT ALL REQUIRED PERMITS ARE OBTAINED AND ARE IN HAND AT THE JOB SITE PRIOR TO THE COMMENCEMENT OF CONSTRUCTION. CONTRACTOR SHALL ABIDE BY ALL PERMIT CONDITIONS.

2. PRE-CONSTRUCTION RESPONSIBILITY

- 2.1. UPON RECEIPT OF NOTICE OF AWARD, THE CONTRACTOR SHALL ARRANGE A PRE-CONSTRUCTION CONFERENCE TO INCLUDE ALL INVOLVED GOVERNMENTAL AGENCIES, ALL AFFECTED UTILITY OWNERS, THE OWNER, THE LANDSCAPE ARCHITECT, ANY OTHER PERTINENT PARTIES AND HIMSELF.
- JANITORIAL SERVICES SHALL BE PROVIDED BY CONTRACTOR THROUGHOUT THE DURATION OF PROJECT.
- 2.3. PRIOR TO BEGINNING CONSTRUCTION, THE CONTRACTOR SHALL VERIFY THE SIZE, LOCATION, ELEVATION, AND MATERIAL OF ALL EXISTING UTILITIES WITHIN THE AREA OF CONSTRUCTION.
- 2.4. IF UPON EXCAVATION, AN EXISTING UTILITY IS FOUND TO BE IN CONFLICT WITH THE PROPOSED CONSTRUCTION OR TO BE OF A SIZE OR MATERIAL DIFFERENT FROM THAT SHOWN ON THE PLANS; THE CONTRACTOR SHALL IMMEDIATELY NOTIFY THE LANDSCAPE
- 2.5. IT SHALL BE THE CONTRACTOR'S RESPONSIBILITY TO MAKE ARRANGEMENTS FOR THE FIELD LOCATIONS AND FOR ANY TREES PROPOSED FOR RELOCATION. THIS SHALL BE DONE IN A TIMELY MANNER TO MINIMIZE IMPACT ON CONSTRUCTION SCHEDULE. ANY DELAY CAUSED BY THE CONTRACTOR BY THE RELOCATION OF TREES SHALL BE INCIDENTAL TO THE CONTRACT AND NO EXTRA COMPENSATION WILL BE ALLOWED.
- 2.6. CONTRACTOR SHALL VERIFY LIMITS OF CONSTRUCTION AS NOTED ON THE PLANS. ANY WORK PERFORMED OUTSIDE OF THE 8.4. THE CONTRACTOR SHALL MAINTAIN ACCURATE AND COMPLETE RECORDS OF WORK ITEMS COMPLETED. AGREED UPON LIMITS OF CONSTRUCTION SHALL BE DONE AT THE EXPENSE OF THE CONTRACTOR.

3. PLANTING SOIL

- 3.1. ALL TREES SHALL BE PLANTED WITH A MINIMUM OF 12" TOPSOIL AROUND AND BENEATH THE ROOTBALL.
- 3.2. ALL SHRUBS SHALL BE PLANTED WITH A MINIMUM OF 6" TOPSOIL AROUND AND BENEATH THE ROOTBALL.
- 3.3. MINIMUM TOPSOIL SHALL BE 2" FOR SODDED GRASS AREAS. 3.4. PLANTING SOIL MIX SHALL BE A WEED FREE MIX AS FOLLOWS:
- 3.4.1. DICOT TREES & SHRUBS: 50% SAND, 40% MUCK & 10% PEAT
- MONOCOT PALMS: 70% SAND & 30% MUCK
- 3.4.3. TURF: 80% SILICA SAND, 10% PEAT & 10% MUCK

4. LANDSCAPE PLANTING

- 4.1. THIS PLAN HAS BEEN DESIGNED TO MEET OR EXCEED ALL APPLICABLE CODES.
- 4.2. THE PLANTING PLAN SHALL BE INSTALLED IN COMPLIANCE WITH ALL EXISTING CODES AND APPLICABLE DEED RESTRICTIONS.
- NURSERY PLANTS" OF THE STATE OF FLORIDA, DEPARTMENT OF AGRICULTURE.
- 4.4. ALL PLANT MATERIAL SHALL BE TRUE TO THE BOTANICAL NAME, GENUS, SPECIES AND/OR HYBRID DESIGNATION.
- 4.5. ALL TREES, SHRUBS AND GROUNDCOVERS SHALL BE OF THE SIZES (HEIGHT & SPREAD) AS SPECIFIED IN THE PLANT LIST. CONTAINER SIZE IS FOR REFERENCE PURPOSES ONLY. ALL PLANT MATERIAL SHALL MEET OR EXCEED THE MINIMUM SIZES AT INSTALLATION, AS SPECIFIED IN THE PLANT LIST.
- 4.6. QUANTITIES LISTED ON THE PLANT LIST ARE FOR ESTIMATING PURPOSES. CONTRACTOR SHALL VERIFY ALL QUANTITIES. MULCH, TOPSOIL, FERTILIZER, ETC. SHALL BE INCLUDED IN THE UNIT COST OF THE PLANTS.
- 4.7. Where there is a discrepancy either in quantities, plant names, sizes or specifications between the plan or plant LIST, THE PLAN TAKES PRECEDENCE.
- 4.8. ALL SUBSTITUTIONS AND CHANGES SHALL BE APPROVED IN WRITING PRIOR TO INSTALLATION. ANY DISCREPANCIES BETWEEN PLANS, SITE AND SPECIFICATIONS SHALL BE BROUGHT TO THE IMMEDIATE ATTENTION OF THE LANDSCAPE ARCHITECT, THE OWNER AND/OR GOVERNING MUNICIPALITY.
- 4.9. CONTRACTOR SHALL BE RESPONSIBLE FOR PROVIDING FINAL GRADING OF ALL ASSOCIATED PLANTING AREAS.
- 4.10. AFTER FINAL GRADE, LANDSCAPE AREAS ARE TO BE RAKED TO A DEPTH OF 6". ALL ROCK AND FOREIGN INORGANIC MATERIALS SHALL BE REMOVED AND DISPOSED OF PROPERLY OFF-SITE.
- 4.11. ALL PLANTING HOLES TO BE HAND DUG EXCEPT WHERE MACHINE DUG HOLES WILL NOT ADVERSELY AFFECT EXISTING TREES, DAMAGE UTILITIES OR OTHER IMPROVEMENTS.
- 4.12. ALL PLANTING BEDS IN OPEN AREAS AND AROUND BUILDING FOUNDATIONS SHALL BE EXCAVATED TO A DEPTH OF TWENTY-FOUR INCHES (24") AND BACK FILLED WITH SOIL MIX AS SPECIFIED IN SECTION 3.00. PLANTING BED SHALL BE FREE FROM ROCK, CONSTRUCTION DEBRIS OR OTHER EXTRANEOUS MATERIAL.
- 4.13. ALL PLANTING BEDS IN MEDIANS, HARDSCAPE AREAS OR AREAS ENCOMPASSED BY IMPERVIOUS MATERIAL SHALL BE EXCAVATED TO A DEPTH OF THIRTY-SIX INCHES (36") OR UNTIL NATIVE SOILS ENCOUNTERED TO ENSURE DRAINAGE. BACK FILL WITH SOIL MIX as specified in Section 5.00. Planting bed shall be free from rock, construction debris or other extraneous MATERIAL.
- 4.14. EXCAVATE PLANTING PITS TO A DEPTH SO THAT THE TRUNK FLARE AND FIRST ORDER LATERAL ROOT(S) WILL BE PLANTED AT FINISH GRADE OR SLIGHTLY HIGHER. ADVENTITIOUS ROOTS ARE NOT CONSIDERED FIRST ORDER ROOTS.
- 4.15. BURLAP, SYNTHETIC STRING, CORDS AND/OR LIFTING ROPES SHALL BE REMOVED FROM THE ROOTBALLS BEFORE ANY TREES ARE PLANTED. THE TOP 1/3RD OF BURLAP MUST BE REMOVED FROM HE TOP OF THE ROOTBALLS. THE TOP 1/3RD OF WIRE BASKETS SHALL BE COMPLETELY REMOVED AND THE BOTTOM 2/3RDS SHALL BE CUT BEFORE THE TREES ARE INSTALLED.
- 4.16. NO PLUNGING OF ANY TREE OR PALM WILL BE ACCEPTED.
- 4.17. NO PLANT MATERIAL WILL BE ACCEPTED SHOWING EVIDENCE OF CABLE, CHAIN MARKS, EQUIPMENT SCARS, OR OTHERWISE DAMAGED.

4.18. PLANT MATERIAL WILL NOT BE ACCEPTED WHEN THE BALL OF EARTH SURROUNDING ITS ROOTS HAS BEEN CRACKED, BROKEN OR TREES

- OTHERWISE DAMAGED. 4.19. ALL TREES SPECIFIED AS FIELD GROWN OR B&B TREES SHALL BE ROOT-PRUNED AT THE NURSERY A MINIMUM OF (8) WEEKS PRIOR TO PLANTING.
- 4.20. ALL PLANT MATERIAL PLANTED WITHIN THE SIGHT DISTANCE TRIANGLE AREAS SHALL BE MAINTAINED TO PROVIDE UNOBSTRUCTED CROSS-VISIBILITY AT A HORIZONTAL LEVEL BETWEEN 30 INCHES AND 8 FEET ABOVE ADJACENT STREET GRADE.
- 4.21. NO CANOPY TREES SHALL BE PLANTED WITHIN 12 FEET OF A LIGHT POLE. NO PALM SPECIES SHALL BE PLANTED WITHIN 6 FEET OF A LIGHT POLE.
- 4.22. GROUND COVER PLANTINGS SHALL PROVIDE NOT LESS THAN 50 PERCENT COVERAGE IMMEDIATELY UPON PLANTING AND 100 PERCENT COVERAGE WITHIN 6 MONTHS AFTER PLANTING.
- 4.23. TREES AND PALMS SHALL BE MAINTAINED TO ALLOW FOR CLEAR PASSAGE 8' IN ALL PEDESTRIAN AREAS.
- 4.24. ALL LANDSCAPE MATERIAL SHALL BE SETBACK A MINIMUM OF 10' FROM ANY FIRE HYDRANT.
- 4.26. CONTRACTOR SHALL STAKE & GUY ALL TREES AND PALMS AT TIME OF PLANTING AS PER THE APPROPRIATE DETAIL. CONTRACTOR is responsible for the maintenance and/or repair of all staking and guying during warranty period and REMOVAL & DISPOSAL OF STAKING AFTER ESTABLISHMENT/WARRANTY PERIOD.

5.1. ALL AREAS NOT USED FOR BUILDINGS, VEHICULAR USE AREAS, WALKS OR PLANTING BEDS SHALL BE GRASSED. GRASSING SHALL EXTEND TO ANY ABUTTING STREET PAVEMENT EDGE AND TO THE MEAN WATERLINE OF ANY ABUTTING CANAL, LAKE OR WATERWAY. REFER TO PLANTING SCHEDULE FOR ESTIMATED QUANTITY AND SPECIES.

- 6.1. ALL PLANTING BEDS AND WATER BASINS FOR TREES SHALL BE COVERED WITH A 3" MINIMUM DEPTH OF PINE STRAW MULCH, UNLESS OTHERWISE SPECIFIED.
- 6.3. MULCH SHALL NOT BE INSTALLED WITHIN 3" OF TREE TUNKS.
- 6.4. FERTILIZER MIX AS FOLLOWS:
- DICOT TREES & SHRUBS: NPK 18-4-2, SLOW RELEASE W/ MICRONUTRIENTS
- MONOCOT PALMS: NPK 8-2-12, SLOW RELEASE W/ MICRONUTRIENTS

TURF: NPK 16-4-8, SLOW RELEASE W/ MICRONUTRIENTS

- 1.11. THE SUCCESSFUL BIDDER SHALL FURNISH TO THE OWNER A UNIT PRICE BREAKDOWN FOR ALL MATERIALS. THE OWNER MAY, AT ITS 7.1. ALL LANDSCAPED AREAS WILL BE IRRIGATED BY AN UNDERGROUND, AUTOMATIC, RUST-FREE IRRIGATION SYSTEM PROVIDING 100% COVERAGE AND 50% SPRAY OVERLAP. THE SYSTEM SHALL BE MAINTAINED IN GOOD WORKING ORDER AND DESIGNED TO MINIMIZE WATER ON IMPERVIOUS SERVICES AND NOT OVERSPRAY WALKWAYS. A RAIN SENSOR DEVICE SHALL BE INSTALLED TO OVERRIDE THE IRRIGATION CYCLE OF THE SYSTEM WHEN ADEQUATE RAINFALL HAS OCCURRED.
 - 7.2. ALL PLANT MATERIAL SHALL BE WATERED IN AT TIME OF PLANTING IN ACCORDANCE WITH STANDARD NURSERY PRACTICES. IN ADDITION, CONTRACTOR WILL CONTINUE THE WATERING OF PLANT MATERIAL UNTIL SUBSTANTIAL COMPLETION AND THE LANDSCAPE IS TURNED OVER TO THE OWNER.

8. PROJECT CLOSEOUT

- 2.2. CONTRACTOR SHALL PROVIDE TEMPORARY SANITARY FACILITIES ONSITE. LOCATION TO BE DETERMINED BY THE OWNER. 8.1. DURING CONSTRUCTION, THE PROJECT SITE AND ALL ADJACENT AREAS SHALL BE MAINTAINED IN A NEAT AND CLEAN MANNER. UPON FINAL CLEAN UP, THE PROJECT SITE SHALL BE LEFT CLEAR OF ALL SURPLUS MATERIAL OR TRASH. THE PAVED AREAS SHALL BE SWEPT BROOM CLEAN.
 - 8.2. THE CONTRACTOR SHALL RESTORE, REPLACE OR AS DIRECTED BY THE LANDSCAPE ARCHITECT, ANY PUBLIC OR PRIVATE PROPERTY DAMAGED BY THE WORK OF THE CONTRACTOR, HIS EQUIPMENT, EMPLOYEES OR THOSE OF HIS SUB-CONTRACTORS THIS WORK SHALL BE RESTORED TO A CONDITION EQUAL TO OR BETTER THAN THAT OF THE EXISTING ADJACENT AREAS. THE RESTORATION WORK SHALL BE AT THE CONTRACTOR'S EXPENSE. SUITABLE MATERIALS AND METHODS SHALL BE USED FOR SUCH RESTORATION.
 - WHERE MATERIAL OR DEBRIS HAS WASHED OR FLOWED INTO OR BEEN PLACED IN WATER COURSES, DITCHES, DRAINS, CATCH BASINS, OR ELSEWHERE AS A RESULT OF THE CONTRACTOR'S OPERATIONS, SUCH MATERIAL OR DEBRIS SHALL BE REMOVED AND SATISFACTORILY DISPOSED OF DURING PROGRESS OF THE WORK. THESE AREAS SHALL BE KEPT IN A CLEAN AND NEAT CONDITION

 - 8.5. UPON COMPLETION OF CONSTRUCTION, THE CONTRACTOR SHALL SUBMIT TO THE LANDSCAPE ARCHITECT OF RECORD COMPLETE SETS OF "AS-BUILT" CONSTRUCTION DRAWINGS. THESE DRAWINGS SHALL BE MARKED TO SHOW "AS-BUILT" CONSTRUCTION CHANGES AND DIMENSIONED LOCATIONS AND ELEVATIONS OF ALL IMPROVEMENTS INCLUDING PRODUCT/EQUIPMENT AS SPECIFIED OR REVISED DURING THE SHOP DRAWING SUBMITTAL PROCESS. AS-BUILT DRAWINGS SHALL BE SIGNED AND SEALED BY A FLORIDA REGISTERED LAND SURVEYOR.

9. GUARANTEE

- 9.1. ALL NEW PLANT MATERIAL SHALL BE GUARANTEED FOR 1 YEAR FROM TIME OF FINAL ACCEPTANCE OF PROJECT. ANY PLANT MATERIAL NOT IN A HEALTHY GROWING CONDITION WILL BE REPLACED IN KIND BY THE CONTRACTOR AT NO ADDITIONAL COST TO THE OWNER WITHIN 10 DAYS OF NOTIFICATION.
- 9.2. FOR ALL REPLACEMENT PLANT MATERIAL, THE WARRANTY PERIOD SHALL BE EXTENDED AN ADDITIONAL 90 DAYS BEYOND THE ORIGINAL WARRANTY PERIOD. REPLACEMENT MATERIAL SHALL BE REPLACED IN KIND AS IT RELATES TO SPECIES, QUANTITY AND SIZE.
- 4.3. PLANT MATERIAL: ALL PLANT MATERIAL SHALL BE FLORIDA #1 OR BETTER AS ESTABLISHED BY "GRADES AND STANDARDS FOR 9.3. ALL TREES THAT LEAN OR ARE BLOWN OVER, CAUSED BY WINDS LESS THAN 74 MPH AS DETERMINED BY THE NATIONAL HURRICANE CENTER, WILL BE RE-SET AND BRACED BY THE CONTRACTOR AT NO ADDITIONAL COST TO THE OWNER.

LANDSCAPE LEGEND

ZOI	NING DISTRICT: GOVERMENTAL - INTERIM	NET LOT AREA:	9.00 AC	391,971 SF	
			REQUIRED	PROVIDED	_
	OPEN SPACE			\sim	_
A.	SQUARE FEET OF OPEN SPACE REQUIRED BY CHAPTER 33	40%	156,788 SF	239,844 SF	= \
В.	SQUARE FEET OF PARKING LOT OPEN SPACE REQUIRED BY CHAPTER 18A	160 SPACES	1,600 SF	4,070 SF	/
C.	TOTAL SF OF LANDSCAPED OPEN SPACE REQUIRED BY CHAPTER 33		158,388 SF	239,844 SF)
	LAWN AREA CALCULAT	ION	\ 	> 3	<u>'</u>
<u>—</u>	TOTAL SF OF LANDSCAPED OPEN SPACE REQUIRED BY CHAPTER 33	158,388 SF	158,388 SF	239,844 SF	=)
В.	MAXIMUM LAWN AREA (SOD) PERMITTED (LESS 55,565 SF OPEN PLAY)	60%	143,906 SF	123,187 SF)
	TREES			}	<u> </u>
A.	NO. TREES REQUIRED PER NET LOT ACRE LESS EXISTING NUMBER OF TREES MEETING MINIMUM REQUIREMENTS	28 TREES PER ACRE	252 TREES	253 TREES	
В.	% PALMS ALLOWED: NO. TREES PROVIDED X 30%	30%	76 PALMS	57 PALMS) .
	% PALMS PERMITTED TO COUNT AS STREET TREES ON 1:1 BASIS X 30%	30%	20 PALMS	0 PALMS) [3
C.	% NATIVES REQUIRED: NO. TREES PROVIDED X 30%	30%	76 TREES	232 TREES	
D.	STREET TREES (MAXIMUM AVERAGE SPACING OF 35' O.C.: LINEAR FEET ALONG STREET / 35	2,296 LF	66 TREES	66 TREES	*
E.	STREET TREES LOCATED DIRECTLY BENEATH POWER LINES (MAXIMUM AVERAGE SPACING OF 25' O.C.): LINEAR FEET ALONG STREET / 25	0 LF	N/A	N/A	2
	SHRUBS			() 1
A.	NO. TREES REQUIRED X 10 = NO. OF SHRUBS REQUIRED	10 SHRUBS PER TREE	2,520 SHRUBS	6,085 SHRUBS	F \
В.	NO. SHRUBS REQUIRED X 30% = NO. OF NATIVE SHRUBS REQUIRED	30%	756 SHRUBS	4,186 SHRUBS)	′

PLANT SCHEDULE

REES	CODE	QTY	COMMON NAME / BOTANICAL NAME	CONT	SIZE	NATIVE	
(+)	AR	18 *	Red Maple / Acer rubrum	B & B	12` HT, 6` SPR, 3" CAL	Yes	
(+)	AG	6	Pond Apple / Annona glabra	B & B	8` HT, 4` SPRD	Yes	
(+)	CD	30	Pigeon Plum / Coccoloba diversifolia	B & B	8` HT, 4` SPRD	Yes	
+	CS	26 *	Orange Geiger Tree / Cordia sebestena	B & B	10` OAH, 5`SPR., 2-1/2" CAL.) Yes	
**************************************	IC	10	Dahoon Holly / llex cassine	B & B	8` HT, 4` SPRD 2	Yes	
**************************************					10° HT, 5° SPRD, 2-1/2" CAL	\ No	
(+) July	LI	21 *	Crape Myrtle / Lagerstroemia indica	B & B	10 HI, 5 SPRD, 2-1/2 CAL) No	
\\\\\\\\\\\\\\\\\\\\\\\\\\\\\\\\\\\\\\	PE	25 *	Slash Pine / Pinus elliotti	B & B	12` - 14` HT, 4` SPRD, 3" CAL	Yes	
+	QV	92 *	Live Oak / Quercus virginiana	B & B	14' HT, 6' SPRD, 3" CAL	Yes	
PALM TREES	CODE	QTY	COMMON NAME / BOTANICAL NAME	CONT	SIZE	<u>NATIVE</u>	
(+ 3	BN	19 *	Silver Bismark Palm / Bismarckia nobilis `Silver` full, dense crown/ heavy caliper	B & B	8` CT	Yes	
715	RE	38 *	Florida Royal Palm / Roystonea elata	B & B	10` GW	Yes	
+	SP	126	Cabbage Palmetto / Sabal palmetto Staggered Heights, Curved Trunk	B & B	10` - 12` CT	Yes	
	TR	26	Florida Thatch Palm / Thrinax radiata	B & B	8`-10` O.A.H.	Yes	
SPECIMEN TREES	CODE	<u>QTY</u>	COMMON NAME / BOTANICAL NAME	<u>CONT</u>	<u>SIZE</u>	NATIVE	
(+)	BS	5 *	Gumbo Limbo / Bursera simaruba	B & B	 18` HT., 7` SPRD, 6" CAL.	Yes	
+ }	CE	28 *	Green Buttonwood / Conocarpus erectus	B & B	16` OAH, 4" CAL	Yes	
+	FS	6 *	Strangler Fig / Ficus aurea	B & B	22` - 24` OAH, 12` SPRD	Yes	
+ }	QC	17 *	Cathedral Live Oak / Quercus virginiana `Cathedral`	B & B	16` OAH, 8` SPRD, 4" CAL	Yes	
2 + }	SM	7 *	West Indian Mahogany / Swietenia mahagoni	B & B	16` OAH, 6`-6" SPRD, 4" CAL	Yes	
promote + }	TD	17 *	Bald Cypress / Taxodium distichum	B & B	18` OAH, 7` SPRD	Yes	
SHRUBS	CODE	QTY	COMMON NAME / BOTANICAL NAME	CONT	SIZE	NATIVE	SPACING
(+)	CR	87 *	Red Tip Cocoplum / Chrysobalanus icaco `Red Tip`	5 gal	24" HT, 24" SPRD	Yes	36" o.c.
(+)	CLG	459 *	Small-Leaf Clusia / Clusia guttifera	7 gal	24" HT, 24" SPRD	Yes	36" o.c.
SHRUB AREAS	CODE CAA	QTY 470 *	COMMON NAME / BOTANICAL NAME	CONT	SIZE	NATIVE	SPACING
	СНІ	479 * 812 *	American Beautyberry / Callicarpa americana Red Tip Cocoplum / Chrysobalanus icaco `Red Tip`	3 gal	18" HT, FULL 18" HT, 18" SPRD	Yes Yes	24" o.c. 30" o.c.
	CLS	96 *	Small-Leaf Clusia / Clusia guttifera		24" HT, FULL	Yes	30" o.c.
			•	3 gal			
	COV	449	Curlyboy Croton / Codiaeum variegatum `Curlyboy`	3 gal	14" HT, FULL	Yes	24" o.c.
	CES	523 *	Silver Button Wood / Conocarpus erectus sericeus	3 gal	18" HT, 18" SPRD	Yes	30" o.c.
	CRA	1,376	Seven Sisters / Crinum americanum	1 gal	14" HT, FULL	Yes	18" o.c.
	DIV	1,665	Flax Lily / Dianella tasmanica `Variegata`	1 gal	14" HT, FULL	No	18" o.c.
	DUE	1,899 *	Gold Mound Duranta / Duranta erecta `Gold Mound`	3 gal	18" HT, FULL	No	24" o.c.
	HAP	672 *	Fire Bush / Hamelia patens	3 gal	18" HT, 18" SPRD	Yes	30" o.c.
	MUC	1,313	Pink Muhly / Muhlenbergia capillaris	3 gal	18" HT, FULL	Yes	30" o.c.
	MYF	536 *	Simpson`s Stopper / Myrcianthes fragrans	3 gal	18" HT, 18" SPRD	Yes	30" o.c.
	NEE	1,440	Boston Fern / Nephrolepis exaltata	1 gal	12" HT, FULL	Yes	18" o.c.
	PSN	522 *	Wild Coffee / Psychotria nervosa	3 gal	18" HT, 18" SPRD	Yes	24" o.c.
	SER	700	Saw Palmetto / Serenoa repens	7 gal	14" HT, FULL	Yes	36" o.c.
	SPB	1,427	Sand Cord Grass / Spartina bakeri	3 gal	18" HT, FULL	Yes	30" o.c.
		1,395	Fakahatchee Grass / Tripsacum dactyloides	3 gal	24" HT, FULL	Yes	30" o.c.
	TRD		Florida Gamagrass / Tripsacum floridanum	3 gal	24" HT, FULL	Yes	30" o.c.
	TRD TRF	1,249				V	24" o.c.
		1,249 2,620	Coontie Palm / Zamia floridana	3 gal	14" HT, FULL	Yes	
TURF AREAS	TRF		Coontie Palm / Zamia floridana COMMON NAME / BOTANICAL NAME	3 gal <u>CONT</u>	14" HT, FULL SIZE	yes <u>NATIVE</u>	
TURF AREAS	TRF ZAF CODE	2,620		-			
	TRF ZAF CODE	2,620 QTY 55,110 sf	COMMON NAME / BOTANICAL NAME	<u>CONT</u> SOD	<u>SIZE</u>	<u>NATIVE</u>	


CRISTOBAL A. BETANCOURT, RLA REGISTRATION NO. 6666941

> DATE: 03-01-2017

CONSULTANT

Lauderdale, FL 33309 954.730.0707 CERTIFICATES OF AUTHORIZATIO

EB4593 LC26000425

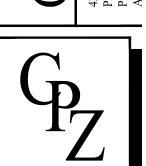

DRAWING TITLE: LANDSCAPE SCHEDULES AND **SPECIFICATIONS**

DRAWN: CHECKED: 03-01-2017 SCALE: AS SHOWN PROJECT NO. 1514


GUTTER & WATER LEADER

GC TO PAINT THIS AREA OF BUILDING TO VERIFY GUTTER & WATER LEADER PAINT COLORS, PRIOR TO TO BE WHITE FINISH ORDERING ALL PAINT BEARING HEIGHT 3' - 0" O.H. SMOOTH STUCCO FINISH -10 - 0 1/2 FINISH FLOOR /+61 psf\ /+61 psf\ +64 psf WIND PRESSURES SHOWN ARE DRAINAGE TYPICAL — STUCCO NOMINAL DESIGN PRESSURES. NO CONTROL JOINTS \- 83 psf FURTHER REDUCTION MAY BE TAKEN NORTH ELEVATION **TYPICAL**


SOUTH ELEVATION

SCALE: 3/16" = 1'-0"

SCALE: 3/16" = 1'-0"

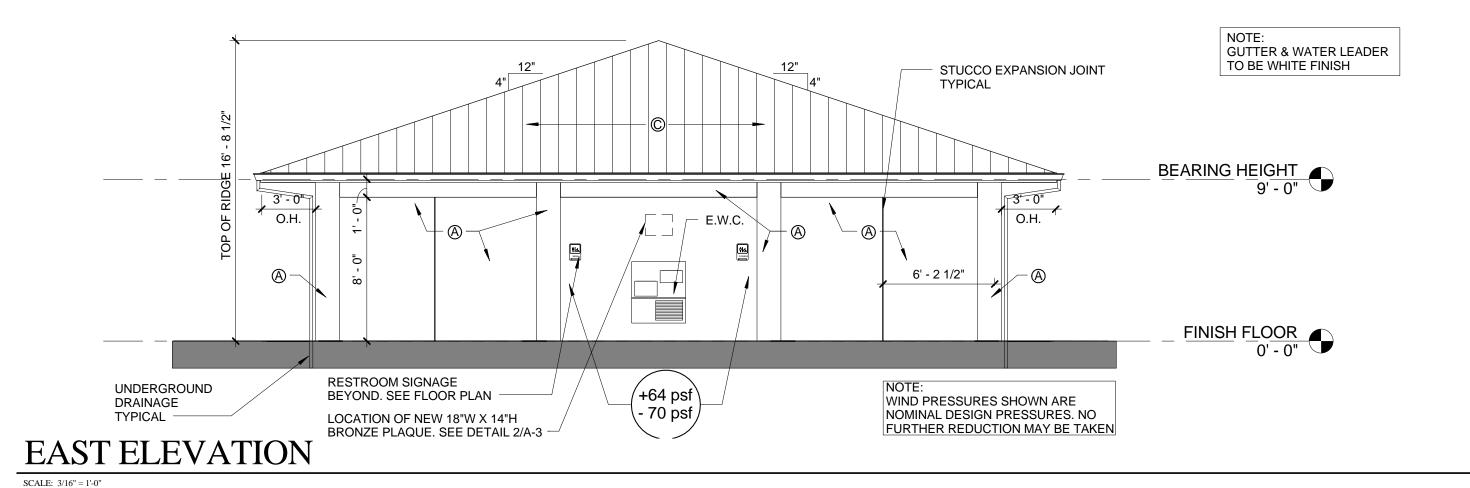

GUTTER & WATER LEADER TO BE WHITE FINISH STUCCO CONTROL JOINT TYPICAL BEARING HEIGHT - SMOOTH STUCCO О.Н. STUCCO CONTROL
JOINT TYPICAL SMOOTH STUCCO FINISH FLOOR +64 psf - 70 psf NOTE: WIND PRESSURES SHOWN ARE NOMINAL DESIGN PRESSURES. NO UNDERGROUND DRAINAGE +58 psf - 71 psf FURTHER REDUCTION MAY BE TAKEN WEST ELEVATION

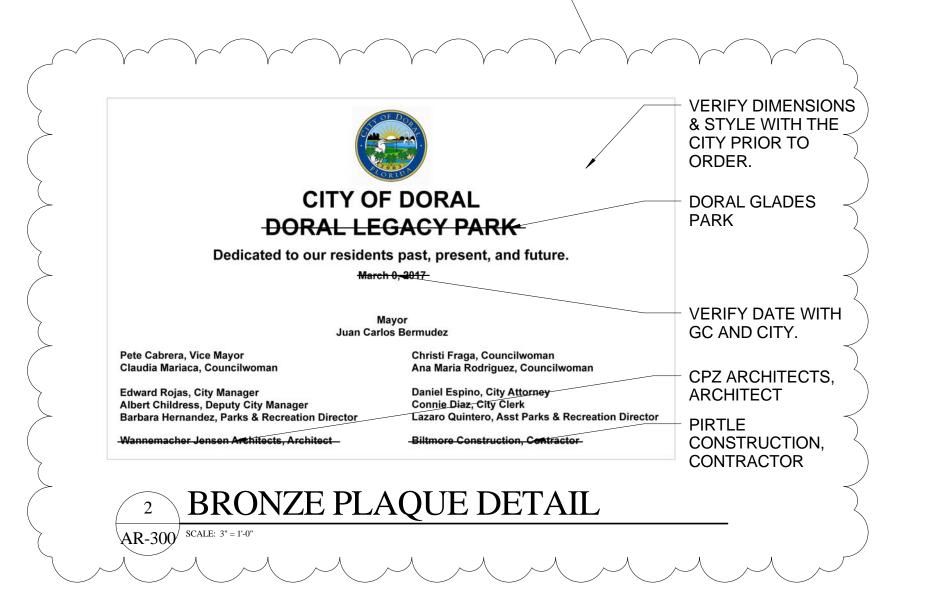

SHERWIN WILLIAMS OR APPROVED EQUAL PAINT SPECIFICATION

A. CONCRETE, STUCCO, AND CEMENT PLASTER:

1. 100% ACRYLIC COATING:

A. PRIMER: APPLY SHERWIN WILLIAMS OR APPROVED EQUAL LOXON ACRYLIC PRIMER (A24W300) AT A WET FILM THICKNESS OF 8 MILS TO DRY TO 3.2 MILS DRY FILM THICKNESS.

B. FIRST COAT: APPLY SHERWIN WILLIAMS OR APPROVED EQUAL SUPERPAINT EXTERIOR LATEX SATIN (A89 SERIES) AT A WET FILM THICKNESS OF 4 MILS TO DRY TO 1.44 MILS DRY FILM THICKNESS.

C. SECOND COAT: APPLY SHERWIN WILLIAMS OR APPROVED EQUAL SUPERPAINT EXTERIOR LATEX SATIN (A89 SERIES) AT A WET FILM THICKNESS OF 4 MILS TO DRY TO 1.44 MILS DRY FILM THICKNESS.

B. CMU BLOCK

1. 100% ACRYLIC COATING:

A. BLOCK FILLER: APPLY SHERWIN WILLIAMS OR APPROVED EQUAL HEAVY DUTY LATEX BLOCK FILLER (B42W46) AT A WET FILM THICKNESS OF 18-34 MILS TO DRY TO 10-18 MILS DRY FILM THICKNESS, AT AN EFFECTIVE APPLICATION RATE OF APPROXIMATELY 50-88 SF/GAL.

B. FIRST FINISH COAT: APPLY SHERWIN WILLIAMS OR APPROVED EQUAL SUPERPAINT EXTERIOR LATEX SATIN (A89 SERIES AT A WET FILM THICKNESS OF 4 MILS TO DRY TO 1.44 MILSDRY FILM THICKNESS.

C. SECOND FINISH COAT: APPLY SHERWIN WILLIAMS OR APPROVED EQUAL SUPERPAINT EXTERIOR LATEX SATIN (A89 SERIES) AT A WET FILM THICKNESS

OF 4 MILSTO DRY TO 1.44 MILS DRY FILM THICKNESS.

C. METAL DOORS & FRAMES

FULL GLOSS:

A. PRIMER: APPLY SHERWIN WILLIAMS OR APPROVED EQUAL PRO-CRYL UNIVERSAL PRIMER, (B66-310 SERIES) APPLIES AT 5.0 - 10.0 MILS WET TO ACHIEVE 2.0 - 4.0 MILS DRY FILM THICKNESS.

B. FIRST COAT: APPLY SHERWIN WILLIAMS OR APPROVED EQUAL SHER-CRYL (TM) HPA HIGH PERFORMANCE ACRYLIC GLOSS (B66-300 SERIES), APPLIED AT A WET FILM THICKNESS OF 4 MILS, TO ACHIEVE A DRY FILM THICKNESS OF 1.4.

C. SECOND COAT: APPLY SHERWIN WILLIAMS OR APPROVED EQUAL SHER-CRYL (TM) HIGH PERFORMANCE ACRYLIC GLOSS, (B66-300 SERIES), APPLIED AT A WET FILM THICKNESS OF 4 MILS, TO ACHIEVE A DRY FILM THICKNESS OF 1.4.

BUILDING COLORS:

MAIN BODY COLOR- COLOR TO BE PACER WHITE SW6098. SHERWIN WILLIAMS OR APPROVED EQUAL.

DOORS, & FRAME COLOR- SW2823 ROOKWOOD CLAY SHERWIN WILLIAMS OR APPROVED EQUAL.

ROOF: ENGLERT SERIES S2000 1 3/4" INTEGRAL SNAP-LOCK METAL. COLOR: SILVER METALLIC.

CONSULTANT:

Restroom Building

Glades Park

ARCHITECTS

DRAWING TITLE:

Exterior Elevations

SHEET:

DRAWN: RH CHECKED: CP/CPZ DATE:

SCALE: As indicated PROJECT NO. 1514

AR-300

CHRIS P. ZIMMERMAN, A.I.A. REGISTERED ARCHITECT NO. STATE OF FLORIDA DATE: 03-29-2016



May 17, 2017

Planning and Zoning Department Chris Zimmerman CPZ Architects, Inc 4316 West Broward Boulevard Plantation, FL 33317

Re: Doral Glades Park

Project: Doral Glades Park Site Plan (2016120008) (129)

Location: 9775 NW 74th Street, Doral, FL

Folio#: 35-3008-000-0045/0050

Plans: Plans entitled "Doral Glades Park" prepared by CPZ Architects, Inc. - Architect,

P.A. dated stamped received April 5, 2017, consisting of 116 sheets

Requests: Site plan review for a park consisting of a nature center with approximately 9,678.34 square feet, one beach volleyball court, two basketball courts, and two tennis courts, a 12.5 acre retention lake, a 3.36 acre wetlands preserve, and rental pavilions.

The entire site consists of 21.48 acres.

Dear Mr. Zimmerman,

The Staff of Planning and Zoning and Public Works Departments have reviewed the submitted site plan as a required condition of approval and have granted approval subject to the following conditions.

- 1. Applicant must submit separate plans for Entrance Feature.
- 2. The proposed project shall be built in substantial conformance with the plans entitled "Doral Glades Park" prepared by CPZ Architects, Inc. Architect, P.A. consisting of 116 sheets, dated stamped received April 5, 2017, as amended.
- 3. The Property shall be landscaped in accordance with the landscape plan, prepared by Chen-Moore & Associates., dated stamp received April 5, 2017, as amended, and included with the site plan submittal.
- 4. Trip Generation and/or Traffic Study approval is required.
- 5. The proposed drainage within the park should not be interconnected with the proposed drainage on NW 77 Terrace. Drainage areas should also be kept independent.
- 6. Approval from Division of Environmental Resources Management (DERM) is required prior to site plan approval. If DERMs' requirements result in a modification to the approved administrative site plan, which may include but is not limited to, the layout of proposed parking field, the Applicant will be fully responsible to meet those requirements prior to building permit approval.
- 7. Approval from Miami Dade County Fire Department is required at time of building permit.



- 8. Issuance of this development permit by the City of Doral does not in any way create any right on the part of an Applicant to obtain a permit from a state or federal agency and does not create any liability on the part of the City of Doral for issuance of the permit if the applicant fails to obtain requisite approvals or fulfill the obligations imposed by a state or federal agency or undertakes actions that result in a violation of state or federal law.
- The project should make every effort to incorporate the Low Impact Development (LID) practices in the project design consistent with Section 74-881 of the Land Development Code.
- 10. Project shall meet the City's Green Ordinance requirements in Chapter 63 of the Land Development Code.
- 11. Project shall meet the requirements of the City's Floodplain Management Ordinance. Project team should contact the City's Floodplain Administrator to review the requirements of the Floodplain Management Ordinance.
- 12. The Applicant shall provide a Construction Air Quality Management Plan to the Department prior to the start of construction.
- 13. A Stormwater Pollution Prevention Plan (SPPP) must be submitted by the Applicant at time of building permit. The Plan should provide guidelines for implementing an erosion and sedimentation control program before the site is cleared or graded, including areas where top soil will be removed and contours of slopes will be cleared. The Plan shall also include location and type of erosion control measures, storm water and sediment management systems, and a vegetative plan for temporary and permanent stabilization. The Plan shall remain on-site for the duration of the construction activity.
- 14. All stormwater shall be retained on site in accordance with applicable law.
- 15. All stormwater drainage systems shall be maintained in working conditions at all times in order to avoid localize flooding during and after a storm.
- 16. The Applicant shall preserve existing trees (including native trees) during the development of the project, wherever possible. If the trees must be removed, the Applicant shall be required to mitigate the impact in accordance with DRER requirements. If the relocated trees do not survive, the Applicant shall be required to replace the trees in compliance with DRER requirements.
- 17. All applicable local, state and federal permits must be obtained before commencement of the development.
- 18. The Applicant shall comply with applicable conditions and requirements provided by Miami-Dade County Public Works Department, Water and Sewer Department, Fire Rescue Department, and Regulatory and Economics Resources (DRER) prior to issuance of building permit.



- 19. If more than one (1) acre of land is disturbed during construction the Contractor/Developer is responsible to obtain NPDES Stormwater permit coverage through the Florida Department of Environmental Protection (FDEP) Construction Generic Permit (CGP). If the project is less than one (1) acre, but part of a larger common plan of development or sale that will ultimately disturb one or more acres, permit coverage is also required. Instruction to request and obtain a CGP can be found at: http://www.dep.state.fl.us/water/stormwater/npdes/docs/cgp.pdf. Contractor/Developer should submit the Notice of Intent (NOI) with the appropriate processing fees to the NPDES Stormwater Notices Center. Contractor/Developer must apply for permit coverage at least two (2) days before construction begins.
- 20. Parking shall be prohibited on top of any drainage inlet on drainage manhole.
- 21. The Applicant shall meet the requirements of the Miami-Dade County Water-Use Efficiency Standards Manual, effective January 2009, as may be amended from time to time.
- 22. The hours of operation during the construction shall adhere to as per Noise Ordinance No. 2011-01.
- 23. Noncompliance with the approved site plan and the terms of this approval shall be considered a violation of the City Code.

This letter serves as formal notification that the site plan is not approved until DERM approval is received. If you have any questions or concerns please feel free to contact this office at 305-593-6630.

Sincerely,

Julián H. Pérez, AICP, CFM

Planning and Zoning Director

Cc: Jorge Gomez, P.E, Public Works Director

Michael P. Ferrera, CFM, Development Review Coordinator