### RESOLUTION No. 21-32

A RESOLUTION OF THE MAYOR AND THE CITY COUNCIL OF THE CITY OF DORAL, FLORIDA, APPROVING/DENYING THE SITE PLAN FOR BRIDGEPREP ACADEMY LOCATED AT 3500 NW 89 COURT, DORAL, FLORIDA; PROVIDING FOR IMPLEMENTATION; AND PROVIDING FOR AN EFFECTIVE DATE

WHEREAS, MG3 Doral School, LLC. (the "Applicant") has submitted an Application requesting Mayor and City Council site plan approval pursuant to Section 53-184(f) of the City's Land Development Code (LDC), for BridgePrep Academy, a public charter school, located at 3500 NW 89 Court, Doral, FL 33172, as legally described in "Exhibit A"; and

**WHEREAS,** a zoning workshop was held on December 9, 2020, at which meeting the public was afforded an opportunity to examine the project and provide feedback; and

WHEREAS, after notice of public hearing duly published and notifications of all property owners of record within 500-foot radius, a public hearing was held before the Mayor and City Council of the City of Doral on January 27, 2021, at which hearing all interested persons were afforded the opportunity to be heard; and

WHEREAS, Staff finds that the proposed site plan is consistent with the City's Comprehensive Plan and complies with the requirements and standards of the Land Development Code; and

**WHEREAS**, the Mayor and City Council of the City of Doral find the adoption and implementation of this Resolution is in the best interest and welfare of the residents of the City.

NOW, THEREFORE, BE IT RESOLVED BY THE MAYOR AND CITY COUNCIL
OF THE CITY OF DORAL, FLORIDA, AS FOLLOWS:

<u>Section 1.</u> The above recitals are confirmed, adopted, and incorporated herein and made part hereof by this reference.

<u>Section 2.</u> The City Council hereby approves the site plan for BridgePrep Academy, as legally described in "Exhibit A." The site plan comprises of the new school campus for BridgePrep Academy, a public charter school consisting of grades K-8. A copy of the site plan is provided in "Exhibit B." The approval of the site plan is subject to the following conditions. Violation of the conditions may result in a code compliance citation or the revocation of this Resolution.

- 1. The maximum number of students will be 1,650 subject to the phases and satisfaction of the conditions identified below.
- 2. The student population will be phased in as follows: 650 students maximum in year 1; 975 students maximum in year 2; 1200 students maximum in year 3; 1650 students maximum in year 4.
- 3. The owner will conduct a new Traffic Study and update its Traffic Operations Plan at the end of year 2. The traffic study and operations plan shall be prepared in accordance with applicable industry standards. The report shall be reviewed for any potential impacts by the City's Public Works Department and Miami-Dade County before increasing enrollment from 975 students in year 3.
- 4. The owner will update the Traffic Study and update its Traffic Operations Plan and obtain approval from the City's Public Works Department and Miami-Dade County each year it desires to increase enrollment until it reaches its cap of 1650 students.
- 5. Beginning in year one and for every year thereafter, the school will have three equal shifts, one hour apart, for arrival and dismissal as follows: Shift 1: 7 AM 2:30 PM; Shift 2: 8 AM 3:30 PM; Shift 3: 9 AM 4:30 PM.
- 6. The above shifts may be adjusted by the school operator provided it maintains the one-hour separation between shifts. Any adjustment in shifts must be provided to the City and Miami-Dade County 30-days prior to implementation to allow the City and Miami-Dade County sufficient time to review and approve for any potential impacts.
- 7. No less than sixty days prior to time for the annual renewal of the annual Certificate of Use, the owner shall submit to the Planning and Zoning Department the Traffic Study and update; Traffic Operations Plan and a letter from the principal of the school detailing the number of students and the grade levels that are currently enrolled in said facility.

- 8. That a traffic signal shall be required at NW 33 Street and NW 89 Court at the expense of the school. If not warranted, a 100% contribution shall be required towards the cost of a traffic signal prior to the issuance of the Certificate of Occupancy (CO). A traffic signal shall be required at NW 35 Lane and NW 87 Avenue at the expense of the school. If not warranted, a 50% contribution shall be required towards the cost of a traffic signal prior to the issuance of the CO.
- 9. That prior to issuance of Temporary Certificate of Occupancy (TCO) or Certificate of Occupancy (CO), Miami-Dade County approved plans be submitted for review and approval to the City's Public Works Department for the requirements of new flashers and school zone striping and signage throughout.
- 10. All applicable impact fees shall be paid by the Applicant prior to issuance of a building permit.
- 11. The proposed project shall be built in substantial conformance with the plans entitled "BridgePrep Academy at Doral" prepared by Lorente Architects, consisting of 17 sheets dated stamped received January 7, 2021.
- 12. The Property shall be landscaped in accordance with the landscape plan, prepared by Lorente Architects, dated stamped received January 7, 2021, as amended, and included with the site plan submittal.
- 13. Compliance with Ordinance No. 2015-09, "Public Arts Program" will be required at the time of building permit, if applicable.
- 14. Provide irrigation plans at time of building permit.
- 15. Provide photometric plans at time of building permit.
- 16. Provide compliance with the Floodplain Management regulation (Chapter 23, Article II, Floodplain Management) of the City's Land Development Code.
- 17. Developer shall be responsible for providing the City a certified drainage inspection report prior to the issuance of a certificate of occupancy.
- A Stormwater Pollution Prevention Plan (SWPPP) must be submitted by the Applicant at time of building permit. The Plan should provide guidelines for implementing an erosion and sedimentation control program before the site is cleared or graded, including areas where topsoil will be removed, and contours of slopes will be cleared. The Plan shall also include location and type of erosion control measures, storm water and sediment management systems, and a vegetative plan for temporary and permanent stabilization. The Plan shall remain on-site for the duration of the construction activity.
- 19. If more than one (1) acre of land is disturbed during construction the Contractor/Developer is responsible to obtain NPDES Stormwater permit coverage through the Florida Department of Environmental Protection (FDEP) Construction Generic Permit (CGP). If the project is less than one (1) acre, but part of a larger common plan of development or sale that will ultimately disturb one or more acres, permit coverage is also required. Instruction to request and obtain a CGP can be found at: http://www.dep.state.fl.us/water/stormwater/npdes/docs/cgp.pdf.

- Contractor/Developer should submit the Notice of Intent (NOI) with the appropriate processing fees to the NPDES Stormwater Notices Center. Contractor/Developer must apply for permit coverage at least two (2) days before construction begins.
- 20. The Applicant shall preserve existing trees (including native trees) during the development of the project, wherever possible. If the trees must be removed, the Applicant shall be required to mitigate the impact in accordance with DRER requirements. If the relocated trees do not survive, the Applicant shall be required to replace the trees in compliance with DRER requirements.
- 21. The hours of operation during the construction shall adhere to as per Noise Ordinance No. 2011-01.
- 22. Approval from Division of Environmental Resources Management (DERM) is required at time of building permit. If DERM's requirements result in a modification to the approved administrative site plan, which may include but is not limited to, the layout of proposed parking field, the Applicant will be fully responsible to meet those requirements prior to building permit approval.
- 23. Approval from Miami-Dade County Fire Department is required at time of building permit.
- 24. All applicable local, state and federal permits must be obtained before commencement of the development.
- 25. Issuance of this development permit by the City of Doral does not in any way create any right on the part of an Applicant to obtain a permit from a state or federal agency and does not create any liability on the part of the City of Doral for issuance of the permit if the applicant fails to obtain requisite approvals or fulfill the obligations imposed by a state or federal agency or undertakes actions that result in a violation of state or federal law.
- 26. Noncompliance with the approved site plan and the terms of this approval shall be considered a violation of the City Code. Penalties for such violation(s) shall be prescribed by the City Code, which include, but are not limited to, the revocation of the approval granted by this Resolution.
- 27. Applicant shall comply with any other outstanding conditions recommended by the Mayor and City Council, Public Works Department, Planning & Zoning Department or Miami-Dade County.

Section 3. The City Manager or his/her designee are hereby authorized to take such action as may be necessary to implement the purpose and provisions of this Resolution.

**Section 4.** The Resolution shall take effect immediately upon adoption.

The foregoing Resolution was offered by Vice Mayor Cabrera who moved its adoption.

The motion was seconded by Councilmember Mariaca and upon being put to a vote, the vote was as follows:

Mayor Juan Carlos Bermudez	Yes
Vice Mayor Pete Cabrera	Yes
Councilwoman Digna Cabral	Yes
Councilwoman Claudia Mariaca	Yes
Councilman Oscar Puig-Corve	Yes

PASSED AND ADOPTED this 27 day of January, 2021.

JUAN CARLOS BERMUDEZ, MAYOR

ATTEST:

CONNIE DIAZ, MMC

CITY CLERK

APPROVED AS TO FORM AND LEGAL SUFFICIENCY FOR THE USE AND RELIANCE OF THE CITY OF DORAL ONLY:

LUIS FIGUEREDO, ESQ.

CITY ATTORNEY

## **EXHIBIT "A"**

### Exhibit A


### <u>Legal description for the subject property</u>:


Lots 8, 9 and 13 of Block 1, of "WestPointe Business Park" according to the Plat thereof, as recorded in Plat Book 147 at Page 25 of the Public Records of Miami-Dade County, Florida, LESS the West 290.67 feet of Lot 13 containing 6.09 Acres more or less.

## EXHIBIT "B"

\_lorente **Architects** 13421 SOUTHWEST 23 STREET MIAMI, FL. 33175 . (305) 525-2370

A100 2 of 46

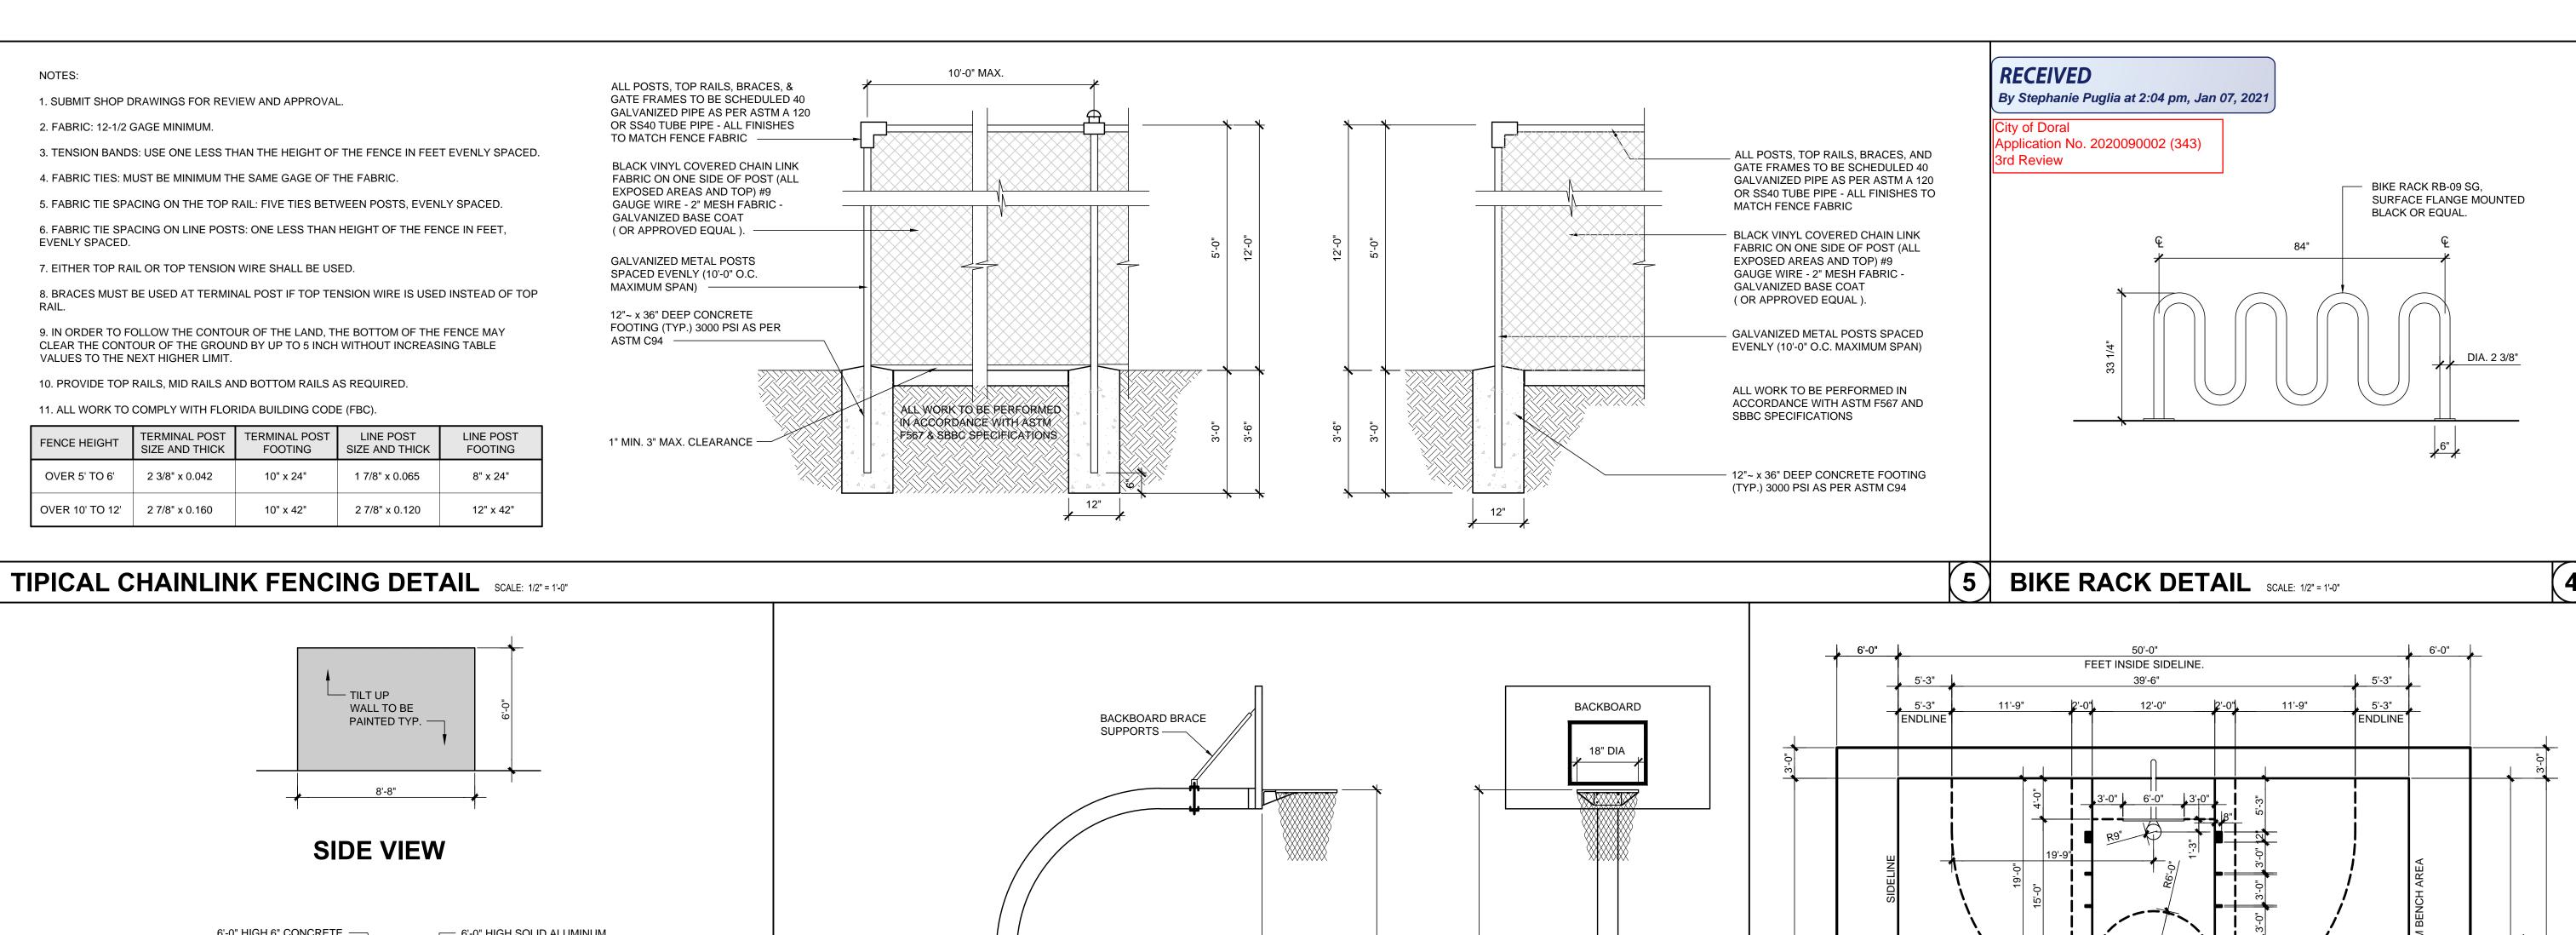

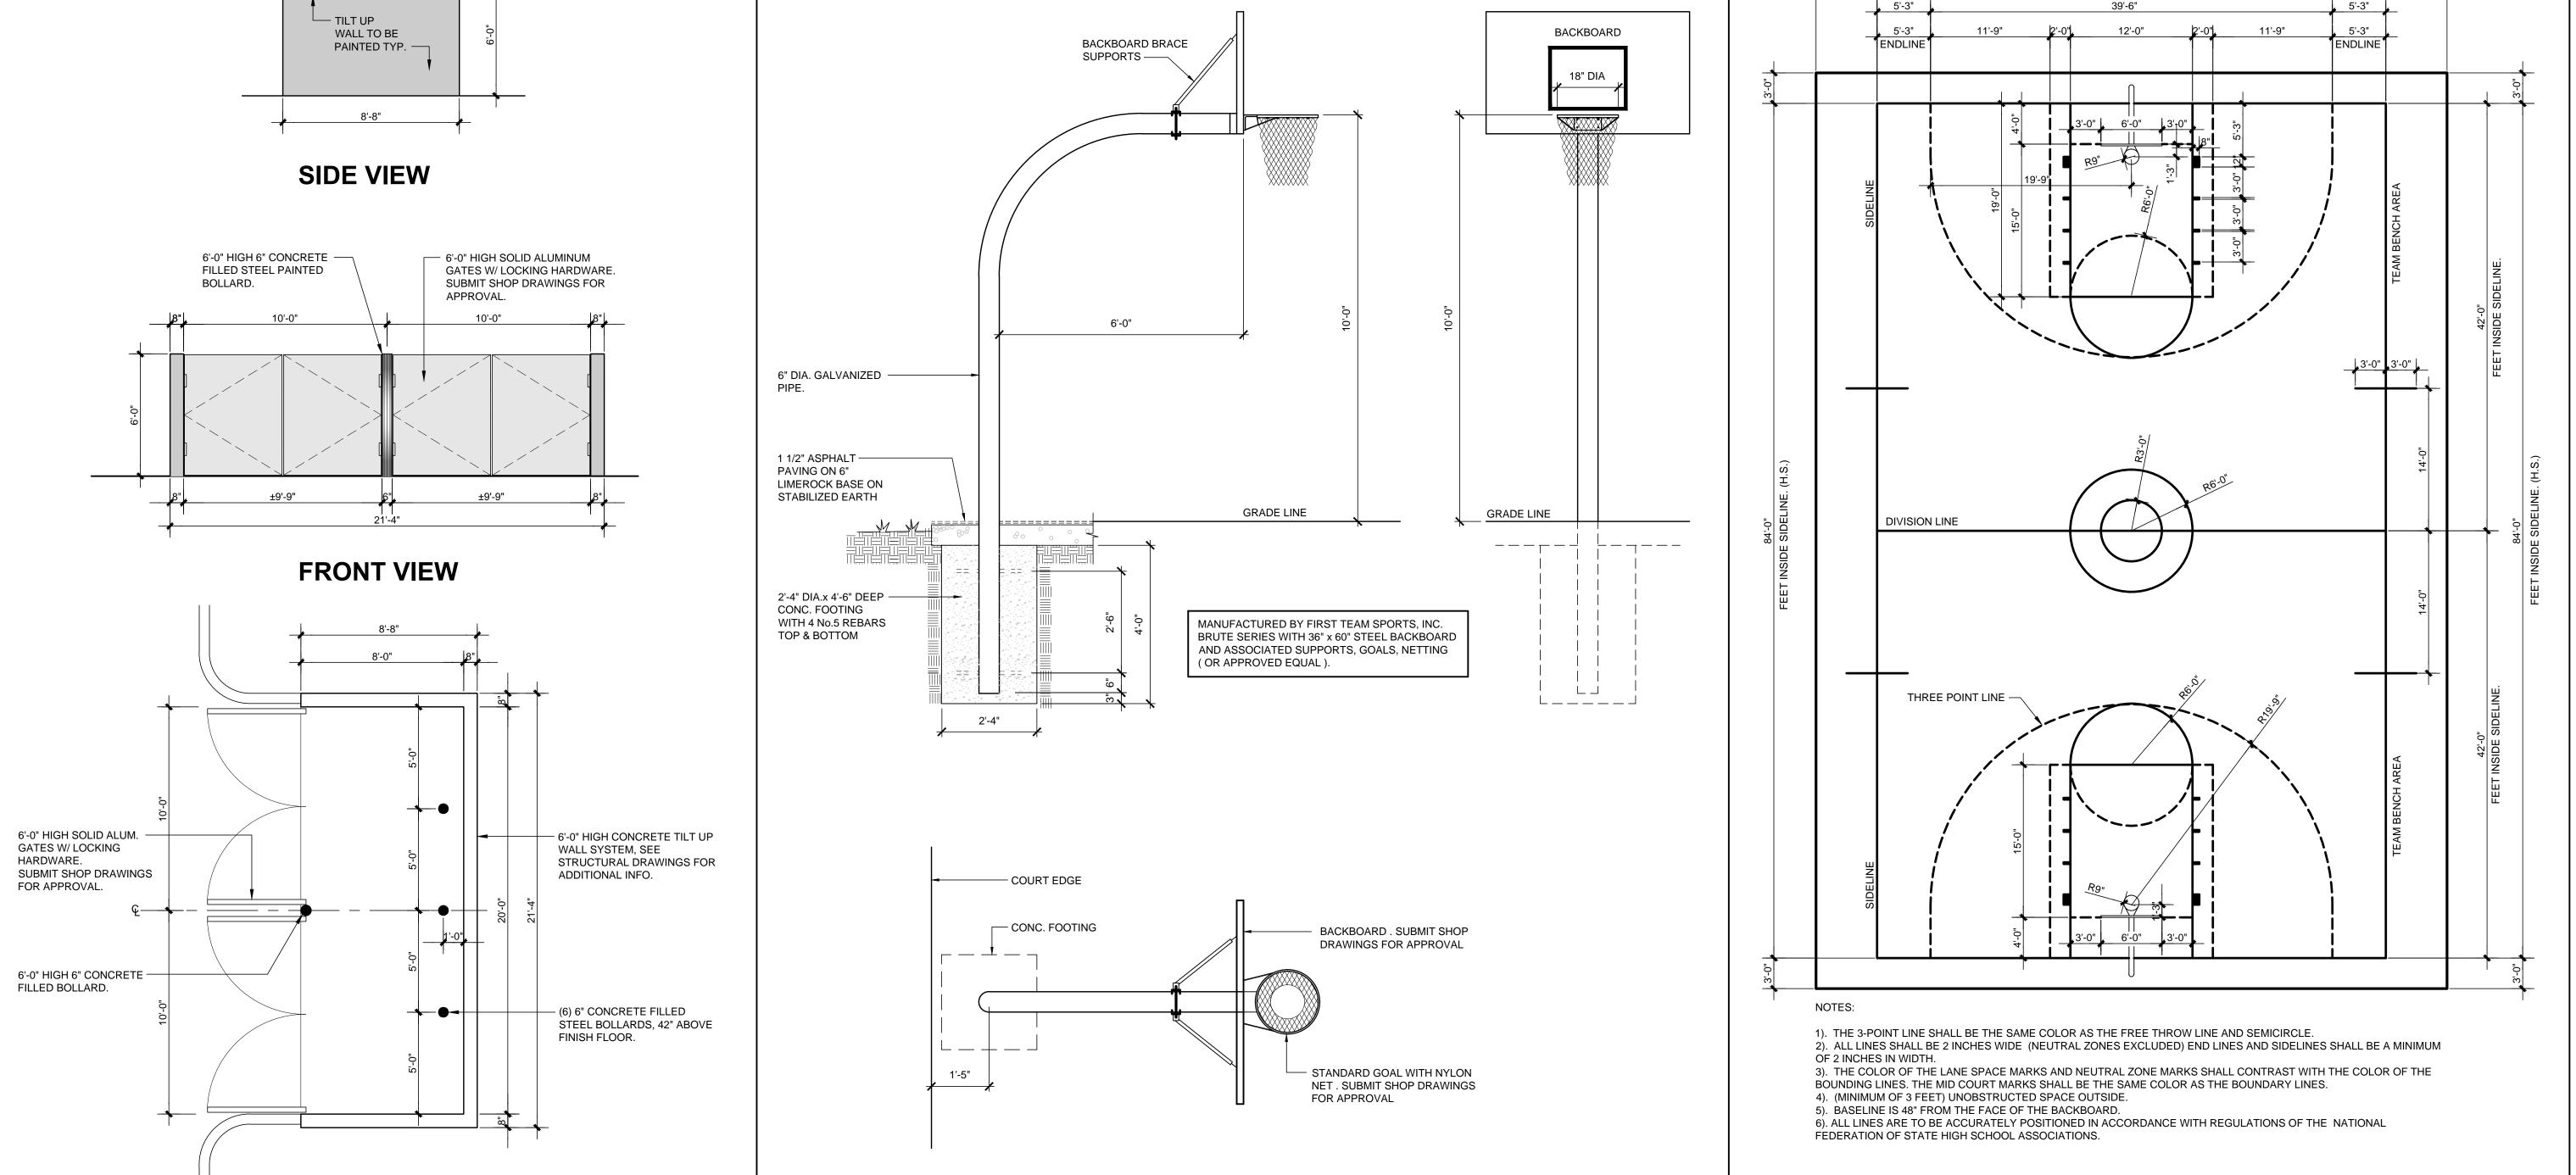

BASKETBALL BACKBOARD DETAIL SCALE: 1/2" = 1'-0"

DUMPSTER ENCLOSURE PLAN DETAIL SCALE: 1/4" = 1'-0"

DELIVERY DATE:

01.04.2021

DRAWN BY:

J.B.

CHECKED BY:

A.LL.

REF NUMBER:

Llorente

**Architects** 

13421 SOUTHWEST 23 STREET

MIAMI, FL. 33175 . (305) 525-2370

AA-26002273

IN ASSOCIATION WITH:

PROFESSIONAL SEAL:

AR-0012031

**BRIDEPREP** 

**ACADEMY** 

AT DORAL

3500 NW 89th COURT

DORAL, FLORIDA 33172

DATE ISSUE DESCRIPTION


DRAWING INFORMATION:

SHEET TITLE:
SITE DETAILS

PROJECT:

 $\frac{A100.1}{3 \text{ of } 46}$ 

BASKETBALL COURT STRIPING DETAIL SCALE: 3/16" = 1'-0"

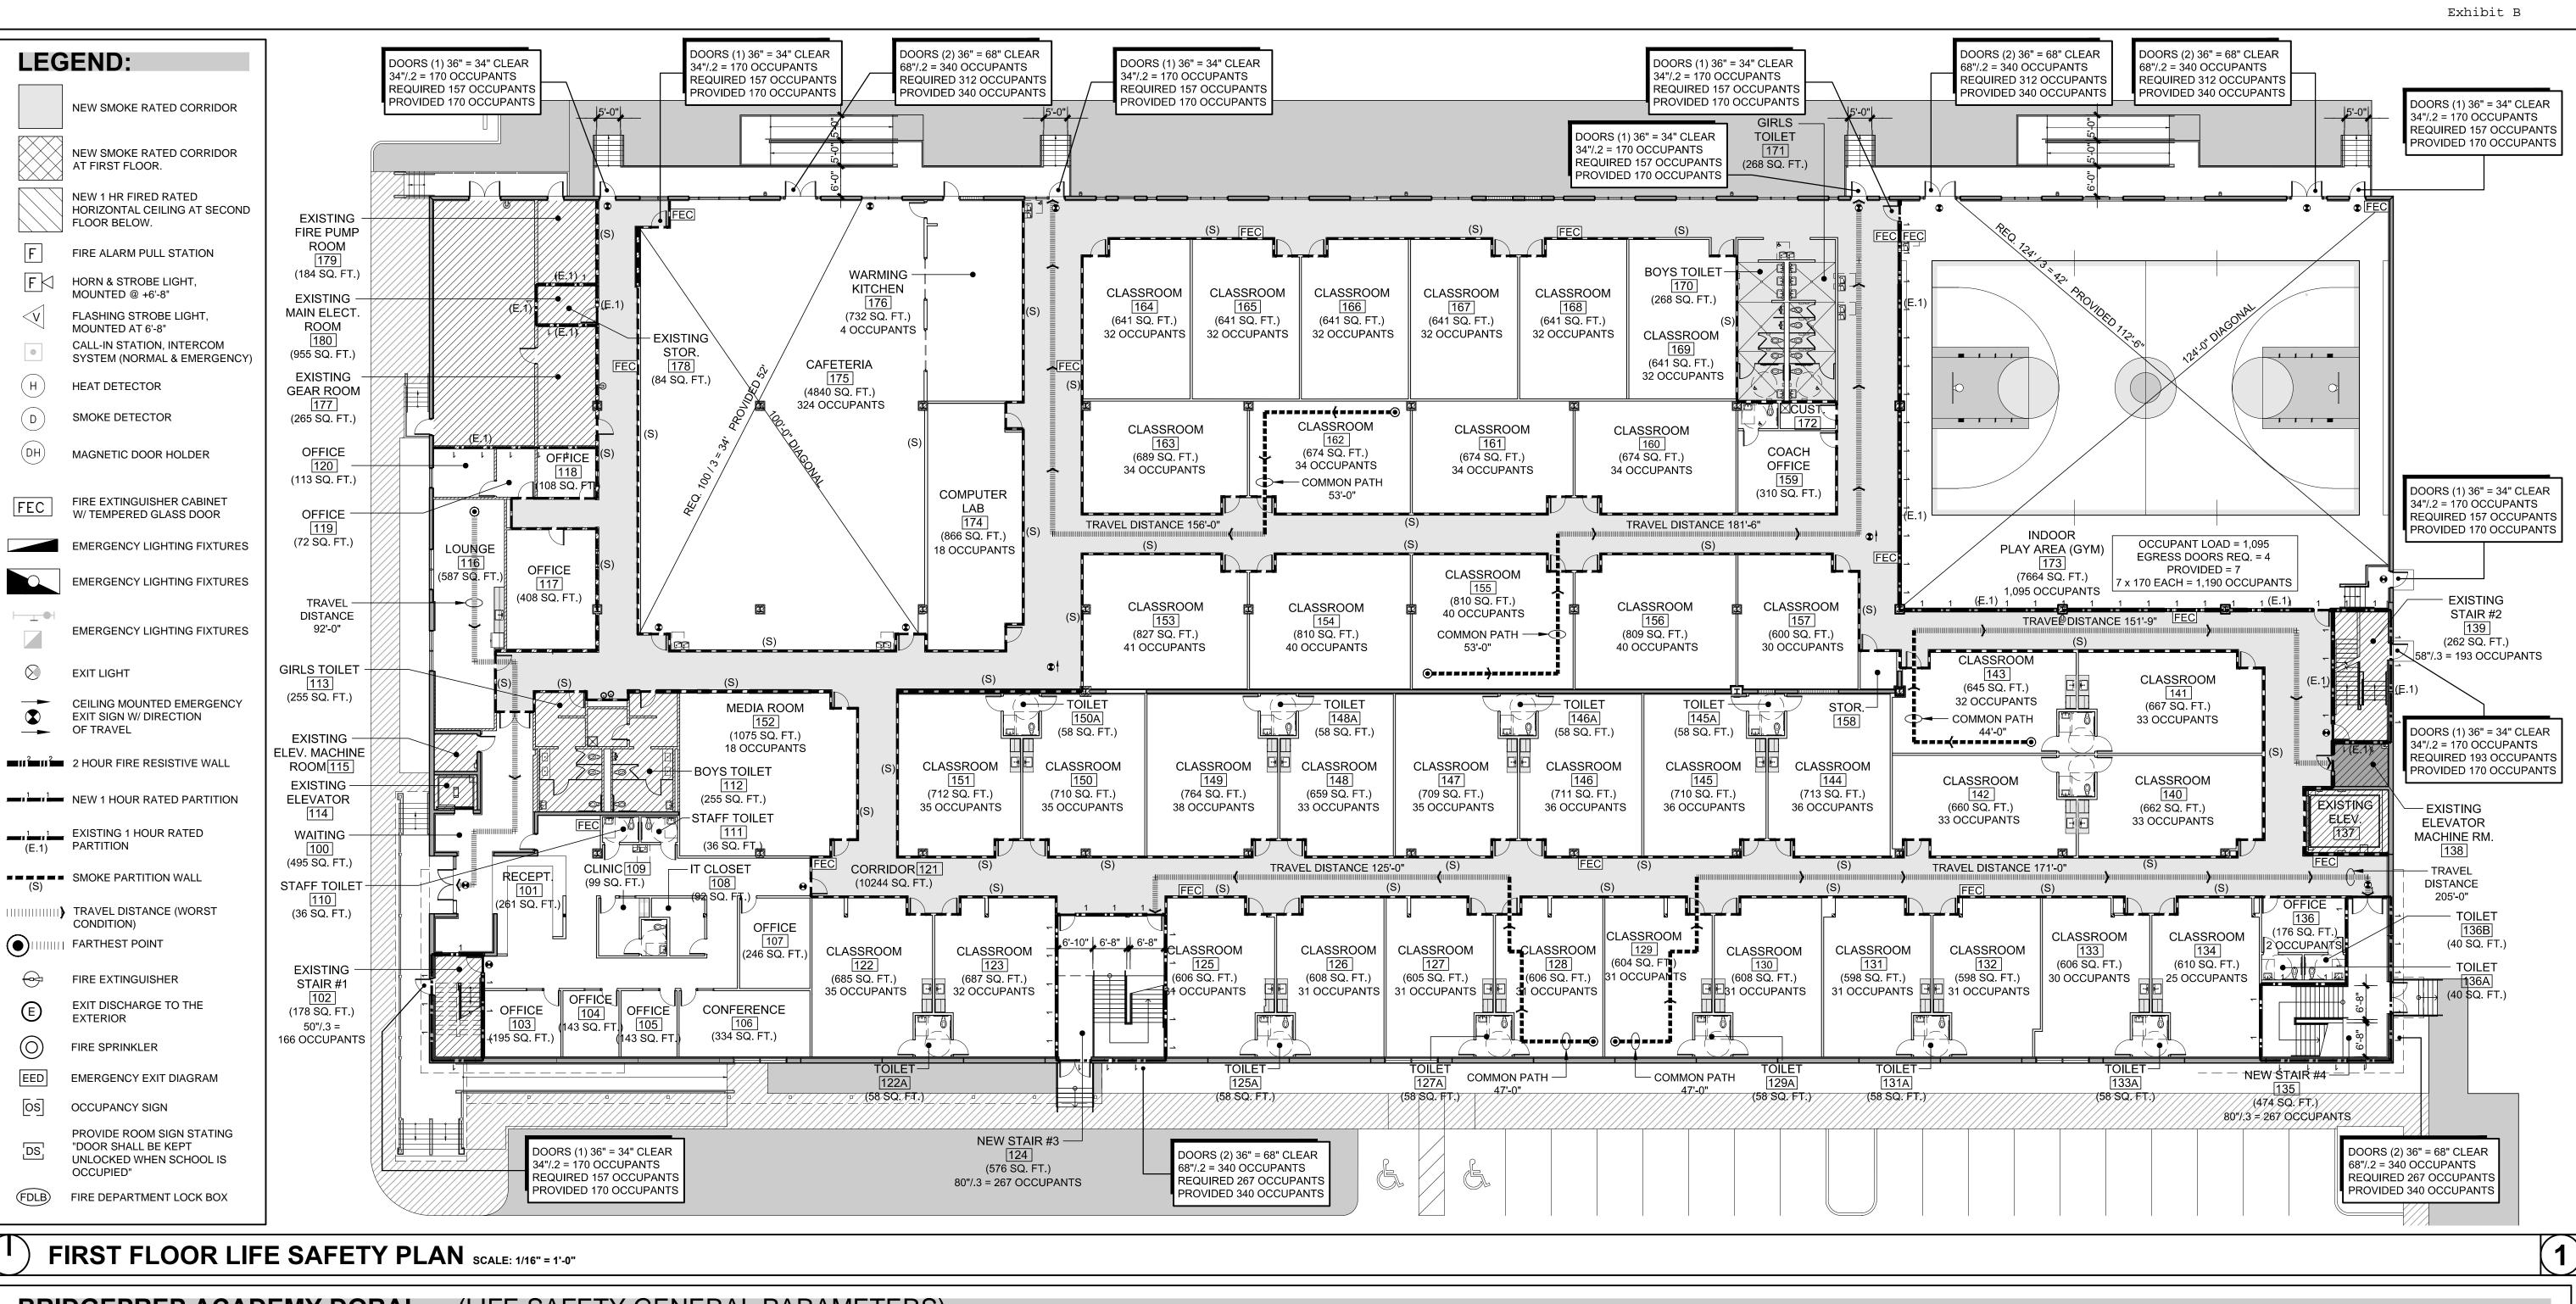

PROJECT: **BRIDEPREP ACADEMY** 

Alberto Llorente

AR-0012031

PROFESSIONAL SEAL:

Architects

13421 SOUTHWEST 23 STREET

MIAMI, FL. 33175 . (305) 525-2370

AA-26002273

IN ASSOCIATION WITH:

AT DORAL 3500 NW 89th COURT DORAL, FLORIDA 33172

DATE ISSUE DESCRIPTION

DRAWING INFORMATION:

SHEET TITLE: FIRST FLOOR LIFE SAFETY PLAN

DELIVERY DATE: 01.04.2021 DRAWN BY CHECKED BY

A101 4 of 46

REF NUMBER

BRIDGEPREP ACADEMY DORAL (LIFE SAFETY GENERAL PARAMETERS)

	PLICABLE CODES (INCLUDING BUT NOT LIMITED TO)
	B. FLORIDA BUILDING CODE (FBC) 2017 EDITION
	C. FLORIDA FIRE PREVENTION CODE (FFPC) 2017 6TH EDITION
2. Bl	ILDING CLASSIFICATION OF OCCUPANCY & HAZARD CONTENT
	A. EXISTING BUILDING BUSINESS/FACTORY/STORAGE
	B. PROPOSED BUILDING EDUCATION GROUP E
	FBC CHAPTER 3-SECTION 305 EDUCATIONAL GROUP E
	C. FULLY SPRINKLERED BUILDING IN COMPLIANCE WITH FBC 903.3.1.1
3. Bl	ILDING CONSTRUCTION TYPE
	A. EXISTING CONSTRUCTION FBC TYPE II-A
	B. PROPOSED CONSTRUCTION FBC TYPE II-A
	C. FULLY SPRINKLED BUILDING IN COMPLIANCE WITH FBC 903.3.1.1
4. AL	LOWABLE BUILDING HEIGHT IN FEET ABOVE GRADE PLANE (FBC TABLE 504.3)
	A. ALLOWED: 85 FEET / ABOVE GRADE PLANE
	B. PROVIDED: 58 FEET / ABOVE GRADE PLANE
5. AL	LOWABLE NUMBER OF STORIES ABOVE GRADE PLANE (FBC TABLE 504.4)
	A. ALLOWED: 4 STORIES
	B. PROVIDED: 3 STORIES
6. AL	LOWABLE AREA FACTOR IN SQUARE FEET (FBC TABLE 506.2)
	A. ALLOWED AREA 79,500 SF.
	A. ALLOWED AREA 79,500 SF. B. PROVIDED BUILDING AREA 65,620 SF.
7. CC	·
7. CC	B. PROVIDED BUILDING AREA 65,620 SF.
7. CC	B. PROVIDED BUILDING AREA 65,620 SF.  MMON PATH OF EGRESS TRAVEL FBC (TABLE 1006.2.1)  A. THE COMMON PATH OF EGRESS TRAVEL SHALL NOT EXCEED 75 FEET FULLY SPRINKLED BUILDING IN COMPLIANCE WITH FBC 903.3.1.1
7. CC	B. PROVIDED BUILDING AREA 65,620 SF.  MMON PATH OF EGRESS TRAVEL FBC (TABLE 1006.2.1)  A. THE COMMON PATH OF EGRESS TRAVEL SHALL NOT EXCEED 75 FEET
	B. PROVIDED BUILDING AREA 65,620 SF.  MMON PATH OF EGRESS TRAVEL FBC (TABLE 1006.2.1)  A. THE COMMON PATH OF EGRESS TRAVEL SHALL NOT EXCEED 75 FEET FULLY SPRINKLED BUILDING IN COMPLIANCE WITH FBC 903.3.1.1
	B. PROVIDED BUILDING AREA 65,620 SF.  MMON PATH OF EGRESS TRAVEL FBC (TABLE 1006.2.1)  A. THE COMMON PATH OF EGRESS TRAVEL SHALL NOT EXCEED 75 FEET FULLY SPRINKLED BUILDING IN COMPLIANCE WITH FBC 903.3.1.1  B. FFPC TABLE A.7.6: THE COMMON PATH OF EGRESS TRAVEL SHALL NOT EXCEED 100 FEET
	B. PROVIDED BUILDING AREA 65,620 SF.  MMON PATH OF EGRESS TRAVEL FBC (TABLE 1006.2.1)  A. THE COMMON PATH OF EGRESS TRAVEL SHALL NOT EXCEED 75 FEET FULLY SPRINKLED BUILDING IN COMPLIANCE WITH FBC 903.3.1.1  B. FFPC TABLE A.7.6: THE COMMON PATH OF EGRESS TRAVEL SHALL NOT EXCEED 100 FEET  AXIMUM DEAD END CORRIDOR FBC 1020.4.2
	B. PROVIDED BUILDING AREA 65,620 SF.  MMON PATH OF EGRESS TRAVEL FBC (TABLE 1006.2.1)  A. THE COMMON PATH OF EGRESS TRAVEL SHALL NOT EXCEED 75 FEET FULLY SPRINKLED BUILDING IN COMPLIANCE WITH FBC 903.3.1.1  B. FFPC TABLE A.7.6: THE COMMON PATH OF EGRESS TRAVEL SHALL NOT EXCEED 100 FEET AXIMUM DEAD END CORRIDOR FBC 1020.4.2  A. SHALL NOT EXCEED 50 FEET
8. MA	B. PROVIDED BUILDING AREA 65,620 SF.  MMON PATH OF EGRESS TRAVEL FBC (TABLE 1006.2.1)  A. THE COMMON PATH OF EGRESS TRAVEL SHALL NOT EXCEED 75 FEET FULLY SPRINKLED BUILDING IN COMPLIANCE WITH FBC 903.3.1.1  B. FFPC TABLE A.7.6: THE COMMON PATH OF EGRESS TRAVEL SHALL NOT EXCEED 100 FEET AXIMUM DEAD END CORRIDOR FBC 1020.4.2  A. SHALL NOT EXCEED 50 FEET FULLY SPRINKLED BUILDING IN COMPLIANCE WITH FBC 903.3.1.1
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C. FOUR EXITS ARE REQUIRED FOR SPACES THAT EXCEED 1000 OCCUPANTS 11. FIRE-RESISTANT RATING REQUIREMENTS FOR BUILDING ELEMENT FBC TABLE 601 A. FULLY SPRINKLED BUILDING IN COMPLIANCE WITH FBC 903.3.1.1 REQUIRED: PROVIDED: B. PRIMARY STRUCTURAL FRAME 1-HR C. BEARING WALLS **EXTERIOR** 1-HR 1-HR INTERIOR 1-HR D. NON BEARING WALLS AND PARTITIONS E. FLOOR CONSTRUCTION INCLUDING SUPPORTING BEAMS AND JOISTS 1-HR 1-HR F. ROOF CONSTRUCTION INCLUDING SUPPORTING BEAMS AND JOISTS 1-HR 1-HR 12. CORRIDOR FIRE RESSISTANCE RATING FBC TABLE 1020.1 A. REQUIRED FIRE RATING 0-HR FULLY SPRINKLED BUILDING IN COMPLIANCE WITH FBC 903.3.1.1 13. INTERIOR WALLS AND CEILING FINISHES REQUIREMENT BY OCCUPANCY FBC (TABLE 803.11) A. FULLY SPRINKLED BUILDING IN COMPLIANCE WITH FBC 903.3.1.1 INTERIOR EXIT STAIRWAYS AND EXIT PASSAGE CORRIDOR

A. TWO EXITS ARE REQUIRED FOR SPACES THAT EXCEED 49-500 OCCUPANTS

B. THREE EXITS ARE REQUIRED FOR SPACES THAT EXCEED 501-1000 OCCUPANTS

10. EXIT AND EXIT ACCESS DOORWAYS FBC TABLE 1006.3.1

ROOMS AND ENCLOSED SPACES 14. MAXIMUM FLOOR AREA ALLOWANCES PER OCCUPANT FBC CHAPTER 10 AND NFPA 101

FLOOR			
		FLOOR AREA / SQ.	
FUNCTION OF SPACE	SQ. FT.	FT. PER OCCUPANT	OCCUPANT LOA
CLASSROOMS	26,053	1 PER 20	1303
MEDIA CENTER	1,075	1 PER 50	22
LABS	866	1 PER 50	17
OFFICES	2,622	1 PER 100	27
GYMNASIUM	7,664	1 PER 7	1095
CAFETERIA/DINING ROOM	4,840	1 PER 15	323
STAFF DINING (LOUNGE)	587	1 PER 15	39
KITCHEN	732	1 PER 200	4
ELECTRICAL / MECHANICAL ROOMS	1,139	N/A	0
CIRCULATION/WALLS/PARTITIONS/TOILETS	19,858	N/A	N/A
	65,436	N/A	2831
	FUNCTION OF SPACE CLASSROOMS MEDIA CENTER LABS OFFICES GYMNASIUM CAFETERIA/DINING ROOM STAFF DINING (LOUNGE) KITCHEN ELECTRICAL / MECHANICAL ROOMS	FUNCTION OF SPACE  CLASSROOMS  MEDIA CENTER  LABS  OFFICES  GYMNASIUM  CAFETERIA/DINING ROOM  STAFF DINING (LOUNGE)  KITCHEN  ELECTRICAL / MECHANICAL ROOMS  CIRCULATION/WALLS/PARTITIONS/TOILETS  SQ. FT.  SQ. FT.  SQ. FT.  SQ. FT.  26,053  866  2622  2622  4866  27622  587  587  KITCHEN  732  ELECTRICAL / MECHANICAL ROOMS  1,139  CIRCULATION/WALLS/PARTITIONS/TOILETS  19,858	FLOOR AREA / SQ. FT. FT. PER OCCUPANT CLASSROOMS 26,053 1 PER 20 MEDIA CENTER 1,075 1 PER 50 LABS 866 1 PER 50 OFFICES 2,622 1 PER 100 GYMNASIUM 7,664 1 PER 7 CAFETERIA/DINING ROOM 4,840 1 PER 15 STAFF DINING (LOUNGE) 587 1 PER 15 KITCHEN 732 1 PER 200 ELECTRICAL / MECHANICAL ROOMS 1,139 N/A CIRCULATION/WALLS/PARTITIONS/TOILETS 19,858 N/A

B. CORRIDORS (.2 PER OCCUPANT) PROVIDED: 89" REQUIRED: 72" C. STAIRS (.3 PER OCCUPANT) REQUIRED: 2832 X .3" PER OCCUPANT = 850" PROVIDED: 948" 15.2 SECOND FLOOR FLOOR AREA / SQ. FT. PER OCCUPANT OCCUPANT LOAD **FUNCTION OF SPACE** CLASSROOMS 16,470 1 PER 20 824

PROVIDED: 612"

617

OFFICES 552 1 PER 100 OPEN SPACE 38,944 CIRCULATION/WALLS/PARTITIONS/TOILETS 9,470 N/A TOTALS 65,436 15.2. SECOND FLOOR EGRESS WIDTH PER OCCUPANT SERVED FBC TABLE 1005.1

A. DOORS (.2 PER OCCUPANT) REQUIRED: 830 OCCUPANTS X .2" PER OCCUPANT = 166" PROVIDED: 204"

15.1 FIRST FLOOR EGRESS WIDTH PER OCCUPANT SERVED FBC TABLE 1005.1

(2) 36" DOOR WIDTH: (68" CLEAR OPENING)/.2 OCCUPANTS = 340 OCCUPANTS

REQUIRED: 2832 OCCUPANTS X.2" PER OCCUPANT = 567"

A. DOORS (.2 PER OCCUPANT)

**TOTALS** 

(6) 36" DOOR WIDTH: (34" CLEAR OPENING)/.2 OCCUPANTS = 1,020 OCCUPANTS B. CORRIDORS (.2 PER OCCUPANT) REQUIRED: 72" PROVIDED: 89" C. STAIRS (.3 PER OCCUPANT) REQUIRED: 830" X .3" PER OCCUPANT 249" PROVIDED: 268"

15.3 THIRD FLOOR FLOOR AREA / SQ. **FUNCTION OF SPACE** FT. PER OCCUPANT OCCUPANT LOAD CLASSROOMS 12,255 1 PER 20 614 OFFICES 1 PER 100 313 ELECTRICAL / MECHANICAL ROOMS 506 N/A 1 PER 300 OPEN SPACE 12,723 N/A N/A CIRCULATION/WALLS/PARTITIONS/TOILETS 9,136 N/A N/A

34,933

N/A

15.3. THIRD FLOOR EGRESS WIDTH PER OCCUPANT SERVED FBC TABLE 1005.1 A. DOORS (.2 PER OCCUPANT) REQUIRED: 617 OCCUPANTS X .2" PER OCCUPANT = 124" (2) 36" DOOR WIDTH: (68" CLEAR OPENING)/.2 OCCUPANTS = 340 OCCUPANTS B. CORRIDORS (.2 PER OCCUPANT)

**REQUIRED: 72"** C. STAIRS (.3 PER OCCUPANT)

PROVIDED: 89" REQUIRED: 617 X .3" PER OCCUPANT = 186" PROVIDED: 268"

PROVIDED: 204"

16. FIRE EXTINGUISHER REQUIREMENT CORRIDORS: MAXIMUM DISTANCE TO FIRE EXTINGUISHER SHALL NOT EXCEED 75 FEET

A. ALL FLOOR SURFACES WHICH MAY BECOME SLIPPERY SHALL HAVE A NON-SLIP IMPERVIOUS FLOORING B. ALL WINDOWS/ STOREFRONTS ADJACENT TO DOORS SHALL BE CATEGORY II GLAZING IN COMPLIANCE WITH FBC.


18. MINIMUM NUMBER OF REQUIRED TOILET FIXTIURES FBC PLUMBING CODE TABLE 403.1 A. GRADES K-2 24 CLASSROOMS @ 18 STUDENTS PER CLASSROOM = 432 STUDENTS / 50 = 9 UNISEX REQUIRED = 11 UNISEX PROVIDED B. STUDENT TOILET TOTAL CAPACITY BASED ON ACTUAL STUDENTS IN CLASSROOM K-2 = (18 STUDENTS)

3-8 = (22 STUDENTS)TOTAL OCCUPANT LOAD = 1,548 STUDENTS (774 MALES / 774 FEMALES) LOAD FACTOR REQUIRED

	MALE	FEMALE	MALE	FEMALE	MALE	FEMALE
WATER CLOSETS	1 PER 50	1 PER 50	16	16	19	19
	LOAD FACTOR R		REQUIRED		PROVIDED	
	MALE	FEMALE	MALE	FEMALE	MALE	FEMALE
AVATORIES	1 PER 50	1 PER 50	16	16	20	20
	LOAD FACTOR		REQUIRED		PROVIDED	
DRINKING FOUNTAINS	1 PER 100		20		20	
	LOAD FACTOR		REQUIRED		PROVIDED	
SERVICE SINK	1		1		4	
OFFICE AND STAFE	TOTAL CADA	CITY OF OCCUPANTS				

C. OFFICES AND STAFF TOTAL CAPACITY 90 OCCUPANTS
TOTAL OCCUPANT LOAD = 90 STAFF (45 MALES / 45 FEMALES)

	LOAD FACT	OR	REQUIR	RED	PROVIDE	D
	MALE	FEMALE	MALE	FEMALE	MALE	FEMALE
WATER CLOSETS	1 PER 25 FIF	RST 50	2	2	4	4
	LOAD FACT	OR	REQUIF	RED	PROVIDE	D
	MALE	FEMALE	MALE	FEMALE	MALE	FEMALE
LAVATORIES	1 PER 40 FIF	RST 80	2	2	4	4

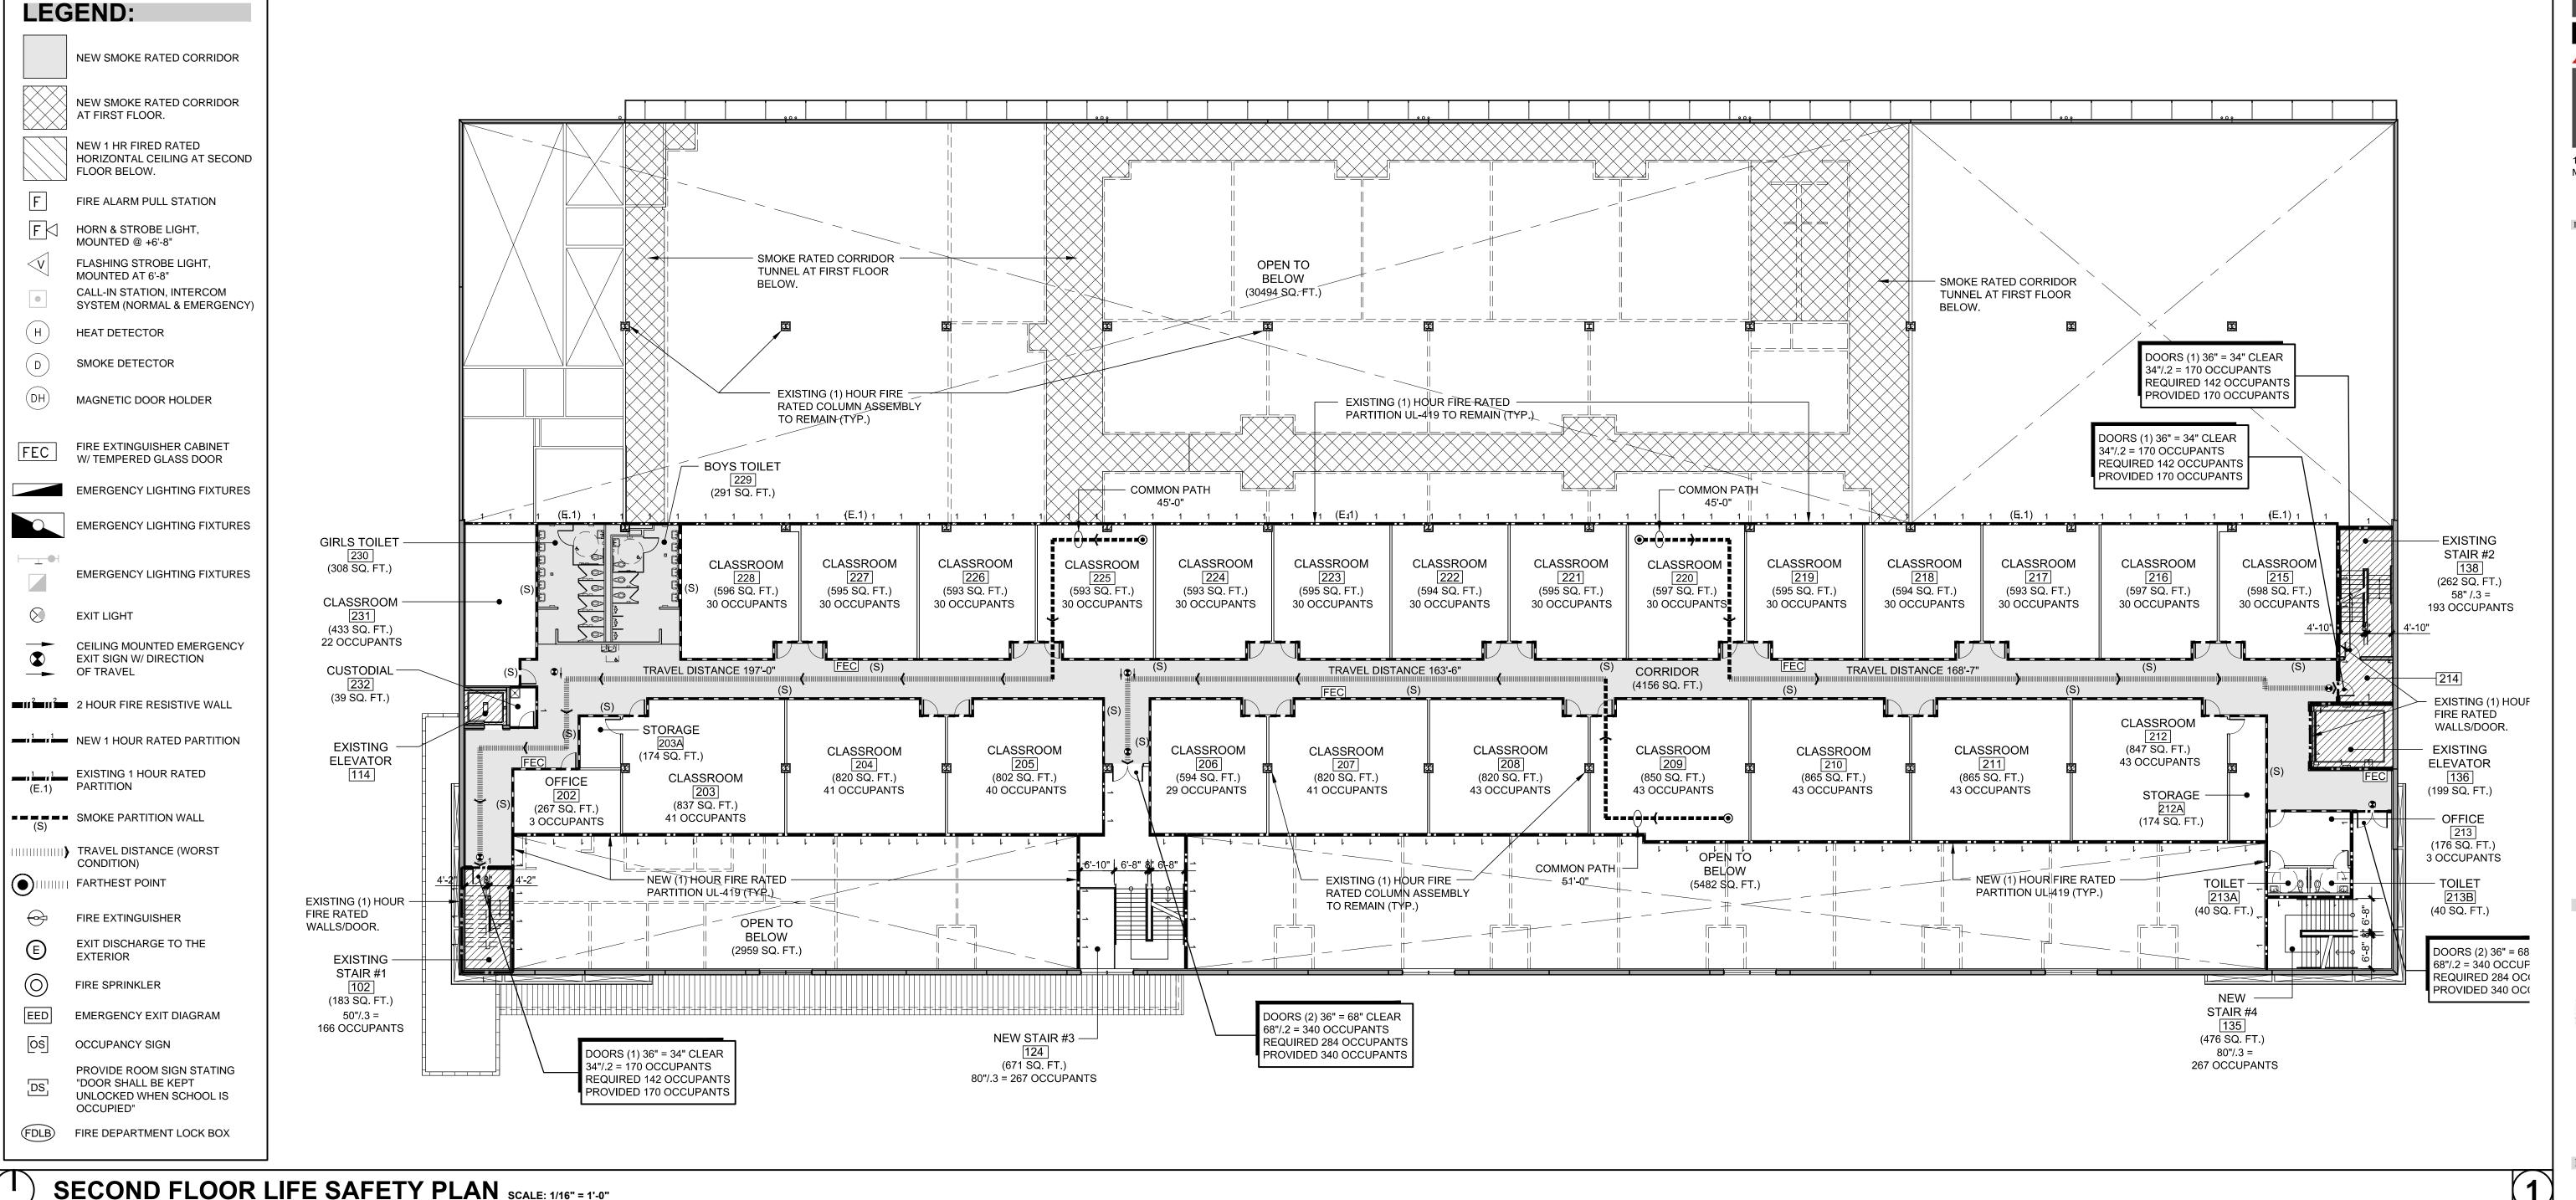



IN ASSOCIATION WITH:

PROFESSIONAL SEAL:



Alberto Llorente AR-0012031

PROJECT:

**BRIDEPREP ACADEMY** AT DORAL

3500 NW 89th COURT DORAL, FLORIDA 33172

DATE ISSUE DESCRIPTION

DRAWING INFORMATION:

SECOND FLOOR LIFE SAFETY PLAN

DELIVERY DATE: 01.04.2021 DRAWN BY:

A102

CHECKED BY

REF NUMBER

ETY GENERAL PARAMETERS) 10. EXIT AND EXIT ACCESS DOORWAYS FBC TABLE 1006.3.1

BRIDGEPREP ACADEMY DORAL (LIFE SAFE	_
1. APPLICABLE CODES (INCLUDING BUT NOT LIMITED TO)  B. FLORIDA BUILDING CODE (FBC) 2017 EDITION  C. FLORIDA FIRE PREVENTION CODE (FFPC) 2017 6TH EDITION	
2. BUILDING CLASSIFICATION OF OCCUPANCY & HAZARD CONTENT  A. EXISTING BUILDING BUSINESS/FACTORY/STORAGE  B. PROPOSED BUILDING EDUCATION GROUP E  FBC CHAPTER 3-SECTION 305 EDUCATIONAL GROUP E  C. FULLY SPRINKLERED BUILDING IN COMPLIANCE WITH FBC 903.3.1.1	
3. BUILDING CONSTRUCTION TYPE  A. EXISTING CONSTRUCTION FBC TYPE II-A  B. PROPOSED CONSTRUCTION FBC TYPE II-A  C. FULLY SPRINKLED BUILDING IN COMPLIANCE WITH FBC 903.3.1.1	
4. ALLOWABLE BUILDING HEIGHT IN FEET ABOVE GRADE PLANE (FBC TABLE 504.3)  A. ALLOWED: 85 FEET / ABOVE GRADE PLANE  B. PROVIDED: 58 FEET / ABOVE GRADE PLANE	
5. ALLOWABLE NUMBER OF STORIES ABOVE GRADE PLANE (FBC TABLE 504.4) A. ALLOWED: 4 STORIES B. PROVIDED: 3 STORIES	
6. ALLOWABLE AREA FACTOR IN SQUARE FEET (FBC TABLE 506.2)  A. ALLOWED AREA 79,500 SF.  B. PROVIDED BUILDING AREA 65,620 SF.	
7. COMMON PATH OF EGRESS TRAVEL FBC (TABLE 1006.2.1)  A. THE COMMON PATH OF EGRESS TRAVEL SHALL NOT EXCEED 75 FEET FULLY SPRINKLED BUILDING IN COMPLIANCE WITH FBC 903.3.1.1  B. FFPC TABLE A.7.6: THE COMMON PATH OF EGRESS TRAVEL SHALL NOT EXCEED 100 FEET	
8. MAXIMUM DEAD END CORRIDOR FBC 1020.4.2  A. SHALL NOT EXCEED 50 FEET  FULLY SPRINKLED BUILDING IN COMPLIANCE WITH FBC 903.3.1.1  B. FFPC TABLE A.7.6: THE DEAD END CORRIDOR SHALL NOT EXCEED 50 FEET	
9. EXIT ACCESS TRAVEL DISTANCE FBC (TABLE 1017.2) A. TRAVEL DISTANCE SHALL NOT EXCEED 250 FEET	

FULLY SPRINKLED BUILDING IN COMPLIANCE WITH FBC 903.3.1.1

B. FFPC TABLE A.7.6: TRAVEL DISTANCE SHALL NOT EXCEED 200 FEET

A. TWO EXITS ARE REQUIRED FOR SPACES THAT EXCEED 49-500 OCCUPANTS B. THREE EXITS ARE REQUIRED FOR SPACES THAT EXCEED 501-1000 OCCUPANTS

C. FOUR EXITS ARE REQUIRED FOR SPACES THAT EXCEED 1000 OCCUPANTS 11. FIRE-RESISTANT RATING REQUIREMENTS FOR BUILDING ELEMENT FBC TABLE 601

A. FULLY SPRINKLED BUILDING IN COMPLIANCE WITH FBC 903.3.1.1 REQUIRED: PROVIDED: B. PRIMARY STRUCTURAL FRAME 1-HR C. BEARING WALLS **EXTERIOR** 1-HR INTERIOR 1-HR D. NON BEARING WALLS AND PARTITIONS E. FLOOR CONSTRUCTION INCLUDING SUPPORTING BEAMS AND JOISTS 1-HR 1-HR F. ROOF CONSTRUCTION INCLUDING SUPPORTING BEAMS AND JOISTS 1-HR 12. CORRIDOR FIRE RESSISTANCE RATING FBC TABLE 1020.1 A. REQUIRED FIRE RATING 0-HR FULLY SPRINKLED BUILDING IN COMPLIANCE WITH FBC 903.3.1.1

13. INTERIOR WALLS AND CEILING FINISHES REQUIREMENT BY OCCUPANCY FBC (TABLE 803.11) A. FULLY SPRINKLED BUILDING IN COMPLIANCE WITH FBC 903.3.1.1

INTERIOR EXIT STAIRWAYS AND EXIT PASSAGE CORRIDOR ROOMS AND ENCLOSED SPACES

14. MAXIMUM FLOOR AREA ALLOWANCES PER OCCUPANT FBC CHAPTER 10 AND NFPA 101 1. FIRST FLOOR

EUNCTION OF SPACE	SO ET	FLOOR AREA / SQ.	OCCUPANT L
CLASSROOMS	26,053	1 PER 20	1303
MEDIA CENTER	1,075	1 PER 50	22
LABS	866	1 PER 50	17
OFFICES	2,622	1 PER 100	27
GYMNASIUM	7,664	1 PER 7	1095
CAFETERIA/DINING ROOM	4,840	1 PER 15	323
STAFF DINING (LOUNGE)	587	1 PER 15	39
KITCHEN	732	1 PER 200	4
ELECTRICAL / MECHANICAL ROOMS	1,139	N/A	0
CIRCULATION/WALLS/PARTITIONS/TOILETS	19,858	N/A	N/A
	65,436	N/A	2831
	LABS OFFICES GYMNASIUM CAFETERIA/DINING ROOM STAFF DINING (LOUNGE) KITCHEN ELECTRICAL / MECHANICAL ROOMS	CLASSROOMS 26,053 MEDIA CENTER 1,075 LABS 866 OFFICES 2,622 GYMNASIUM 7,664 CAFETERIA/DINING ROOM 4,840 STAFF DINING (LOUNGE) 587 KITCHEN 732 ELECTRICAL / MECHANICAL ROOMS 1,139 CIRCULATION/WALLS/PARTITIONS/TOILETS 19,858	FUNCTION OF SPACE         SQ. FT.         FT. PER OCCUPANT           CLASSROOMS         26,053         1 PER 20           MEDIA CENTER         1,075         1 PER 50           LABS         866         1 PER 50           OFFICES         2,622         1 PER 100           GYMNASIUM         7,664         1 PER 7           CAFETERIA/DINING ROOM         4,840         1 PER 15           STAFF DINING (LOUNGE)         587         1 PER 15           KITCHEN         732         1 PER 200           ELECTRICAL / MECHANICAL ROOMS         1,139         N/A           CIRCULATION/WALLS/PARTITIONS/TOILETS         19,858         N/A

B. CORRIDORS (.2 PER OCCUPANT) PROVIDED: 89" REQUIRED: 72" C. STAIRS (.3 PER OCCUPANT) REQUIRED: 2832 X .3" PER OCCUPANT = 850" PROVIDED: 948" 15.2 SECOND FLOOR

FLOOR AREA / SQ. **FUNCTION OF SPACE** FT. PER OCCUPANT OCCUPANT LOAD CLASSROOMS 16,470 1 PER 20 OFFICES 1 PER 100 552 OPEN SPACE 38,944 CIRCULATION/WALLS/PARTITIONS/TOILETS 9,470 N/A TOTALS 65,436

PROVIDED: 612"

PROVIDED: 268"

15.2. SECOND FLOOR EGRESS WIDTH PER OCCUPANT SERVED FBC TABLE 1005.1

15.1 FIRST FLOOR EGRESS WIDTH PER OCCUPANT SERVED FBC TABLE 1005.1

(2) 36" DOOR WIDTH: (68" CLEAR OPENING)/.2 OCCUPANTS = 340 OCCUPANTS

REQUIRED: 2832 OCCUPANTS X.2" PER OCCUPANT = 567"

A. DOORS (.2 PER OCCUPANT)

A. DOORS (.2 PER OCCUPANT)

REQUIRED: 830" X .3" PER OCCUPANT 249"

REQUIRED: 830 OCCUPANTS X .2" PER OCCUPANT = 166" PROVIDED: 204" (6) 36" DOOR WIDTH: (34" CLEAR OPENING)/.2 OCCUPANTS = 1,020 OCCUPANTS B. CORRIDORS (.2 PER OCCUPANT) REQUIRED: 72" PROVIDED: 89" C. STAIRS (.3 PER OCCUPANT)

.3 THIRD	FLOOR			
			FLOOR AREA / SQ.	
MOC	FUNCTION OF SPACE	SQ. FT.	FT. PER OCCUPANT	OCCUPANT LOAD
	CLASSROOMS	12,255	1 PER 20	614
	OFFICES	313	1 PER 100	3
	ELECTRICAL / MECHANICAL ROOMS	506	1 PER 300	N/A
	OPEN SPACE	12,723	N/A	N/A
	CIRCULATION/WALLS/PARTITIONS/TOILETS	9,136	N/A	N/A
OTALS		34,933	N/A	617

15.3. THIRD FLOOR EGRESS WIDTH PER OCCUPANT SERVED FBC TABLE 1005.1 A. DOORS (.2 PER OCCUPANT) REQUIRED: 617 OCCUPANTS X .2" PER OCCUPANT = 124" (2) 36" DOOR WIDTH: (68" CLEAR OPENING)/.2 OCCUPANTS = 340 OCCUPANTS

B. CORRIDORS (.2 PER OCCUPANT) **REQUIRED: 72"** PROVIDED: 89" C. STAIRS (.3 PER OCCUPANT)

REQUIRED: 617 X .3" PER OCCUPANT = 186" PROVIDED: 268"

A. ALL FLOOR SURFACES WHICH MAY BECOME SLIPPERY SHALL HAVE A NON-SLIP IMPERVIOUS FLOORING B. ALL WINDOWS/ STOREFRONTS ADJACENT TO DOORS SHALL BE CATEGORY II GLAZING IN COMPLIANCE WITH FBC.

CORRIDORS: MAXIMUM DISTANCE TO FIRE EXTINGUISHER SHALL NOT EXCEED 75 FEET

18. MINIMUM NUMBER OF REQUIRED TOILET FIXTIURES FBC PLUMBING CODE TABLE 403.1 A. GRADES K-2 24 CLASSROOMS @ 18 STUDENTS PER CLASSROOM = 432 STUDENTS / 50 = 9 UNISEX REQUIRED = 11 UNISEX PROVIDED

PROVIDED: 204"


B. STUDENT TOILET TOTAL CAPACITY BASED ON ACTUAL STUDENTS IN CLASSROOM K-2 = (18 STUDENTS)3-8 = (22 STUDENTS)TOTAL OCCUPANT LOAD = 1,548 STUDENTS (774 MALES / 774 FEMALES)

	LOAD FACT	LOAD FACTOR		REQUIRED		D
	MALE			MALE FEMALE		FEMALE
WATER CLOSETS	1 PER 50	1 PER 50	16	16	19	19
	LOAD FACTOR I		REQUIRED		PROVIDED	
	MALE	FEMALE	MALE	FEMALE	MALE	FEMALE
LAVATORIES	1 PER 50	1 PER 50	16	16	20	20
	LOAD FACTOR		REQUIRED		PROVIDED	
DRINKING FOUNTAINS	1 PER 100	1 PER 100		20		
	LOAD FACT	OR	REQUIRED		PROVIDED	

C. OFFICES AND STAFF TOTAL CAPACITY 90 OCCUPANTS

16. FIRE EXTINGUISHER REQUIREMENT

TOTAL OCCI	JPANT LOAD :	= 90 STAFF (45 MALE:	S / 45 FE	MALES)		
	LOAD FACT	OR	REQUIR	RED	<b>PROVIDE</b>	D
	MALE	FEMALE	MALE	FEMALE	MALE	FEMALE
WATER CLOSETS	1 PER 25 FIF	RST 50	2	2	4	4
	LOAD FACT	OR	REQUIR	RED	PROVIDE	D
	MALE	FEMALE	MALE	FEMALE	MALE	FEMALE
LAVATORIES	1 PER 40 FIF	RST 80	2	2	4	4

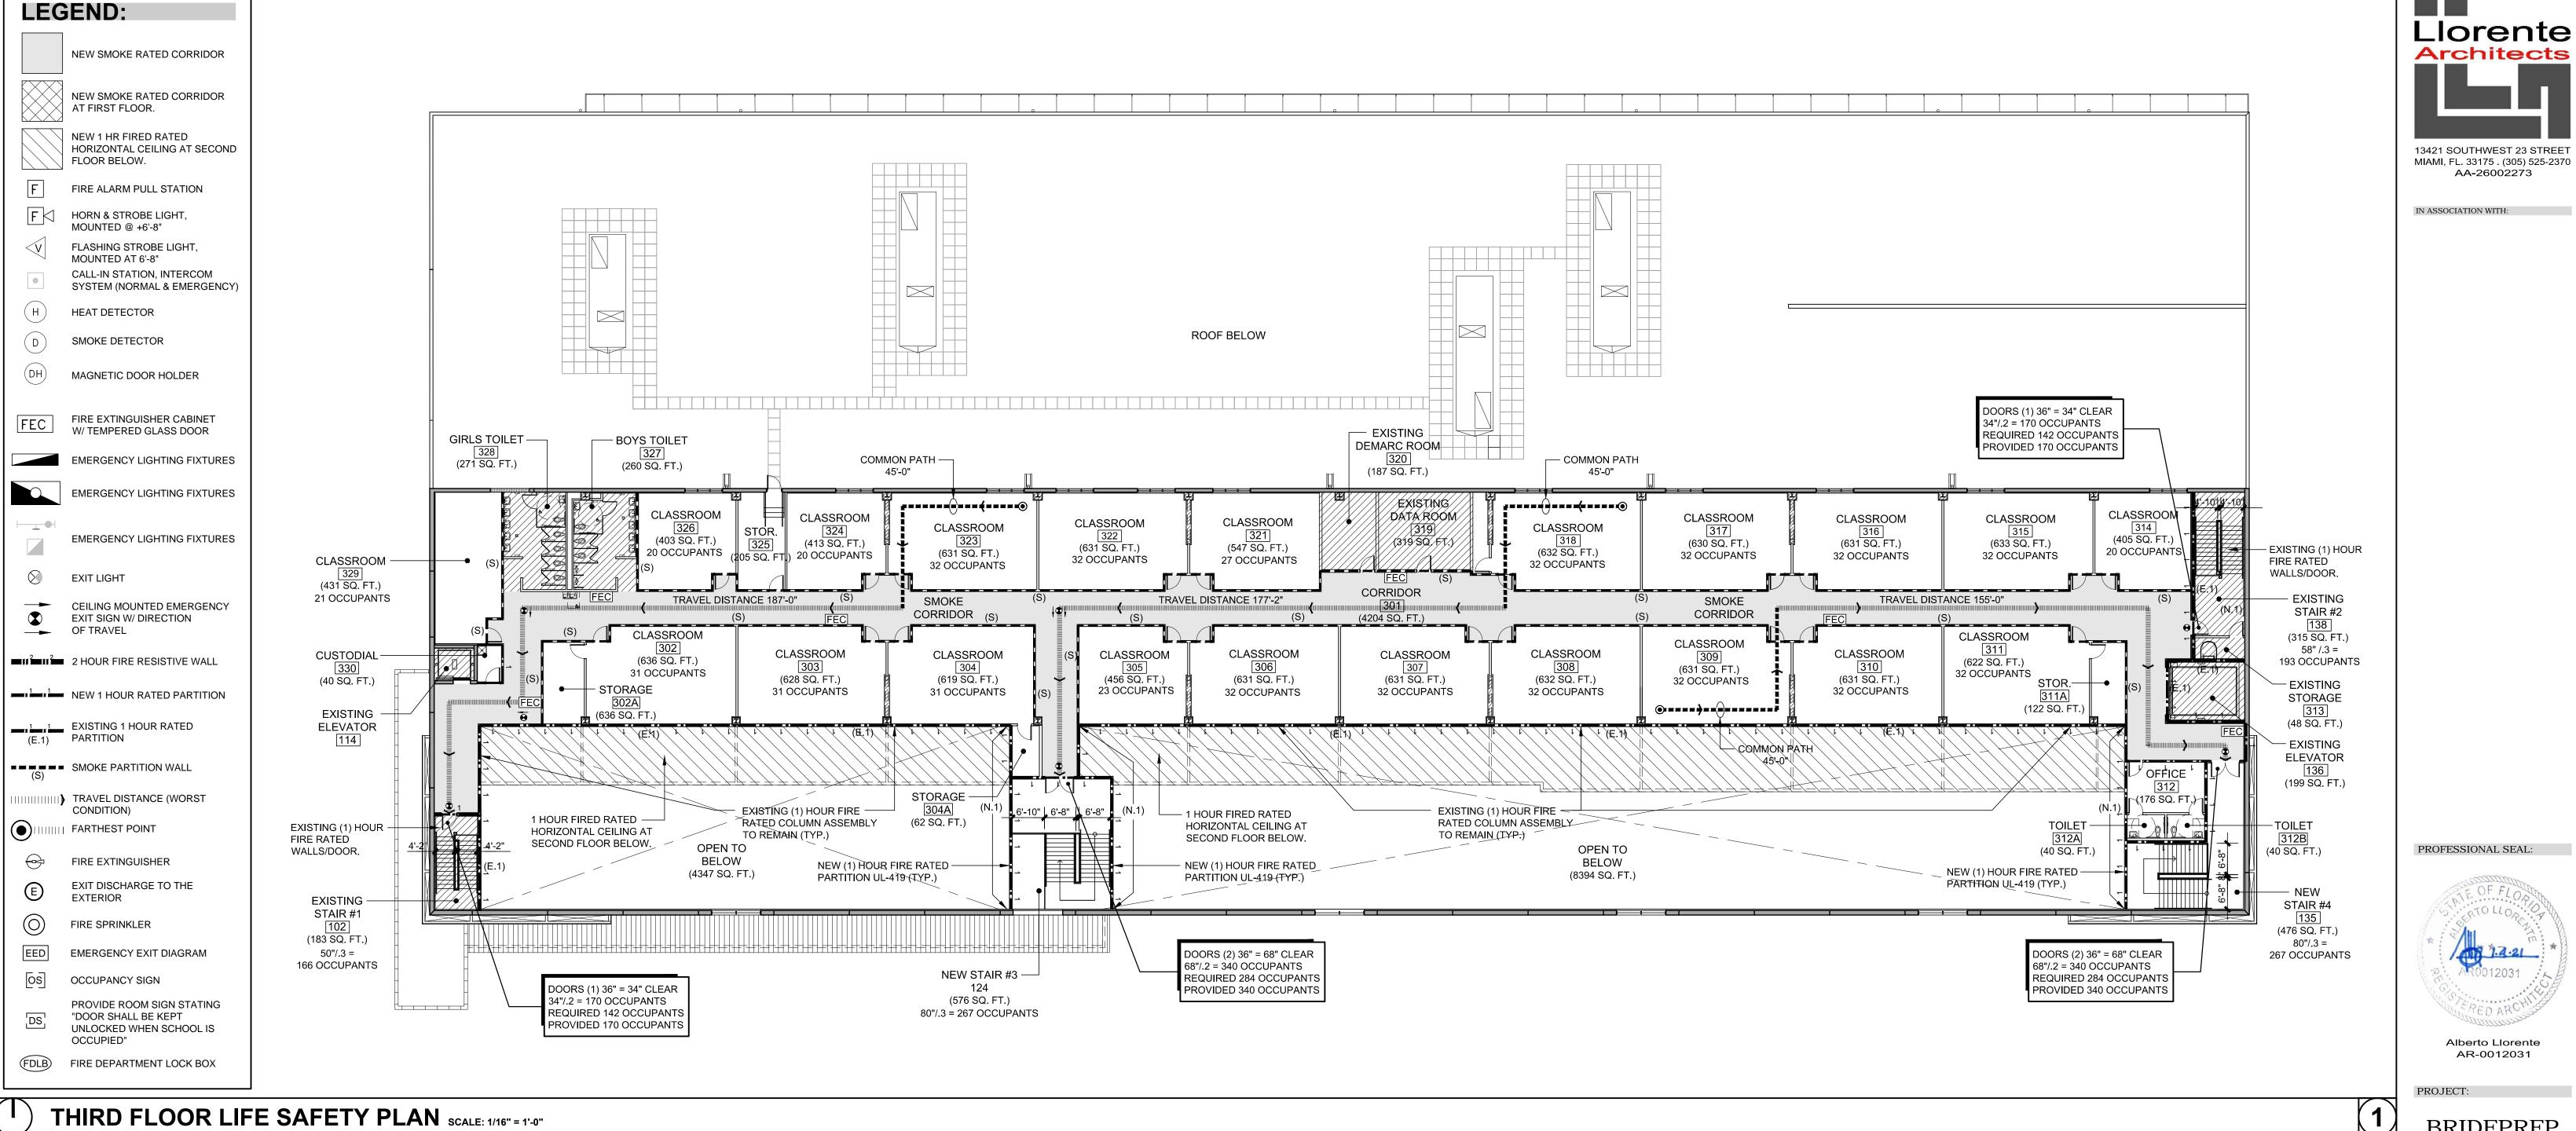



AA-26002273



Alberto Llorente AR-0012031

PROJECT:

15.3. THIRD FLOOR EGRESS WIDTH PER OCCUPANT SERVED FBC TABLE 1005.1

REQUIRED: 617 OCCUPANTS X .2" PER OCCUPANT = 124"

(2) 36" DOOR WIDTH: (68" CLEAR OPENING)/.2 OCCUPANTS = 340 OCCUPANTS

CORRIDORS: MAXIMUM DISTANCE TO FIRE EXTINGUISHER SHALL NOT EXCEED 75 FEET

B. ALL WINDOWS/ STOREFRONTS ADJACENT TO DOORS SHALL BE CATEGORY II GLAZING IN COMPLIANCE WITH FBC.

REQUIRED

REQUIRED

REQUIRED

REQUIRED

REQUIRED

MALE FEMALE

MALE FEMALE

MALE FEMALE

MALE FEMALE

A. ALL FLOOR SURFACES WHICH MAY BECOME SLIPPERY SHALL HAVE A NON-SLIP IMPERVIOUS FLOORING

18. MINIMUM NUMBER OF REQUIRED TOILET FIXTIURES FBC PLUMBING CODE TABLE 403.1

A. GRADES K-2 24 CLASSROOMS @ 18 STUDENTS PER CLASSROOM = 432 STUDENTS / 50

TOTAL OCCUPANT LOAD = 1,548 STUDENTS (774 MALES / 774 FEMALES)

B. STUDENT TOILET TOTAL CAPACITY BASED ON ACTUAL STUDENTS IN CLASSROOM

TOTAL OCCUPANT LOAD = 90 STAFF (45 MALES / 45 FEMALES)

PROVIDED: 204"

PROVIDED: 89"

PROVIDED: 268"

= 11 UNISEX PROVIDED

K-2 = (18 STUDENTS)

3-8 = (22 STUDENTS)

MALE FEMALE

MALE FEMALE

MALE FEMALE

MALE FEMALE

PROVIDED

PROVIDED

PROVIDED

A. DOORS (.2 PER OCCUPANT)

C. STAIRS (.3 PER OCCUPANT)

**REQUIRED: 72"** 

16. FIRE EXTINGUISHER REQUIREMENT

WATER CLOSETS

DRINKING FOUNTAINS 1 PER 100

**LAVATORIES** 

SERVICE SINK

WATER CLOSETS

**LAVATORIES** 

B. CORRIDORS (.2 PER OCCUPANT)

REQUIRED: 617 X .3" PER OCCUPANT = 186"

**LOAD FACTOR** 

LOAD FACTOR

LOAD FACTOR

LOAD FACTOR

LOAD FACTOR

MALE FEMALE

1 PER 25 FIRST 50 LOAD FACTOR MALE FEMALE

1 PER 40 FIRST 80

C. OFFICES AND STAFF TOTAL CAPACITY 90 OCCUPANTS

MALE FEMALE

1 PER 50 1 PER 50

MALE FEMALE

**BRIDEPREP ACADEMY** AT DORAL

3500 NW 89th COURT DORAL, FLORIDA 33172

DATE ISSUE DESCRIPTION

DRAWING INFORMATION:

SHEET TITLE: THIRD FLOOR LIFE SAFETY PLAN

DELIVERY DATE: 01.04.2021 DRAWN BY:

CHECKED BY REF NUMBER

A103 6 of 46

BRIDGEPREP ACADEMY DORAL (LIFE SAFETY GENERAL PARAMETERS)

			-			
1. APPLICABLE CODES (INCLUDING BUT NOT LIMITED TO)	10. EXIT A	AND EXIT ACCESS DOORWAYS FBC TABLE 1006	5.3.1			
B. FLORIDA BUILDING CODE (FBC) 2017 EDITION	A. 7	TWO EXITS ARE REQUIRED FOR SPACES THAT E	EXCEED 49-	500 OCCUPA	NTS	
C. FLORIDA FIRE PREVENTION CODE (FFPC) 2017 6TH EDITION	В. Т	THREE EXITS ARE REQUIRED FOR SPACES THAT	ΓEXCEED 5	01-1000 OCC	UPANTS	
		FOUR EXITS ARE REQUIRED FOR SPACES THAT				
2. BUILDING CLASSIFICATION OF OCCUPANCY & HAZARD CONTENT						
A. EXISTING BUILDING BUSINESS/FACTORY/STORAGE	11. FIRE-I	RESISTANT RATING REQUIREMENTS FOR BUILD	ING ELEME	NT FBC TAB	LE 601	
B. PROPOSED BUILDING EDUCATION GROUP E		FULLY SPRINKLED BUILDING IN COMPLIANCE WI				PROVIDED:
FBC CHAPTER 3-SECTION 305 EDUCATIONAL GROUP E		PRIMARY STRUCTURAL FRAME	1111 00 000	.0.1.1	1-HR	1-HR
C. FULLY SPRINKLERED BUILDING IN COMPLIANCE WITH FBC 903.3.1.1		BEARING WALLS			1-1111	1-1111
C. I OLL I SPININKLENED BOILDING IN COMPLIANCE WITH I BC 905.5.1.1	O. L	EXTERIOR			1-HR	1-HR
3. BUILDING CONSTRUCTION TYPE		INTERIOR			1-HR	1-HR
A. EXISTING CONSTRUCTION FBC TYPE II-A	D 1				I-UK	I-HK
	D. r	NON BEARING WALLS AND PARTITIONS			0.110	0.110
B. PROPOSED CONSTRUCTION FBC TYPE II-A		INTERIOR			0-HR	0-HR
C. FULLY SPRINKLED BUILDING IN COMPLIANCE WITH FBC 903.3.1.1		LOOR CONSTRUCTION INCLUDING SUPPORTIN			1-HR	1-HR
	F. F	ROOF CONSTRUCTION INCLUDING SUPPORTING	BEAMS AN	D JOISTS	1-HR	1-HR
4. ALLOWABLE BUILDING HEIGHT IN FEET ABOVE GRADE PLANE (FBC TABLE 504.3)						
A. ALLOWED: 85 FEET / ABOVE GRADE PLANE	12. CORR	RIDOR FIRE RESSISTANCE RATING FBC TABLE 1	020.1			
B. PROVIDED: 58 FEET / ABOVE GRADE PLANE		REQUIRED FIRE RATING			0-HR	0-HR
	FUL	LLY SPRINKLED BUILDING IN COMPLIANCE WITH	FBC 903.3.	1.1		
5. ALLOWABLE NUMBER OF STORIES ABOVE GRADE PLANE (FBC TABLE 504.4)						
A. ALLOWED: 4 STORIES	13. INTER	RIOR WALLS AND CEILING FINISHES REQUIREM	ENT BY OCC	<b>CUPANCY FB</b>	C (TABLE 803	3.11)
B. PROVIDED: 3 STORIES	A. F	FULLY SPRINKLED BUILDING IN COMPLIANCE WI	TH FBC 903	.3.1.1		
	INT	ERIOR EXIT STAIRWAYS AND EXIT PASSAGE	В			
6. ALLOWABLE AREA FACTOR IN SQUARE FEET (FBC TABLE 506.2)	CO	RRIDOR C				
A. ALLOWED AREA 79,500 SF.	RO	OMS AND ENCLOSED SPACES C				
B. PROVIDED BUILDING AREA 65,620 SF.						
	14. MAXIN	MUM FLOOR AREA ALLOWANCES PER OCCUPA	NT FBC CH	APTER 10 AN	D NFPA 101	
7. COMMON PATH OF EGRESS TRAVEL FBC (TABLE 1006.2.1)	1. FIRST I		20 0			
A. THE COMMON PATH OF EGRESS TRAVEL SHALL NOT EXCEED 75 FEET		12001		FLOOR AF	REA / SO	
FULLY SPRINKLED BUILDING IN COMPLIANCE WITH FBC 903.3.1.1	ROOM	FUNCTION OF SPACE	SQ. FT.	FT. PER O		OCCUPANT LO
B. FFPC TABLE A.7.6: THE COMMON PATH OF EGRESS TRAVEL SHALL NOT EXCEED 100 FEET	1	CLASSROOMS	26,053	1 PER 20		1303
B. TIT O TABLE A.T.O. THE GOWINGIN TATITOT EGILEGO TRAVEL OF LAGELD 100 TELT	2	MEDIA CENTER	1,075	1 PER 50		22
8. MAXIMUM DEAD END CORRIDOR FBC 1020.4.2	2	LABS	866	1 PER 50		17
A. SHALL NOT EXCEED 50 FEET	3		000	1 PER 50 1 PER 100		
	4 5	OFFICES	2,622			27
FULLY SPRINKLED BUILDING IN COMPLIANCE WITH FBC 903.3.1.1	5	GYMNASIUM	7,664	1 PER 7		1095
B. FFPC TABLE A.7.6: THE DEAD END CORRIDOR SHALL NOT EXCEED 50 FEET	6	CAFETERIA/DINING ROOM	4,840	1 PER 15		323
A FVIT AGOEGO TRAVEL BIOTANIOS FRO (TABLE (A) - A)	/	STAFF DINING (LOUNGE)	587	1 PER 15		39
9. EXIT ACCESS TRAVEL DISTANCE FBC (TABLE 1017.2)	8	KITCHEN	732	1 PER 200		4
A. TRAVEL DISTANCE SHALL NOT EXCEED 250 FEET	9	ELECTRICAL / MECHANICAL ROOMS	1,139	N/A		0
FULLY SPRINKLED BUILDING IN COMPLIANCE WITH FBC 903.3.1.1	10	CIRCULATION/WALLS/PARTITIONS/TOILETS	19,858	N/A		N/A
B. FFPC TABLE A.7.6: TRAVEL DISTANCE SHALL NOT EXCEED 200 FEET	TOTALS		65,436	N/A		2831

REQUIRED: 72" PROVIDED: 89" C. STAIRS (.3 PER OCCUPANT) REQUIRED: 2832 X .3" PER OCCUPANT = 850" PROVIDED: 948" 15.2 SECOND FLOOR FLOOR AREA / SQ. **FUNCTION OF SPACE** FT. PER OCCUPANT OCCUPANT LOAD CLASSROOMS 16,470 1 PER 20 824 OFFICES 1 PER 100 552 OPEN SPACE 38,944 CIRCULATION/WALLS/PARTITIONS/TOILETS 9,470 N/A TOTALS 65,436 15.2. SECOND FLOOR EGRESS WIDTH PER OCCUPANT SERVED FBC TABLE 1005.1 A. DOORS (.2 PER OCCUPANT) REQUIRED: 830 OCCUPANTS X .2" PER OCCUPANT = 166" PROVIDED: 204"

PROVIDED: 612"

15.1 FIRST FLOOR EGRESS WIDTH PER OCCUPANT SERVED FBC TABLE 1005.1

(2) 36" DOOR WIDTH: (68" CLEAR OPENING)/.2 OCCUPANTS = 340 OCCUPANTS


REQUIRED: 2832 OCCUPANTS X .2" PER OCCUPANT = 567"

A. DOORS (.2 PER OCCUPANT)

B. CORRIDORS (.2 PER OCCUPANT)

(6) 36" DOOR WIDTH: (34" CLEAR OPENING)/.2 OCCUPANTS = 1,020 OCCUPANTS B. CORRIDORS (.2 PER OCCUPANT) REQUIRED: 72" PROVIDED: 89" C. STAIRS (.3 PER OCCUPANT) PROVIDED: 268" REQUIRED: 830" X .3" PER OCCUPANT 249"

3 THIR	D FLOOR			
			FLOOR AREA / SQ.	
MO	FUNCTION OF SPACE	SQ. FT.	FT. PER OCCUPANT	OCCUPANT LO
	CLASSROOMS	12,255	1 PER 20	614
	OFFICES	313	1 PER 100	3
	ELECTRICAL / MECHANICAL ROOMS	506	1 PER 300	N/A
	OPEN SPACE	12,723	N/A	N/A
	CIRCULATION/WALLS/PARTITIONS/TOILETS	9,136	N/A	N/A
TALS		34,933	N/A	617
		•		

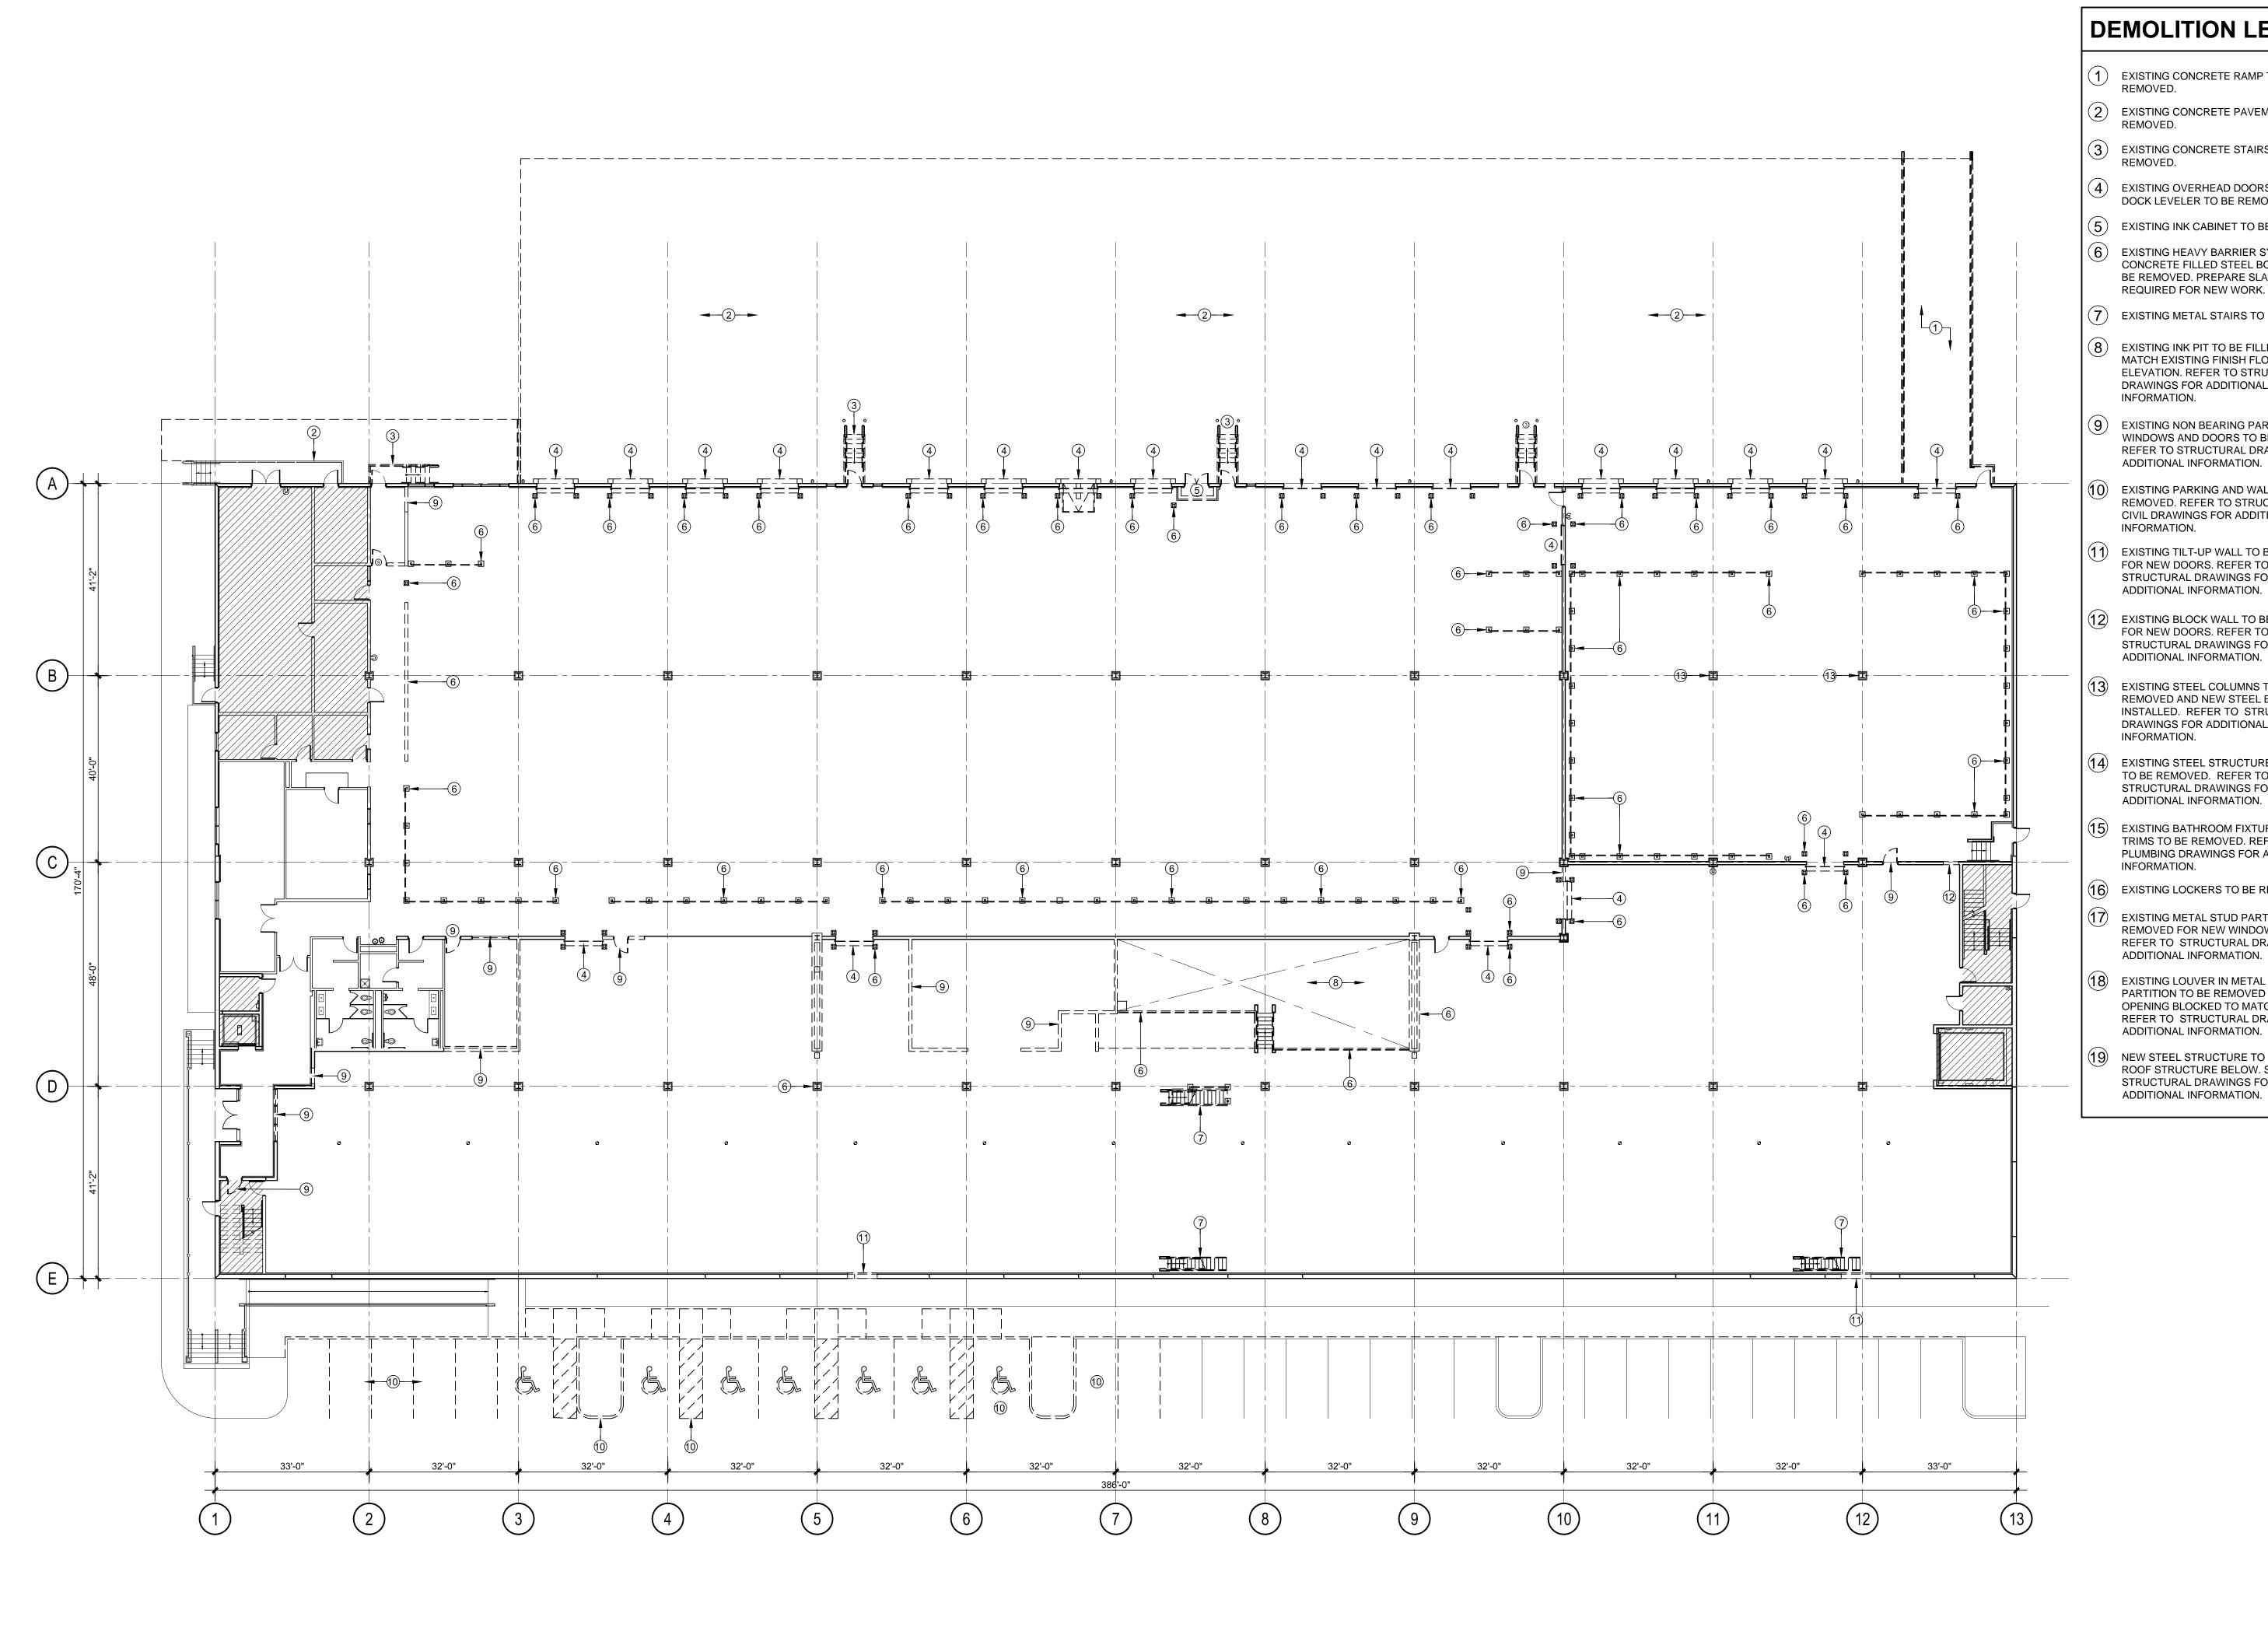

## **DEMOLITION LEGEND**

- (1) EXISTING CONCRETE RAMP TO BE REMOVED.
- (2) EXISTING CONCRETE PAVEMENT TO BE REMOVED.
- (3) EXISTING CONCRETE STAIRS TO BE REMOVED.
- (4) EXISTING OVERHEAD DOORS AND DOCK LEVELER TO BE REMOVED.
- (5) EXISTING INK CABINET TO BE REMOVED.
- (6) EXISTING HEAVY BARRIER SYSTEM AND CONCRETE FILLED STEEL BOLLARDS TO BE REMOVED. PREPARE SLAB AS REQUIRED FOR NEW WORK.
- (7) EXISTING METAL STAIRS TO BE REMOVED.
- (8) EXISTING INK PIT TO BE FILLED TO MATCH EXISTING FINISH FLOOR ELEVATION. REFER TO STRUCTURAL DRAWINGS FOR ADDITIONAL INFORMATION.
- (9) EXISTING NON BEARING PARTITIONS, WINDOWS AND DOORS TO BE REMOVED. REFER TO STRUCTURAL DRAWINGS FOR ADDITIONAL INFORMATION.
- (10) EXISTING PARKING AND WALKWAY TO BE REMOVED. REFER TO STRUCTURAL AND CIVIL DRAWINGS FOR ADDITIONAL INFORMATION.
- (11) EXISTING TILT-UP WALL TO BE REMOVED FOR NEW DOORS. REFER TO STRUCTURAL DRAWINGS FOR ADDITIONAL INFORMATION.
- (12) EXISTING BLOCK WALL TO BE REMOVED FOR NEW DOORS. REFER TO STRUCTURAL DRAWINGS FOR
- (13) EXISTING STEEL COLUMNS TO BE REMOVED AND NEW STEEL BEAM INSTALLED. REFER TO STRUCTURAL DRAWINGS FOR ADDITIONAL INFORMATION.
- (14) EXISTING STEEL STRUCTURE COLUMNS TO BE REMOVED. REFER TO STRUCTURAL DRAWINGS FOR ADDITIONAL INFORMATION.
- (15) EXISTING BATHROOM FIXTURES AND TRIMS TO BE REMOVED. REFER TO PLUMBING DRAWINGS FOR ADDITIONAL
- (16) EXISTING LOCKERS TO BE REMOVED.
- (17) EXISTING METAL STUD PARTITION TO BE REMOVED FOR NEW WINDOW OPENING. REFER TO STRUCTURAL DRAWINGS FOR ADDITIONAL INFORMATION.
- (18) EXISTING LOUVER IN METAL STUD PARTITION TO BE REMOVED AND
  OPENING BLOCKED TO MATCH EXISTING.
  REFER TO STRUCTURAL DRAWINGS FOR ADDITIONAL INFORMATION.
- (19) NEW STEEL STRUCTURE TO SUPPORT ROOF STRUCTURE BELOW. SEE STRUCTURAL DRAWINGS FOR ADDITIONAL INFORMATION.



13421 SOUTHWEST 23 STREET MIAMI, FL. 33175 . (305) 525-2370 AA-26002273

IN ASSOCIATION WITH:

PROFESSIONAL SEAL:



Alberto Llorente AR-0012031

PROJECT:

BRIDEPREP **ACADEMY** AT DORAL


3500 NW 89th COURT DORAL, FLORIDA 33172 DATE ISSUE DESCRIPTION

DRAWING INFORMATION: DEMOLITION FIRST FLOOR

DELIVERY DATE: DRAWN BY: CHECKED BY

REF NUMBER:

A104

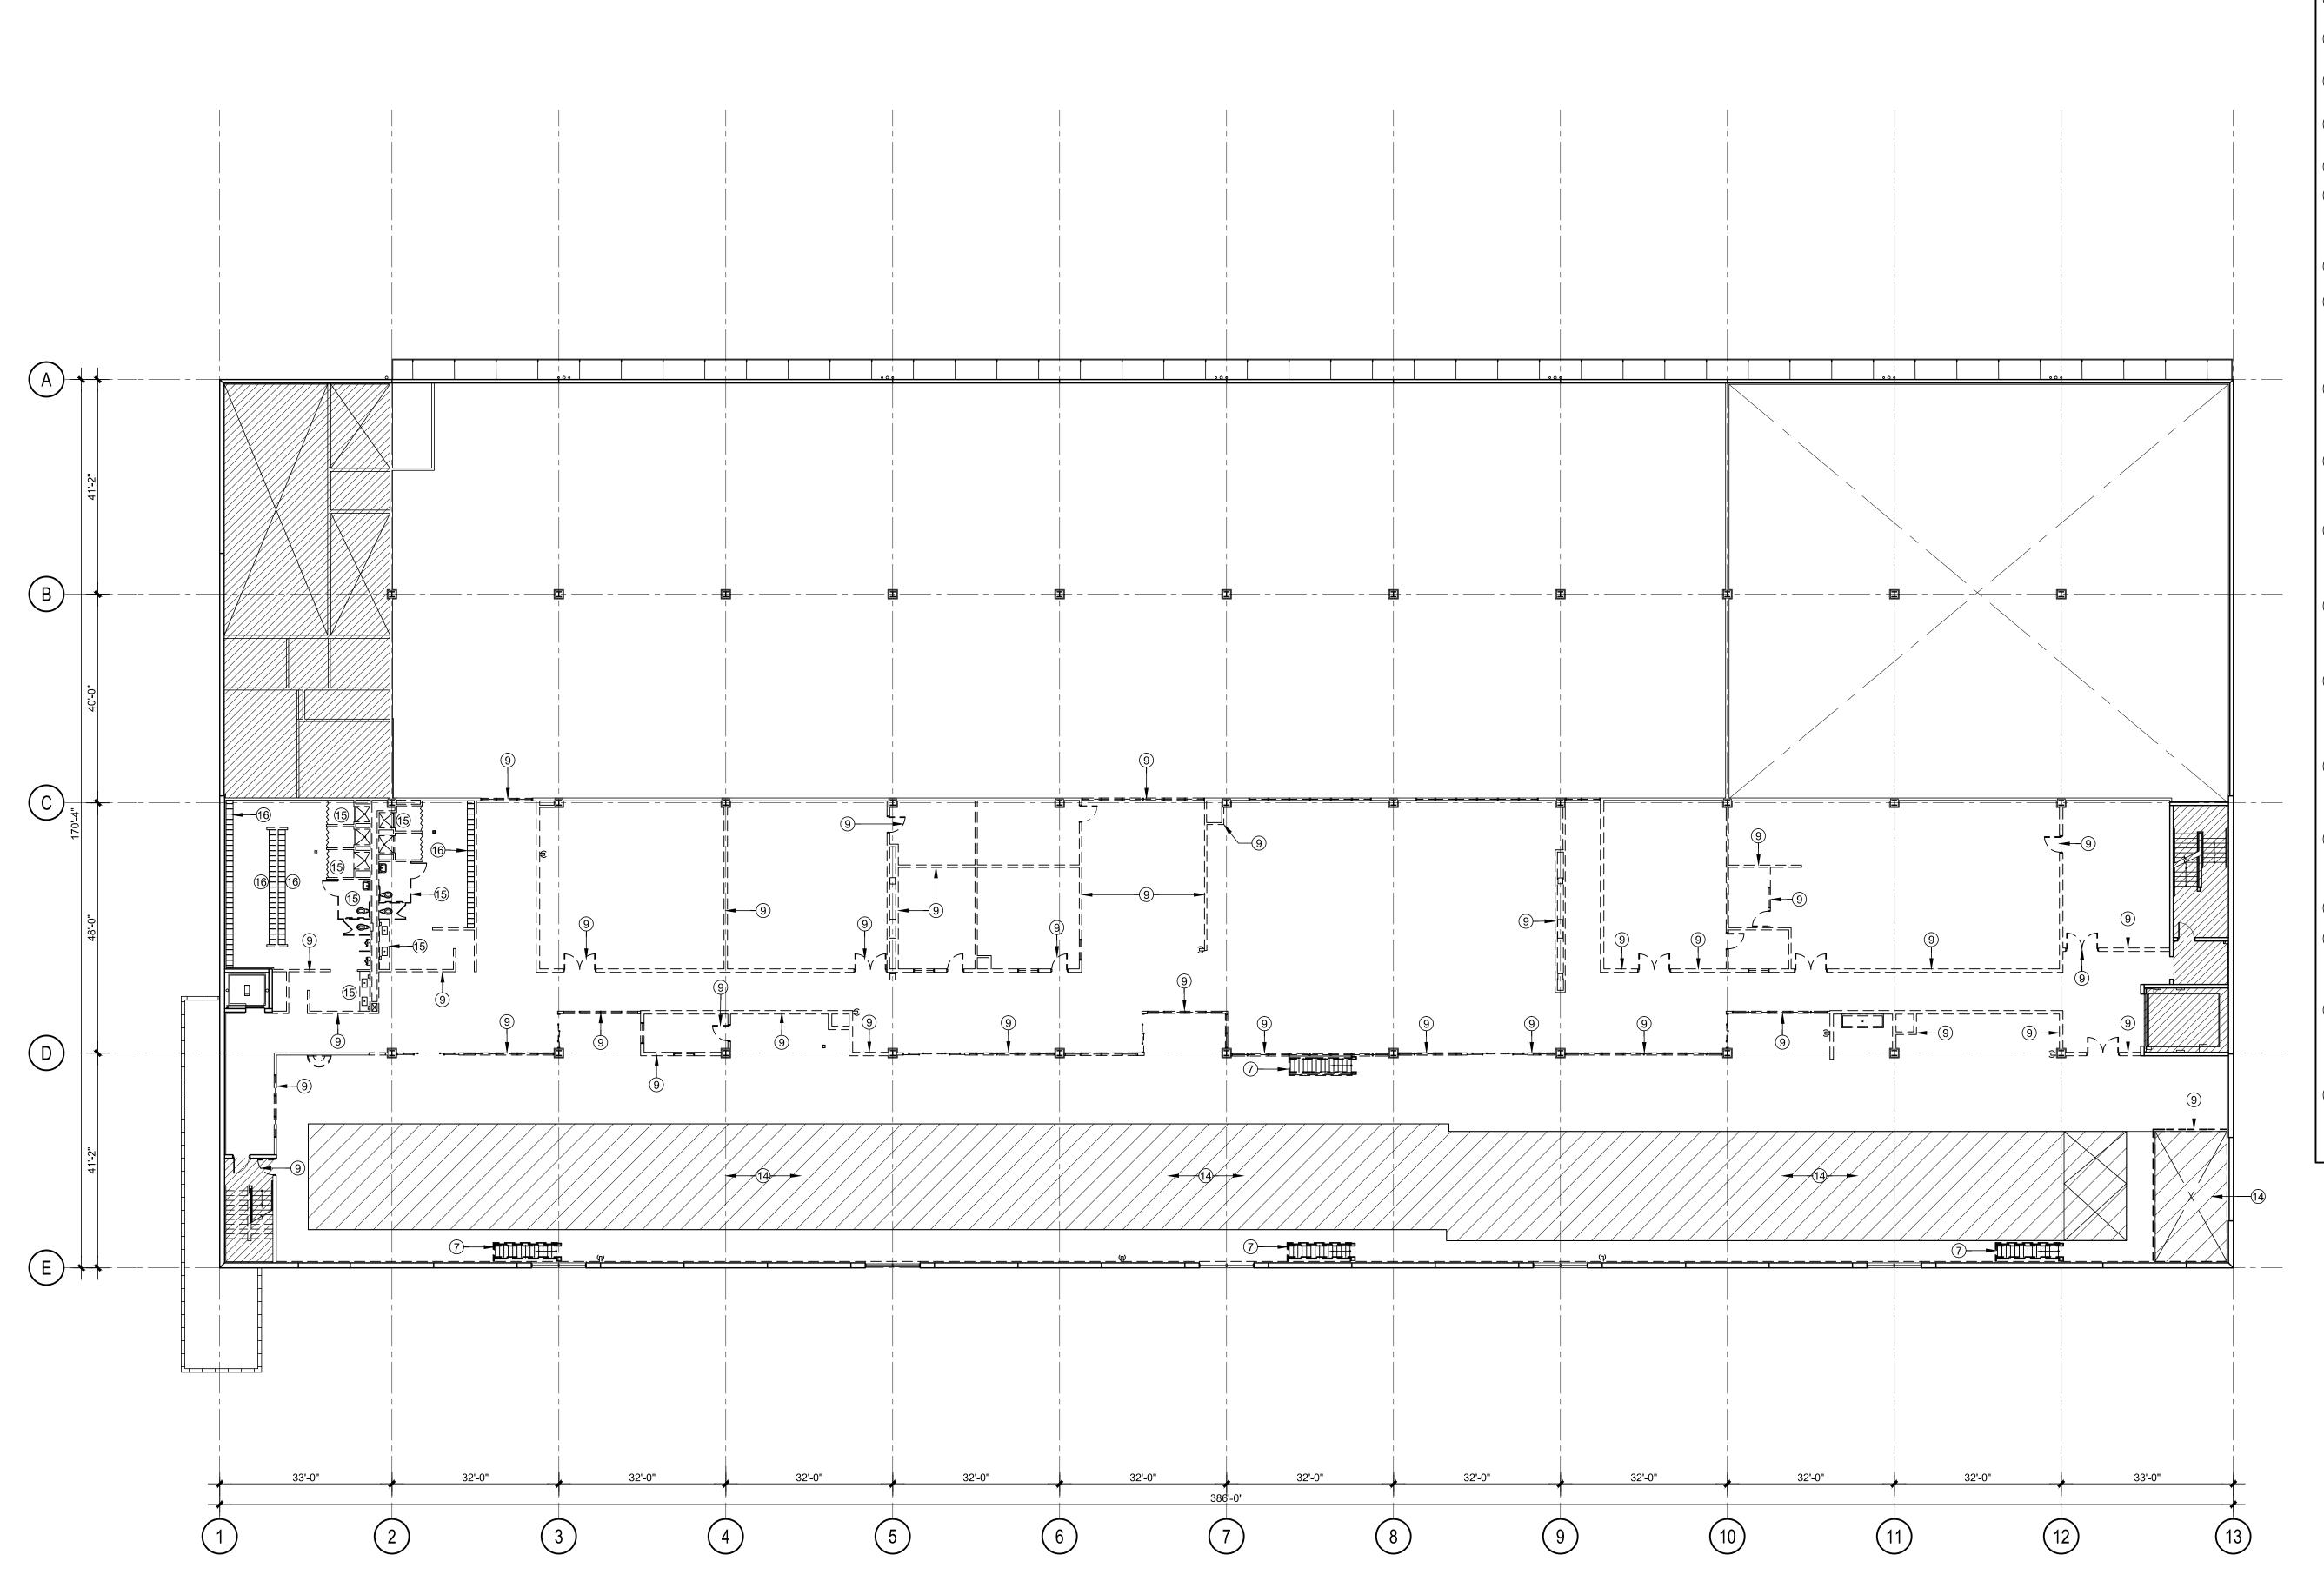

## **DEMOLITION LEGEND**

- 1 EXISTING CONCRETE RAMP TO BE REMOVED.
- 2 EXISTING CONCRETE PAVEMENT TO BE REMOVED.
- 3 EXISTING CONCRETE STAIRS TO BE REMOVED.
- 4 EXISTING OVERHEAD DOORS AND DOCK LEVELER TO BE REMOVED.
- (5) EXISTING INK CABINET TO BE REMOVED.
- 6 EXISTING HEAVY BARRIER SYSTEM AND CONCRETE FILLED STEEL BOLLARDS TO BE REMOVED. PREPARE SLAB AS REQUIRED FOR NEW WORK.
- (7) EXISTING METAL STAIRS TO BE REMOVED.
- 8 EXISTING INK PIT TO BE FILLED TO MATCH EXISTING FINISH FLOOR ELEVATION. REFER TO STRUCTURAL DRAWINGS FOR ADDITIONAL INFORMATION.
- 9 EXISTING NON BEARING PARTITIONS, WINDOWS AND DOORS TO BE REMOVED. REFER TO STRUCTURAL DRAWINGS FOR ADDITIONAL INFORMATION.
- EXISTING PARKING AND WALKWAY TO BE REMOVED. REFER TO STRUCTURAL AND CIVIL DRAWINGS FOR ADDITIONAL INFORMATION.
- EXISTING TILT-UP WALL TO BE REMOVED FOR NEW DOORS. REFER TO STRUCTURAL DRAWINGS FOR ADDITIONAL INFORMATION.
- EXISTING BLOCK WALL TO BE REMOVED FOR NEW DOORS. REFER TO STRUCTURAL DRAWINGS FOR ADDITIONAL INFORMATION.
- EXISTING STEEL COLUMNS TO BE REMOVED AND NEW STEEL BEAM INSTALLED. REFER TO STRUCTURAL DRAWINGS FOR ADDITIONAL INFORMATION.
- 14) EXISTING STEEL STRUCTURE COLUMNS
  TO BE REMOVED. REFER TO
  STRUCTURAL DRAWINGS FOR
  ADDITIONAL INFORMATION.
- EXISTING BATHROOM FIXTURES AND TRIMS TO BE REMOVED. REFER TO PLUMBING DRAWINGS FOR ADDITIONAL INFORMATION.
- 16 EXISTING LOCKERS TO BE REMOVED.
- EXISTING METAL STUD PARTITION TO BE REMOVED FOR NEW WINDOW OPENING. REFER TO STRUCTURAL DRAWINGS FOR ADDITIONAL INFORMATION.
- EXISTING LOUVER IN METAL STUD PARTITION TO BE REMOVED AND OPENING BLOCKED TO MATCH EXISTING. REFER TO STRUCTURAL DRAWINGS FOR ADDITIONAL INFORMATION.
- NEW STEEL STRUCTURE TO SUPPORT ROOF STRUCTURE BELOW. SEE STRUCTURAL DRAWINGS FOR ADDITIONAL INFORMATION.



13421 SOUTHWEST 23 STREET MIAMI, FL. 33175 . (305) 525-2370 AA-26002273

IN ASSOCIATION WITH:

PROFESSIONAL SEAL:



Alberto Llorente AR-0012031

PROJECT:

BRIDEPREP ACADEMY AT DORAL

3500 NW 89th COURT DORAL, FLORIDA 33172

DATE ISSUE DESCRIPTION

DRAWING INFORMATION:
SHEET TITLE:

SHEET TITLE:
DEMOLITION SECOND
FLOOR PLAN

DELIVERY DATE:

01.04.2021

DRAWN BY:

J.B.

CHECKED BY:

A.LL.

CHECKED BY:

A.LL.

REF NUMBER:

A105



## **DEMOLITION LEGEND**

- 1 EXISTING CONCRETE RAMP TO BE REMOVED.
- 2 EXISTING CONCRETE PAVEMENT TO BE REMOVED.
- 3 EXISTING CONCRETE STAIRS TO BE REMOVED.
- 4 EXISTING OVERHEAD DOORS AND DOCK LEVELER TO BE REMOVED.
- (5) EXISTING INK CABINET TO BE REMOVED.
- 6 EXISTING HEAVY BARRIER SYSTEM AND CONCRETE FILLED STEEL BOLLARDS TO BE REMOVED. PREPARE SLAB AS REQUIRED FOR NEW WORK.
- (7) EXISTING METAL STAIRS TO BE REMOVED.
- 8 EXISTING INK PIT TO BE FILLED TO MATCH EXISTING FINISH FLOOR ELEVATION. REFER TO STRUCTURAL DRAWINGS FOR ADDITIONAL INFORMATION.
- 9 EXISTING NON BEARING PARTITIONS, WINDOWS AND DOORS TO BE REMOVED. REFER TO STRUCTURAL DRAWINGS FOR ADDITIONAL INFORMATION.
- EXISTING PARKING AND WALKWAY TO BE REMOVED. REFER TO STRUCTURAL AND CIVIL DRAWINGS FOR ADDITIONAL INFORMATION.
- EXISTING TILT-UP WALL TO BE REMOVED FOR NEW DOORS. REFER TO STRUCTURAL DRAWINGS FOR ADDITIONAL INFORMATION.
- EXISTING BLOCK WALL TO BE REMOVED FOR NEW DOORS. REFER TO STRUCTURAL DRAWINGS FOR ADDITIONAL INFORMATION.
- EXISTING STEEL COLUMNS TO BE REMOVED AND NEW STEEL BEAM INSTALLED. REFER TO STRUCTURAL DRAWINGS FOR ADDITIONAL INFORMATION.
- 14) EXISTING STEEL STRUCTURE COLUMNS TO BE REMOVED. REFER TO STRUCTURAL DRAWINGS FOR ADDITIONAL INFORMATION.
- EXISTING BATHROOM FIXTURES AND TRIMS TO BE REMOVED. REFER TO PLUMBING DRAWINGS FOR ADDITIONAL INFORMATION.
- 16 EXISTING LOCKERS TO BE REMOVED.
- EXISTING METAL STUD PARTITION TO BE REMOVED FOR NEW WINDOW OPENING. REFER TO STRUCTURAL DRAWINGS FOR ADDITIONAL INFORMATION.
- EXISTING LOUVER IN METAL STUD PARTITION TO BE REMOVED AND OPENING BLOCKED TO MATCH EXISTING. REFER TO STRUCTURAL DRAWINGS FOR ADDITIONAL INFORMATION.
- NEW STEEL STRUCTURE TO SUPPORT ROOF STRUCTURE BELOW. SEE STRUCTURAL DRAWINGS FOR ADDITIONAL INFORMATION.



13421 SOUTHWEST 23 STREET MIAMI, FL. 33175 . (305) 525-2370 AA-26002273

IN ASSOCIATION WITH:

PROFESSIONAL SEAL:



Alberto Llorente AR-0012031

PROJECT:

BRIDEPREP ACADEMY AT DORAL

3500 NW 89th COURT DORAL, FLORIDA 33172

DATE ISSUE DESCRIPTION

DRAWING INFORMATION:

DEMOLITION THIRD FLOOR PLAN

DELIVERY DATE:

01.04.2021


DRAWN BY:

J.B.

CHECKED BY:

SHEET NO. A 106

REF NUMBER:

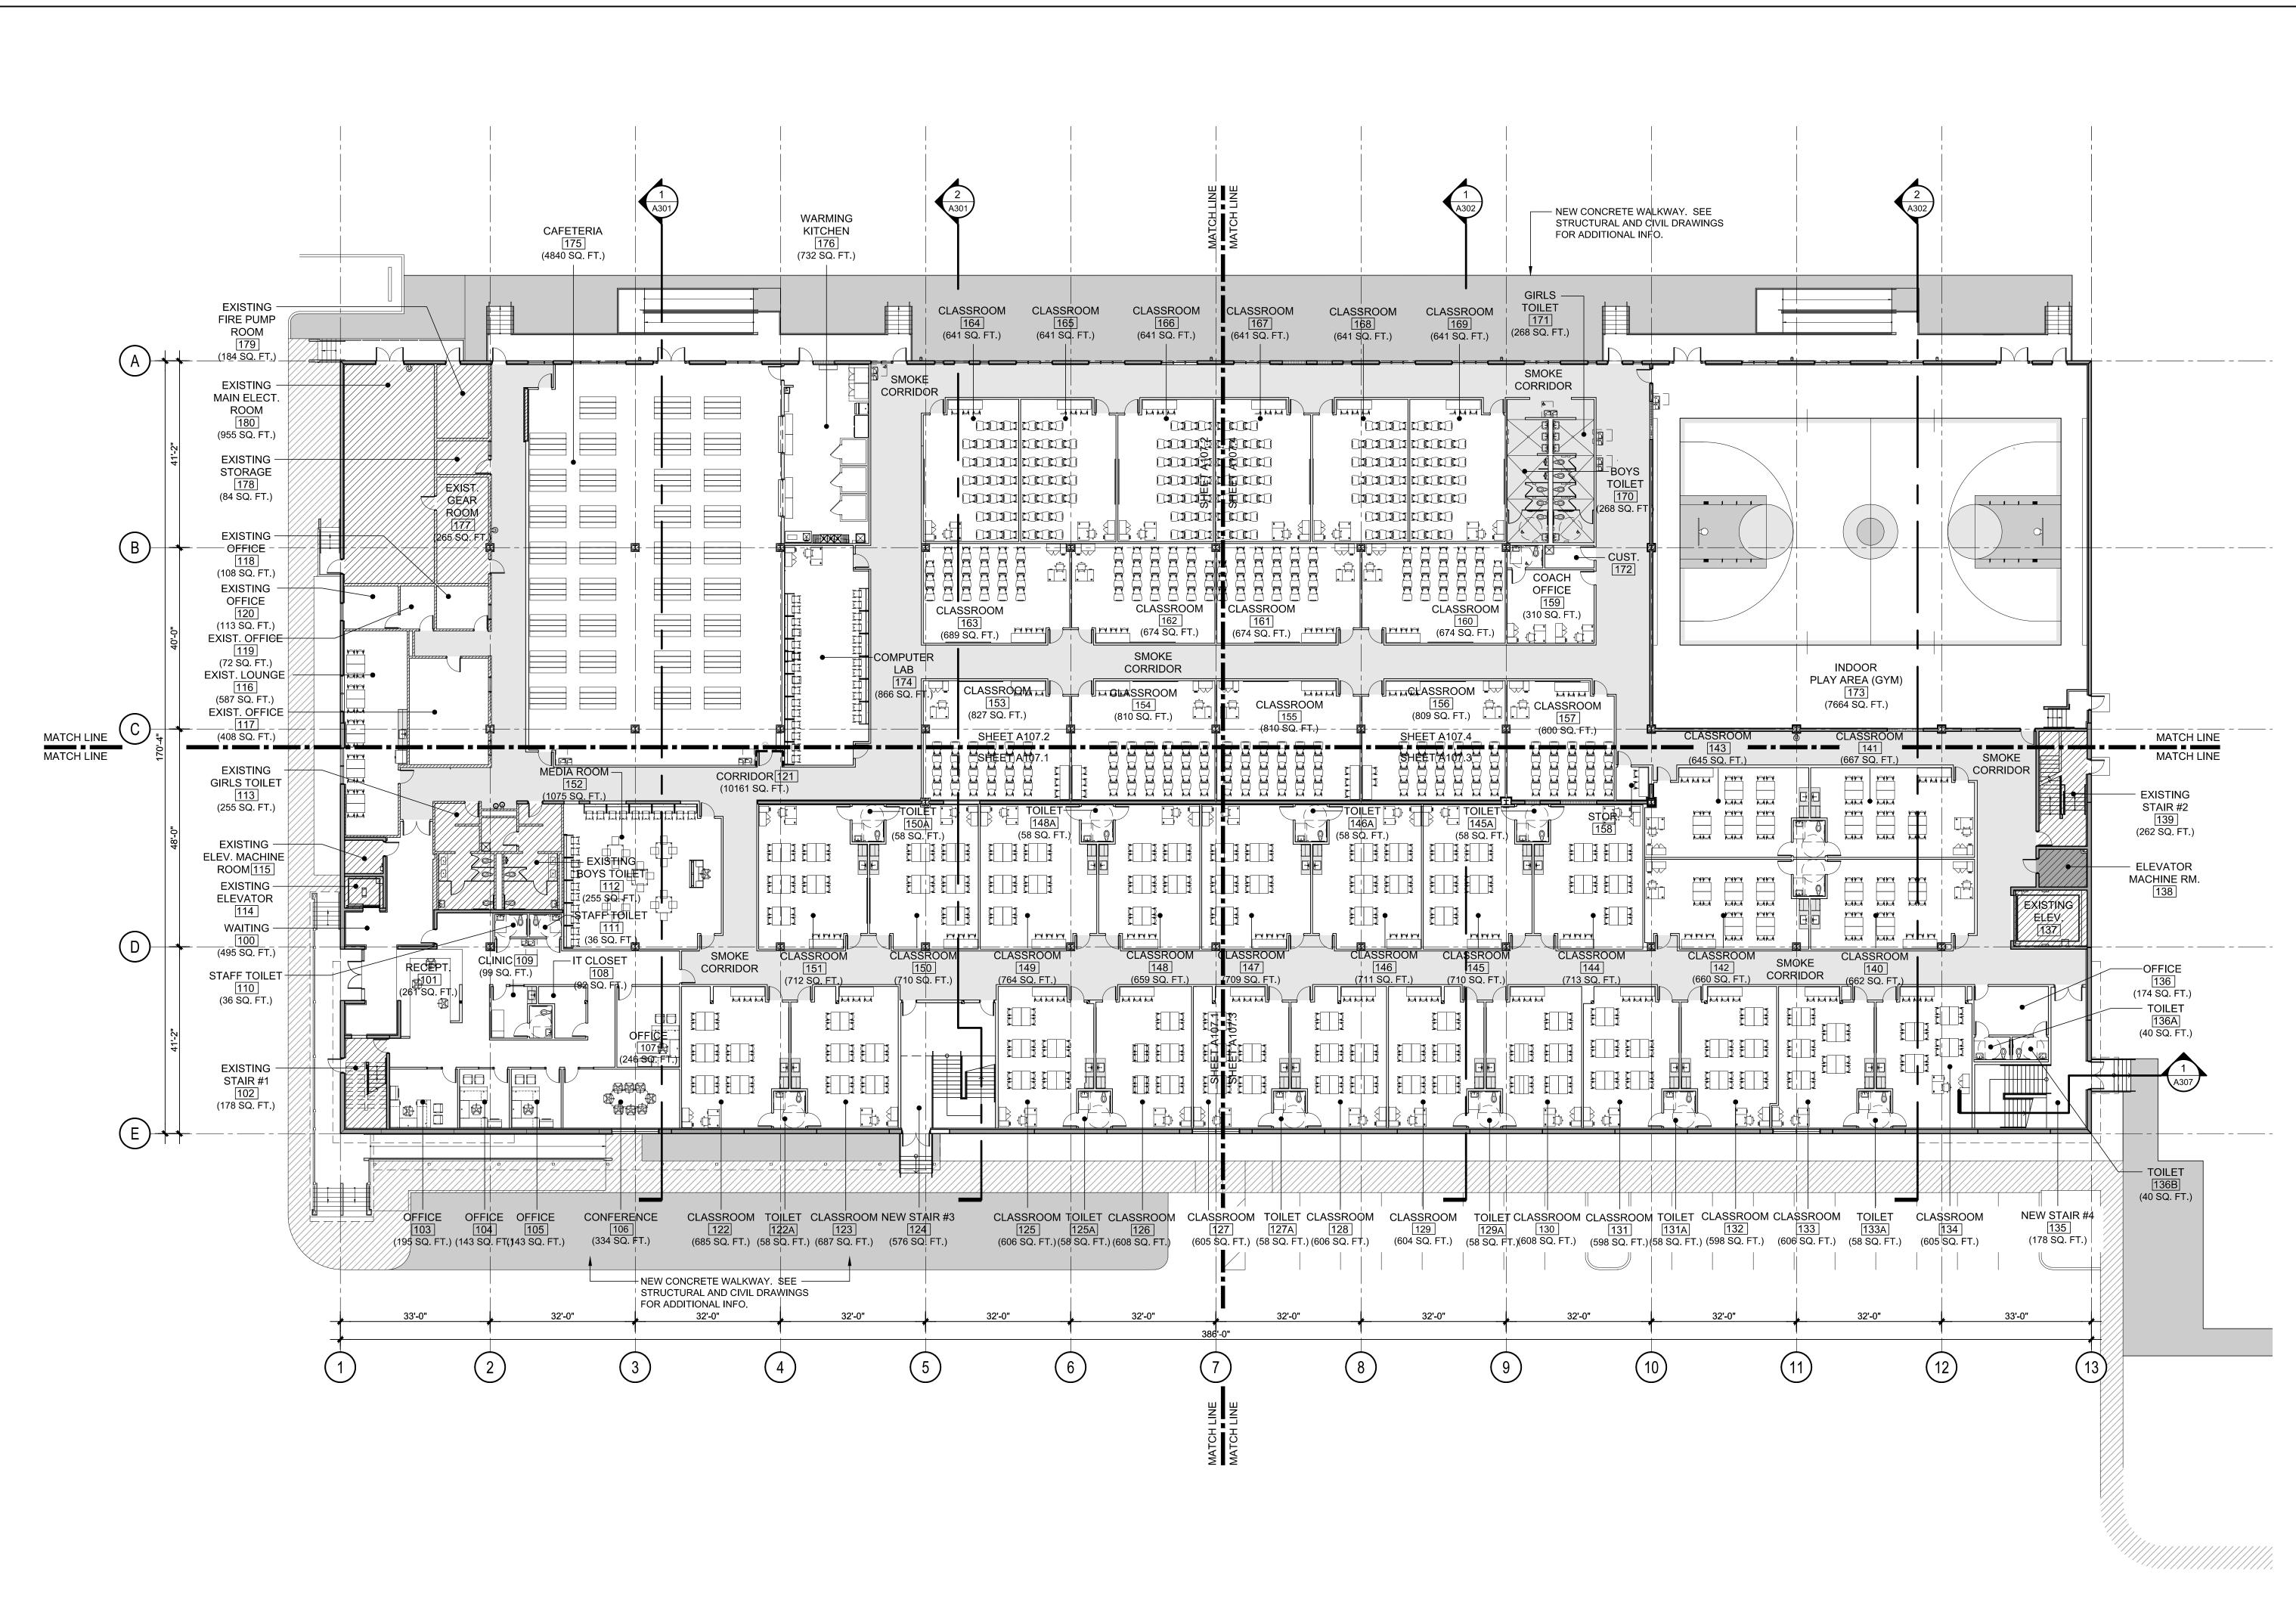

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13421 SOUTHWEST 23 STREET
MIAMI, FL. 33175. (305) 525-2370

IN ASSOCIATION WITH:

AA-26002273

PROFESSIONAL SEAL:



Alberto Llorente AR-0012031

PROJECT:

BRIDEPREP ACADEMY AT DORAL

3500 NW 89th COURT DORAL, FLORIDA 33172

DATE ISSUE DESCRIPTION

DRAWING INFORMATION:

SHEET TITLE:

PROPOSED OVERALL
FIRST FLOOR PLAN

PROPOSED OVERALL FIRST FLOOR PLAN

DELIVERY DATE:

01.04.2021

DRAWN BY:


J.B.

CHECKED BY:

A.LL.

REF NUMBER:

A107

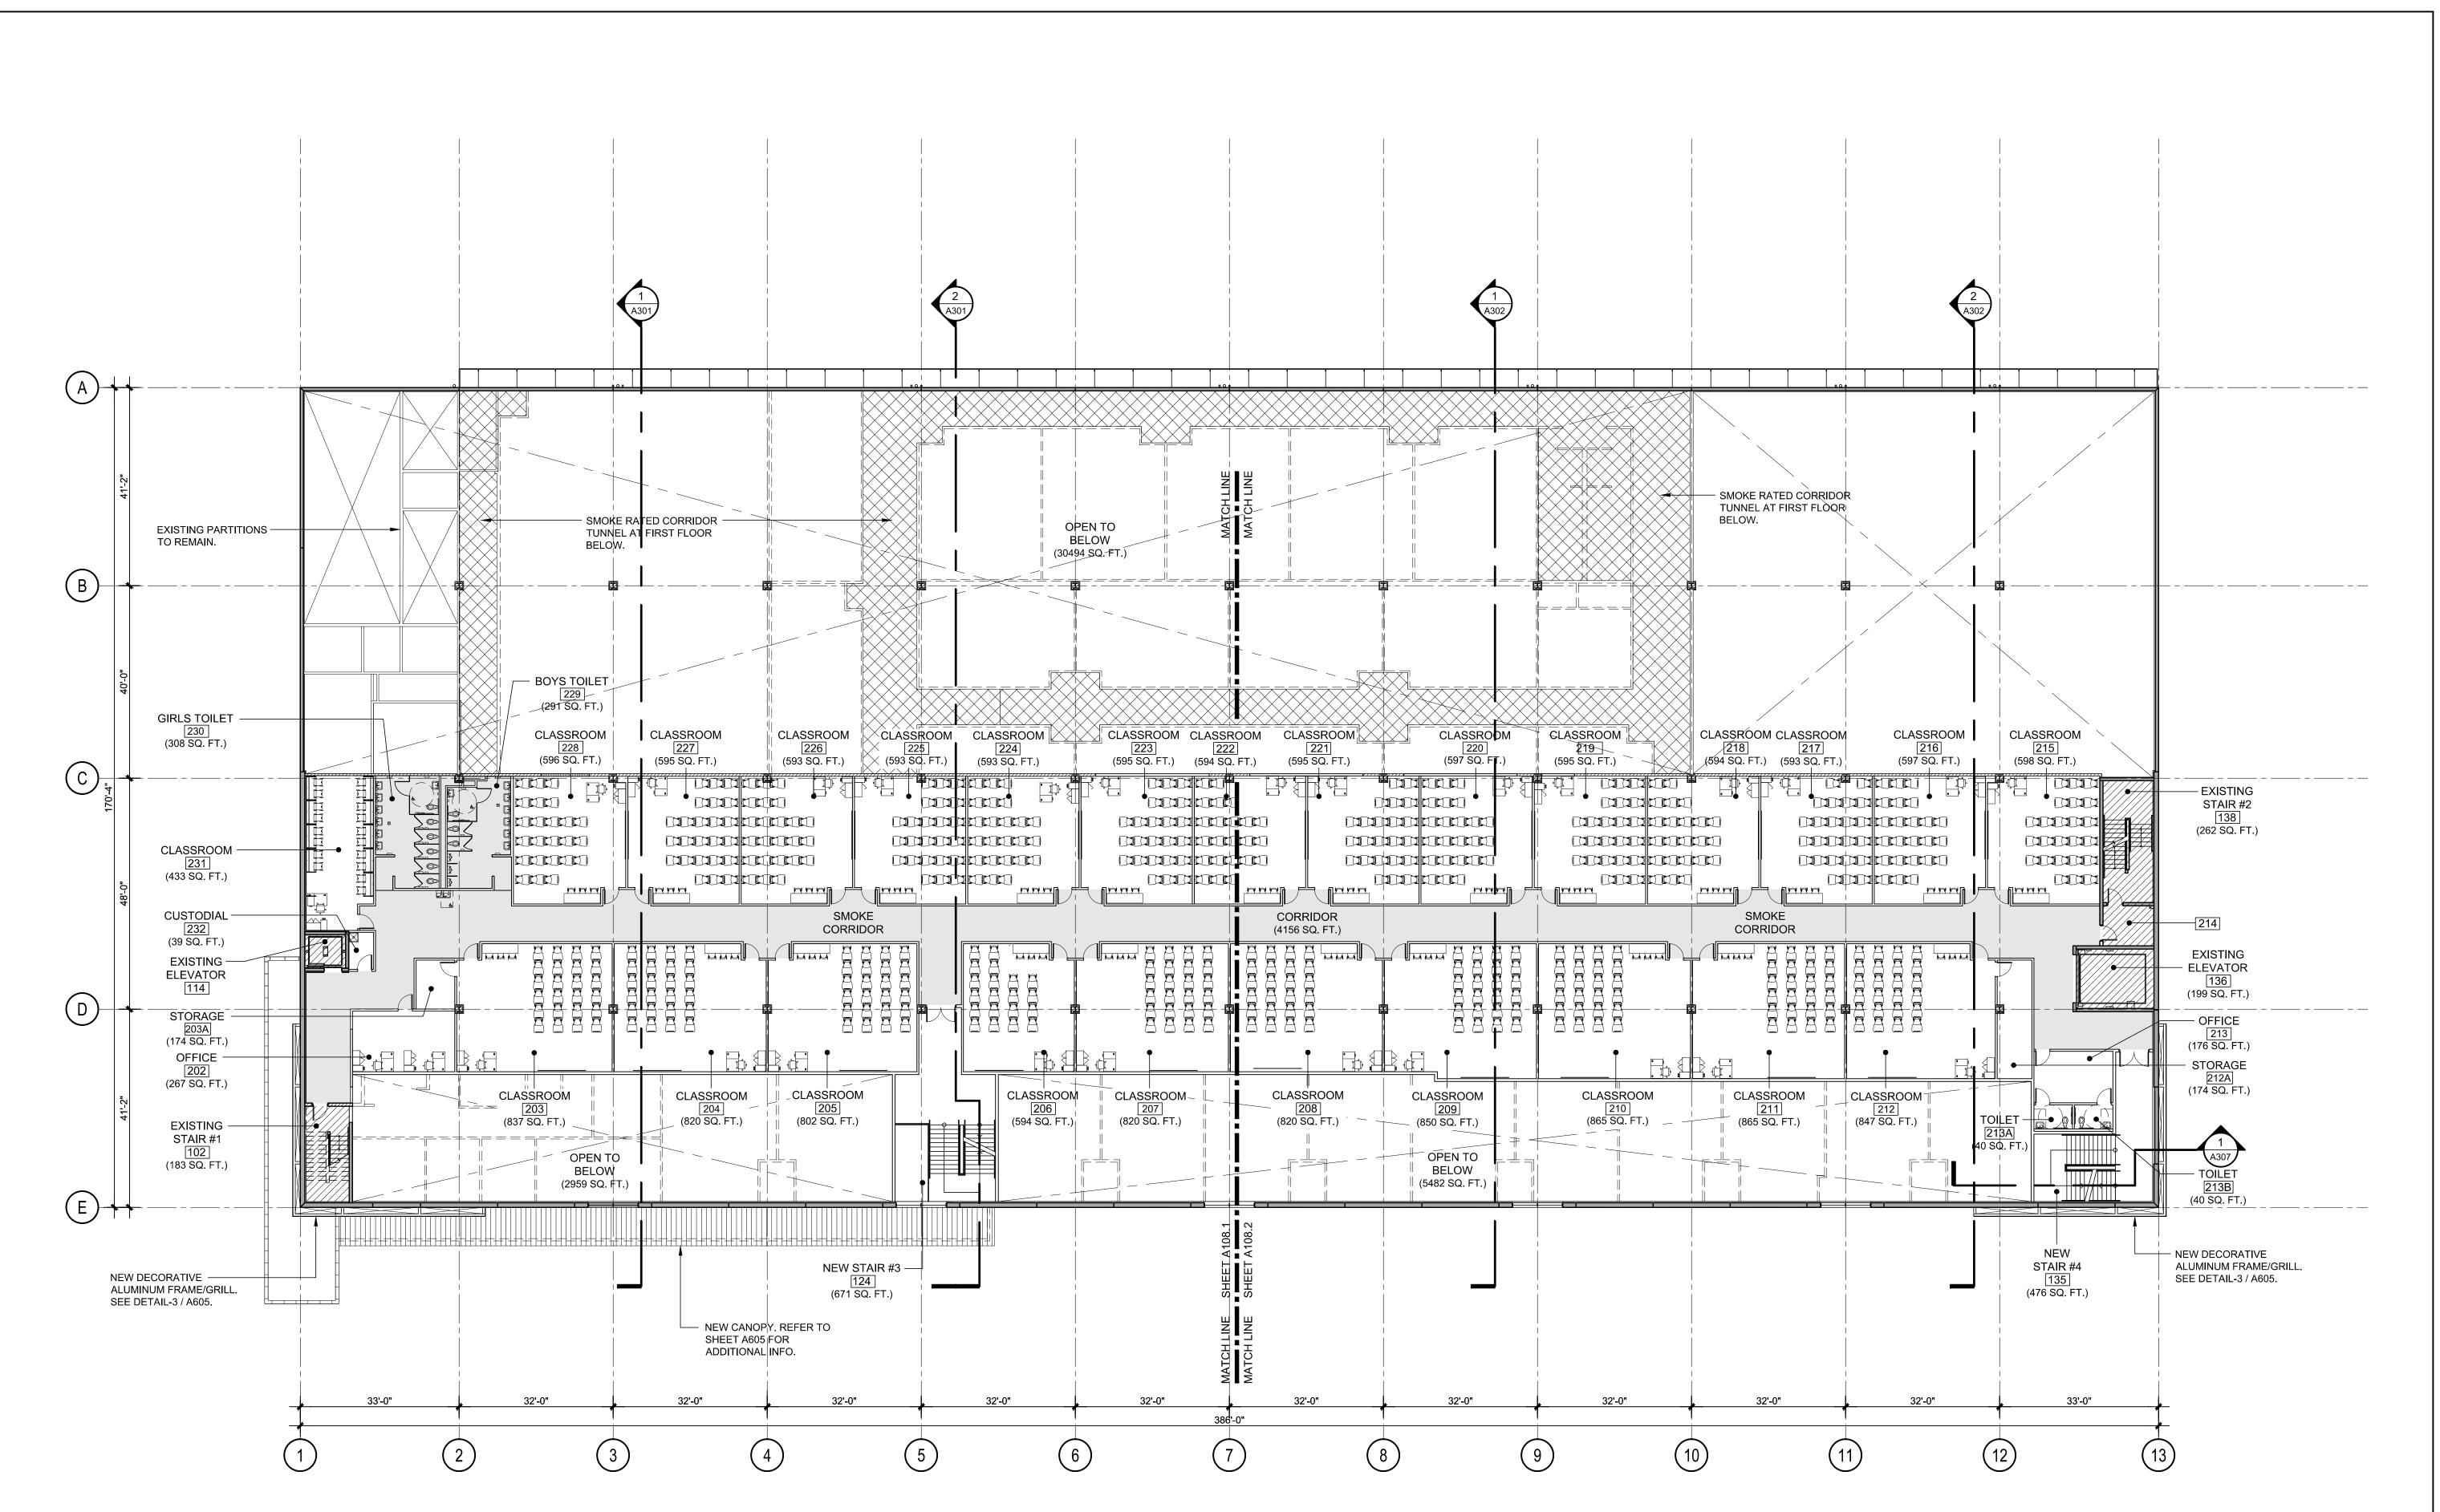



IN ASSOCIATION WITH:

PROFESSIONAL SEAL:



Alberto Llorente AR-0012031

PROJECT:

BRIDEPREP ACADEMY AT DORAL

3500 NW 89th COURT DORAL, FLORIDA 33172

DATE ISSUE DESCRIPTION

DRAWING INFORMATION:

SHEET TITLE:

PROPOSED OVERALL
SECOND FLOOR PLAN

DELIVERY DATE:

01.04.2021

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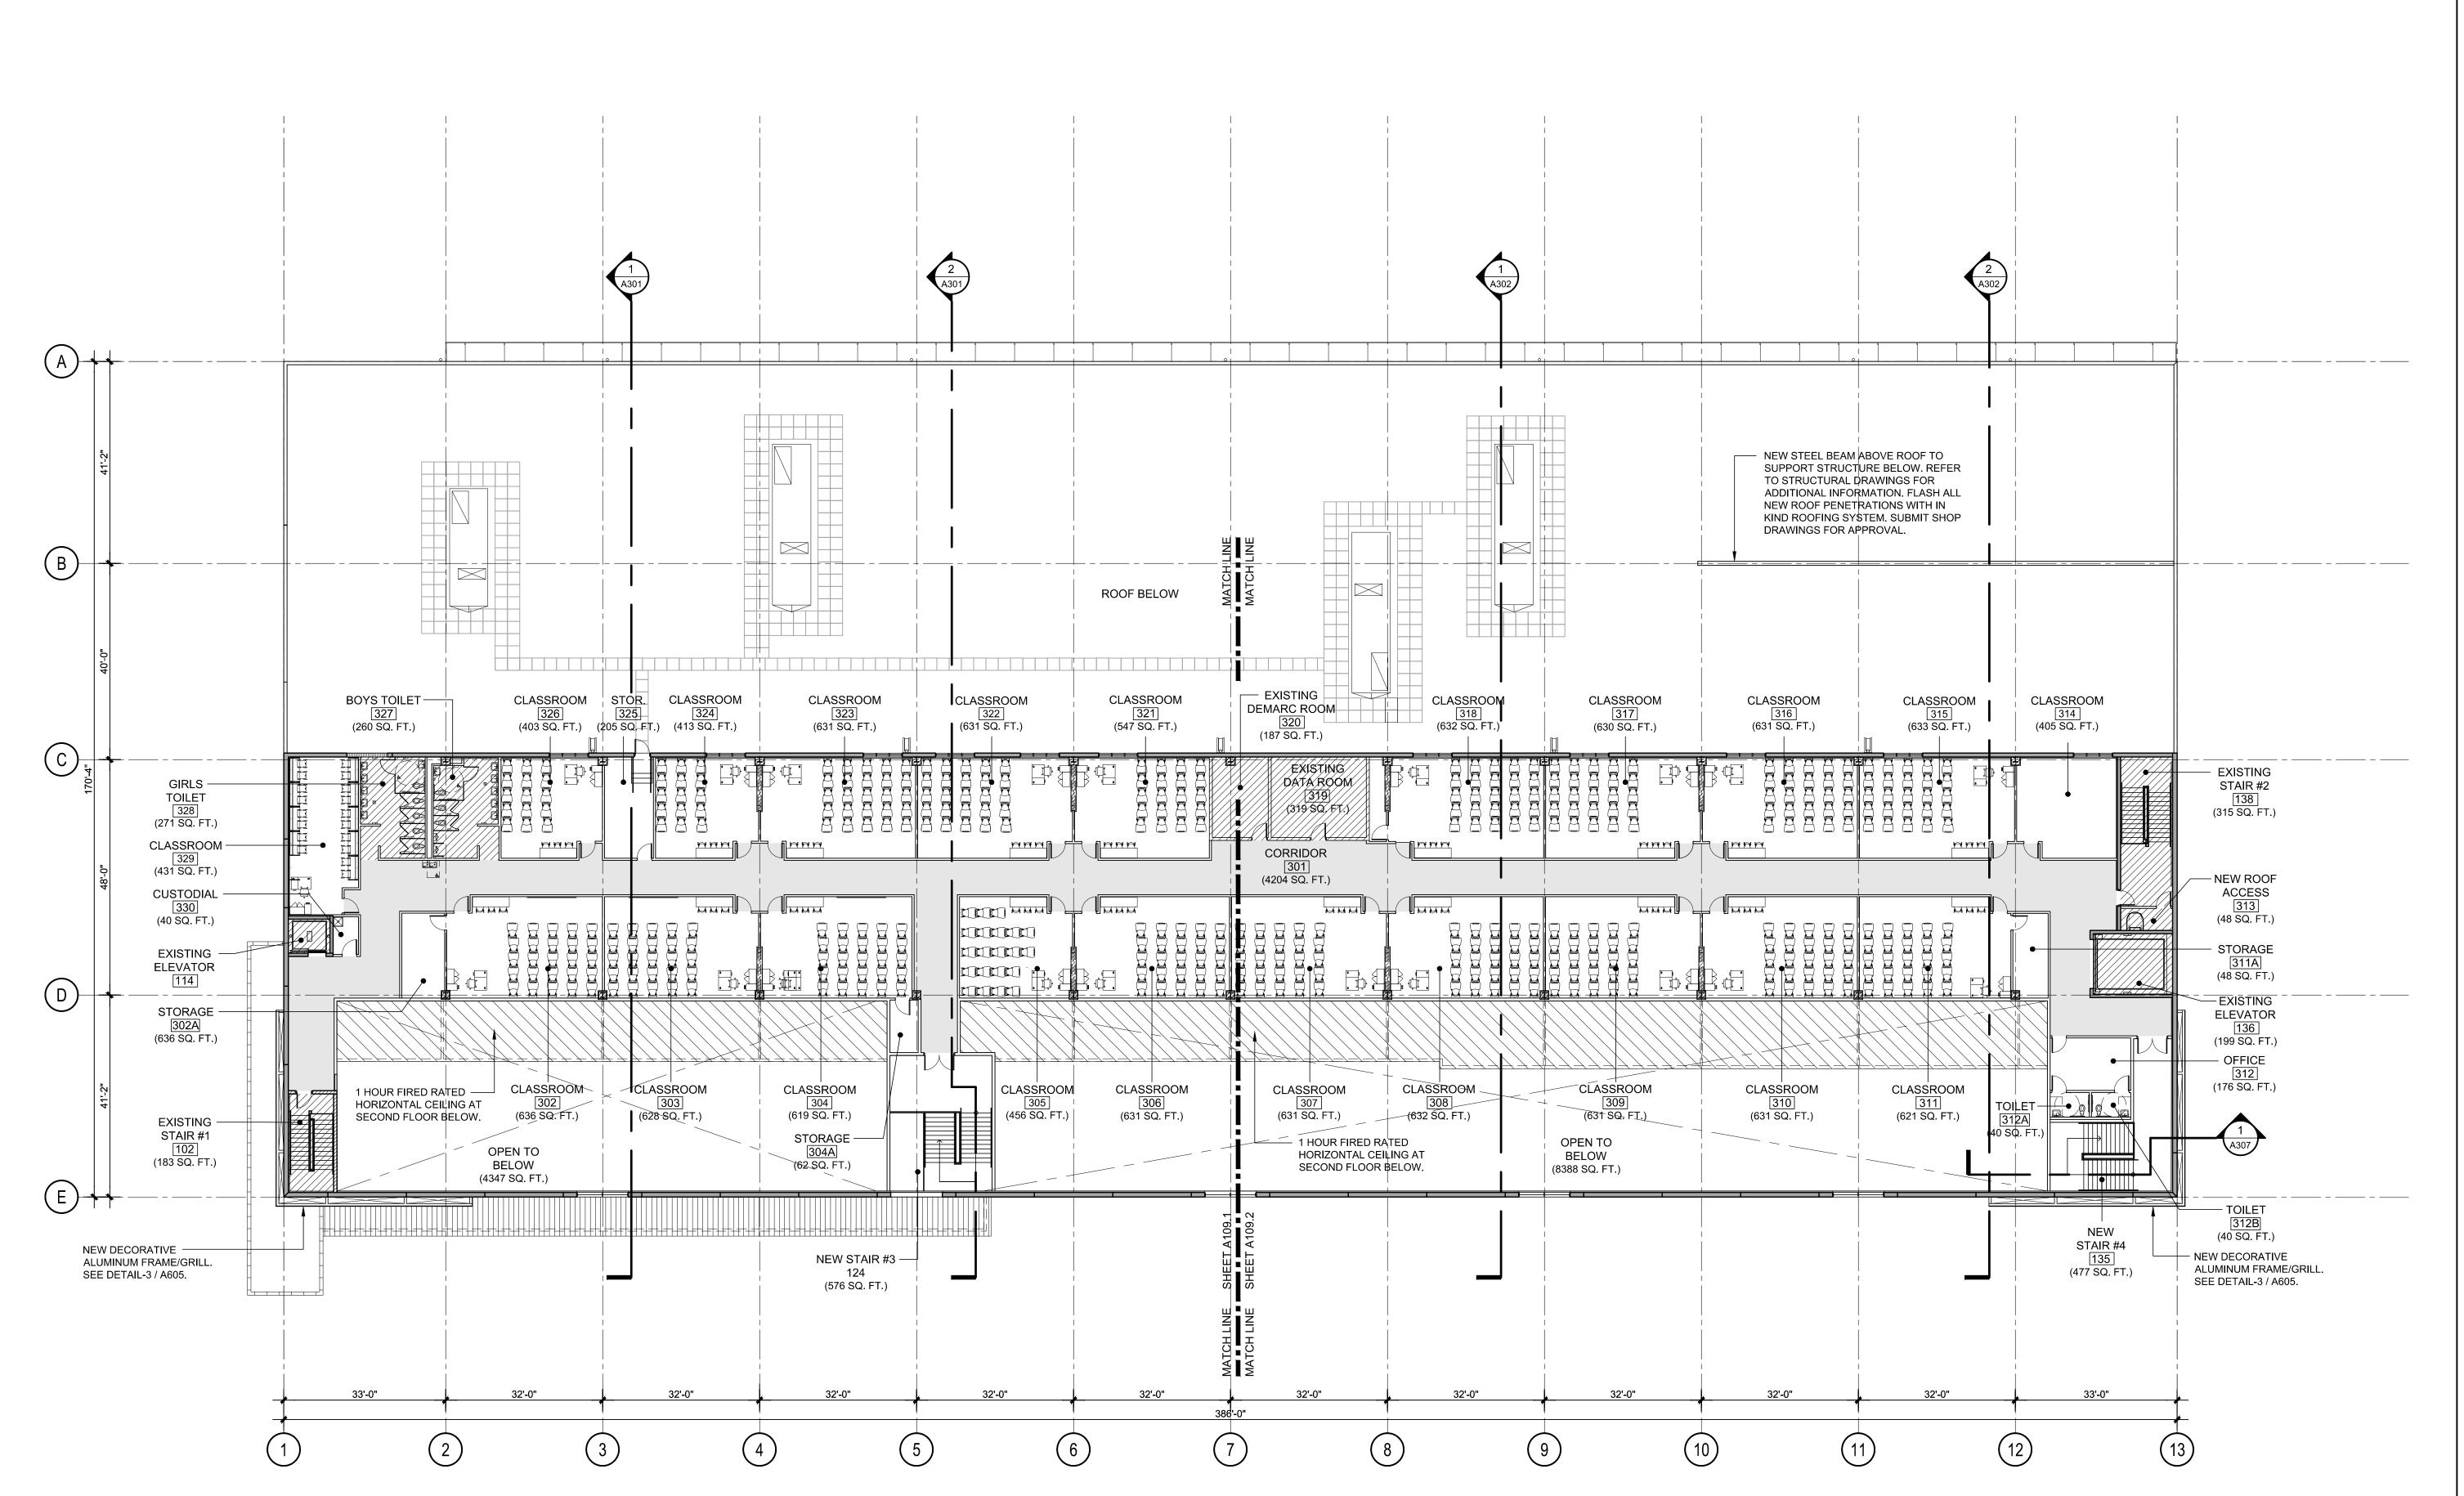
J.B.

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A.LL.

REF NUMBER:

A108
15 of 46





IN ASSOCIATION WITH:

PROFESSIONAL SEAL:



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PROJECT:

BRIDEPREP ACADEMY AT DORAL

3500 NW 89th COURT DORAL, FLORIDA 33172

DATE ISSUE DESCRIPTION

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SHEET TITLE:

PROPOSED OVERALL

THIRD FLOOR PLAN

DELIVERY DATE:

01.04.2021

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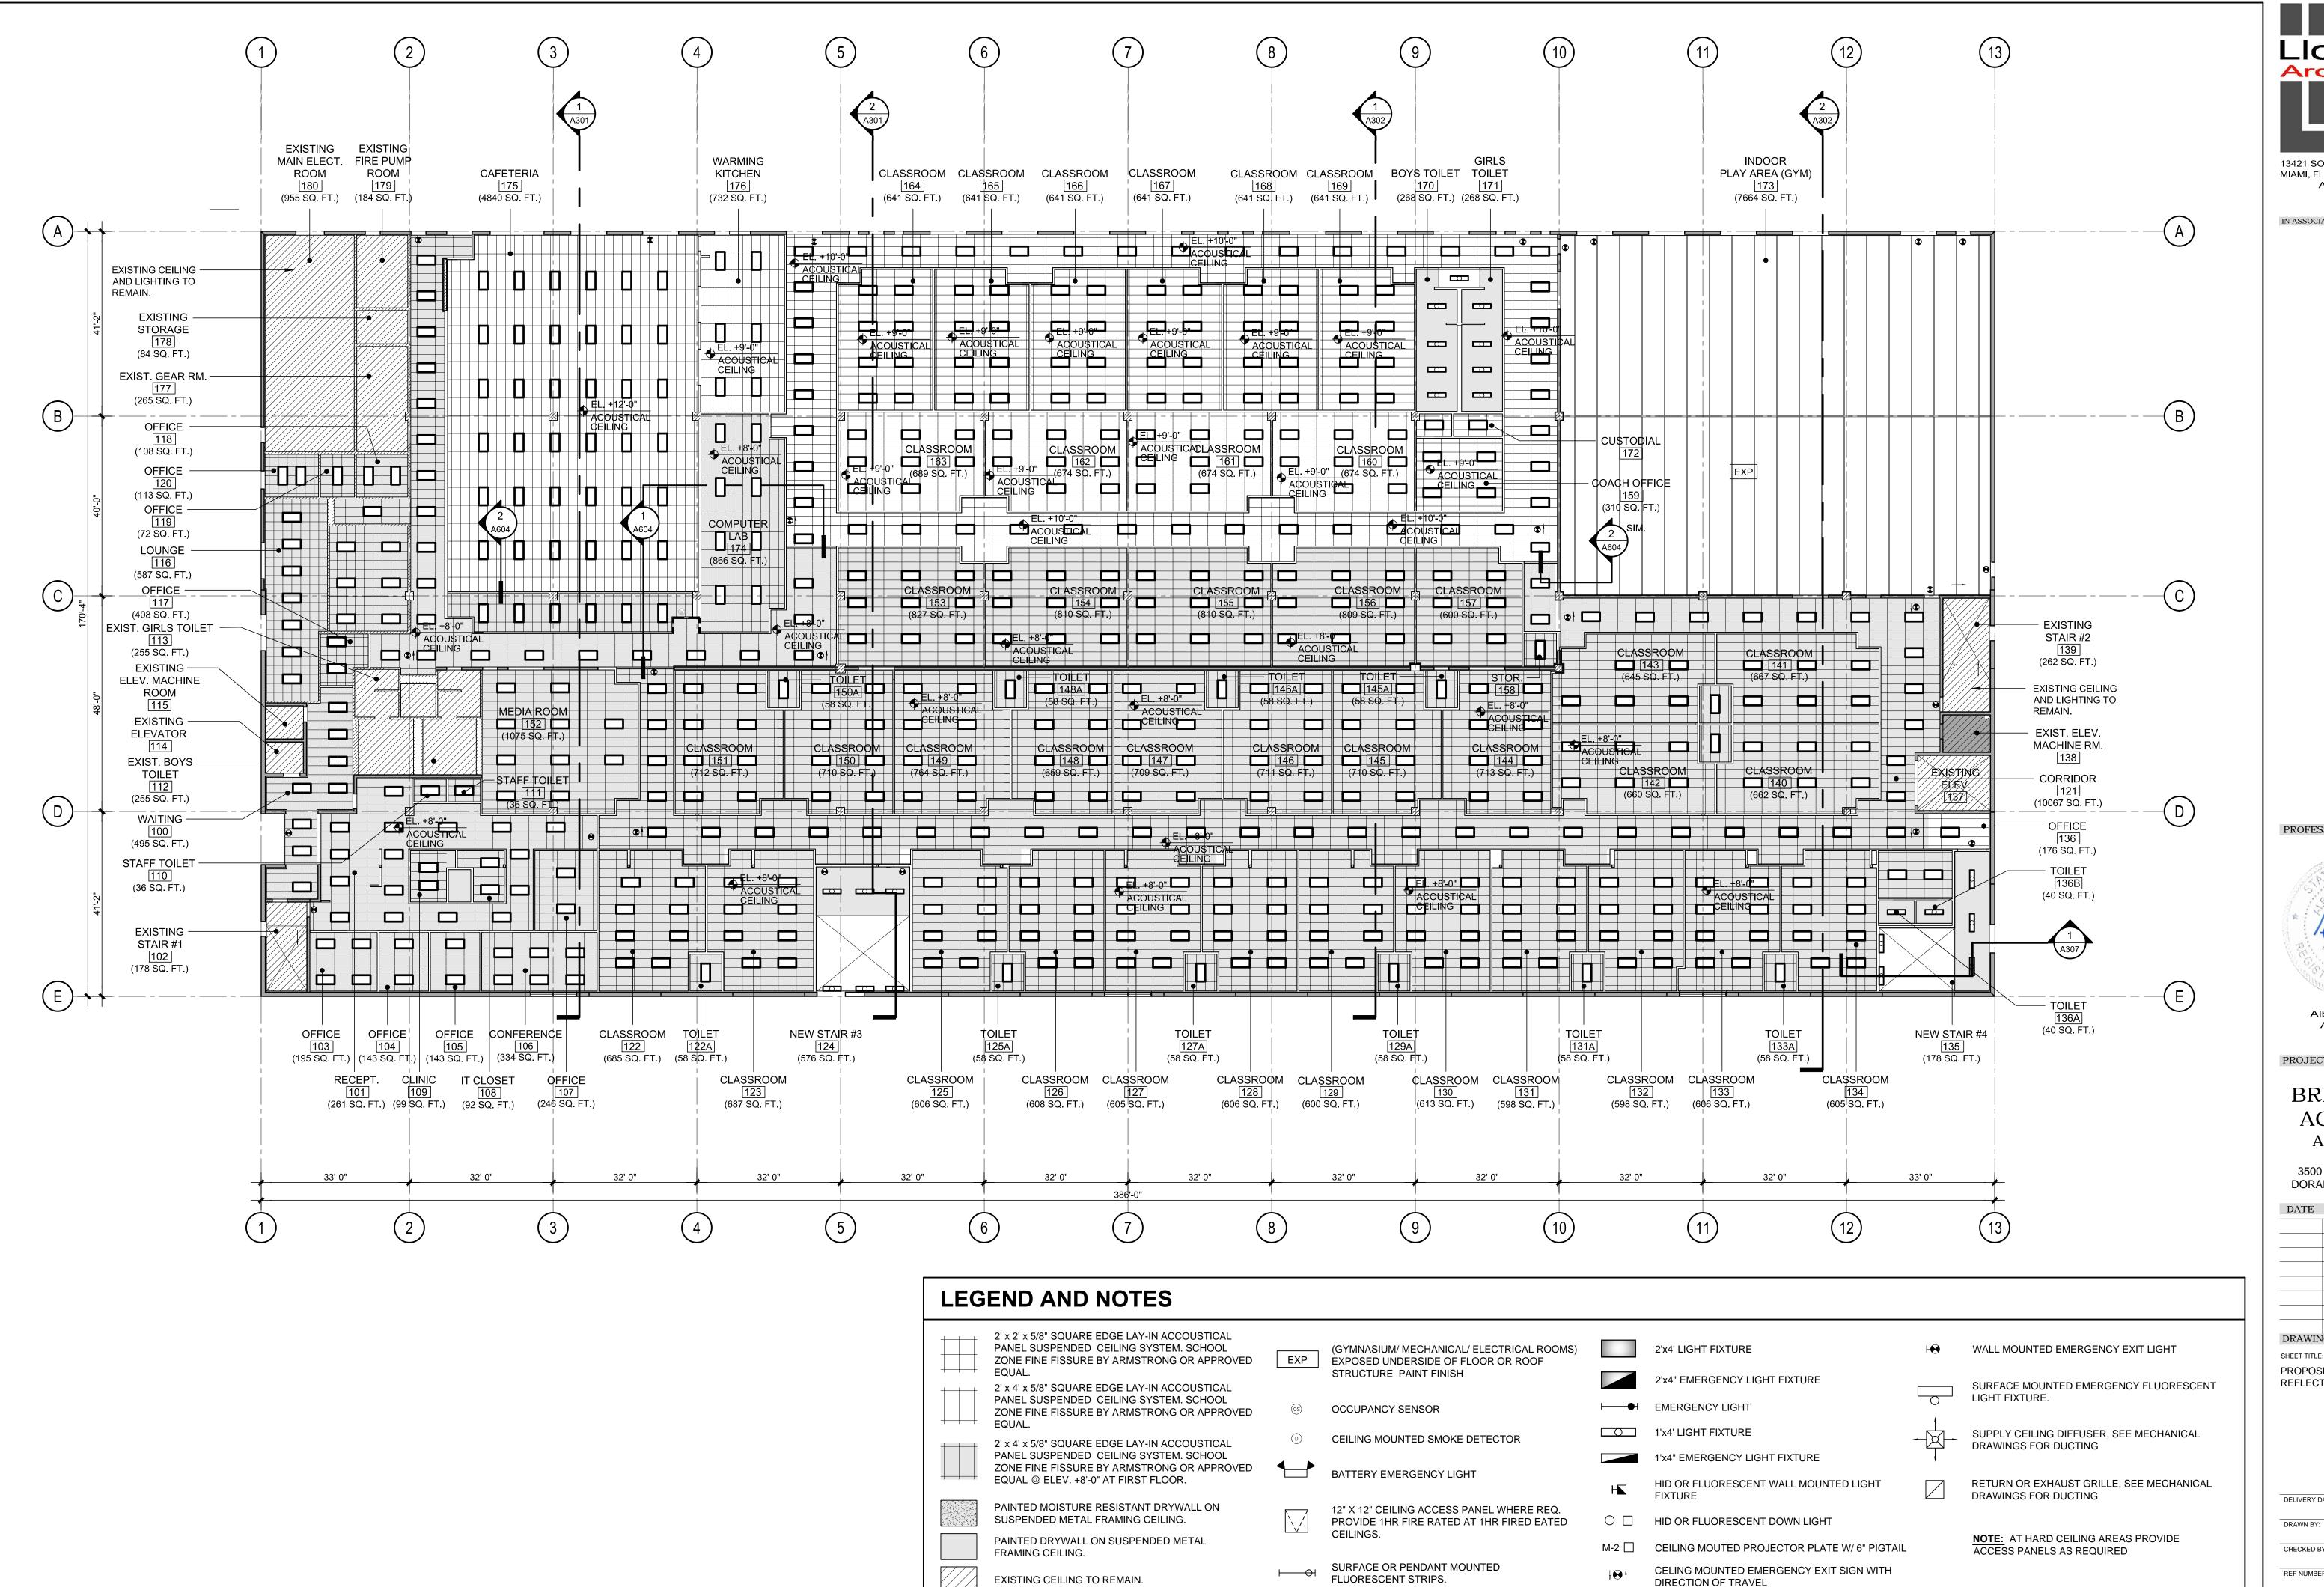
J.B.

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A.LL.

REF NUMBER:

A109 18 of 46



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PROJECT:

BRIDEPREP ACADEMY AT DORAL

3500 NW 89th COURT DORAL, FLORIDA 33172

DATE ISSUE DESCRIPTION

DRAWING INFORMATION:
SHEET TITLE:

PROPOSED FIRST FLOOR REFLECTED CEILING PLAN

DELIVERY DATE: 01.04.2021

DRAWN BY: J.B.


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REF NUMBER:



PANEL SUSPENDED CEILING SYSTEM. SCHOOL

2' x 4' x 5/8" SQUARE EDGE LAY-IN ACCOUSTICAL

PANEL SUSPENDED CEILING SYSTEM. SCHOOL

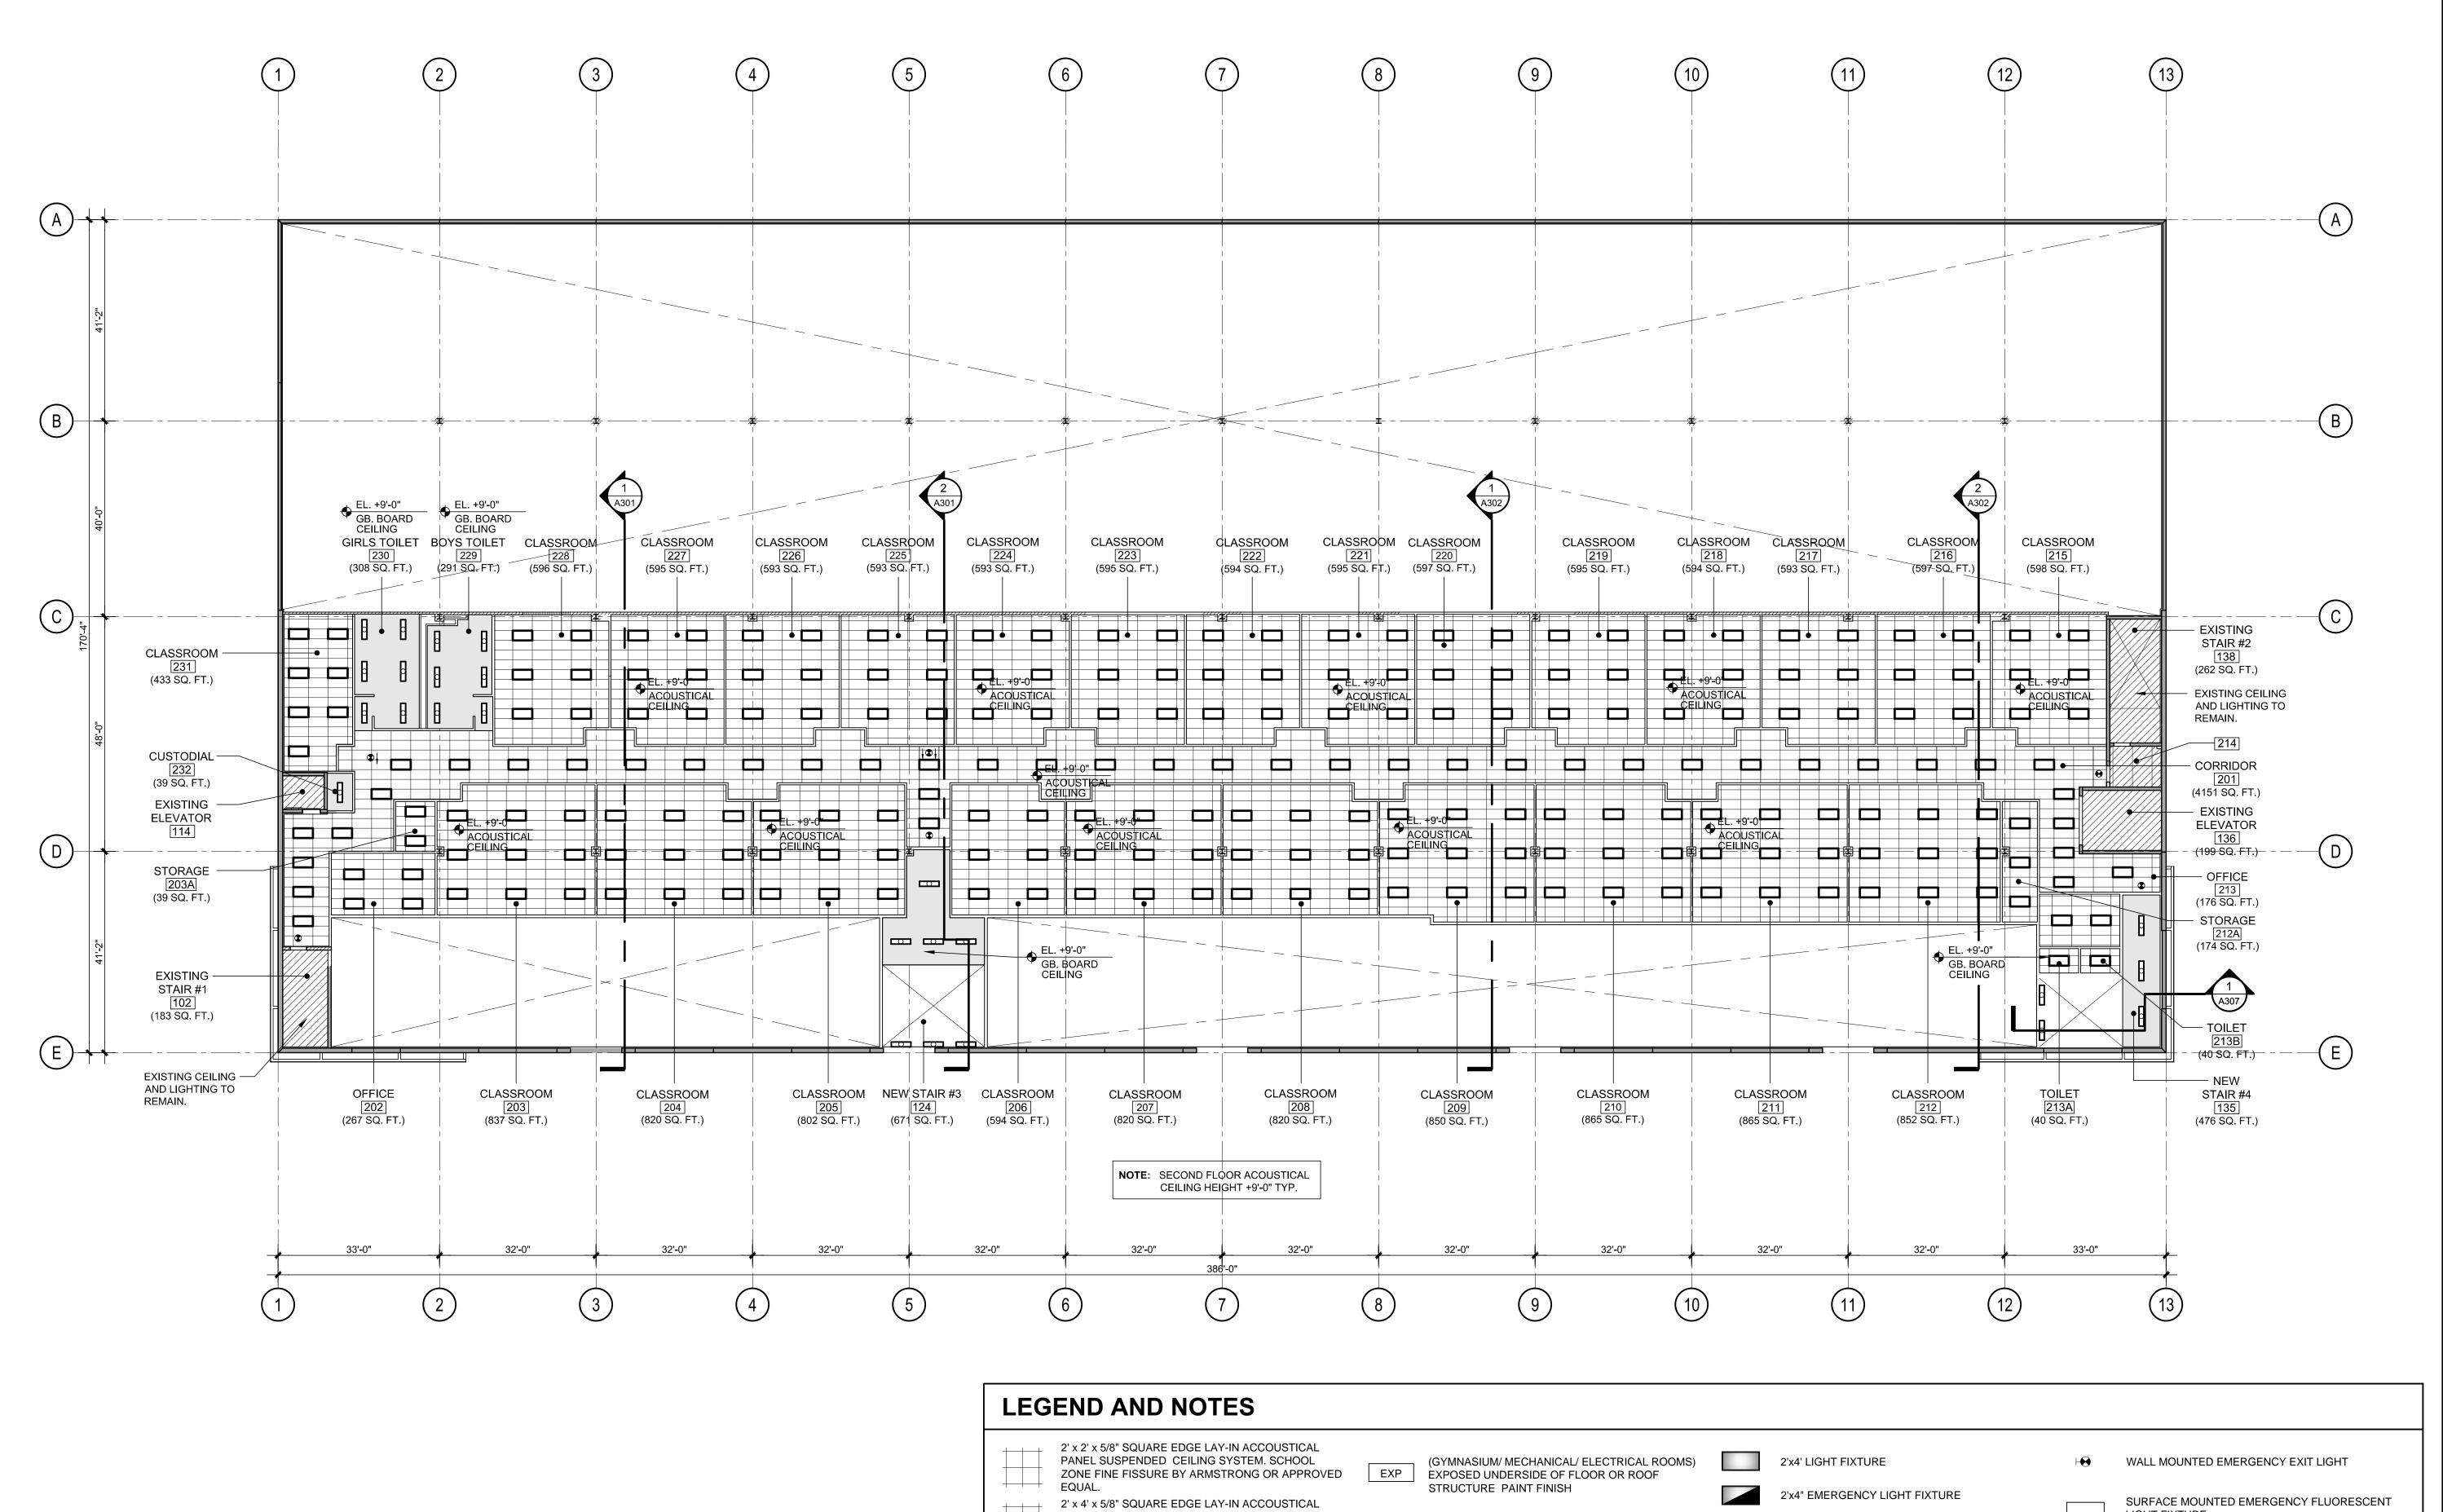PAINTED MOISTURE RESISTANT DRYWALL ON

PAINTED DRYWALL ON SUSPENDED METAL

EQUAL @ ELEV. +8'-0" AT FIRST FLOOR.

SUSPENDED METAL FRAMING CEILING.

EXISTING CEILING TO REMAIN.

EQUAL.

FRAMING CEILING.

ZONE FINE FISSURE BY ARMSTRONG OR APPROVED

ZONE FINE FISSURE BY ARMSTRONG OR APPROVED

OCCUPANCY SENSOR

CEILING MOUNTED SMOKE DETECTOR

SURFACE OR PENDANT MOUNTED

FLUORESCENT STRIPS.

12" X 12" CEILING ACCESS PANEL WHERE REQ.

PROVIDE 1HR FIRE RATED AT 1HR FIRED EATED

BATTERY EMERGENCY LIGHT



IN ASSOCIATION WITH:

OFESSIONAL SEAL:



AR-0012031

PROJECT:

BRIDEPREP ACADEMY AT DORAL

3500 NW 89th COURT DORAL, FLORIDA 33172

DATE ISSUE DESCRIPTION

DRAWING INFORMATION:
SHEET TITLE:

PROPOSED SECOND FLOOR REFLECTED CEILING PLAN

LIGHT FIXTURE.

DRAWINGS FOR DUCTING

DRAWINGS FOR DUCTING

SUPPLY CEILING DIFFUSER, SEE MECHANICAL

RETURN OR EXHAUST GRILLE, SEE MECHANICAL

**NOTE:** AT HARD CEILING AREAS PROVIDE

ACCESS PANELS AS REQUIRED

► EMERGENCY LIGHT

1'x4' LIGHT FIXTURE

1'x4" EMERGENCY LIGHT FIXTURE

○ ☐ HID OR FLUORESCENT DOWN LIGHT

DIRECTION OF TRAVEL

HID OR FLUORESCENT WALL MOUNTED LIGHT

CEILING MOUTED PROJECTOR PLATE W/ 6" PIGTAIL

CELING MOUNTED EMERGENCY EXIT SIGN WITH

DELIVERY DATE: 01.04.2021

DRAWN BY:

J.B.

CHECKED BY:


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REF NUMBER:

SHEET NO.

A111

22 OF 46

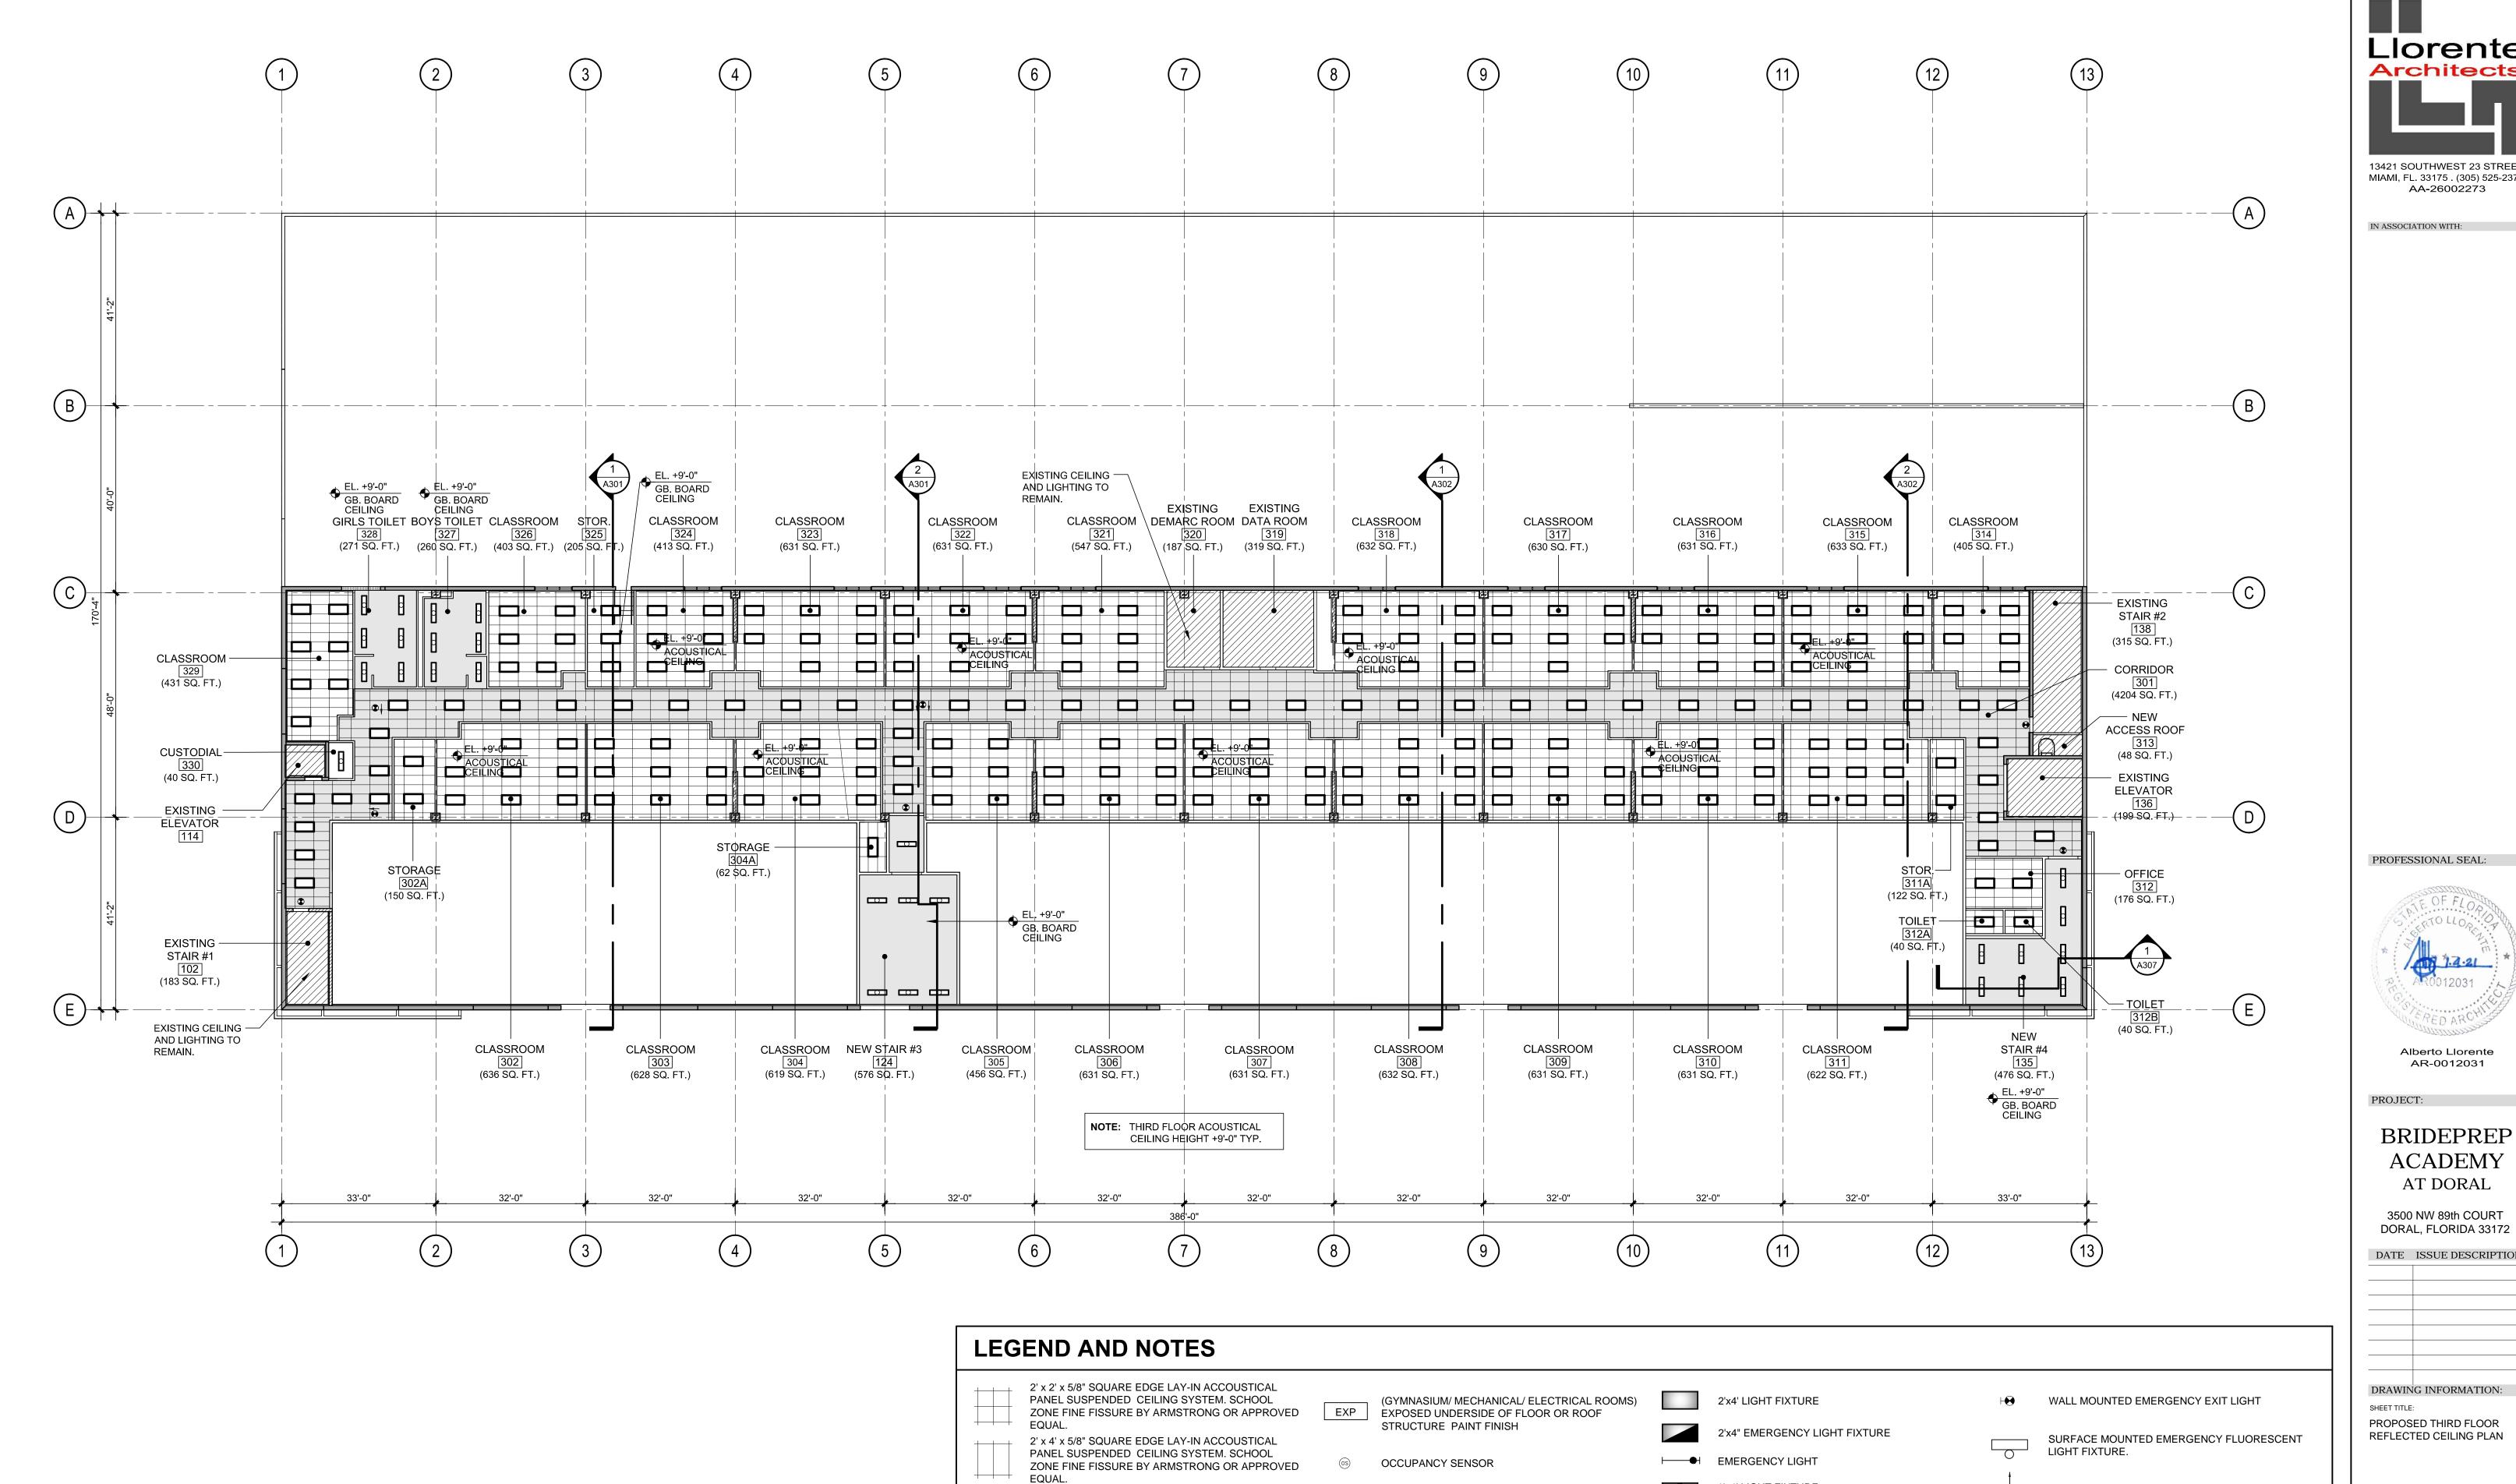

2' x 4' x 5/8" SQUARE EDGE LAY-IN ACCOUSTICAL

PANEL SUSPENDED CEILING SYSTEM. SCHOOL

PAINTED MOISTURE RESISTANT DRYWALL ON

PAINTED DRYWALL ON SUSPENDED METAL

EQUAL @ ELEV. +8'-0" AT FIRST FLOOR.

SUSPENDED METAL FRAMING CEILING.

FRAMING CEILING.

EXISTING CEILING TO REMAIN.

ZONE FINE FISSURE BY ARMSTRONG OR APPROVED



AA-26002273

PROFESSIONAL SEAL:



Alberto Llorente AR-0012031

PROJECT:

**BRIDEPREP ACADEMY** AT DORAL

3500 NW 89th COURT DORAL, FLORIDA 33172

DATE ISSUE DESCRIPTION

DRAWING INFORMATION:

PROPOSED THIRD FLOOR REFLECTED CEILING PLAN

SUPPLY CEILING DIFFUSER, SEE MECHANICAL

RETURN OR EXHAUST GRILLE, SEE MECHANICAL

**NOTE:** AT HARD CEILING AREAS PROVIDE

ACCESS PANELS AS REQUIRED

DRAWINGS FOR DUCTING

DRAWINGS FOR DUCTING

1'x4' LIGHT FIXTURE

1'x4" EMERGENCY LIGHT FIXTURE

○ ☐ HID OR FLUORESCENT DOWN LIGHT

DIRECTION OF TRAVEL

HID OR FLUORESCENT WALL MOUNTED LIGHT

CEILING MOUTED PROJECTOR PLATE W/ 6" PIGTAIL

CELING MOUNTED EMERGENCY EXIT SIGN WITH

CEILING MOUNTED SMOKE DETECTOR

SURFACE OR PENDANT MOUNTED

FLUORESCENT STRIPS.

12" X 12" CEILING ACCESS PANEL WHERE REQ.


PROVIDE 1HR FIRE RATED AT 1HR FIRED EATED


BATTERY EMERGENCY LIGHT


DELIVERY DATE: 01.04.2021 DRAWN BY:

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> A112 23 of 46



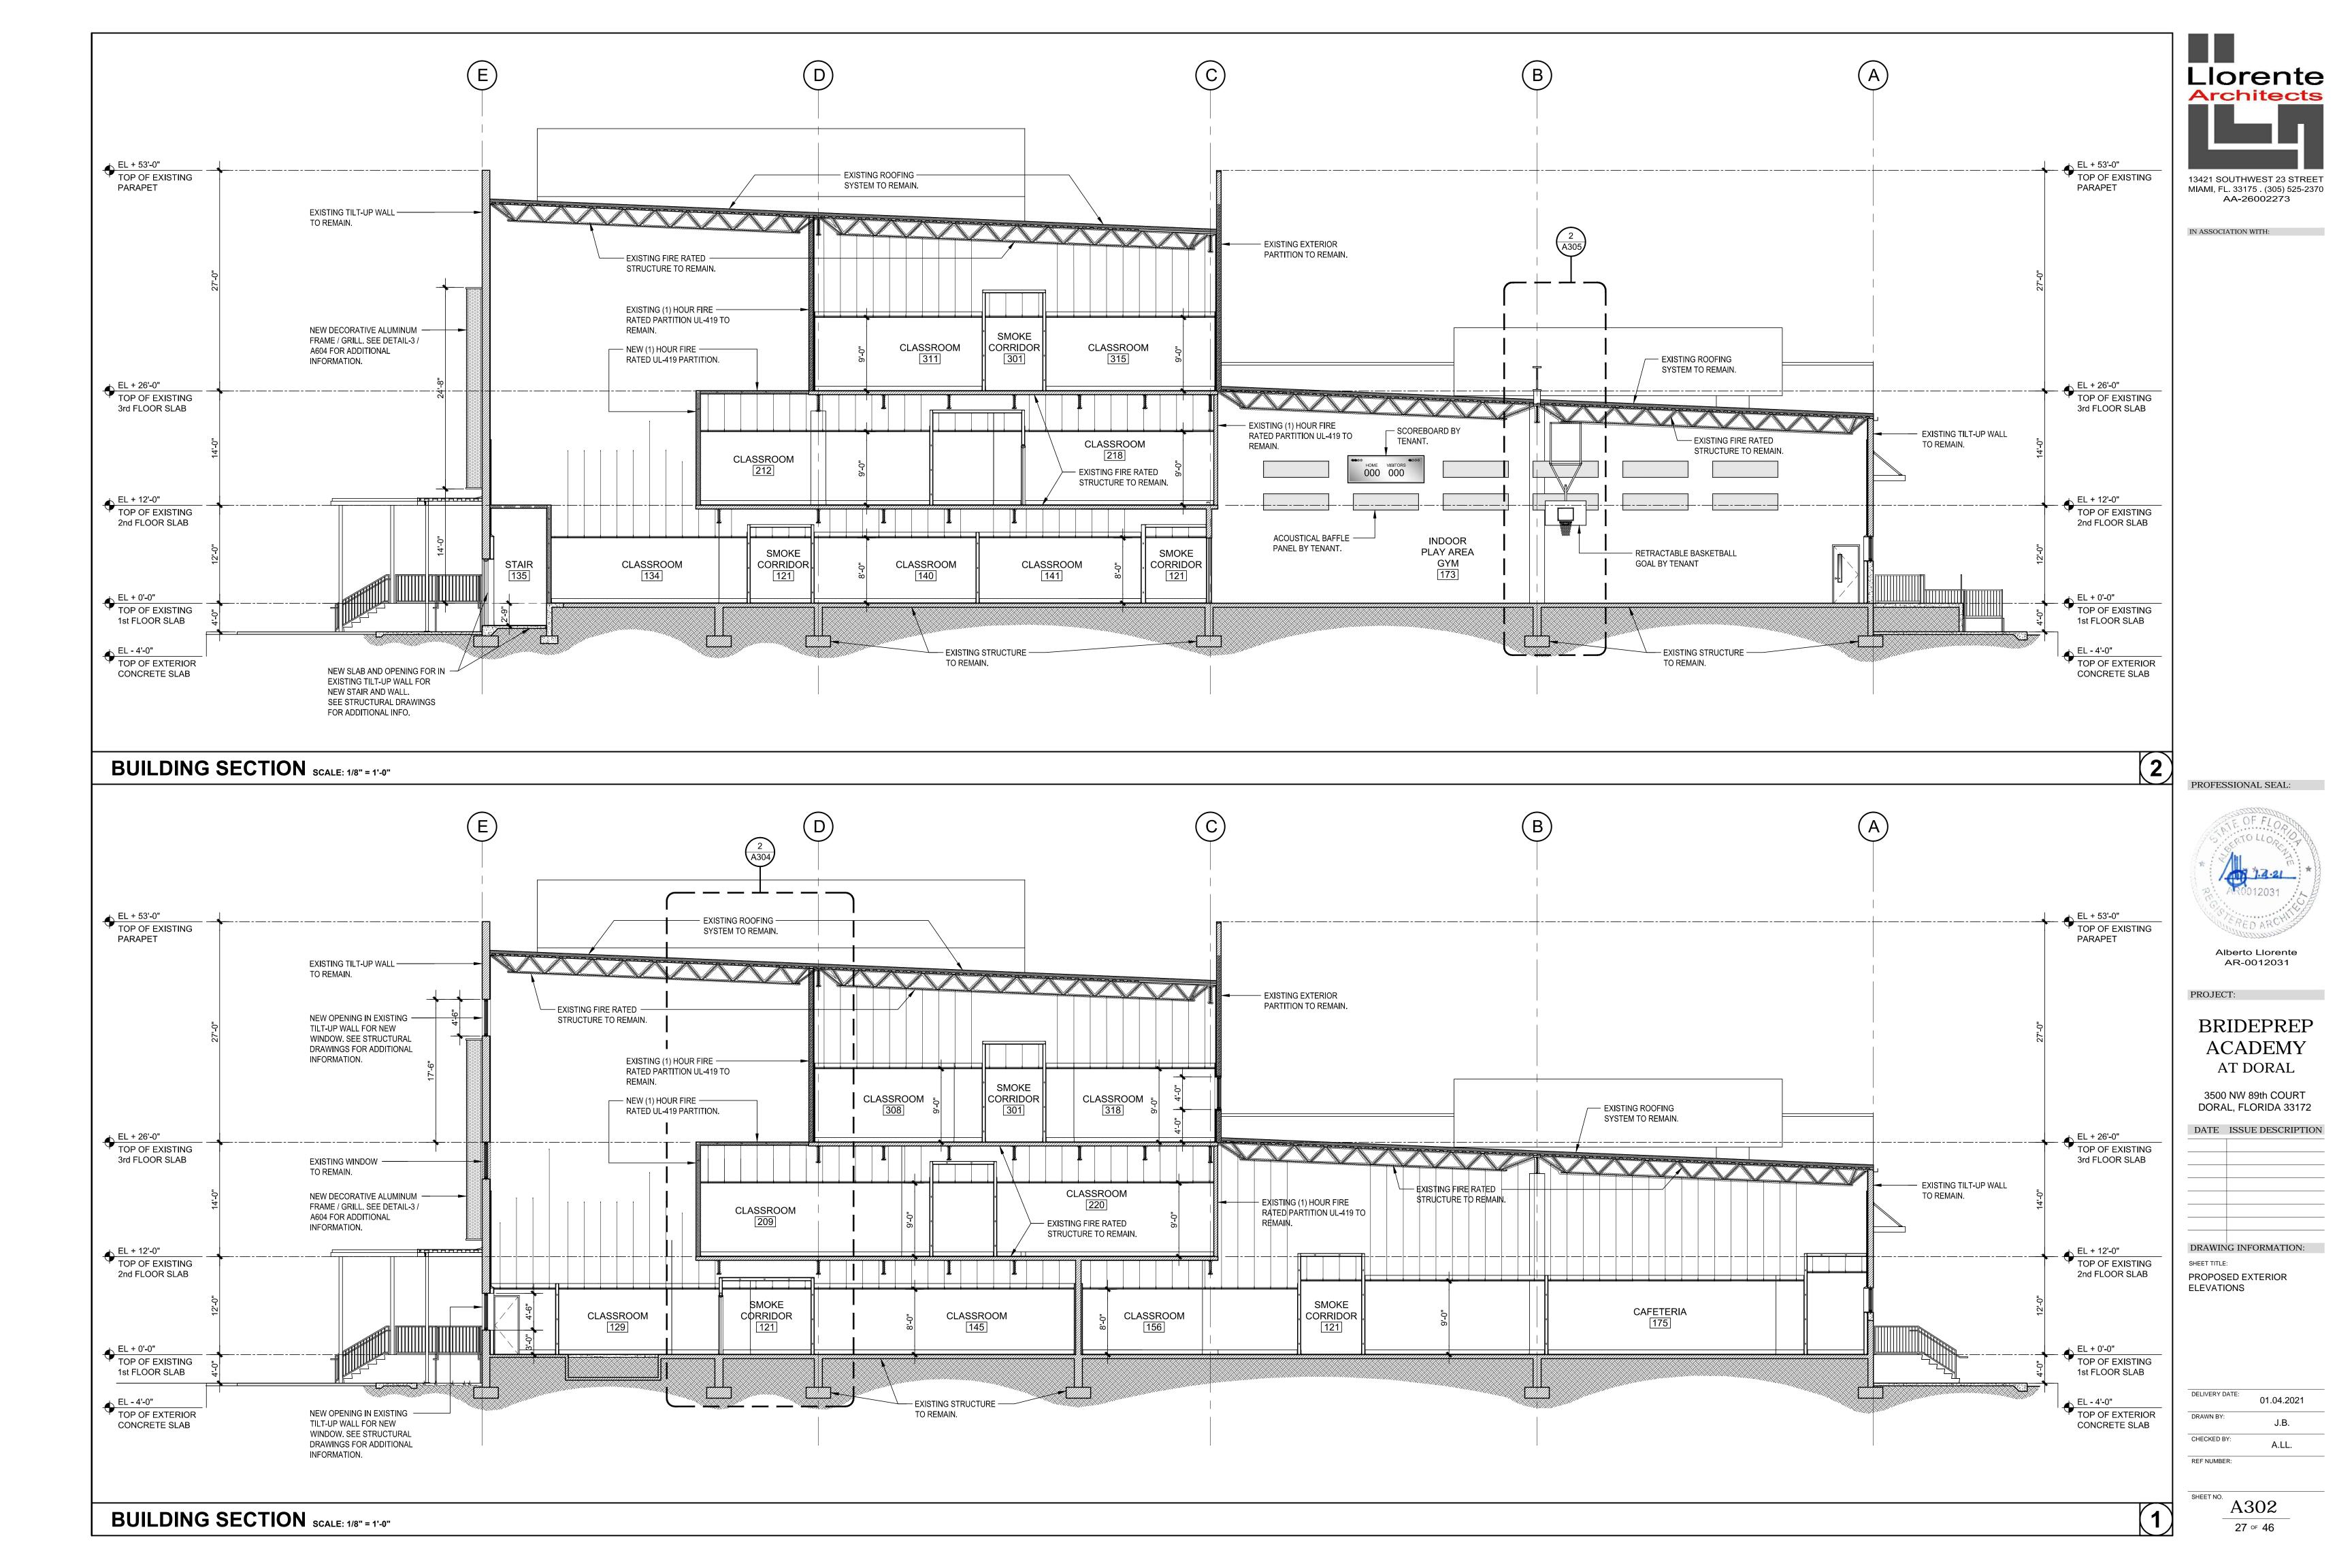

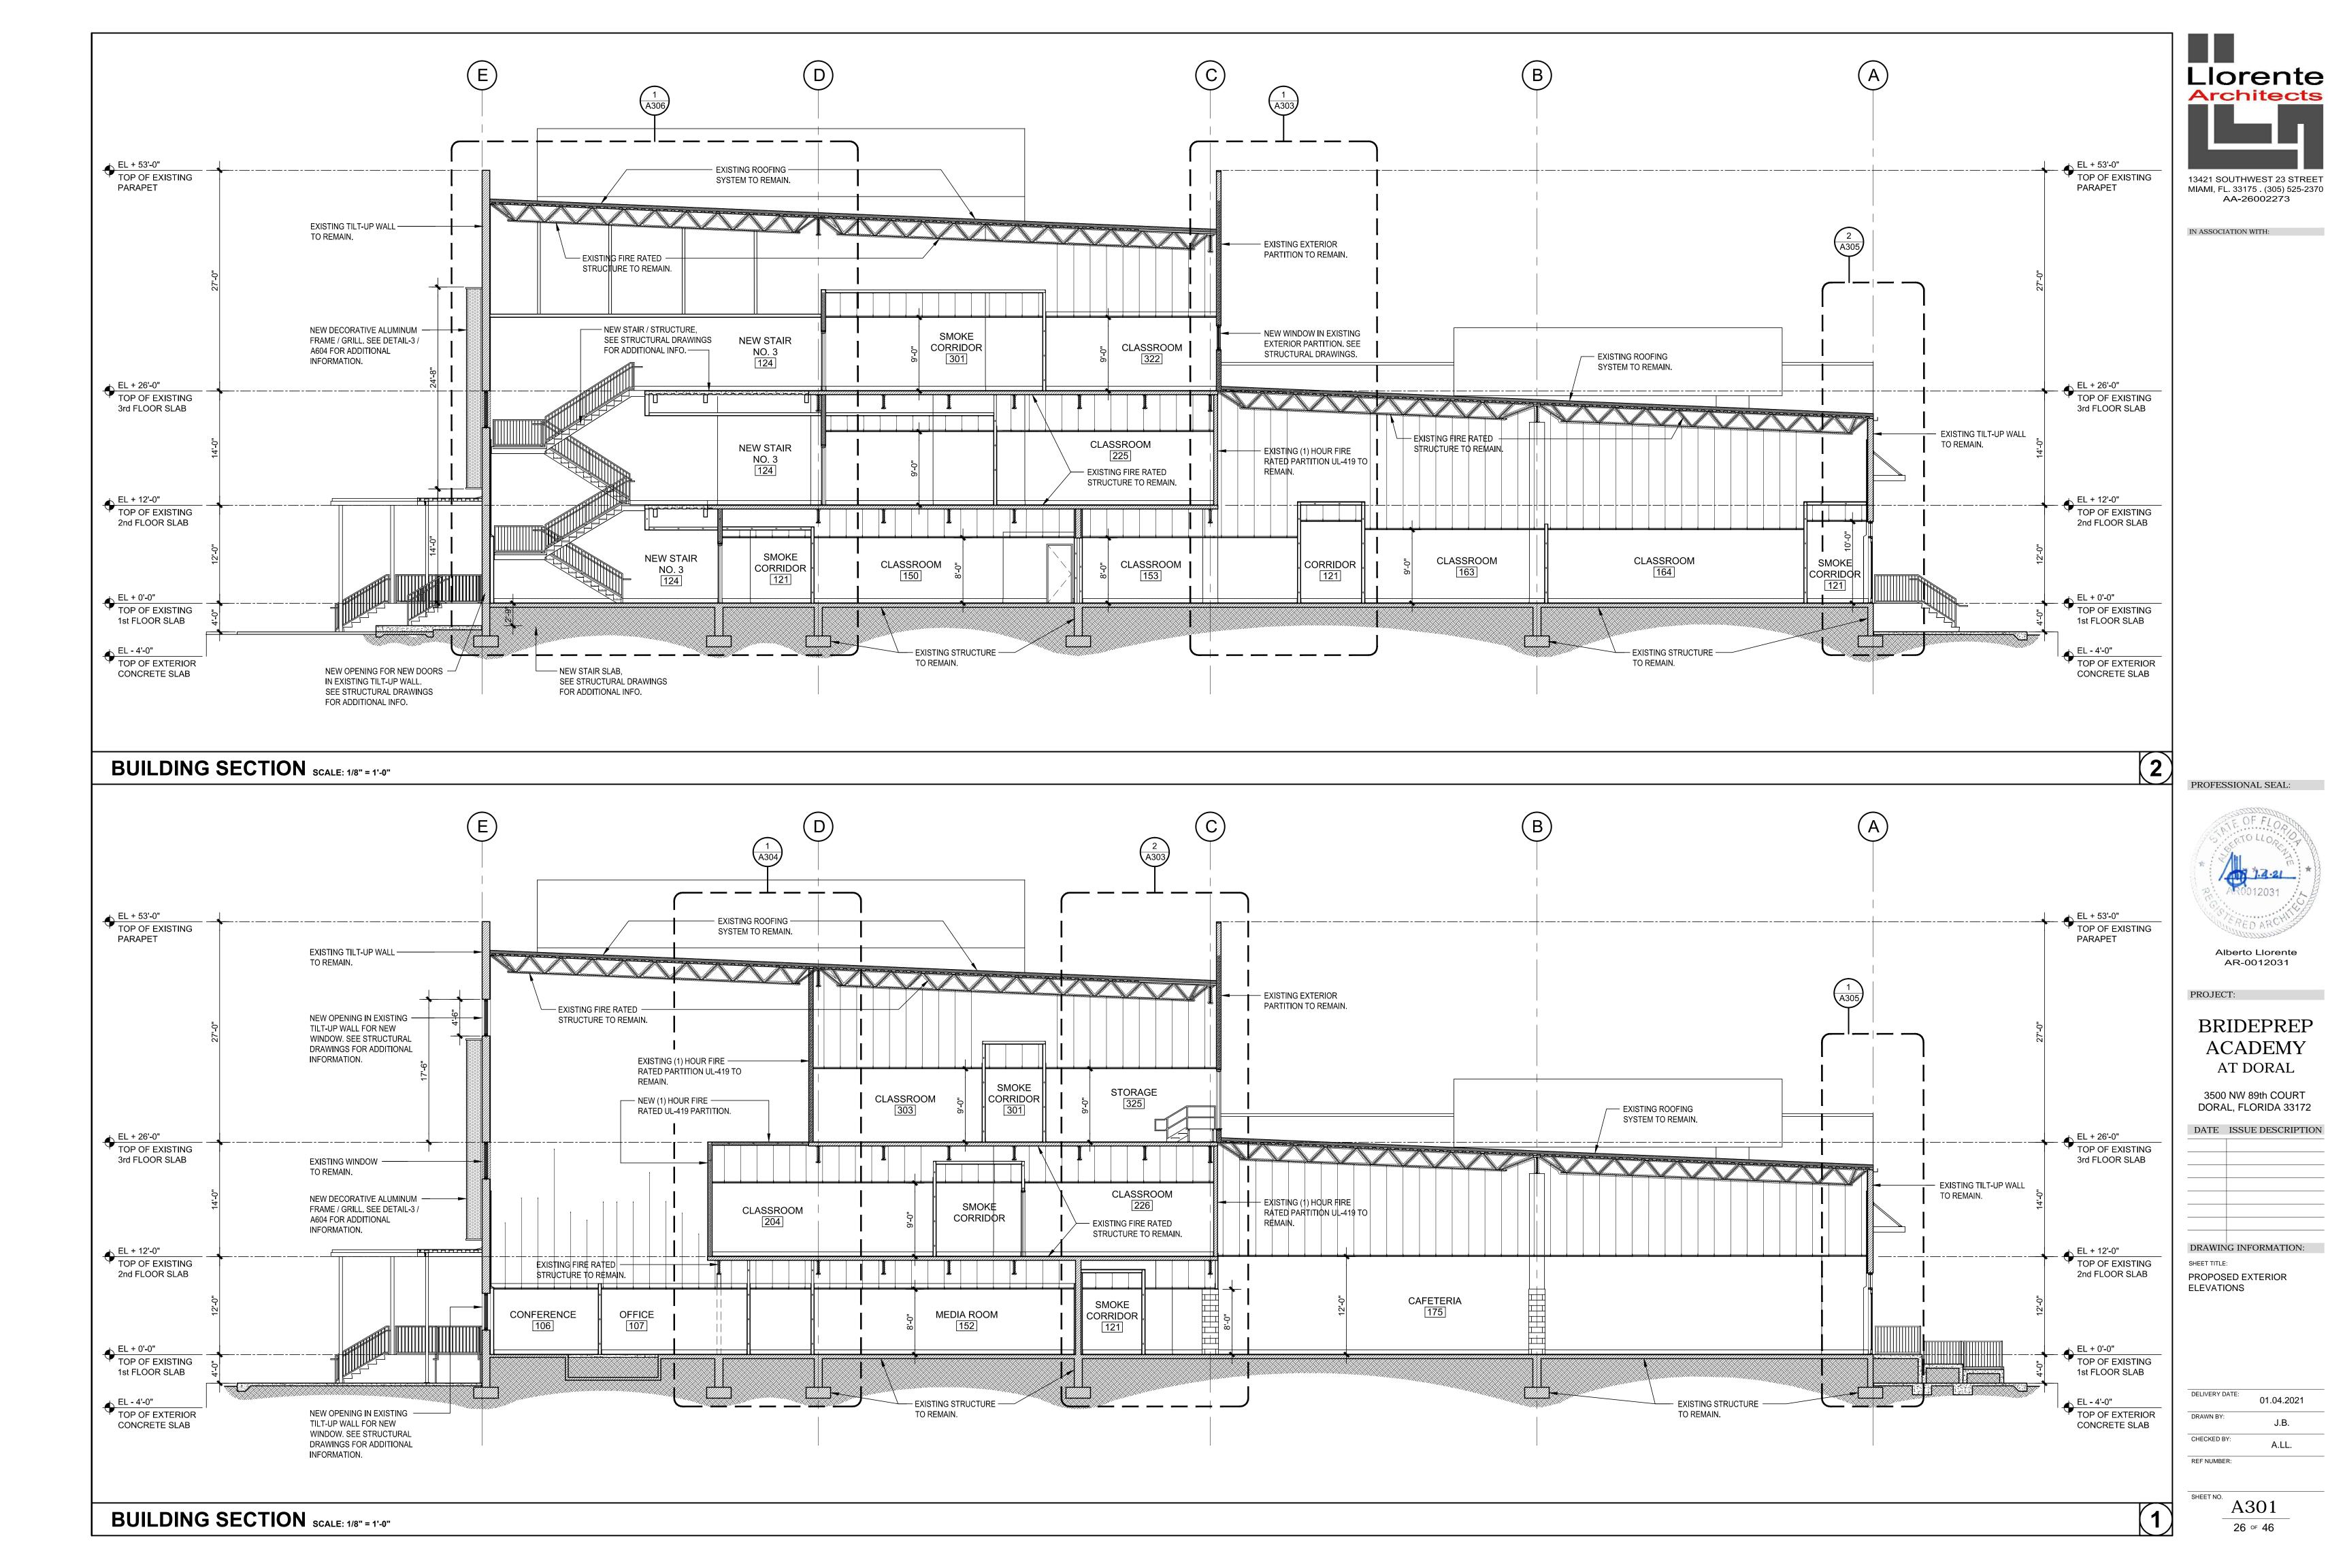

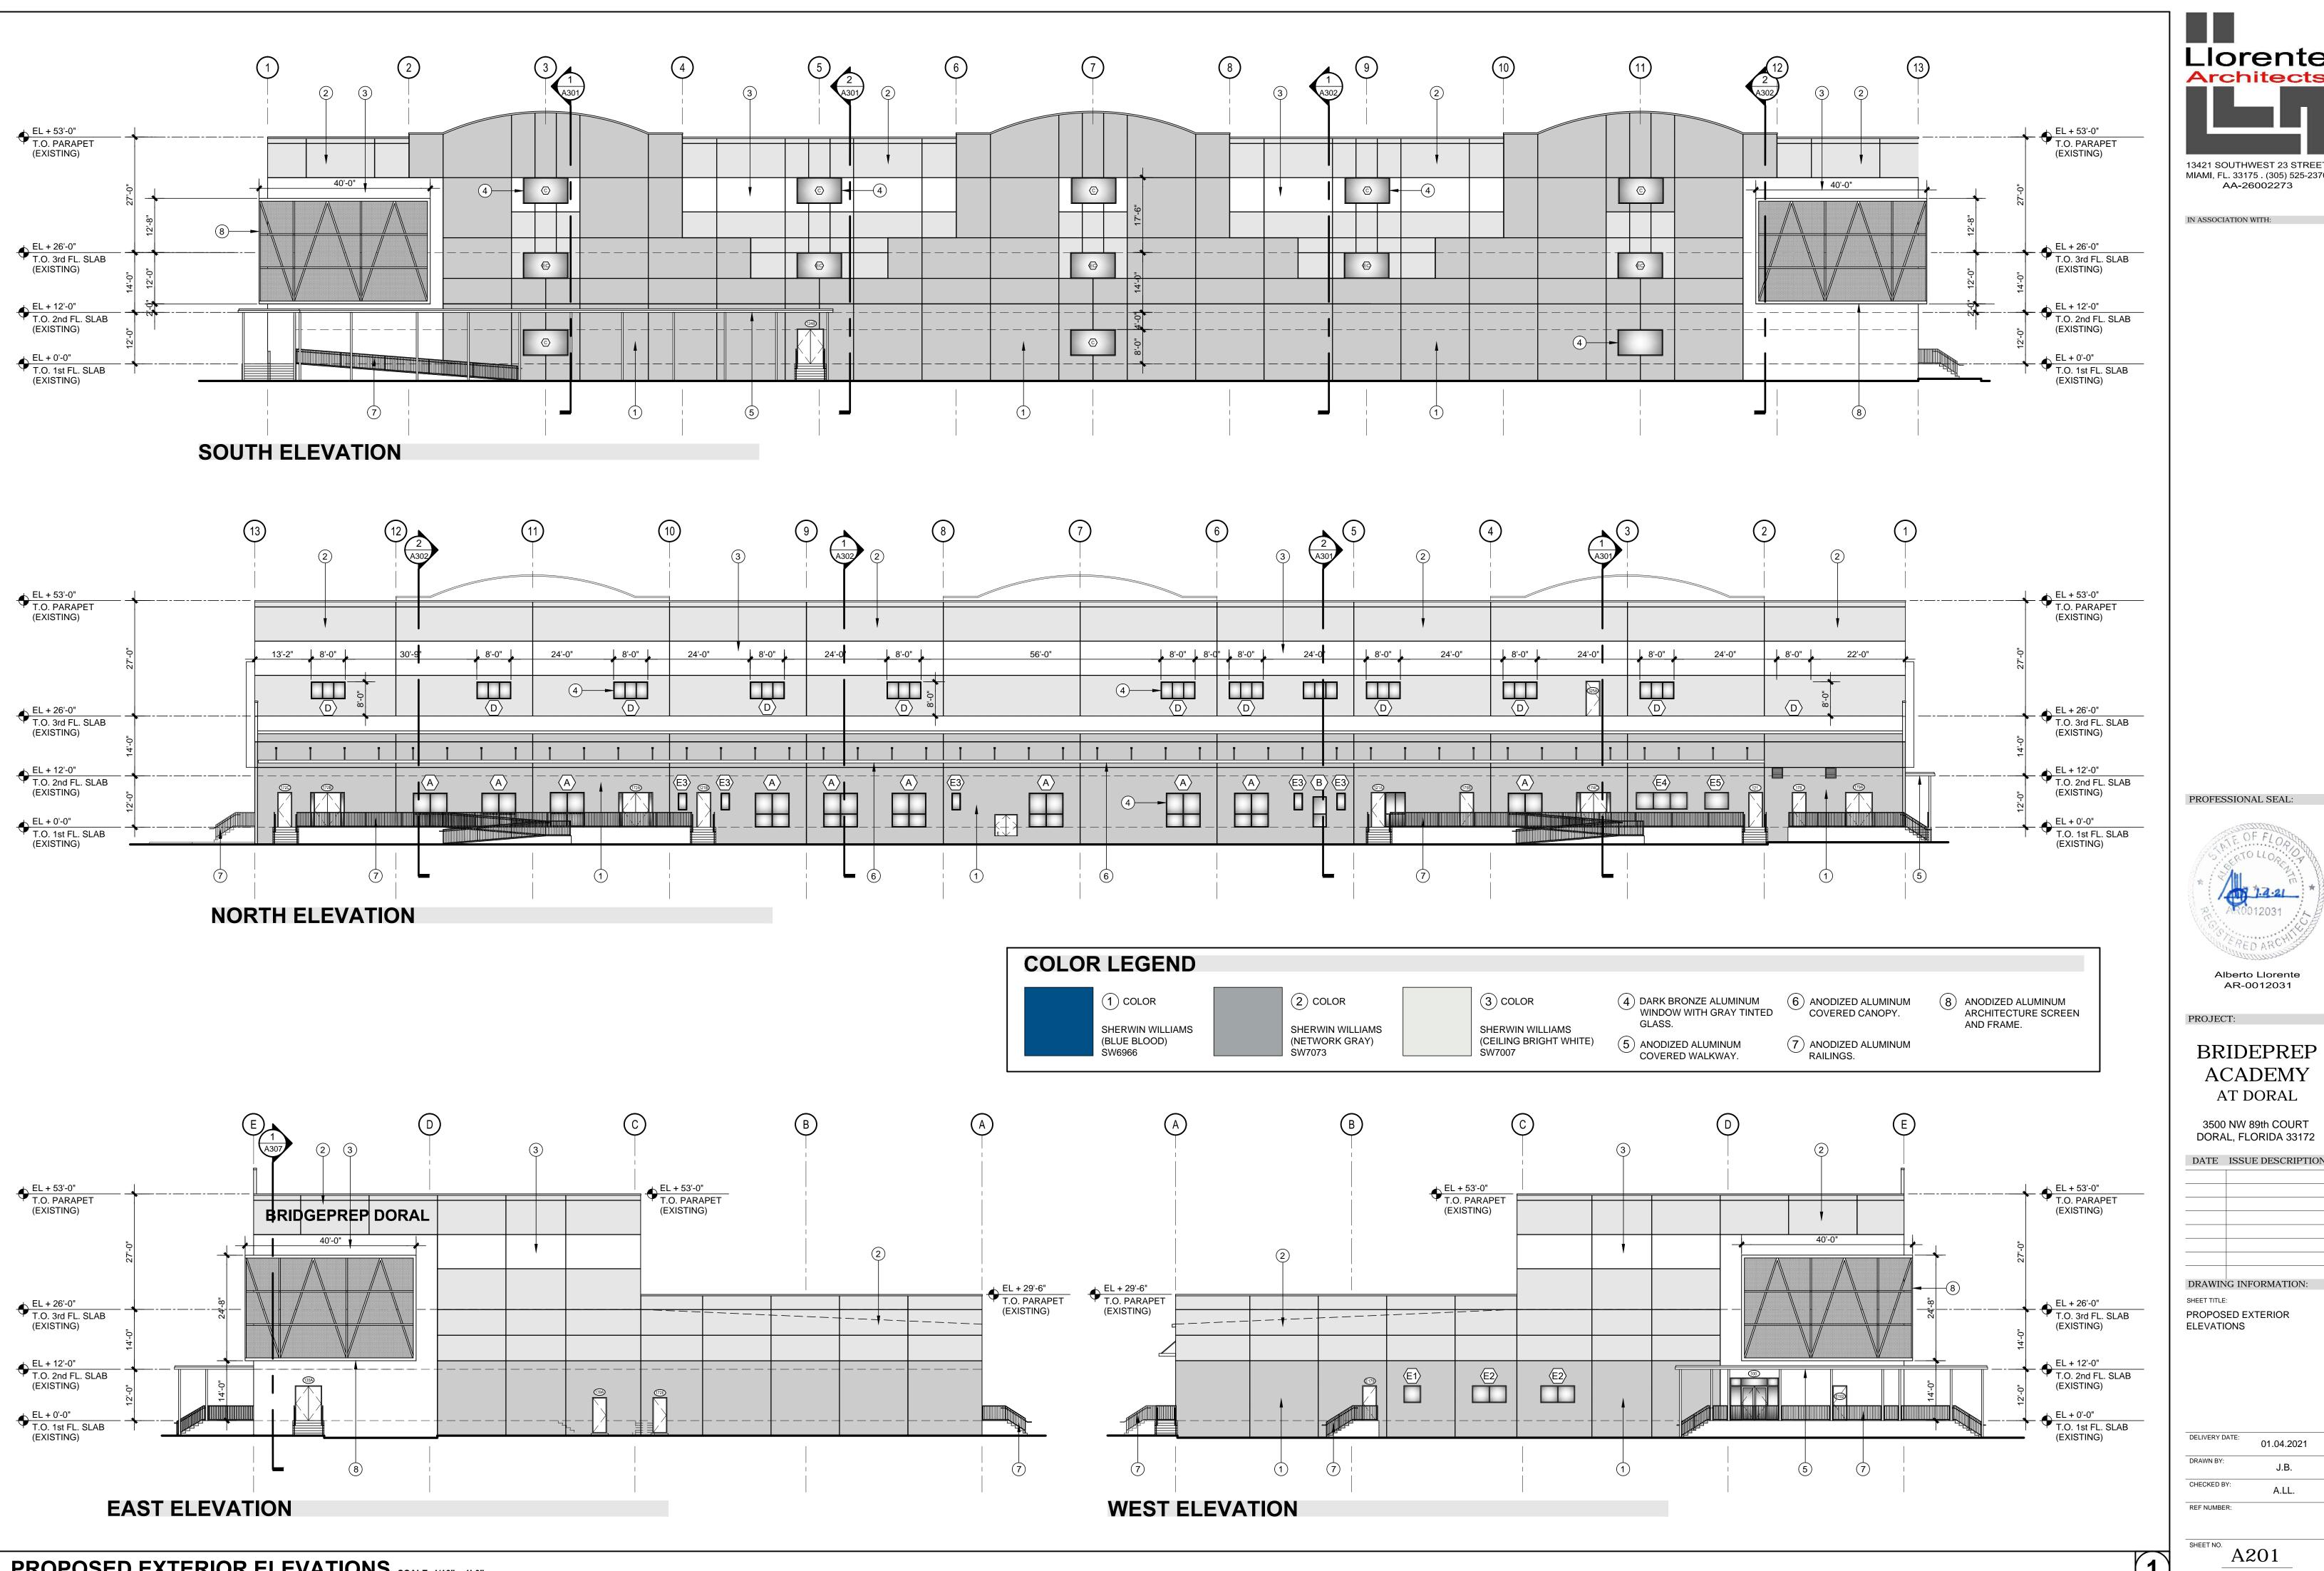Llorente **Architects** 13421 SOUTHWEST 23 STREET MIAMI, FL. 33175 . (305) 525-2370

AA-26002273

IN ASSOCIATION WITH:

PROFESSIONAL SEAL:



Alberto Llorente AR-0012031

PROJECT:

BRIDEPREP **ACADEMY** AT DORAL


3500 NW 89th COURT DORAL, FLORIDA 33172


DRAWING INFORMATION: SHEET TITLE: PROPOSED EXTERIOR

DELIVERY DATE: 01.04.2021

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A201



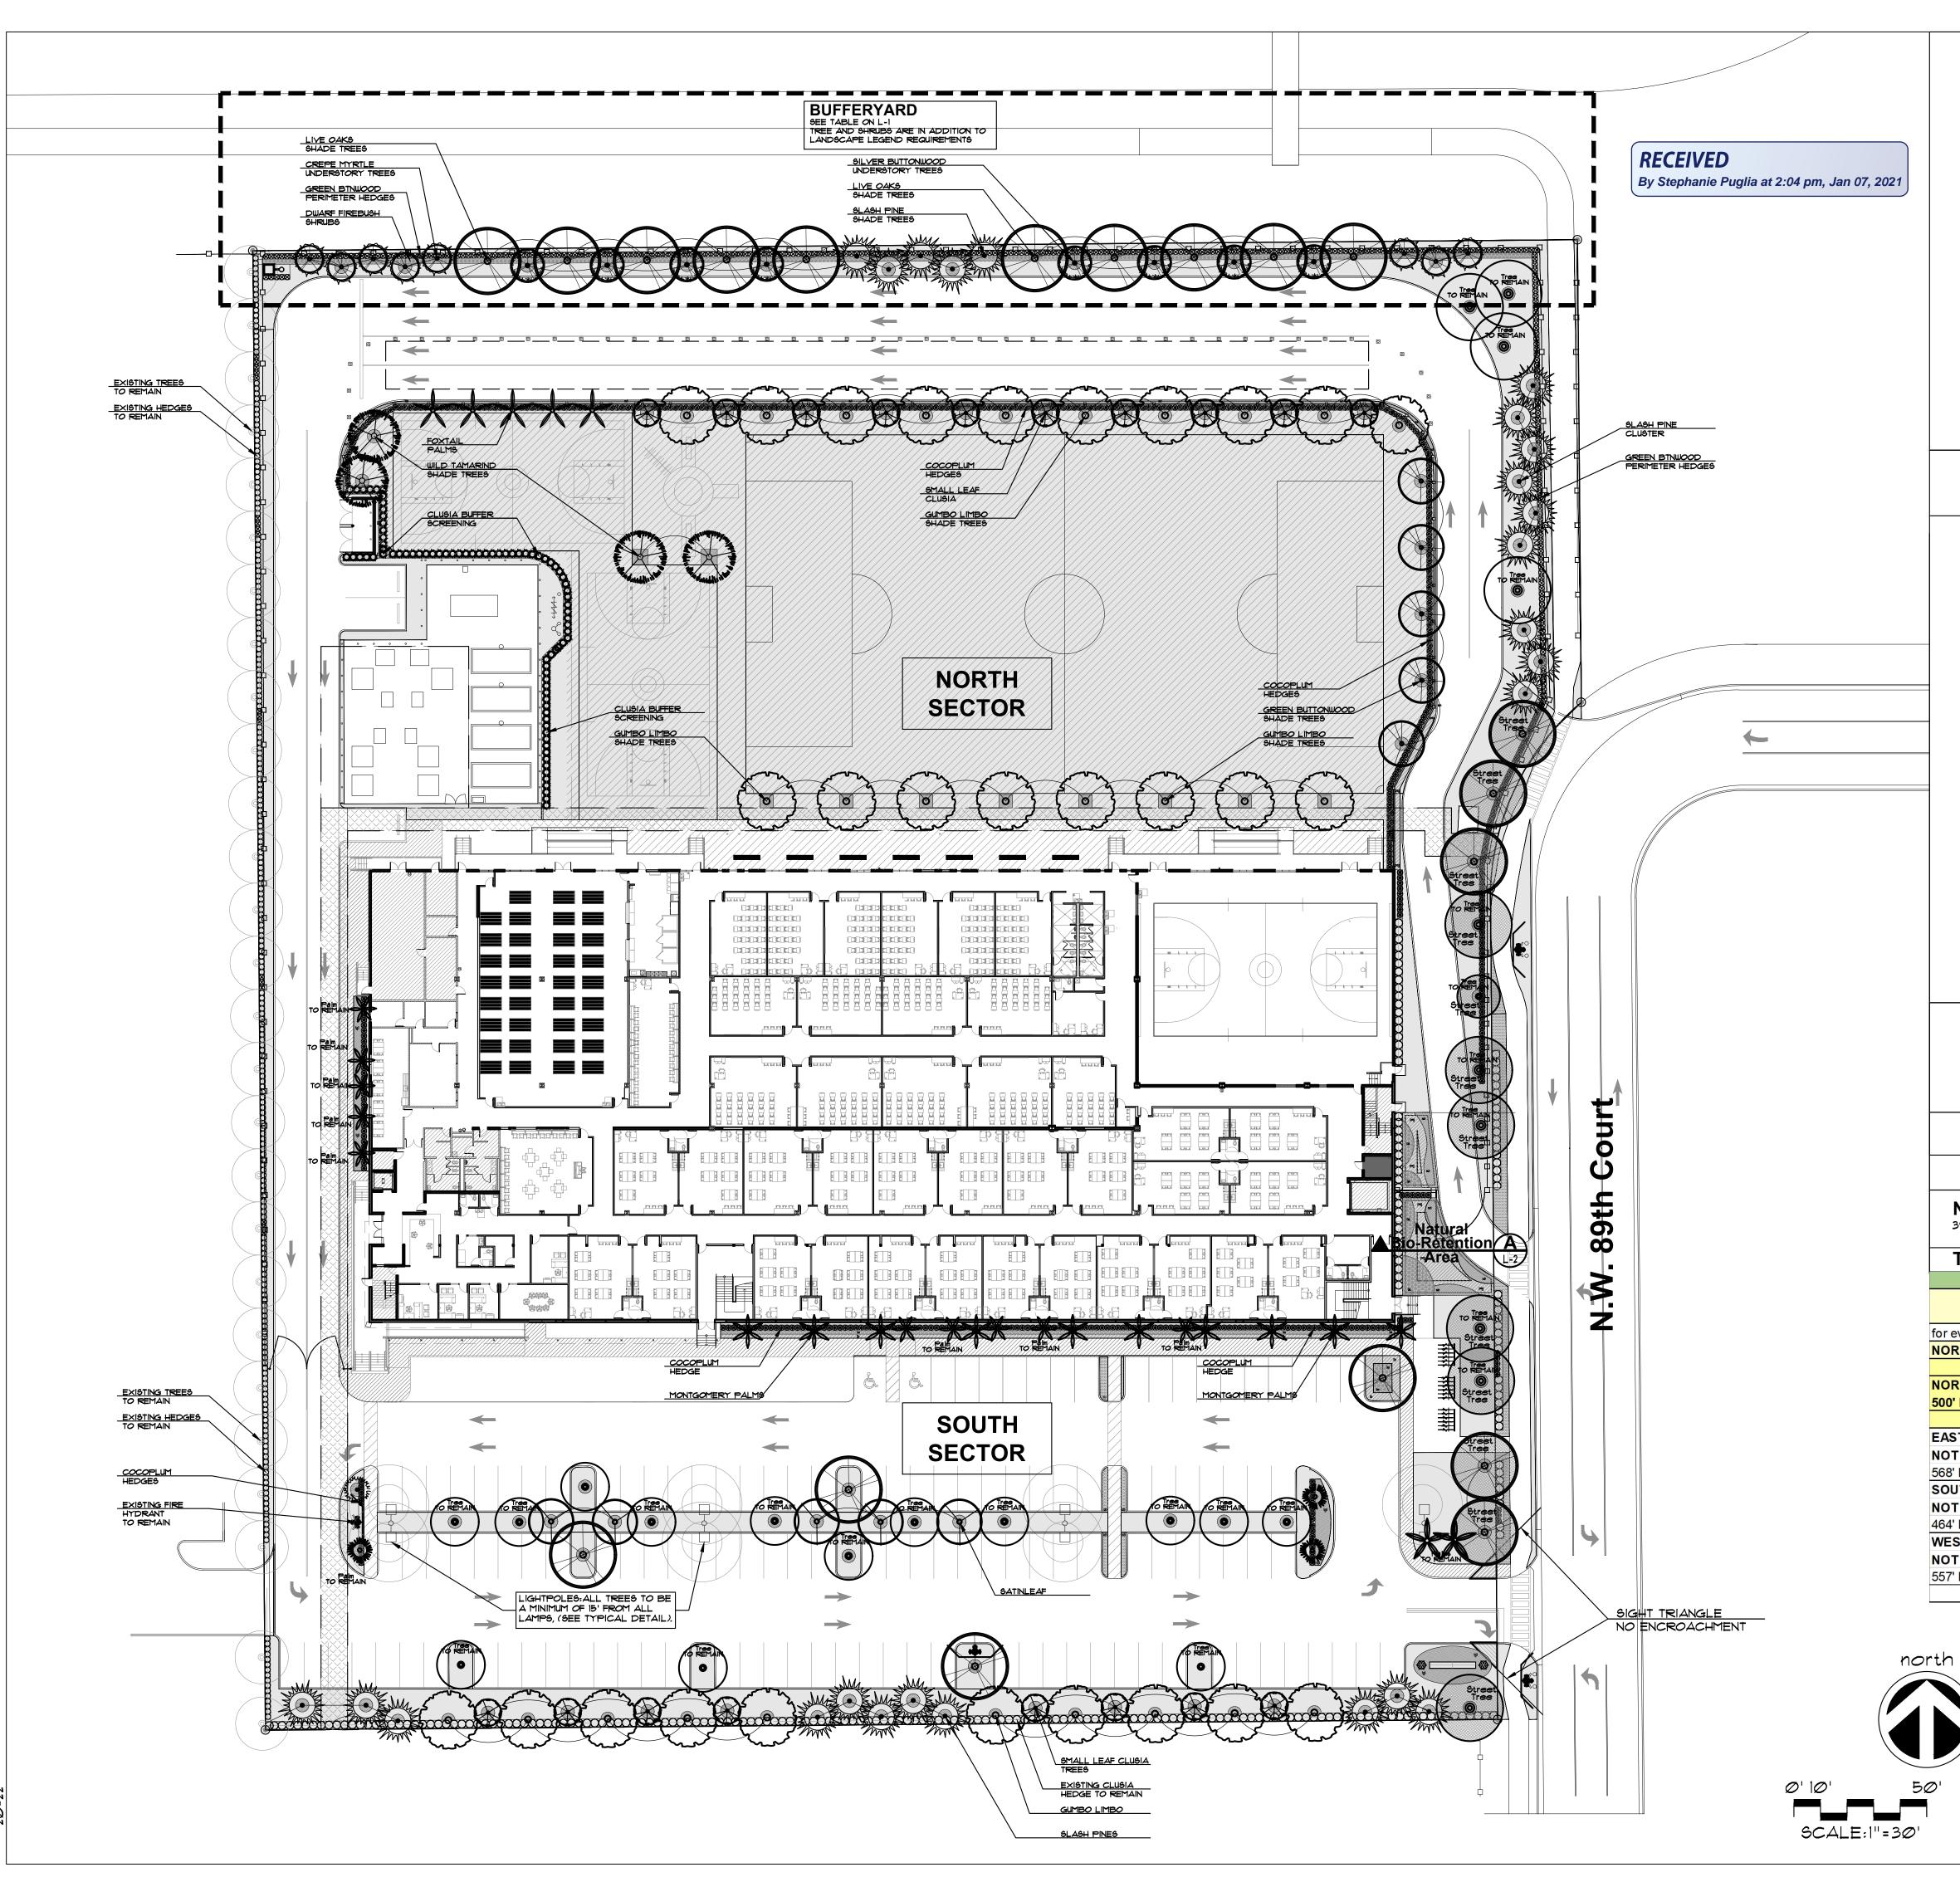
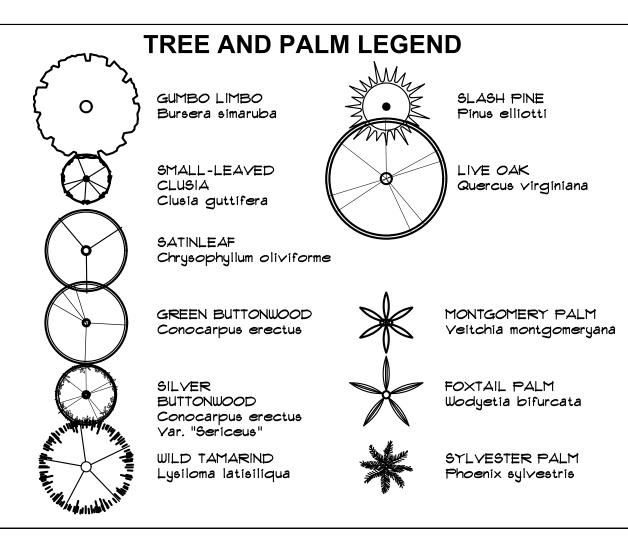
## LANDSCAPE LEGEND CITY OF DORAL- CHAPTER 71

	9 ACRES	265,478 S.F.
ZONING DISTRICT: IC  OPEN SPACE	REQUIRED	PROVIDED
A. Square feet of open space required by Chapter 11, as indicated on site plan:  Net lot area = $20\% \times 215,418 =$	_ 53 <i>,</i> Ø96_	_88,988
B. Square feet of parking lot open space required by Chapter 11, on site plan:  131 SURFACE SPACES × 10 S.F./ SPACE	1,310	1,3100
C. Total s.f. of open space required by Chapter 71: A + B =	54,406	<u> </u>
LAWN AREA CALCULATION  54,406  required by Chapter 71	54,406	90298
B. Maximum lawn area (sod) permitted= required by Chapter 11, on site plan: _2 × 54,406 s.f.=	10,881	VERY drought tolera grasses shown on pla 10,765
TREES: 15 per Acre  A. No. trees required per net lot acre space	92	1Ø2
Less existing no. of trees meeting min. required  B. % Palms Allowed:  No. of trees provided 30 x 30% =		not included into Landscape Requiremen
C. % Natives Required:  50% MINIMUM REQUIRED	46	not including st. trees  84
D. Street Trees (maximum average spacing	EE "STREET TE ABLE- BELOW 12	REE TABULATIONS' 12
E. Street Trees located directly beneath power lines, Max. ave. spacing of 25' oc	<u>N/A</u>	<u>N/A</u>
TOTAL NUMBER OF TREES REQUIRED	104	114
SHRUBS: A. No. trees required x 10= No. of shrubs allowed	1,040	1,Ø75
B. No. shrubs allowed x 50% = No. of Native shrubs required	<u> </u>	1,Ø75

STREET TREE TA	BULATION	<b>NS</b>
	REQUIRED	PROVIDED
N.W. 89th Court 392 LF./   TREE/35 LF.	12	12 7 EXIST.+ 5 PROPOSED
TOTALS	12	12
BUFFERYARD REQUI	REMENTS	

TOTALS			12		12	
BU	FFERYA	RD REQUI	RE	MENTS		
		L	and	scape Required		
TYPE 2	WIDTH	SHADE TRE	ES	<b>UNDERSTORY T</b>	REES	SHRUBS
or every 100 l.f.	10'	3		3		30
NORTH: 500' I.f.		15		15		150
		L	and	scape Provided		
NORTH	WIDTH	SHADE TRE	ES	<b>UNDERSTORY T</b>	REES	SHRUBS
500' I.f.	10'	15 *		16 *		480 *
*IN ADI	OT NOITIC	LANDSCAPE	RE	QUIREMENTS		
EAST	WIDTH	SHADE TRE	ES	<b>UNDERSTORY T</b>	REES	SHRUBS
NOT DISSIMILIAR LAND USE						
568' I.f.						
SOUTH	WIDTH	SHADE TRE	ES	<b>UNDERSTORY T</b>	REES	SHRUBS
NOT DISSIMILIAR LAND USE						
164' I.f.						
WEST	WIDTH	SHADE TRE	ES	<b>UNDERSTORY T</b>	REES	SHRUBS
NOT DISSIMILIAR LAND USE						
557' l.f.						
		<del></del>				

SEE SHEET L-1.1 FOR NORTH SECTOR PLAN, AND SHEET L-1.2 FOR SOUTH SECTOR PLAN.

SEE SHEET L-2 FOR PLANTLIST AND LANDSCAPE SPECIFICATIONS.

SEE SHEET L-3 FOR LANDSCAPE DETAILS, NOTES

SITE LANDSCAPE PLAN









JAMES F. SOCASH RLA \* 0001132

Alberto Llorente AR-0012031


**BRIDGEPREP ACADEMY** AT DORAL 3500 NW 89th COURT

DORAL, FLORIDA 33172 DATE ISSUE DESCRIPTION 1\10.23.20 SITE PLAN COMM.

DRAWING INFORMATION:

DELIVERY DATE: 12.01.2020

DRAWN BY: CHECKED BY: REF NUMBER:

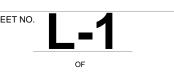



SPECIFICATION

# 13421 SOUTHWEST 23 STREET MIAMI, FL. 33175 . (305) 525-2370

### IN ASSOCIATION WITH:





AA-26002273










## PROFESSIONAL SEAL:

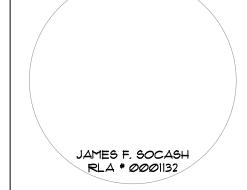

Alberto Llorente AR-0012031

**BRIDGEPREP ACADEMY** AT DORAL

DORAL, FLORIDA 33172 DATE ISSUE DESCRIPTION

3500 NW 89th COURT

1\10.23.20 SITE PLAN COMM


DRAWING INFORMATION: SHEET TITLE:

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REF NUMBER:

## ■■ LANDSCAPE NOTES

- 1. ALL PLANT MATERIAL SHALL BE FLORIDA NO. 1 GRADE OR BETTER.
- 2. CONTRACTOR SHALL FAMILIARIZE HIMSELF WITH THE LOCATION OF AND AYOID AND PROTECT UTILITY LINES, BURIED CABLES, AND OTHER UTILITIES.
- 3. TREE, PALM, ACCENT AND BED LINES ARE TO BE LOCATED IN THE FIELD AND APPROVED BY THE LANDSCAPE ARCHITECT PRIOR TO INSTALLATION.
- 4. ALL PLANTING SOIL SHALL BE 50:50 TOPSOIL:SAND MIX, FREE OF CLAY. STONES, ROCKS, OR OTHER FOREIGN MATTER. THIS SPECIFICATION INCLUDES ALL BACKFILL FOR BERMS AND OTHER LANDSCAPE AREAS.
  - SODDED-LAWN AREAS
  - 2" DEPTH PLANTING SOIL SPREAD IN PLACE- THROUGHOUT. GROUNDCOYER PLANTING BEDS:
- 6" DEPTH PLANTING SOIL SPREAD IN PLACE- THROUGHOUT. SHRUB AND HEDGE PLANTING AREAS:
- 12" DEPTH PLANTING SOIL SPREAD IN PLACE- THROUGHOUT. TREES, PALMS, SPECIMEN PLANT MATERIAL:
- 24" DEPTH PLANTING SOIL SPREAD IN PLACE OR, TO THE DEPTH OF THE ROOTBALL OR CONTAINER WHICHEVER IS GREATEST.
- LANDSCAPE ISLANDS AND BUILDING FOUNDATIONS: EXCAVATE AND REMOVE ALL LIMEROCK, ROCKS, DEBRIS. ETC. TO A DEPTH OF 18" AND BACKFILL W/ 50:50 TOPSOIL:SAND MIX. BUILDING FOUNDATIONS SHALL BE THE SAME DEPTH TO A WIDTH OF 36" FROM THE BUILDING BASE.
- 5. THE SITE CONTRACTOR SHALL BE RESPONSIBLE TO BRING ALL GRADES TO WITHIN 2" OF FINAL GRADES. THIS SHALL INCLUDE A 2" APPLICATION OF 50:50 TOPSOIL:SAND MIX FOR ALL LANDSCAPE AND AREAS TO BE SODDED.
- 6. THE LANDSCAPE CONTRACTOR SHALL CALCULATE AND SUBMIT AN ITEMIZED PRICE FOR THE 2" APPLICATION OF 50:50 MIX FOR ALL SOD AREAS AS A REFERENCE IN THE CASE THAT THERE WOULD BE A DISCREPANCY BETWEEN SITE AND LANDSCAPE CONTRACTORS AND NOTIFY THE SITE CONTRACTOR OR PROJECT SUPERINTENDENT AS TO THIS DISCREPANCY. IT WILL THEN BE DETERMINED WHICH PARTY WILL PROVIDE THIS 2" TOPSOIL:SAND APPLICATION
- AND SUBSEQUENT PAYMENT. OTHER PLANTING SOIL MIXES TO BE ADDED, I.E. FOR TREES, PALMS, SPECIMEN PLANTS, SHRUBS AND GROUND COVERS SHALL BE THE RESPONSIBILITY OF THE LANDSCAPE CONTRACTOR AND BE INCLUSIVE WITH THE LANDSCAPE BID.
- T. CONTRACTOR SHALL COORDINATE WITH THE IRRIGATION CONTRACTOR AND LEAVE PROVISIONS FOR ALL, INCLUDING UNDERGROUND UTILITY LINE LOCATIONS DIAL SII "NO CUTS" AS REQUIRED BY LAW.
- 8. ALL PLANTING BEDS SHALL BE MULCHED TO A DEPTH OF 3" WITH AN APPROVED RECYCLED MULCH BY THE PRESIDING GOVERNING AGENCY. NO HEAVY METALS, I.E. ARSENIC, LEAD, ETC. ARE TO BE CONTAINED IN THE MULCH AND THE CONTRACTOR SHALL PROVIDE CERTIFICATION OR PROOF THAT ALL MULCH IS FREE OF HEAVY METALS OR SIMILAR ENVIRONMENTAL CONTAMINANTS.
- 9. SOD SHALL BE ARGENTINE "BAHIA" OR ST. AUGUSTINE "FLORATAM" AS SHOWN ON THE PLANS, STRONGLY ROOTED, FREE FROM WEED, FUNGUS, INSECTS AND DISEASE. CONTRACTOR SHALL SOD ALL AREAS AS INDICATED ON THE PLAN OR AS DIRECTED. PAYMENT SHALL BE DETERMINED BY THE TOTAL MEASURED SODDED AREAS X THE UNIT PRICE SUBMITTED AND FIELD VERIFIED.
- 10. SOD SHALL BE INSTALLED IN ACCORDANCE WITH THE SPECIFICATIONS AS DEFINED BY FDOT. SOD SHALL CARRY A 5-MONTH WARRANTY.
- II. ALL TREES, PALMS, SHRUBS AND GROUNDCOVERS SHALL CARRY A ONE-YEAR WARRANTY FROM THE DATE OF FINAL ACCEPTANCE.
- 12. ALL TREES AND PALMS SHALL BE STAKED PER ACCEPTED STANDARDS BY THE FLORIDA NURSERYMEN & GROWERS LANDSCAPE ASSOCIATION (FNGLA). THERE SHALL BE ONE FINAL INSPECTION FOR APPROVAL BY THE PRESIDING GOVERNING AGENCY. CONTRACTOR SHALL INSURE THAT THE PLANS, DETAILS, SPECIFICATIONS AND NOTES HAVE BEEN ADHERED TO AND THAT THE LANDSCAPE AND IRRIGATION INSTALLATION IS COMPLIANT TO ALL ITEMS AS DIRECTED ON THE PLANS PRIOR TO SCHEDULING OF THE FINAL INSPECTION.
- 13. THE PLANT LIST IS INTENDED ONLY AS AN AID TO BIDDING. ANY DISCREPANCIES FOUND BETWEEN THE QUANTITIES ON THE PLAN AND PLANT LIST, THE QUANTITIES ON THE PLAN SHALL BE HELD VALID.
- 14. IRRIGATION SHALL PROVIDE FOR A 100% COVERAGE WITH A 100% OVERLAP, AUTOMATIC SYSTEM W/ RAIN MOISTURE SENSOR ATTACHED TO CONTROLLER. ALL FLORIDA BUILDING CODE APPENDIX "F" IRRIGATION REQUIREMENTS SHALL BE STRICTLY ADHERED TO FOR INSTALLATION AND PREVAILING WATER MANAGEMENT DISTRICT RESTRICTIONS AND REGULATIONS SHALL BE IN COMPLIANCE FOR POST-INSTALLATION WATERING SCHEDULES.
- 15. EXISTING IRRIGATION SYSTEM (IF APPLICABLE) SHALL BE RETROFITTED TO COMPLY WITH THOSE SPECIFICATIONS AS OUTLINED ABOVE.
- 16. CONTRACTOR SHALL PROVIDE A WATER TRUCK DURING PLANTING TO INSURE PROPER WATERING-IN DURING INSTALLATION AND WILL BE RESPONSIBLE FOR CONTINUAL WATERING UNTIL FINAL ACCEPTANCE BY THE OWNER.
- 17. ALL EXISTING TREES, PALMS AND PLANT MATERIAL TO REMAIN SHALL BE PROTECTED DURING CONSTRUCTION. CONTRACTOR SHALL INSTALL PROTECTIVE BARRIERS SUCH AS "TENAX" PROTECTIVE FENCING OR AS SHOWN ON THE DETAILS TO BE INSTALLED AT THE BEGINNING OF THE PROJECT. BARRIERS SHALL BE LOCATED TO INCLUDE THE DRIPLINE OF THE TREES, PALMS AND PLANT MATERIAL WHERE POSSIBLE. THE CONTRACTOR SHALL TAKE EXTRA CAUTION TO PREVENT ANY DAMAGE TO THE TRUNK, BRANCHES, ROOTS, ROOT ZONE AREAS AND ADJACENT GRADES.
- 18. EXISTING TREES AND PALMS TO REMAIN SHALL BE TRIMMED PER ANSI-300 STANDARDS. SUPERVISION OF THE TRIMMING SHALL BE PERFORMED BY AN ISA-CERTIFIED ARBORIST.
- 19. ALL EXISTING TREES AND PALMS SHALL BE "LIFTED AND THINNED" TO PROVIDE FOR AN 8' MINIMUM CLEARANCE FOR SIDEWALKS AND PEDESTRIAN WALKWAYS AND A 14' MINIMUM CLEARANCE FOR ROADWAYS, DRIVEWAYS, AND ALL VEHICULAR USE AREAS.
- 20. REMOVAL OF ANY TREES OR PALMS WILL REQUIRE A WRITTEN "TREE REMOVAL PERMIT" FROM THE LOCAL GOVERNING AGENCY PRIOR TO REMOVAL.
- 21. ALL PLANTINGS IN NON-IRRIGATED AREAS, I.E. RIGHTS OF WAYS, SWALES, ETC. SHALL BE WATERED-IN THOROUGHLY AND CONTINUED TO BE WATERED THROUGHOUT UNTIL C.O. ACCEPTANCE. COORDINATE WITH OWNER AND PROJECT MANAGER TO PROVIDE POST C.O. WATERING TO INSURE PLANT ESTABLISHMENT FOR A MINIMUM OF ONE YEAR AFTER CERTIFICATE OF OCCUPANCY ACCEPTANCE.
- 22. THE LANDSCAPE CONTRACTOR SHALL SCHEDULE A PRE-CONSTRUCTION CONFERENCE WITH THE LOCAL GOVERNING AGENCY, GENERAL CONTRACTOR, LANDSCAPE ARCHITECT, AND IRRIGATION CONTRACTOR PRIOR TO COMMENCEMENT OF WORK.

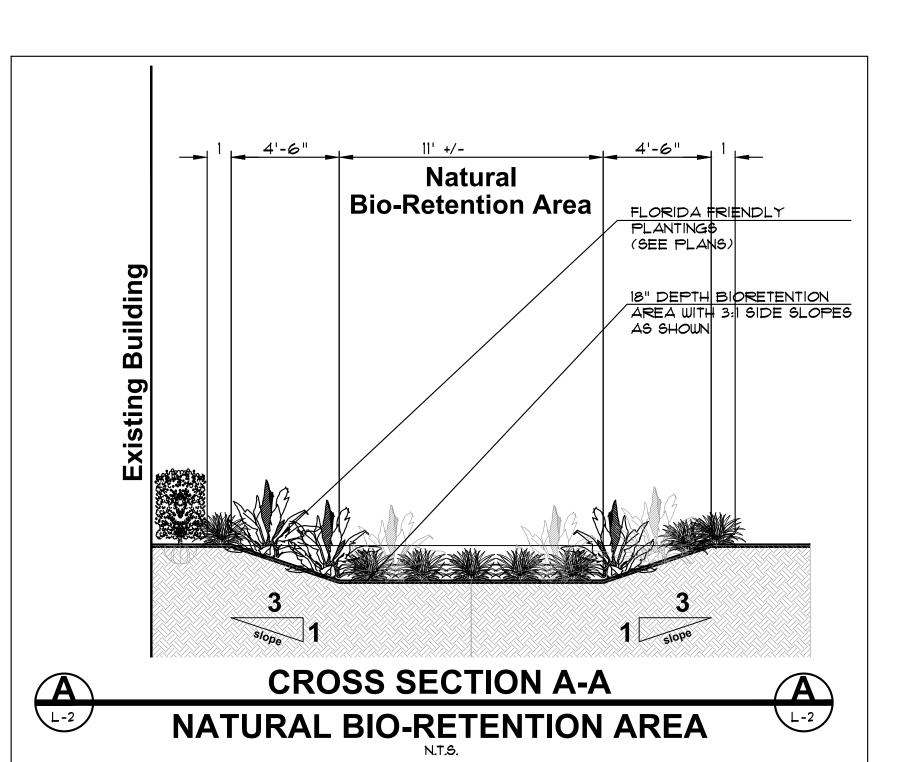

LL	YES	7	EXISTING WILD TAMARIND	Lysiloma latisiliquum	ALL EXISTING - SEE TREE INVENTORY
QV6	YES	5	LIVE OAKS	Quercus virginiana	l6' x 7' эрг., 4" саl., 6' с.t.
		12	STREET TREES		
**	PROPC	SED LC ദ	OT TREES  EXISTING TREES TO REMAIN		
BS	YES	28	GUMBO LIMBO	Bursera simaruba	14' x 6' spr., 4" cal.
-	YES	18	SMALL LEAF CLUSIA	Clusia guttifera	10' O.A., × 6', 2 1/2" cal.
co	YES	5	SATINLEAF	Chrysophyllum oliviforme	14' x 6' spr., 4" cal.
CE	YES	5	GREEN BUTTONWOOD	Conocarpus erectus	14' x 6' spr., 4" cal.
LL	YES	4	WILD TAMARIND	Lysiloma latisiliquum	14' x 6' spr., 4" cal.
PEL	YES	20	SLASH PINE	Pinus elliottii	14' x 6' spr., 4" cal.
QY	YES	4	LIVE OAKS	Quercus virginiana	14' x 6' spr., 4" cal.
		102	LOT TREES	*	
	PALMS	100	MONITO OMEDY DAI MC	Vettalita mantaramana	DDI TK TC 141 a.a. A.II b.d.
VM2		1Ø 5	MONTGOMERY PALMS	Veitchia montgomeryana	DBL. TK, FG., 14' o.a., full hd.
WB			FOXTAIL PALMS	Wodyetia bifurcata	14' o.a., 5" @ dbh, full hd
**5	SHRUB	S			
CRI	YES	200	EXISTING PITCH APPLE	Clusia rosea	SOUTH PERIMETER
Cl3	YES	150	EXISTING COCOPLUM	Chysobalanus icaco	EAST PERIMETER
CRT	YES	125	PITCH APPLE	Clusia rosea	7 GAL., 36" ht., 30" Ø.C., FTB.
CI3	YES	500	COCOPLUM	Chysobalanus icaco	3 gal., 24" x 24", 24"o.c., full
CEH	YES	50	GREEN BUTTONWOOD	Conocarpus erectus	3 gal., 24" x 24", 24" o.c., full
	YES	50	DWARF FIREBUSH	Hamelia nodosa	3 gal., 18" x 18", 24" o.c.
				N CONSTRUCTION LANDSCAPE D	
**	BUFFE SHADE	PECIFIC	PLANTINGS (ADDITIONA	AL TO LANDSCAPE REQUI	REMENTS)
**   ** (	BUFFE SHADE YES	RYARD  TREES	PLANTINGS (ADDITIONA SLASH PINE	AL TO LANDSCAPE REQUII	REMENTS)  14' x 6' spr., 4" cal.
** ( ** ( PEL QV	BUFFE SHADE YES	RYARD  TREES	PLANTINGS (ADDITIONAL) SLASH PINE LIVE OAKS	AL TO LANDSCAPE REQUI	REMENTS)
**   ** ; PEL QV **	BUFFE SHADE YES YES UNDER	RYARD TREES 5 10 RSTORY	PLANTINGS (ADDITIONAL SLASH PINE LIVE OAKS TREES	AL TO LANDSCAPE REQUII Pinus elliottii Quercus virginiana	REMENTS)  14' x 6' spr., 4" cal.  14' x 6' spr., 4" cal.
**   ** ; PEL QY **	BUFFE SHADE YES	RYARD TREES  5  10  RSTORY	PLANTINGS (ADDITIONAL SLASH PINE LIVE OAKS TREES SILVER BUTTONWOOD	AL TO LANDSCAPE REQUII  Pinus elliottii  Quercus virginiana  Conocarpus erec. "Sericeus"	REMENTS)  14' × 6' spr., 4" cal.  14' × 6' spr., 4" cal.  10' × 6' spr., 6" DBH (3 TKS. # 2" ea), AT TIME OF INSTALLATION
**   ** ; PEL QV **   CET	BUFFE SHADE YES YES UNDER	RYARD TREES  5  10  RSTORY 8	PLANTINGS (ADDITIONAL SLASH PINE LIVE OAKS TREES SILVER BUTTONWOOD CRAPE MYRTLE "WHITE"	AL TO LANDSCAPE REQUII  Pinus elliottii  Quercus virginiana  Conocarpus erec. "Sericeus"	REMENTS)  14' x 6' spr., 4" cal.  14' x 6' spr., 4" cal.
**   ** ( PEL QV **   CET LIW **	BUFFE SHADE YES YES UNDER YES	RYARD  TREES  S  RSTORY  S  RYARD	PLANTINGS (ADDITIONAL SLASH PINE LIVE OAKS TREES SILVER BUTTONWOOD CRAPE MYRTLE "WHITE" SHRUBS	AL TO LANDSCAPE REQUII  Pinus elliottii  Quercus virginiana  Conocarpus erec. "Sericeus"  Lagerstroemia indica "Natchez" 12" x 5" sp	REMENTS)  14' x 6' spr., 4" cal.  14' x 6' spr., 4" cal.  16' x 6' spr., 6" DBH (3 TKS. # 2" ea), AT TIME OF INSTALLATION  17. STANDARD, SINGLE LEADER, 2" DBH, 4' C.T. AT TIME OF INSTALLATION
**   **   PEL QY  **   CET LIW  **	BUFFE SHADE YES YES UNDER	RYARD TREES  5  10  RSTORY 8	PLANTINGS (ADDITIONAL SLASH PINE LIVE OAKS TREES SILVER BUTTONWOOD CRAPE MYRTLE "WHITE"	AL TO LANDSCAPE REQUII  Pinus elliottii  Quercus virginiana  Conocarpus erec. "Sericeus"	REMENTS)  14' × 6' spr., 4" cal.  14' × 6' spr., 4" cal.  10' × 6' spr., 6" DBH (3 TKS. # 2" ea), AT TIME OF INSTALLATION
**   **   PEL QV  **   CET LIW  **	BUFFE YES UNDER YES BUFFE YES	RYARD  TREES  S  RSTORY  8  RYARD  240	PLANTINGS (ADDITIONAL SLASH PINE LIVE OAKS TREES SILVER BUTTONWOOD CRAPE MYRTLE "WHITE" SHRUBS GREEN BUTTONWOOD	Pinus elliottii  Quercus virginiana  Conocarpus erec. "Sericeus"  Lagerstroemia indica "Natchez" [2" x 5" sp	REMENTS)  14' x 6' spr., 4" cal.  14' x 6' spr., 4" cal.  16' x 6' spr., 6" DBH (3 TKS. • 2" ea), AT TIME OF INSTALLATION  17. STANDARD, SINGLE LEADER, 2" DBH, 4' C.T. AT TIME OF INSTALLATION  3 gal., 24" x 24", 24" o.c., full
**   **   PEL QV  **   CET LIW  **   CEH HPD	BUFFE YES UNDER YES BUFFE YES YES	RYARD  TREES  S  RSTORY  8  RYARD  240	PLANTINGS (ADDITIONAL SLASH PINE LIVE OAKS TREES SILVER BUTTONWOOD CRAPE MYRTLE "WHITE" SHRUBS GREEN BUTTONWOOD DWARF FIREBUSH	Pinus elliottii  Quercus virginiana  Conocarpus erec. "Sericeus"  Lagerstroemia indica "Natchez" 12' x 5' sp  Conocarpus erectus  Hamelia nodosa	REMENTS)  14' x 6' spr., 4" cal.  14' x 6' spr., 4" cal.  10' x 6' spr., 6" DBH (3 TKS. • 2" ea), AT TIME OF INSTALLATION  17. STANDARD, SINGLE LEADER, 2" DBH, 4' C.T. AT TIME OF INSTALLATION  3 gal., 24" x 24", 24" o.c., full  3 gal., 18" x 18", 24" o.c.
**   PEL QV **   CET LIW CEH HPD	BUFFE YES UNDER YES BUFFE YES YES	RYARD  TREES  S  RSTORY  8  RYARD  240	PLANTINGS (ADDITIONAL SLASH PINE LIVE OAKS TREES SILVER BUTTONWOOD CRAPE MYRTLE "WHITE" SHRUBS GREEN BUTTONWOOD DWARF FIREBUSH	Pinus elliottii  Quercus virginiana  Conocarpus erec. "Sericeus"  Lagerstroemia indica "Natchez" 12" x 5" sp  Conocarpus erectus  Hamelia nodosa  Stenotaphrum secundatum	REMENTS)  14' x 6' spr., 4" cal.  14' x 6' spr., 4" cal.  16' x 6' spr., 6" DBH (3 TKS. # 2" ea), AT TIME OF INSTALLATION  17. STANDARD, SINGLE LEADER, 2" DBH, 4' C.T. AT TIME OF INSTALLATION  3 gal., 24" x 24", 24" o.c., full  3 gal., 18" x 18", 24" o.c.  SOLID SOD, price per s.f.
**   **   PEL QV  **   CET LIW  **   CEH HPD	BUFFE YES UNDER YES BUFFE YES YES	RYARD  TREES  S  RSTORY  8  RYARD  240	PLANTINGS (ADDITIONAL SLASH PINE LIVE OAKS TREES SILVER BUTTONWOOD CRAPE MYRTLE "WHITE" SHRUBS GREEN BUTTONWOOD DWARF FIREBUSH	Pinus elliottii  Quercus virginiana  Conocarpus erec. "Sericeus"  Lagerstroemia indica "Natchez" 12' x 5' sp  Conocarpus erectus  Hamelia nodosa	REMENTS)  14' x 6' spr., 4" cal.  14' x 6' spr., 4" cal.  10' x 6' spr., 6" DBH (3 TKS. • 2" ea), AT TIME OF INSTALLATION  17. STANDARD, SINGLE LEADER, 2" DBH, 4' C.T. AT TIME OF INSTALLATION  3 gal., 24" x 24", 24" o.c., full  3 gal., 18" x 18", 24" o.c.
**   **   PEL QY  **   CET LIW  **   CEH HPD	BUFFE YES UNDER YES BUFFE YES YES	RYARD  TREES  S  RSTORY  8  RYARD  240	PLANTINGS (ADDITIONAL SLASH PINE LIVE OAKS TREES SILVER BUTTONWOOD CRAPE MYRTLE "WHITE" SHRUBS GREEN BUTTONWOOD DWARF FIREBUSH	Pinus elliottii  Quercus virginiana  Conocarpus erec. "Sericeus"  Lagerstroemia indica "Natchez" 12" x 5" sp  Conocarpus erectus  Hamelia nodosa  Stenotaphrum secundatum	REMENTS)  14' x 6' spr., 4" cal.  14' x 6' spr., 4" cal.  10' x 6' spr., 6" DBH (3 TKS. • 2" ea), AT TIME OF INSTALLATION  17. STANDARD, SINGLE LEADER, 2" DBH, 4' C.T. AT TIME OF INSTALLATION  3 gal., 24" x 24", 24" o.c., full  3 gal., 18" x 18", 24" o.c.  SOLID SOD, price per s.f.  SOLID SOD, price per s.f.
**   **   PEL QY  **   CET LIW  **   CEH HPD	BUFFE YES YES UNDER YES YES YES OD	RYARD  TREES  S  RSTORY  8  RYARD  240	PLANTINGS (ADDITIONAL SLASH PINE LIVE OAKS TREES SILVER BUTTONWOOD CRAPE MYRTLE "WHITE" SHRUBS GREEN BUTTONWOOD DWARF FIREBUSH  "FLORATAM" ST. AUGUSTINE "ARGENTINE" BAHIA SOD	Pinus elliottii  Quercus virginiana  Conocarpus erec. "Sericeus"  Lagerstroemia indica "Natchez" 12' x 5' sp  Conocarpus erectus  Hamelia nodosa  Stenotaphrum secundatum  Paspalum notatum  50:50 TOPSOIL:SAND MIX, 9	REMENTS)  14' x 6' spr., 4" cal.  14' x 6' spr., 4" cal.  10' x 6' spr., 6" DBH (3 TKS. • 2" ea), AT TIME OF INSTALLATION  17. STANDARD, SINGLE LEADER, 2" DBH, 4' C.T. AT TIME OF INSTALLATION  3 gal., 24" x 24", 24" o.c., full  3 gal., 18" x 18", 24" o.c.  SOLID SOD, price per s.f.  SOLID SOD, price per s.f.
**   **   PEL QY  **   CET LIW  **   CEH HPD	BUFFE YES UNDER YES BUFFE YES YES OD	RYARD TREES S RYARD 8 RYARD 240 240	PLANTINGS (ADDITIONAL SLASH PINE LIVE OAKS TREES SILVER BUTTONWOOD CRAPE MYRTLE "WHITE" SHRUBS GREEN BUTTONWOOD DWARF FIREBUSH  "FLORATAM" ST. AUGUSTINE "ARGENTINE" BAHIA SOD  TOPSOIL:SAND MIX TREES, PALMS, SHRUBS AND	Pinus elliottii  Quercus virginiana  Conocarpus erec. "Sericeus"  Lagerstroemia indica "Natchez" 12' x 5' sp  Conocarpus erectus  Hamelia nodosa  Stenotaphrum secundatum  Paspalum notatum  50:50 TOPSOIL:SAND MIX, 9	REMENTS)  14' x 6' spr., 4" cal.  14' x 6' spr., 4" cal.  16' x 6' spr., 6" DBH (3 TKS. # 2" ea), AT TIME OF INSTALLATION  17. STANDARD, SINGLE LEADER 2" DBH, 4' C.T. AT TIME OF INSTALLATION  3 gal., 24" x 24", 24" o.c., full  3 gal., 18" x 18", 24" o.c.  SOLID SOD, price per s.f.  SOLID SOD, price per s.f.
**   **   PEL QV **   CET LIW **   CEH HPD  SOD BAH TOP:	BUFFE YES UNDER YES BUFFE YES YES OD	RYARD TREES TORY S RYARD 240 240 240 30 c.y. 50 c.y.	PLANTINGS (ADDITIONAL SLASH PINE LIVE OAKS TREES SILVER BUTTONWOOD CRAPE MYRTLE "WHITE" SHRUBS GREEN BUTTONWOOD DWARF FIREBUSH  "FLORATAM" ST. AUGUSTINE "ARGENTINE" BAHIA SOD  TOPSOIL:SAND MIX TREES, PALMS, SHRUBS AND	Pinus elliottii  Quercus virginiana  Conocarpus erec. "Sericeus"  Lagerstroemia indica "Natchez" [2" x 5" sp  Conocarpus erectus  Hamelia nodosa  Stenotaphrum secundatum  Paspalum notatum  50:50 TOPSOIL:SAND MIX, Sp  GROUNDCOVERS	REMENTS)  14' x 6' spr., 4" cal.  14' x 6' spr., 4" cal.  16' x 6' spr., 6" DBH (3 TKS. # 2" ea), AT TIME OF INSTALLATION  17. STANDARD, SINGLE LEADER 2" DBH, 4' C.T. AT TIME OF INSTALLATION  3 gal., 24" x 24", 24" o.c., full  3 gal., 18" x 18", 24" o.c.  SOLID SOD, price per s.f.  SOLID SOD, price per s.f.
**   **   PEL QV **   CET LIW **   CEH HPD  SOD BAH TOP:	BUFFE YES UNDER YES BUFFE YES YES SOIL:	RYARD TREES TORY S RYARD 240 240 240 30 c.y. 50 c.y.	PLANTINGS (ADDITIONAL SLASH PINE LIVE OAKS TREES SILVER BUTTONWOOD CRAPE MYRTLE "WHITE" SHRUBS GREEN BUTTONWOOD DWARF FIREBUSH  "FLORATAM" ST. AUGUSTINE "ARGENTINE" BAHIA SOD  TOPSOIL:SAND MIX TREES, PALMS, SHRUBS AND	Pinus elliottii  Quercus virginiana  Conocarpus erec. "Sericeus"  Lagerstroemia indica "Natchez" [2" x 5" sp  Conocarpus erectus  Hamelia nodosa  Stenotaphrum secundatum  Paspalum notatum  50:50 TOPSOIL:SAND MIX, Sp  GROUNDCOVERS	REMENTS)  14' x 6' spr., 4" cal.  14' x 6' spr., 4" cal.  10' x 6' spr., 6" DBH (3 TK5. • 2" ea), AT TIME OF INSTALLATION  17. STANDARD, SINGLE LEADER 2" DBH, 4' CT. AT TIME OF INSTALLATION  3 gal., 24" x 24", 24" o.c., full  3 gal., 18" x 18", 24" o.c.  SOLID SOD, price per s.f.  SOLID SOD, price per s.f.  PREAD IN PLACE  IN PLACE
**   **   PEL QV **   CET LIW **   CEH HPD  SOD BAH TOP:	BUFFE YES UNDER YES BUFFE YES YES SOIL:	RYARD TREES 5 10 RSTORY 8 8 RYARD 240 240 30 c.y. 50 c.y.	PLANTINGS (ADDITIONAL SLASH PINE LIVE OAKS TREES SILVER BUTTONWOOD CRAPE MYRTLE "WHITE" SHRUBS GREEN BUTTONWOOD DWARF FIREBUSH  "FLORATAM" ST. AUGUSTINE "ARGENTINE" BAHIA SOD  TOPSOIL:SAND MIX TREES, PALMS, SHRUBS AND AREA TO BE SODDED WITH  RECYCLED DRK BROWN	Pinus elliottii  Quercus virginiana  Conocarpus erec. "Sericeus"  Lagerstroemia indica "Natchez" [2" x 5" sp  Conocarpus erectus  Hamelia nodosa  Stenotaphrum secundatum  Paspalum notatum  50:50 TOPSOIL:SAND MIX, Sp  GROUNDCOVERS  A 2" DEPTH OF TOPSOIL SPREAD  3" DEPTH, SPREAD IN PLACE  PROVIDE SAMPLE FOR APP	REMENTS)  14' x 6' spr., 4" cal.  14' x 6' spr., 4" cal.  16' x 6' spr., 6" DBH (3 TKS. 0 2" ea), AT TIME OF INSTALLATION  17. STANDARD, SINGLE LEADER, 2" DBH, 4' CT. AT TIME OF INSTALLATION  3 gal., 24" x 24", 24" o.c., full  3 gal., 18" x 18", 24" o.c.  SOLID SOD, price per s.f.  SOLID SOD, price per s.f.  PREAD IN PLACE  IN PLACE  E, ATLAS PEAT AND SOIL  ROYAL PRIOR TO INSTALLATION
**   **   PEL QV **   CET LIW **   CEH HPD  SOD BAH TOP:	BUFFE YES UNDER YES BUFFE YES YES SOIL:	RYARD TREES 5 10 RSTORY 8 8 RYARD 240 240 30 c.y. 50 c.y.	PLANTINGS (ADDITIONAL SLASH PINE LIVE OAKS TREES SILVER BUTTONWOOD CRAPE MYRTLE "WHITE" SHRUBS GREEN BUTTONWOOD DWARF FIREBUSH  "FLORATAM" ST. AUGUSTINE "ARGENTINE" BAHIA SOD  TOPSOIL:SAND MIX TREES, PALMS, SHRUBS AND AREA TO BE SODDED WITH  RECYCLED DRK BROWN	Pinus elliottii Quercus virginiana  Conocarpus erec. "Sericeus"  Lagerstroemia indica "Natchez" 12" x 5" sp  Conocarpus erectus  Hamelia nodosa  Stenotaphrum secundatum  Paspalum notatum  50:50 TOPSOIL: SAND MIX, Sp  GROUNDCOVERS  A 2" DEPTH OF TOPSOIL SPREAD  3" DEPTH, SPREAD IN PLACE  PROVIDE SAMPLE FOR APP  JLCH QUANTITIES SHOWN ARE APP	REMENTS)  14' x 6' spr., 4" cal.  14' x 6' spr., 4" cal.  16' x 6' spr., 6" DBH (3 TKS. e 2" ea), AT TIME OF INSTALLATION  17. STANDARD, SINGLE LEADER, 2" DBH, 4' CT. AT TIME OF INSTALLATION  3 gal., 24" x 24", 24" o.c., full  3 gal., 18" x 18", 24" o.c.  SOLID SOD, price per s.f.  SOLID SOD, price per s.f.  PREAD IN PLACE  IN PLACE  E, ATLAS PEAT AND SOIL  ROYAL PRIOR TO INSTALLATION  ROXIMATE, CONTRACTOR
**   **   PEL QV **   CET LIW **   CEH HPD  SOD BAH TOP:	BUFFE YES UNDER YES BUFFE YES YES SOIL:	RYARD TREES  5  10  RSTORY  8  8  RYARD  240  240  30 c.y.  50 c.y.	PLANTINGS (ADDITIONAL SLASH PINE LIVE OAKS TREES SILVER BUTTONWOOD CRAPE MYRTLE "WHITE" SHRUBS GREEN BUTTONWOOD DWARF FIREBUSH  "FLORATAM" ST. AUGUSTINE "ARGENTINE" BAHIA SOD  TOPSOIL:SAND MIX TREES, PALMS, SHRUBS AND AREA TO BE SODDED WITH  RECYCLED DRK BROWN  TOPSOIL, SOD AND MIX TO PROVIDE A UNIT P	Pinus elliottii  Quercus virginiana  Conocarpus erec. "Sericeus"  Lagerstroemia indica "Natchez" 12" x 5" sp  Conocarpus erectus  Hamelia nodosa  Stenotaphrum secundatum  Paspalum notatum  50:50 TOPSOIL:SAND MIX, Sp  GROUNDCOVERS  A 2" DEPTH OF TOPSOIL SPREAD  3" DEPTH, SPREAD IN PLACE  PROVIDE SAMPLE FOR APPERICE PER UNIT AND WILL BE PAID	REMENTS)  14' x 6' spr., 4" cal.  14' x 6' spr., 4" cal.  16' x 6' spr., 6" DBH (3 TKS. e 2" ea), AT TIME OF INSTALLATION  17. STANDARD, SINGLE LEADER, 2" DBH, 4' CT. AT TIME OF INSTALLATION  3 gal., 24" x 24", 24" o.c., full  3 gal., 18" x 18", 24" o.c.  SOLID SOD, price per s.f.  SOLID SOD, price per s.f.  PREAD IN PLACE  IN PLACE  E, ATLAS PEAT AND SOIL  ROYAL PRIOR TO INSTALLATION  ROXIMATE, CONTRACTOR
**   **   PEL QV **   CET LIW **   CEH HPD  SO SOD BAH  TOP:	BUFFE YES UNDER YES YES OD SOIL:	RYARD TREES  5  10  RYARD 240 240  240  30 c.y. 50 c.y.	PLANTINGS (ADDITIONAL  SLASH PINE LIVE OAKS  TREES  SILVER BUTTONWOOD  CRAPE MYRTLE "WHITE"  SHRUBS  GREEN BUTTONWOOD  DWARF FIREBUSH  "FLORATAM" ST. AUGUSTINE  "ARGENTINE" BAHIA SOD  TOPSOIL:SAND MIX  TREES, PALMS, SHRUBS AND  AREA TO BE SODDED WITH  RECYCLED DRK BROWN  TOPSOIL, SOD AND MIX  TO PROVIDE A UNIT P  UPON FINAL INSPECTICE	Pinus elliottii  Quercus virginiana  Conocarpus erec. "Sericeus"  Lagerstroemia indica "Natchez" 12" x 5" sp  Conocarpus erectus  Hamelia nodosa  Stenotaphrum secundatum  Paspalum notatum  50:50 TOPSOIL:SAND MIX, Sp  GROUNDCOVERS  A 2" DEPTH OF TOPSOIL SPREAD  3" DEPTH, SPREAD IN PLACE  PROVIDE SAMPLE FOR APPERICE PER UNIT AND WILL BE PAID	REMENTS)  14' x 6' spr., 4" cal.  14' x 6' spr., 4" cal.  16' x 6' spr., 6" DBH (3 TKS. e 2" ea), AT TIME OF INSTALLATION  17. STANDARD, SINGLE LEADER, 2" DBH, 4' CT. AT TIME OF INSTALLATION  3 gal., 24" x 24", 24" o.c., full  3 gal., 18" x 18", 24" o.c.  SOLID SOD, price per s.f.  SOLID SOD, price per s.f.  PREAD IN PLACE  IN PLACE  E, ATLAS PEAT AND SOIL  ROYAL PRIOR TO INSTALLATION  ROXIMATE, CONTRACTOR
**   **   PEL QV **   CET LIW **   CEH HPD  SO SOD BAH  TOP:	BUFFE YES UNDER YES YES OD SOIL:	RYARD TREES  5  10  RYARD 240 240  240  30 c.y. 50 c.y.	PLANTINGS (ADDITIONAL  SLASH PINE LIVE OAKS  TREES  SILVER BUTTONWOOD  CRAPE MYRTLE "WHITE"  SHRUBS  GREEN BUTTONWOOD  DWARF FIREBUSH  "FLORATAM" ST. AUGUSTINE  "ARGENTINE" BAHIA SOD  TOPSOIL:SAND MIX  TREES, PALMS, SHRUBS AND  AREA TO BE SODDED WITH  RECYCLED DRK BROWN  TOPSOIL, SOD AND MIX  TO PROVIDE A UNIT P  UPON FINAL INSPECTICATE  TERING:	Pinus elliottii Quercus virginiana  Conocarpus erec. "Sericeus"  Lagerstroemia indica "Natchez" 12" x 5" sp  Conocarpus erectus  Hamelia nodosa  Stenotaphrum secundatum  Paspalum notatum  50:50 TOPSOIL: SAND MIX, Sp  GROUNDCOVERS  A 2" DEPTH OF TOPSOIL SPREAD  3" DEPTH, SPREAD IN PLACE  PROVIDE SAMPLE FOR APP  ILCH QUANTITIES SHOWN ARE APP  RICE PER UNIT AND WILL BE PAID  ON AND APPROVAL.	REMENTS)  14' x 6' spr., 4" cal.  14' x 6' spr., 4" cal.  16' x 6' spr., 6" DBH (3 TKS. • 2" ea), AT TIME OF INSTALLATION  17. STANDARD, SINGLE LEADER 2" DBH, 4" C.T. AT TIME OF INSTALLATION  13 gal., 24" x 24", 24" o.c., full  13 gal., 18" x 18", 24" o.c.  SOLID SOD, price per s.f.  SOLID SOD, price per s.f.  SPREAD IN PLACE  IN PLACE  E, ATLAS PEAT AND SOIL  ROYAL PRIOR TO INSTALLATION  ROXIMATE, CONTRACTOR  ON THAT UNIT PRICE BASIS
**   **   PEL QV **   CET LIW **   CEH HPD  SO SOD BAH  TOP:	BUFFE YES UNDER YES YES OD SOIL:	RYARD TREES  5  10  RYARD 240 240  240  30 c.y. 50 c.y.	PLANTINGS (ADDITIONAL  SLASH PINE  LIVE OAKS  TREES  SILVER BUTTONWOOD  CRAPE MYRTLE "WHITE"  SHRUBS  GREEN BUTTONWOOD  DWARF FIREBUSH  "FLORATAM" ST. AUGUSTINE  "ARGENTINE" BAHIA SOD  TOPSOIL:SAND MIX  TREES, PALMS, SHRUBS AND  AREA TO BE SODDED WITH  RECYCLED DRK BROWN  TOPSOIL, SOD AND MIX  TO PROVIDE A UNIT P  UPON FINAL INSPECTICAL  TERING:  CONTRACTOR SHALL	Pinus elliottii  Quercus virginiana  Conocarpus erec. "Sericeus"  Lagerstroemia indica "Natchez" 12" x 5" sp  Conocarpus erectus  Hamelia nodosa  Stenotaphrum secundatum  Paspalum notatum  50:50 TOPSOIL:SAND MIX, Sp  GROUNDCOVERS  A 2" DEPTH OF TOPSOIL SPREAD  3" DEPTH, SPREAD IN PLACE  PROVIDE SAMPLE FOR APPERICE PER UNIT AND WILL BE PAID	REMENTS)  14' x 6' spr., 4" cal.  14' x 6' spr., 4" cal.  16' x 6' spr., 6' DBH (3 TKS. • 2" ea), AT TIME OF INSTALLATION  17. STANDARD, SINGLE LEADER, 2" DBH, 4' C.T. AT TIME OF INSTALLATION  18. 3 gal., 24" x 24", 24" o.c., full  19. 3 gal., 18" x 18", 24" o.c.  SOLID SOD, price per s.f.  SOLID SOD, price per s.f.  SOLID SOD, price per s.f.  SPREAD IN PLACE  IN PLACE  E, ATLAS PEAT AND SOIL  ROYAL PRIOR TO INSTALLATION  ROXIMATE, CONTRACTOR  19. ON THAT UNIT PRICE BASIS

**PLANTLIST** 

\*\* "AT TIME OF PLANTING" FOR ALL PLANTINGS.

**EXISTING TREES (SEE TREE DISPOSITION PLANS)** 

BOTANICAL NAME

SYM, NATIVE \* NAME


PLANTLIST, DETAILS, NOTES, ETC.






### IN ASSOCIATION WITH:



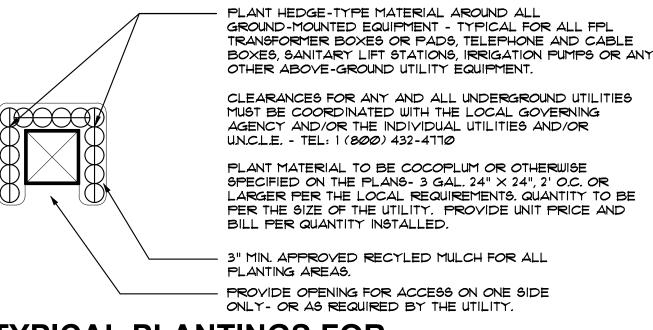


### TYPICAL PLANTINGS FOR **GROUND-MOUNTED EQUIPMENT**

N.T.S.

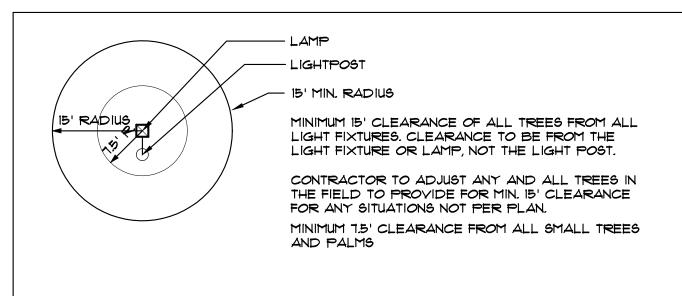

## FROM LIGHT FIXTURES

N.T.S.

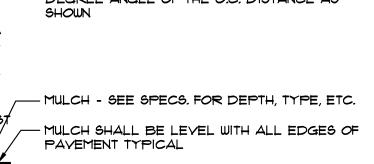

### SHRUB PLANTING DETAIL

DRAWN BY: CHECKED BY: A.LL. REF NUMBER:

**L-3** 

12.01.2020

**DELIVERY DATE:** 

PROFESSIONAL SEAL:

JAMES F. SOCASH

RLA \* 0001132

Alberto Llorente

AR-0012031

**BRIDGEPREP** 

**ACADEMY** 

AT DORAL


3500 NW 89th COURT

DORAL, FLORIDA 33172

DATE ISSUE DESCRIPTION

\10.23.20 SITE PLAN COMM


DRAWING INFORMATION:

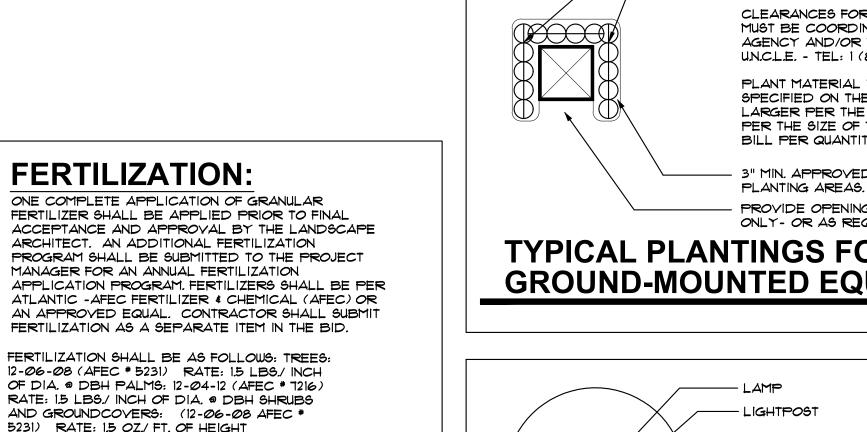


## MINIMUM TREE CLEARANCE


GROUNDCOVERS TO BE STAGGERED AS SHOWN - SPACING BETWEEN ROWS TO BE AT A 60 DEGREE ANGLE OF THE O.C. DISTANCE AS - PLANTING SOIL MIX - SEE NOTES FOR TYPE,


## **GROUNDCOVER DETAIL**

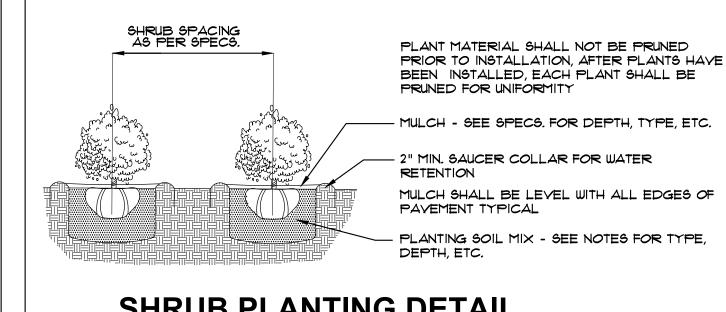

LANDSCAPE DETAILS,

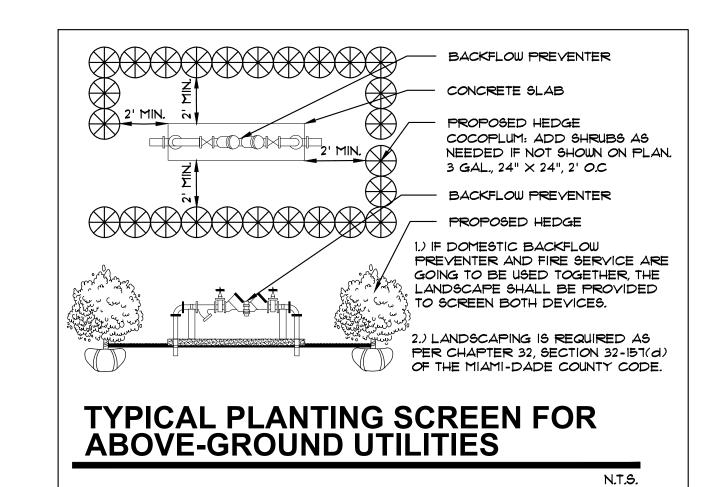

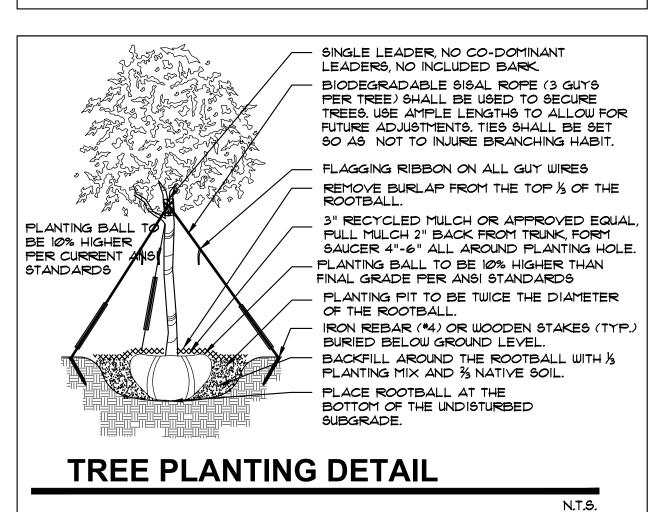

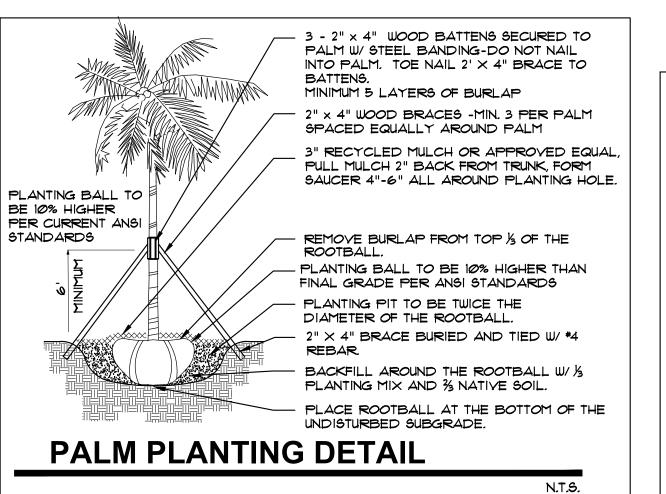

ALL FREE-STANDING TREES AND PALMS SHALL HAVE A MINIMUM 5' DIAMETER MULCH RING 8. ALL PLANTING BEDS SHALL BE MULCHED TO A DEPTH OF 3" WITH AN APPROVED RECYCLED 51 DIAMETER MULCH BY THE PRESIDING GOVERNING AGENCY. MINIMUM NO HEAVY METALS. I.E. ARSENIC, LEAD, ETC. ARE TO BE CONTAINED IN THE MULCH AND THE CONTRACTOR SHALL PROVIDE CERTIFICATION OR PROOF THAT ALL MULCH IS FREE OF HEAVY METALS OR SIMILAR ENVIRONMENTAL CONTAMINANTS. TYPICAL MULCH RING FOR FREE-STANDING TREES AND PALMS

EQUIPMENT.

**■ FERTILIZATION:** 

5231) RATE: 1.5 OZ./ FT. OF HEIGHT

-EDGE OF PAVEMENT

REQUIREMENTS APPLY TO FIRE HYDRANTS,

EQUIPMENT FOR UTILIZING FIRE HOSE, ON

FIRE PREVENTION CODE SECTION 5211.2

THIS DIAGRAM SHALL APPEAR ON ALL

THE CLEAR ZONE SHALL BE FREE OF LANDSCAPE (EXCEPT SOD), MAILBOXES,

FIRE HYDRANT

**CLEAR ZONE** 

LANDSCAPE PLANS PRIOR TO APPROVAL

PARKING, LAMP-POSTS AND ALL OTHER

EXCEPTIONS: OTHER FIRE FIGHTING EQUIPMENT OR TRAFFIC POSTS TO PREVENT FIRE FIGHTING

N.T.S.

BY THE AUTHORITY OF THE SOUTH FLORIDA

PUBLIC OR PRIVATE PROPERTY.

SIAMESE CONNECTIONS AND ANY OTHER FIRE

SPECIFICATIONS, ETC.